



PLANNING DEPARTMENT

COMPLIES WITH
ZONING BY-LAW:

DATE REVIEWED:

REVIEWED BY:

Sarah Otter

ENGINEERING REVIEW



ACCEPTED

ACCEPTED AS NOTED

REQUIRES RE-SUBMISSION

THIS PLAN HAS BEEN REVIEWED WITH RESPECT TO GENERAL CONFORMANCE WITH THE OVERALL LOT GRADING PLAN AND OUR APPROVAL OF THIS PLAN FOR NO OTHER REASON. WE ACCEPT NO RESPONSIBILITY FOR THE ACCURACY OF THE ELEVATIONS AND DIMENSIONS PROVIDED BY OTHERS.

March 29, 2021

DATE

REVIEWED BY

(TOWN OF BRADFORD WEST GWILLIMBURY USE ONLY)

John Williams

SITE COPY

TOWN OF BRADFORD WEST GWILLIMBURY - BUILDING DEPARTMENT

REVIEWED

68R
John Williams


INSPECTOR:

PERMIT NO.: **PR202100113**

DATE: **Mar. 29, 2021**

ALL CONSTRUCTION SHALL COMPLY WITH THE ONTARIO BUILDING CODE AND ALL OTHER APPLICABLE STATUTORY REGULATIONS. THE REVIEWED DOCUMENTS MUST BE KEPT ON SITE AT ALL TIMES.

INSPECTION REQUEST EMAIL: BUILDINGINSPECTIONS@TOWNOFBWG.COM
INSPECTION REQUEST FAX: (905) 778-2035
INSPECTION REQUEST TELEPHONE: (905) 778-2055 EXT. 1500

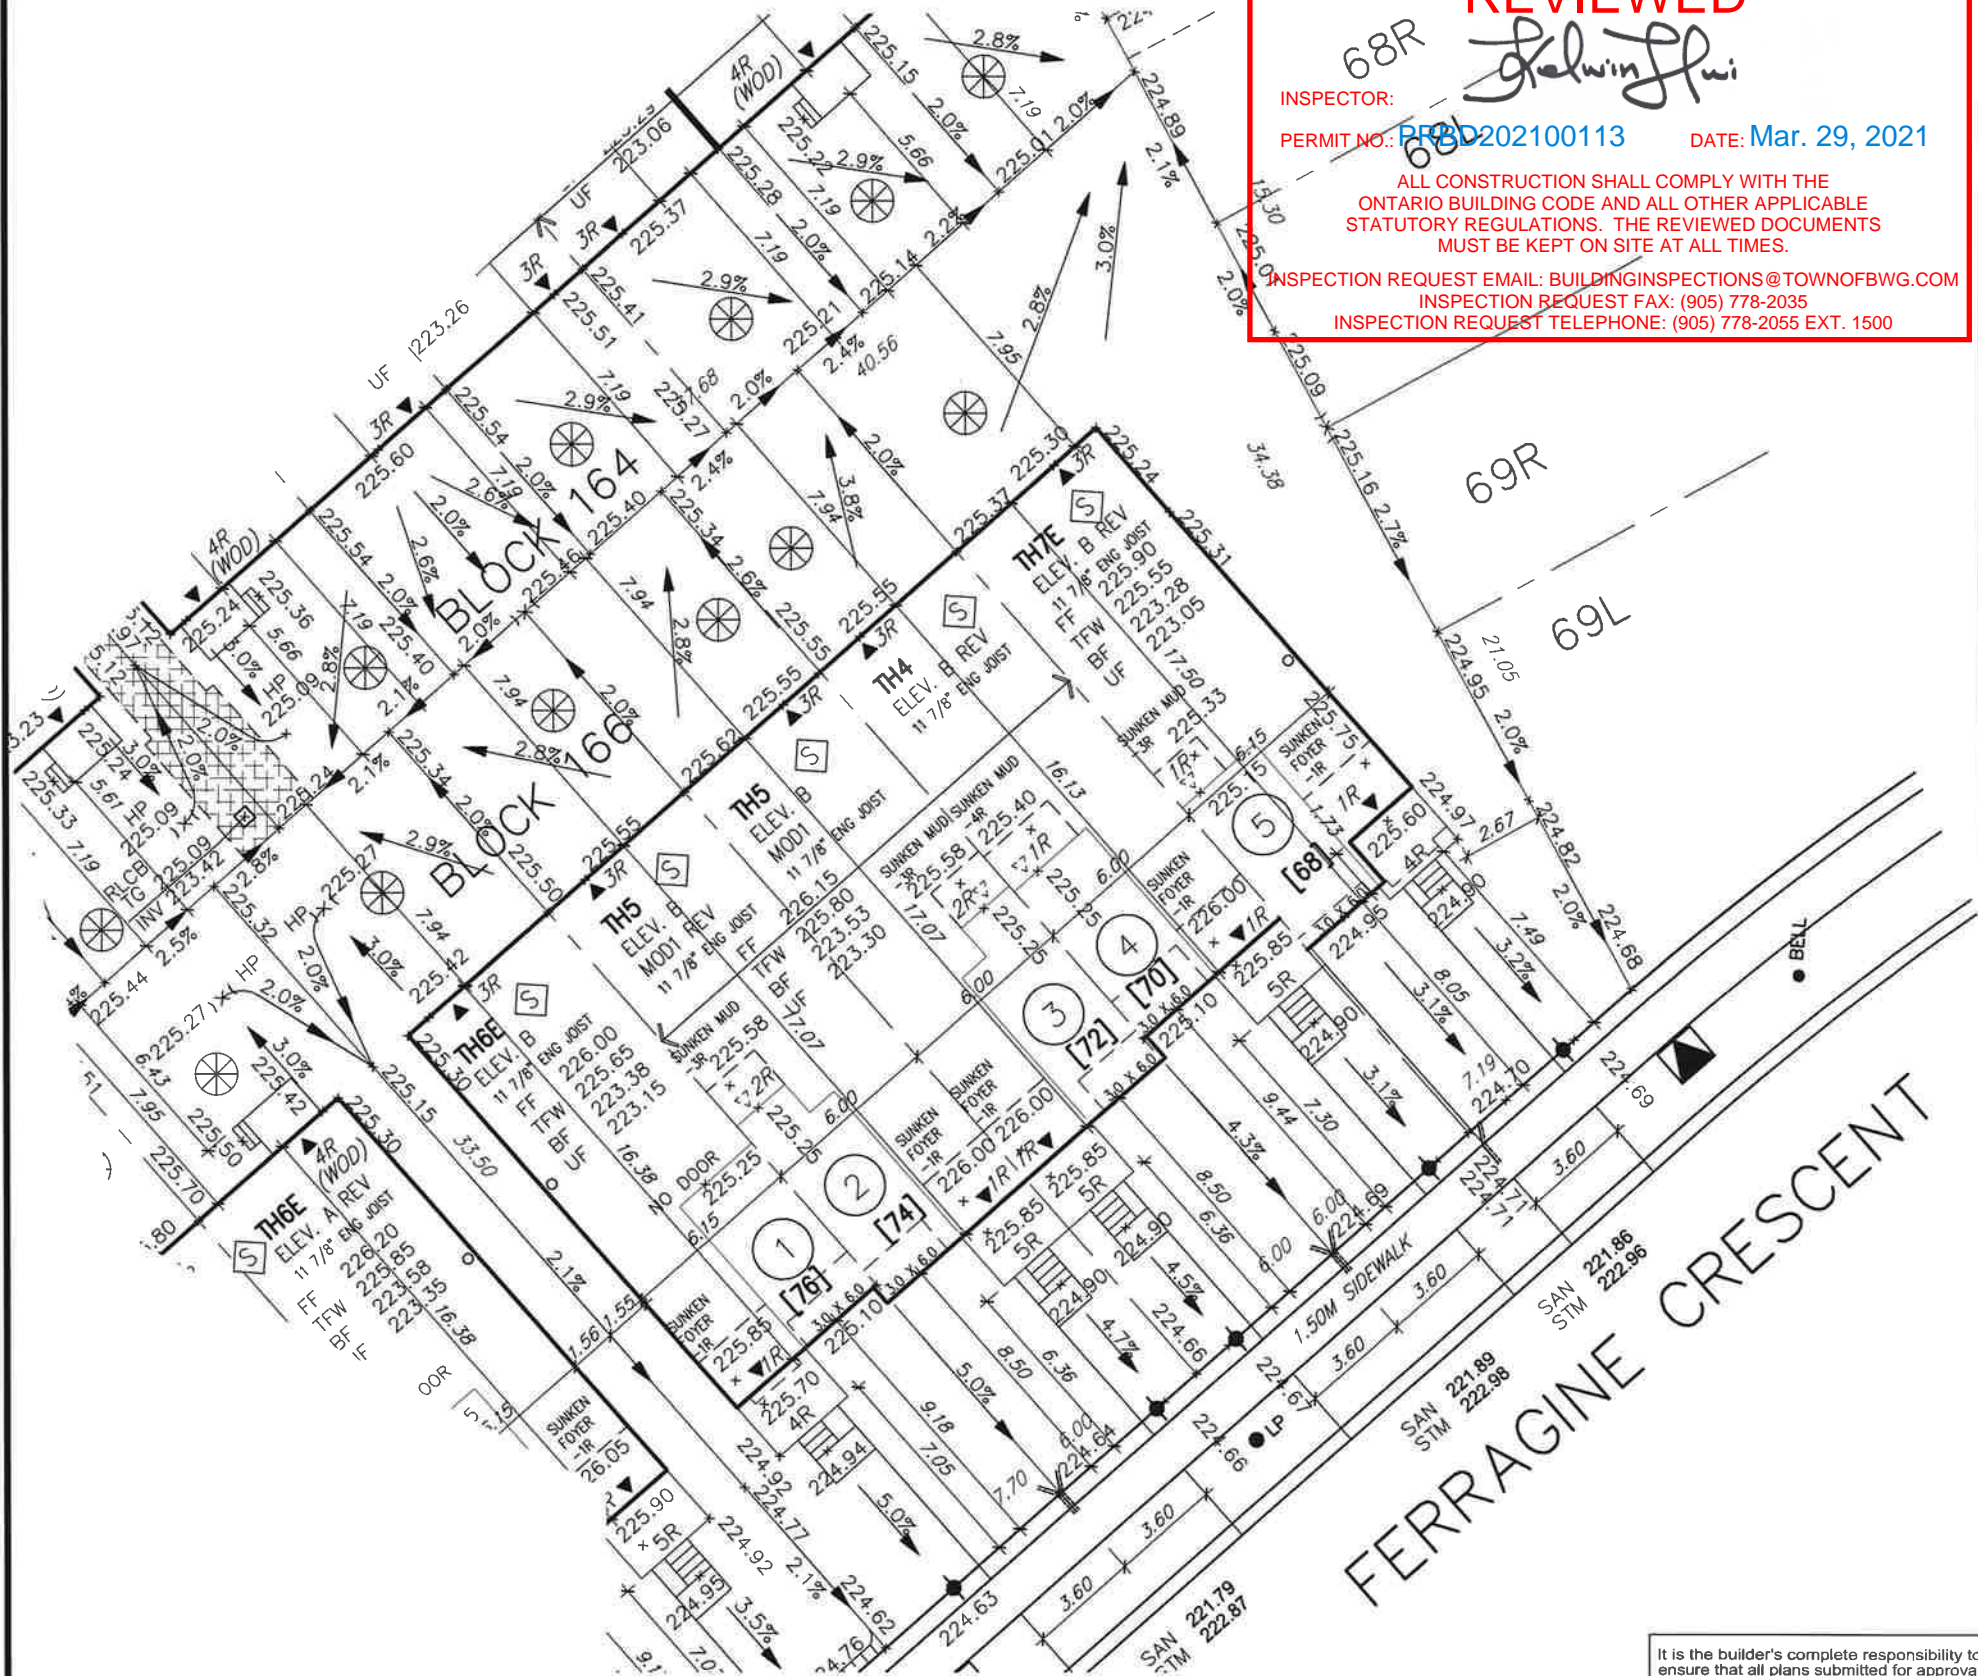

BLOCK 166			
LOT NO.	LOT FRONTAGE (M)	LOT AREA (SM)	BUILDING HT (M)
1	7.70	257.95	8.56
2	6.00	201.00	8.51
3	6.00	201.00	8.51
4	6.00	201.00	8.51
5	8.72	368.90	8.36

It is the builder's complete responsibility to ensure that all plans submitted for approval fully comply with the Architectural Guidelines and all applicable regulations and requirements including zoning provisions and any provisions in the subdivision agreement. The Control Architect is not responsible in any way for examining or approving site (lotting) plans or working drawings with respect to any zoning or building code or permit matter or that any house can be properly built or located on its lot.

This is to certify that these plans comply with the applicable Architectural Design Guidelines approved by the Town of BRADFORD / WEST GWILLIMBURY.

JOHN G. WILLIAMS LTD., ARCHITECT
ARCHITECTURAL CONTROL REVIEW
AND APPROVAL

APPROVED BY: *John Williams*
DATE: **Jun. 18, 2018**

This stamp certifies compliance with the applicable Design Guidelines only and bears no further professional responsibility.



MUNICIPAL ADDRESS

RICHARD - H:\ARCHIVE\WORKING\2016\16023.BW\Site plan\16023-SW.dwg - Wed - Jun 27 2018 - 1:31 PM

project no
13045

<ul style="list-style-type: none">PROPOSED VALVELIGHT POLEWATER SERVICEDOUBLE STM./SAN. CONNECTIONSINGLE STM./SAN. CONNECTIONCATCH BASINCABLE TELEVISION PEDESTALBELL PEDESTAL	<ul style="list-style-type: none">HYDRANTTRANSFORMER	<ul style="list-style-type: none">STREET SIGNMAIL BOXRETAINING WALLCHAIN LINK FENCE (SEE LANDSCAPE PLAN)ACOUSTICAL FENCE (SEE LANDSCAPE PLAN)WOOD SCREEN FENCE (SEE LANDSCAPE PLAN)HYDRO SERVICE LATERALHYDRO METERGAS METEREMBANKMENT	<ul style="list-style-type: none">SWALE DIRECTIONLOTS EQUIPPED WITH SUMP PUMP	<ul style="list-style-type: none">PROVIDE 3/4" DIA. CLEAR STONE IN THIS AREATHIS LOT CONTAINS ENGINEERED FILLAIR CONDITIONER REQUIREDRAIN WATER DOWNSPOUT LOCATION (DISCHARGE ONTO SPLASHPAD)SIDE WINDOW LOCATIONOPT. DOOR LOCATIONEXTERIOR DOOR LOCATIONREDUCE SIDE YARD
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The undersigned has reviewed and takes responsibility for this design and has the qualifications and meets the requirements set out in the Ontario Building Code to be a Designer.

qualification information
Wellington Jno-Baptiste 25591
name registration information
VA3 Design Inc. 42658

Builder to verify location of all hydrants, street lights, transformers and other services. If minimum dimensions are not maintained, builder is to relocate at his own expense.
Builder to verify service connection elevations prior to constructing foundations.



255 Consumers Rd Suite 120
Toronto ON M2J 1R4
t 416.630.2255 f 416.630.4782
va3design.com

URBAN ECOSYSTEMS LTD. HAS REVIEWED THE PROPOSED GRADES AS SHOWN ON THIS PLAN AND HAS FOUND THEM TO BE IN GENERAL CONFORMANCE WITH THE APPROVED PLANS

LOT NO. **Block 165A**
DATE **June 28, 2018**

DEVELOPER:	ARG GROUP
BUILDER:	BAYVIEW WELLINGTON
CONSULTANT:	URBAN ECO SYSTEMS- CIVIL ENG VA3 DESIGN- ARCHITECTURE

MAX BUILDING HEIGHT: 13.0m	LOT AREA: VARIES m2	SAN INVERT: - m
BUILDING HEIGHT: -m	LOT FRONTAGE: - m	STM INVERT: - m
AVERAGE GRADE: 225.22m	LOT COVERAGE: N/A %	DESIGNED: -
4		DRAWN: RC
3		SCALE: 1:250
2	ISSUED FOR PERMIT	JUNE 13-2018
1	ISSUED FOR REVIEW	NOV 06-2017
No.	Revision	Date
SITING & GRADING PLAN		
LOT NO: 166A		