


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This is to certify that these plans comply with the applicable Architectural Design Guidelines approved by the BRADFORD / WEST GWILLIMBURY.

JOHN G. WILLIAMS LTD., ARCHITECT
 ARCHITECTURAL CONTROL REVIEW AND APPROVAL
 APPROVED BY: [Signature]
 DATE: MAR 15, 2022
 This stamp certifies compliance with the applicable Design Guidelines only and bears no further professional responsibility.

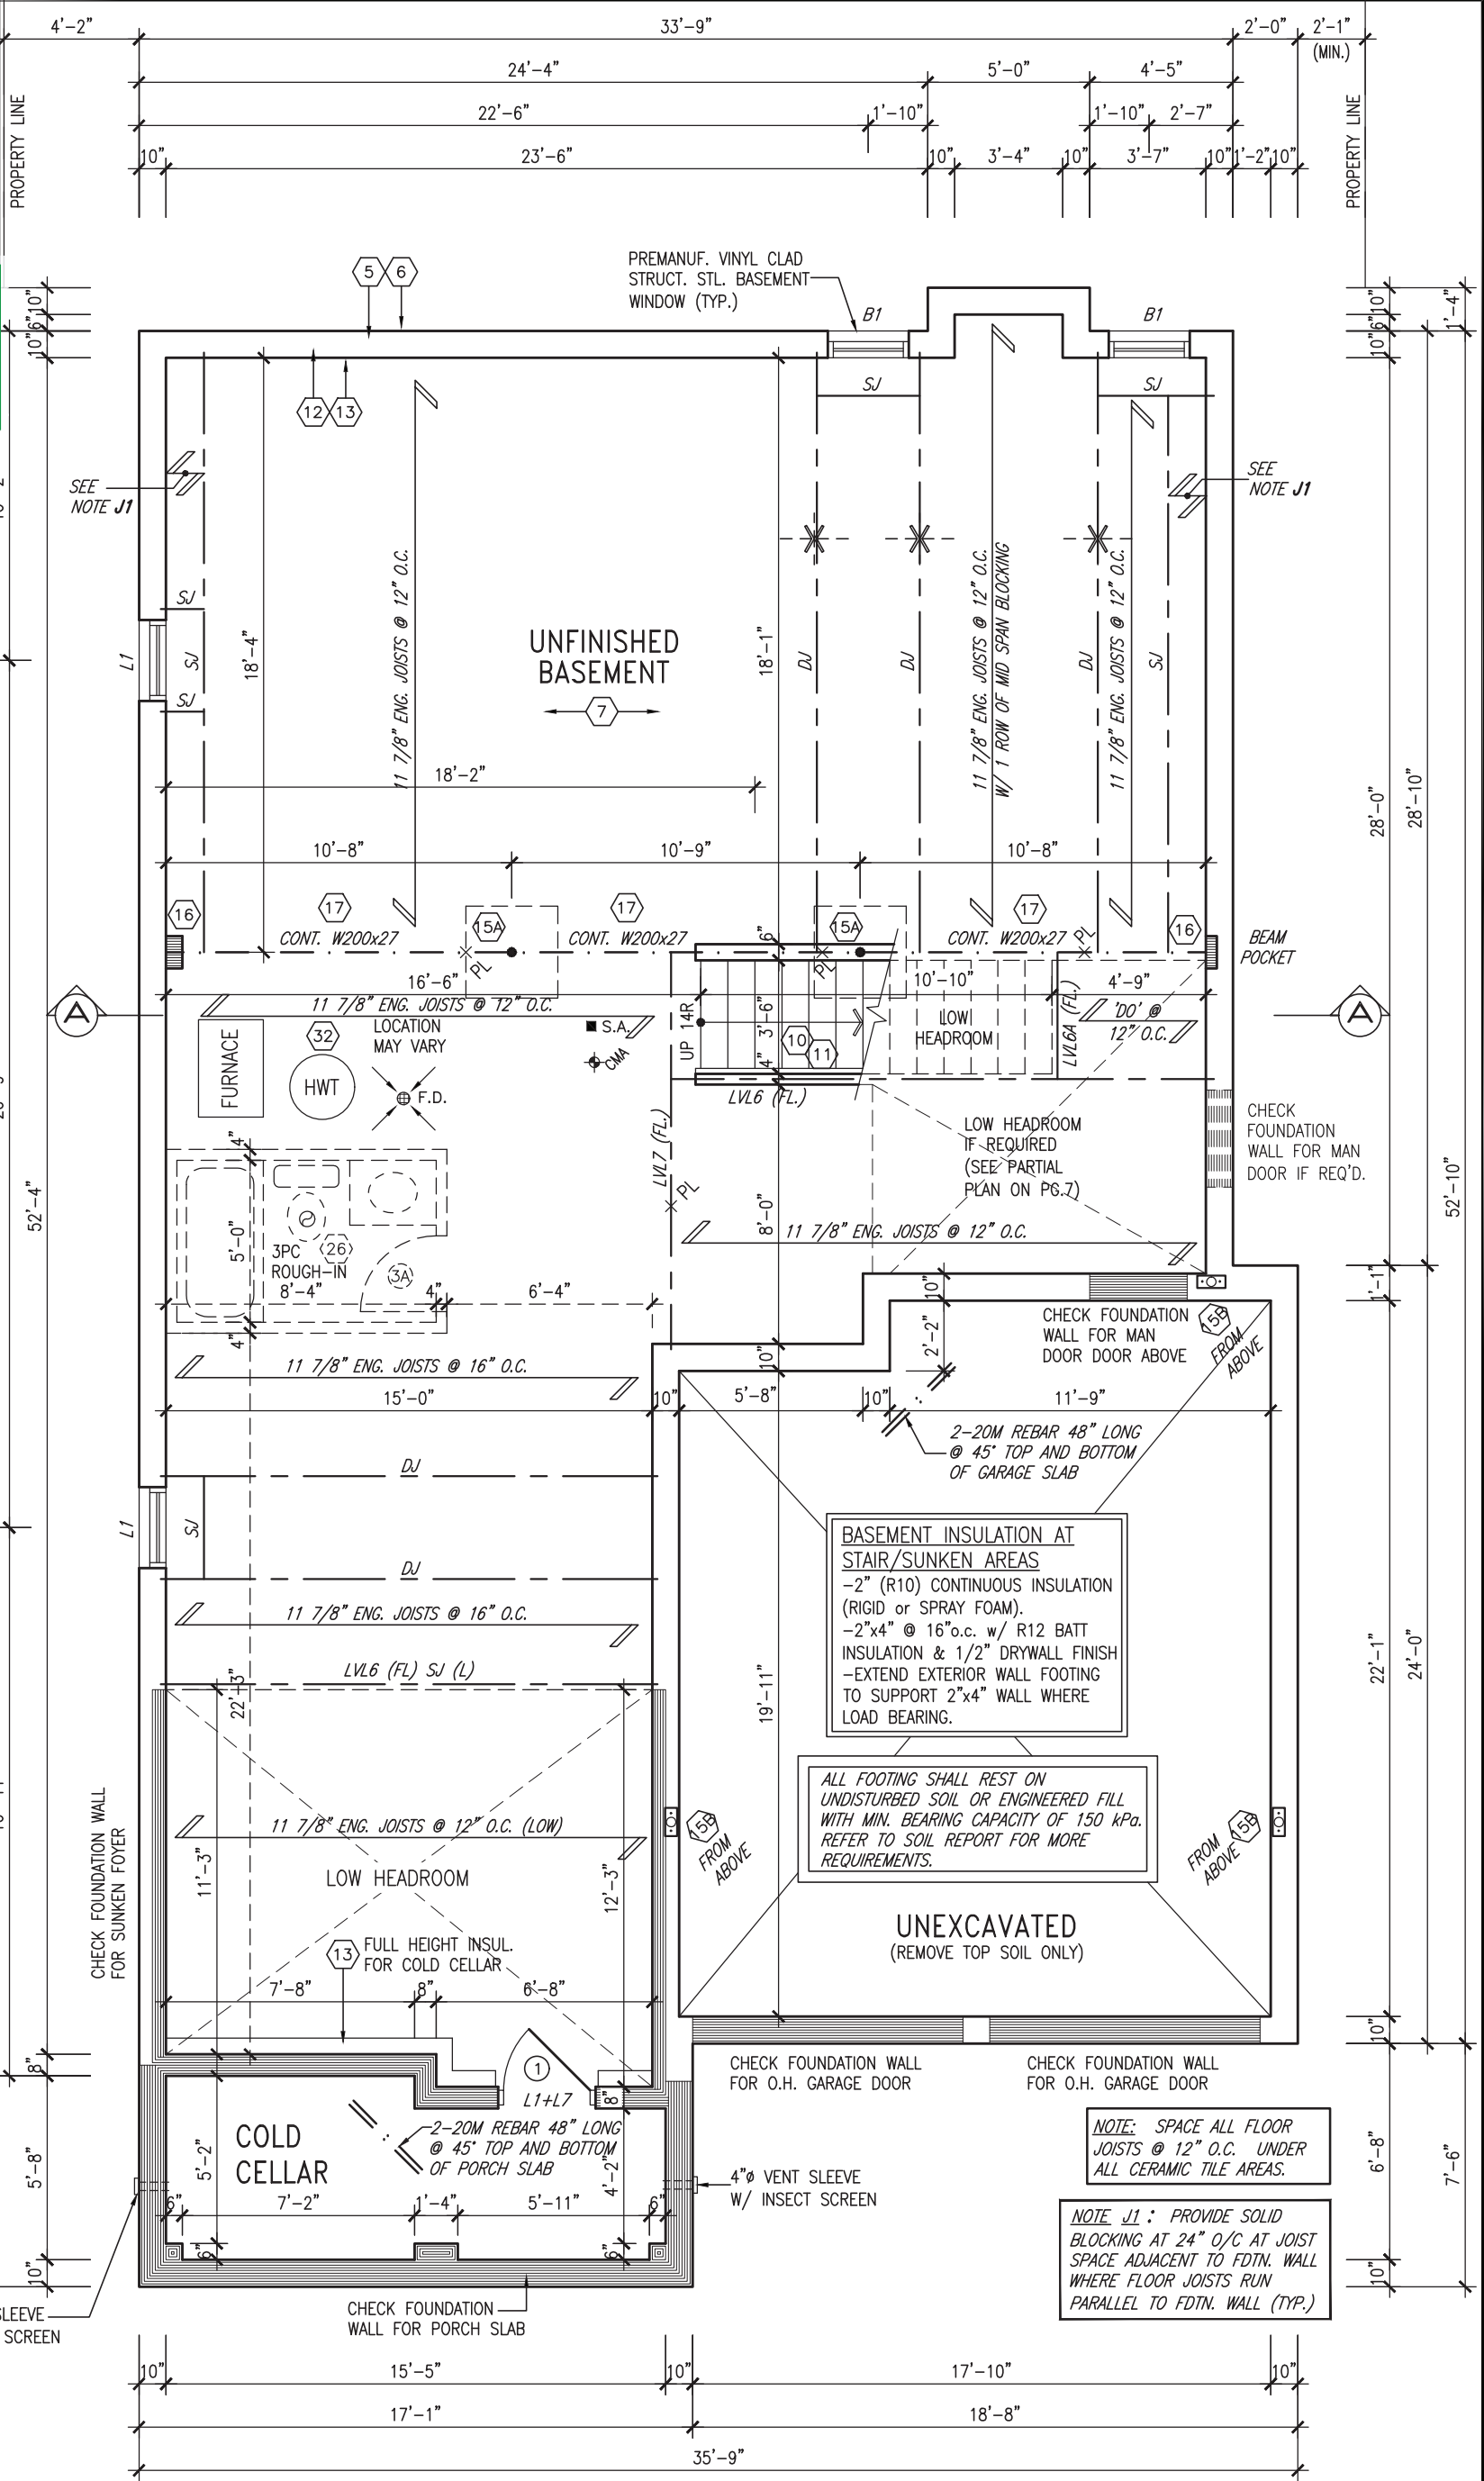


BASEMENT PLAN 'A'

AREA CHART ON PAGE 18

NOTE:
 ALL LVL'S SUPPORTING FLOOR LOADS ARE TO BE SPECIFIED BY THE FLOOR TRUSS MANUFACTURER.

NOTE:
 FLOOR FRAMING INFO REFER TO ENG SHOP DRAWINGS FOR ALL TRUSS-JOIST INFORMATION AND DETAILS. UNLESS OTHERWISE NOTED.

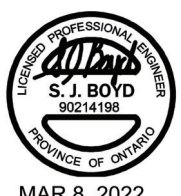

9				The undersigned has reviewed and takes responsibility for this design and has the qualifications and meets the requirements set out in the Ontario Building Code to be a Designer.
8				qualification information
7				Wellington Jno-Baptiste 25591
6				name registration information BCIN
5				VA3 Design Inc. 42658
4				Contractor must verify all dimensions on the job and report any discrepancy to the Designer before proceeding with the work. All drawings and specifications are instruments of service and the property of the Designer which must be returned at the completion of the work. Drawings are not to be scaled.
3	REVISED AS PER ENG COMMENTS	MAR 03-22	RC	
2	REVISED AS PER FLOOR / ROOF LAYOUT	FEB 24-22	RC	
1	ISSUED FOR CLIENT REVIEW	NOV 26-21	VA3	
no.	description	date	by	

VA3 DESIGN
 255 Consumers Rd Suite 120
 Toronto ON M2J 1R4
 t 416.630.2255 f 416.630.4782
 va3design.com

BAYVIEW WELLINGTON **S42-19**

project name: GREEN VALLEY EAST municipality: BRADFORD, ONTARIO project no.: 16023

date: OCTOBER 2021 checked by: JWM scale: 3/16" = 1'-0" drawing no.: 1

BASEMENT PLAN 'A'

file name: 16023-S42-19

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JOHN G. WILLIAMS LTD., ARCHITECT
ARCHITECTURAL CONTROL REVIEW AND APPROVAL

APPROVED BY: *[Signature]*
DATE: **MAR 15, 2022**

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NOTE W1
PROVIDE 2-15M FULL HEIGHT VERTICAL REBARS EACH SIDE OF OPENING + 2-15M HORIZ. REBARS BELOW AND EXTEND 24" BEYOND OPENING PROVIDE 3" CLEAR COVER FROM SOIL SIDE


SEE DETAIL S4 FOR 9'-0" BASEMENT COND



MAR 8, 2022

NOTE:
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NOTE:
FLOOR FRAMING INFO REFER TO ENG SHOP DRAWINGS FOR ALL TRUSS-JOIST INFORMATION AND DETAILS. UNLESS OTHERWISE NOTED.

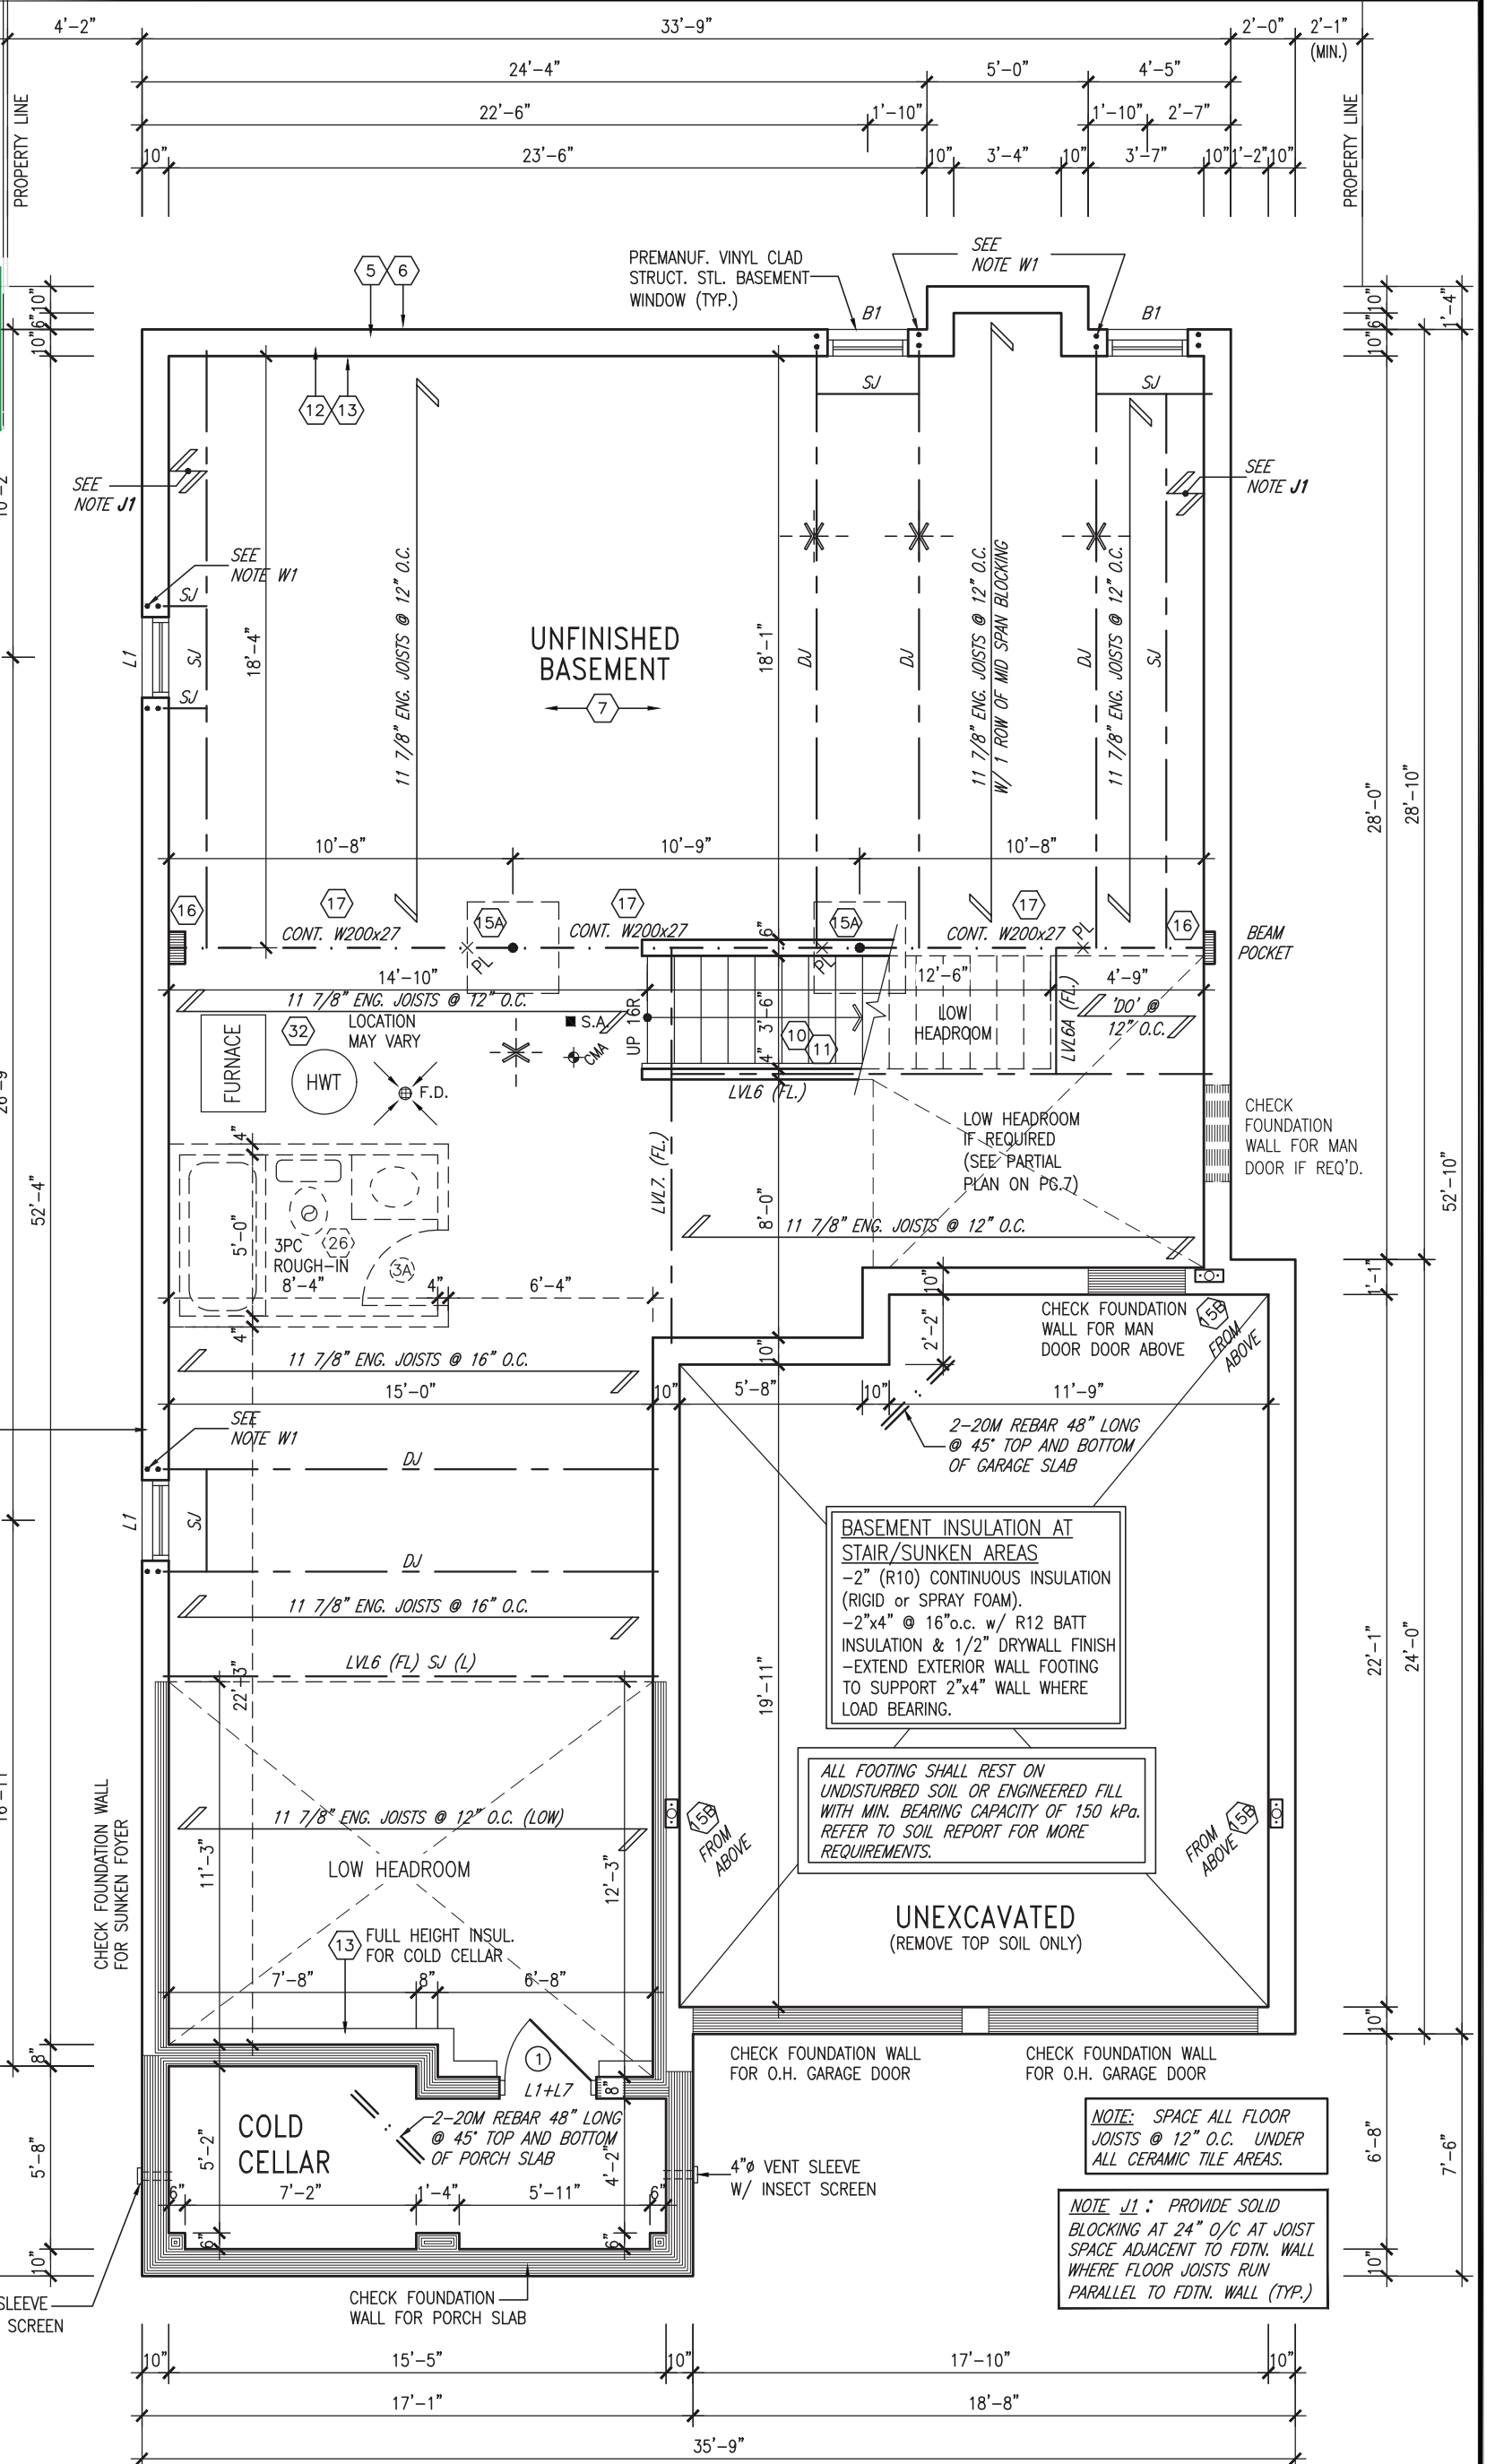

OPT. 9'-0" BASEMENT PLAN 'A'

AREA CHART ON PAGE 18

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8				qualification information
7				Wellington Jno-Baptiste 25591
6				name registration information BCIN
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3	REVISED AS PER ENG COMMENTS	MAR 03-22	RC	
2	REVISED AS PER FLOOR / ROOF LAYOUT	FEB 24-22	RC	
1	ISSUED FOR CLIENT REVIEW	NOV 26-21	VA3	
no.	description	date	by	

VA3 DESIGN

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Toronto ON M2J 1R4
t 416.630.2255 f 416.630.4782
va3design.com

BAYVIEW WELLINGTON **S42-19**

project name: **GREEN VALLEY EAST** municipality: **BRADFORD, ONTARIO** project no.: **16023**

date: **OCTOBER 2021** checked by: **JWM** scale: **3/16" = 1'-0"** drawing no.: **1A**

file name: **16023-S42-19**

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JOHN G. WILLIAMS LTD., ARCHITECT
 ARCHITECTURAL CONTROL REVIEW AND APPROVAL
 APPROVED BY: [Signature]
 DATE: MAR 15, 2022
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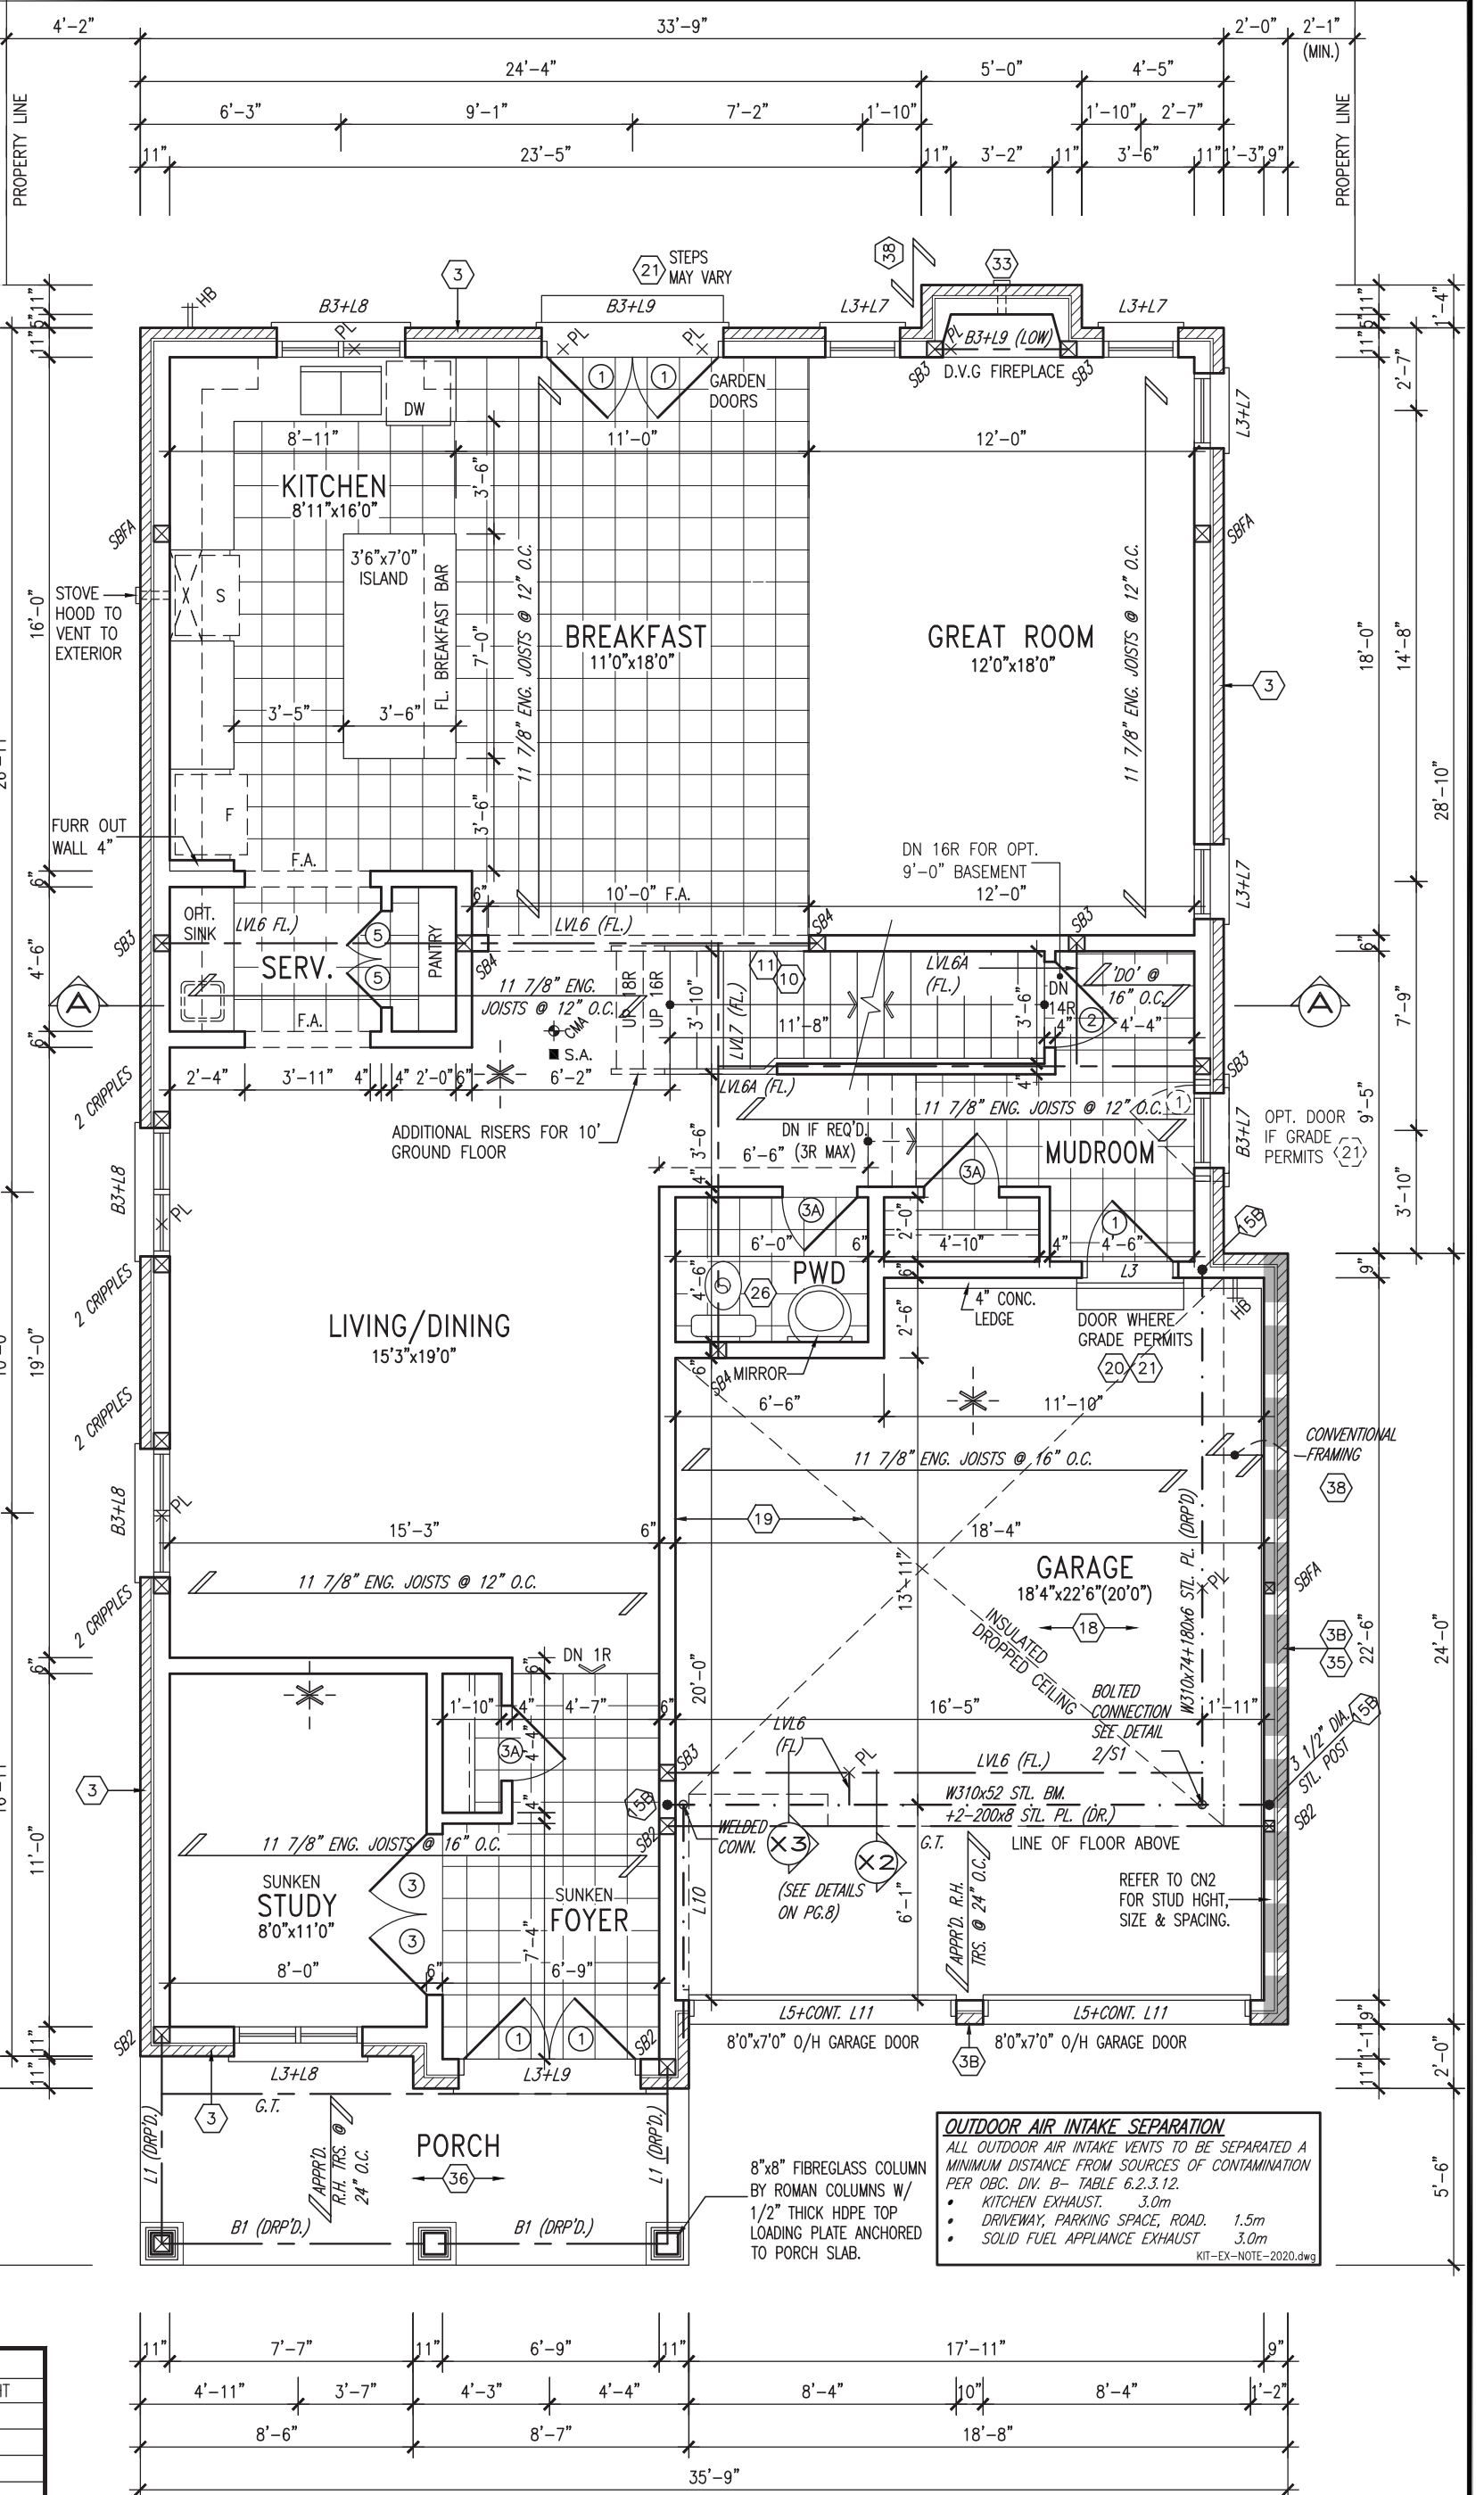


NOTE:
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 FLOOR FRAMING INFO REFER TO ENG SHOP DRAWINGS FOR ALL TRUSS-JOIST INFORMATION AND DETAILS, UNLESS OTHERWISE NOTED.

NOTE:
 SPACE ALL FLOOR JOISTS @ 12" O.C. UNDER ALL CERAMIC TILE AREAS.

DOOR HEIGHTS	
CEILING HEIGHT	DOOR HEIGHT
11'0" or greater	8'0" (96")
10'0"	8'0" (96")
9'0"	6'8" (80")
8'0" or lower	6'8" (80")

CONTRACTOR TO CONFIRM HEIGHTS WITH BUILDER



GROUND FLOOR PLAN 'A'

INDICATES REDUCED SIDE YARD


no.	description	date	by
9			
8			
7			
6			
5			
4			
3	REVISED AS PER ENG COMMENTS	MAR 03-22	RC
2	REVISED AS PER FLOOR / ROOF LAYOUT	FEB 24-22	RC
1	ISSUED FOR CLIENT REVIEW	NOV 26-21	VA3

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 qualification information
 Wellington Jno-Baptiste [Signature] 25591 BCIN
 name registration information
 VA3 Design Inc. 42658
 Contractor must verify all dimensions on the job and report any discrepancy to the Designer before proceeding with the work. All drawings and specifications are instruments of service and the property of the Designer which must be returned at the completion of the work. Drawings are not to be scaled.

VA3 DESIGN
 255 Consumers Rd Suite 120
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 t 416.630.2255 f 416.630.4782
 va3design.com

BAYVIEW WELLINGTON **S42-19**
 project name: GREEN VALLEY EAST municipality: BRADFORD, ONTARIO project no.: 16023
 date: OCTOBER 2021
 drawn by: TP checked by: JWM scale: 3/16" = 1'-0" drawing no.: 2
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GRAB BAR NOTE:
STUD WALL REINFORCEMENT FOR FUTURE GRAB BARS IN MAIN BATHROOM
 REINFORCEMENT OF STUD WALLS SHALL BE INSTALLED ADJACENT TO WATER CLOSETS AND SHOWER OR BATHTUB IN MAIN BATHROOM PER OBC, DIV. B-9.5.2.3. REFER TO FOLLOWING SECTIONS FOR THE FIXTURES LISTED. WATER CLOSET: 3.8.3.8.(3)(a) & 3.8.3.8.(3)(c). SHOWER 3.8.3.13.(2)(g). BATHTUB 3.8.3.13.(4)(e). FREE STANDING BATHTUB EXCLUDED. SEE DETAILS PROVIDED.
 GB-NOTE-2020.dwg


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JOHN G. WILLIAMS LTD., ARCHITECT
 ARCHITECTURAL CONTROL REVIEW AND APPROVAL

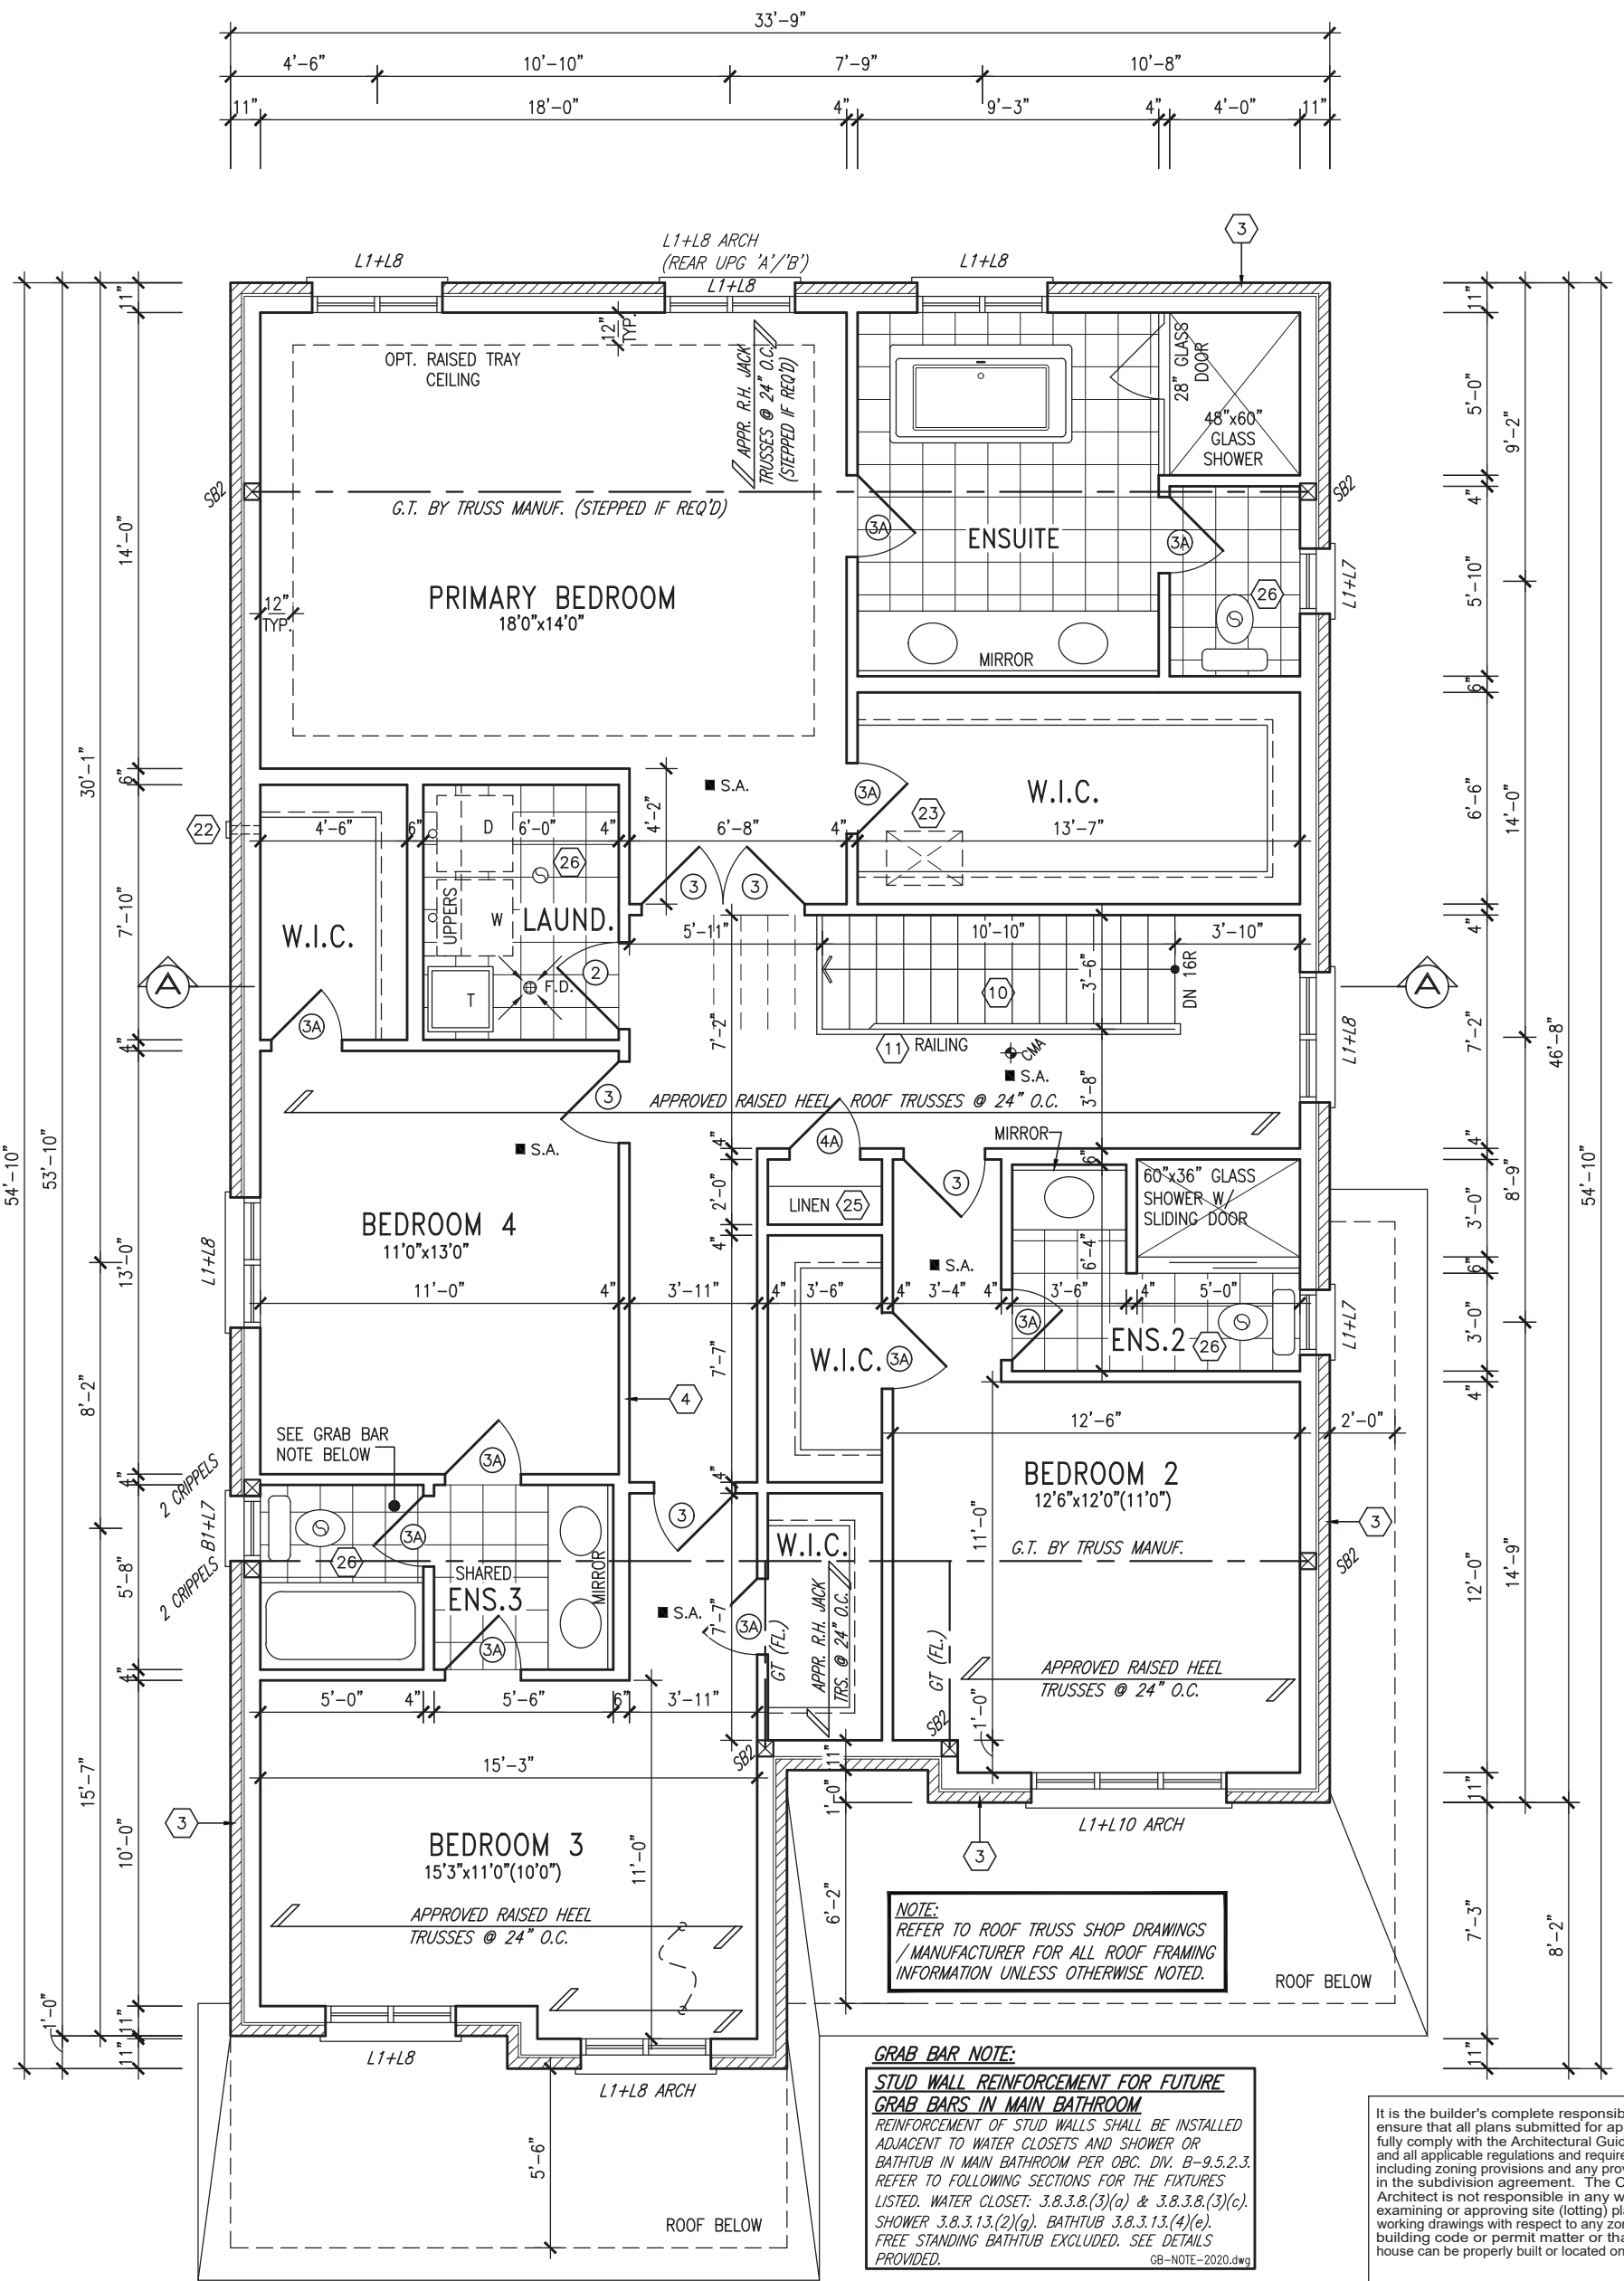APPROVED BY: _____
 DATE: MAR 15, 2022


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SECOND FLOOR PLAN 'A'

9.				The undersigned has reviewed and takes responsibility for this design and has the qualifications and meets the requirements set out in the Ontario Building Code to be a Designer.		 VA3 DESIGN 255 Consumers Rd Suite 120 Toronto ON M2J 1R4 t 416.630.2255 f 416.630.4782 va3design.com	BAYVIEW WELLINGTON project name GREEN VALLEY EAST date OCTOBER 2021 drawn by TP	municipality BRADFORD, ONTARIO checked by JWM scale 3/16" = 1'-0"	S42-19 project no. 16023 SECOND FLOOR PLAN 'A' drawing no. 3		
8.			Wellington Jno-Baptiste 25591 name registration information VA3 Design Inc. 42658								
7.			Contractor must verify all dimensions on the job and report any discrepancy to the Designer before proceeding with the work. All drawings and specifications are instruments of service and the property of the Designer which must be returned at the completion of the work. Drawings are not to be scaled.								
6.											
5.	3	REVISED AS PER ENG COMMENTS	MAR 03-22	RC							
4.	2	REVISED AS PER FLOOR / ROOF LAYOUT	FEB 24-22	RC							
3.	1	ISSUED FOR CLIENT REVIEW	NOV 26-21	VA3							
2.											
1.											

APPROVED RAISED HEEL ROOF TRUSSES @ 24" O.C.

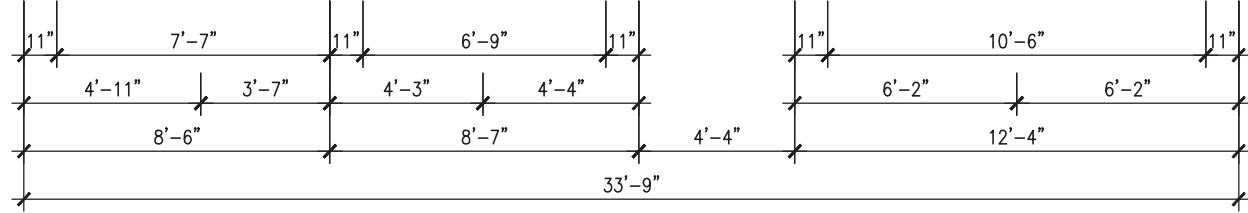

GRAB BAR NOTE:
STUD WALL REINFORCEMENT FOR FUTURE GRAB BARS IN MAIN BATHROOM
 REINFORCEMENT OF STUD WALLS SHALL BE INSTALLED ADJACENT TO WATER CLOSETS AND SHOWER OR BATHTUB IN MAIN BATHROOM PER OBC, DIV. B-9.5.2.3. REFER TO FOLLOWING SECTIONS FOR THE FIXTURES LISTED. WATER CLOSET: 3.8.3.8.(3)(a) & 3.8.3.8.(3)(c). SHOWER 3.8.3.13.(2)(g). BATHTUB 3.8.3.13.(4)(e). FREE STANDING BATHTUB EXCLUDED. SEE DETAILS PROVIDED. GB-NOTE-2020.dwg

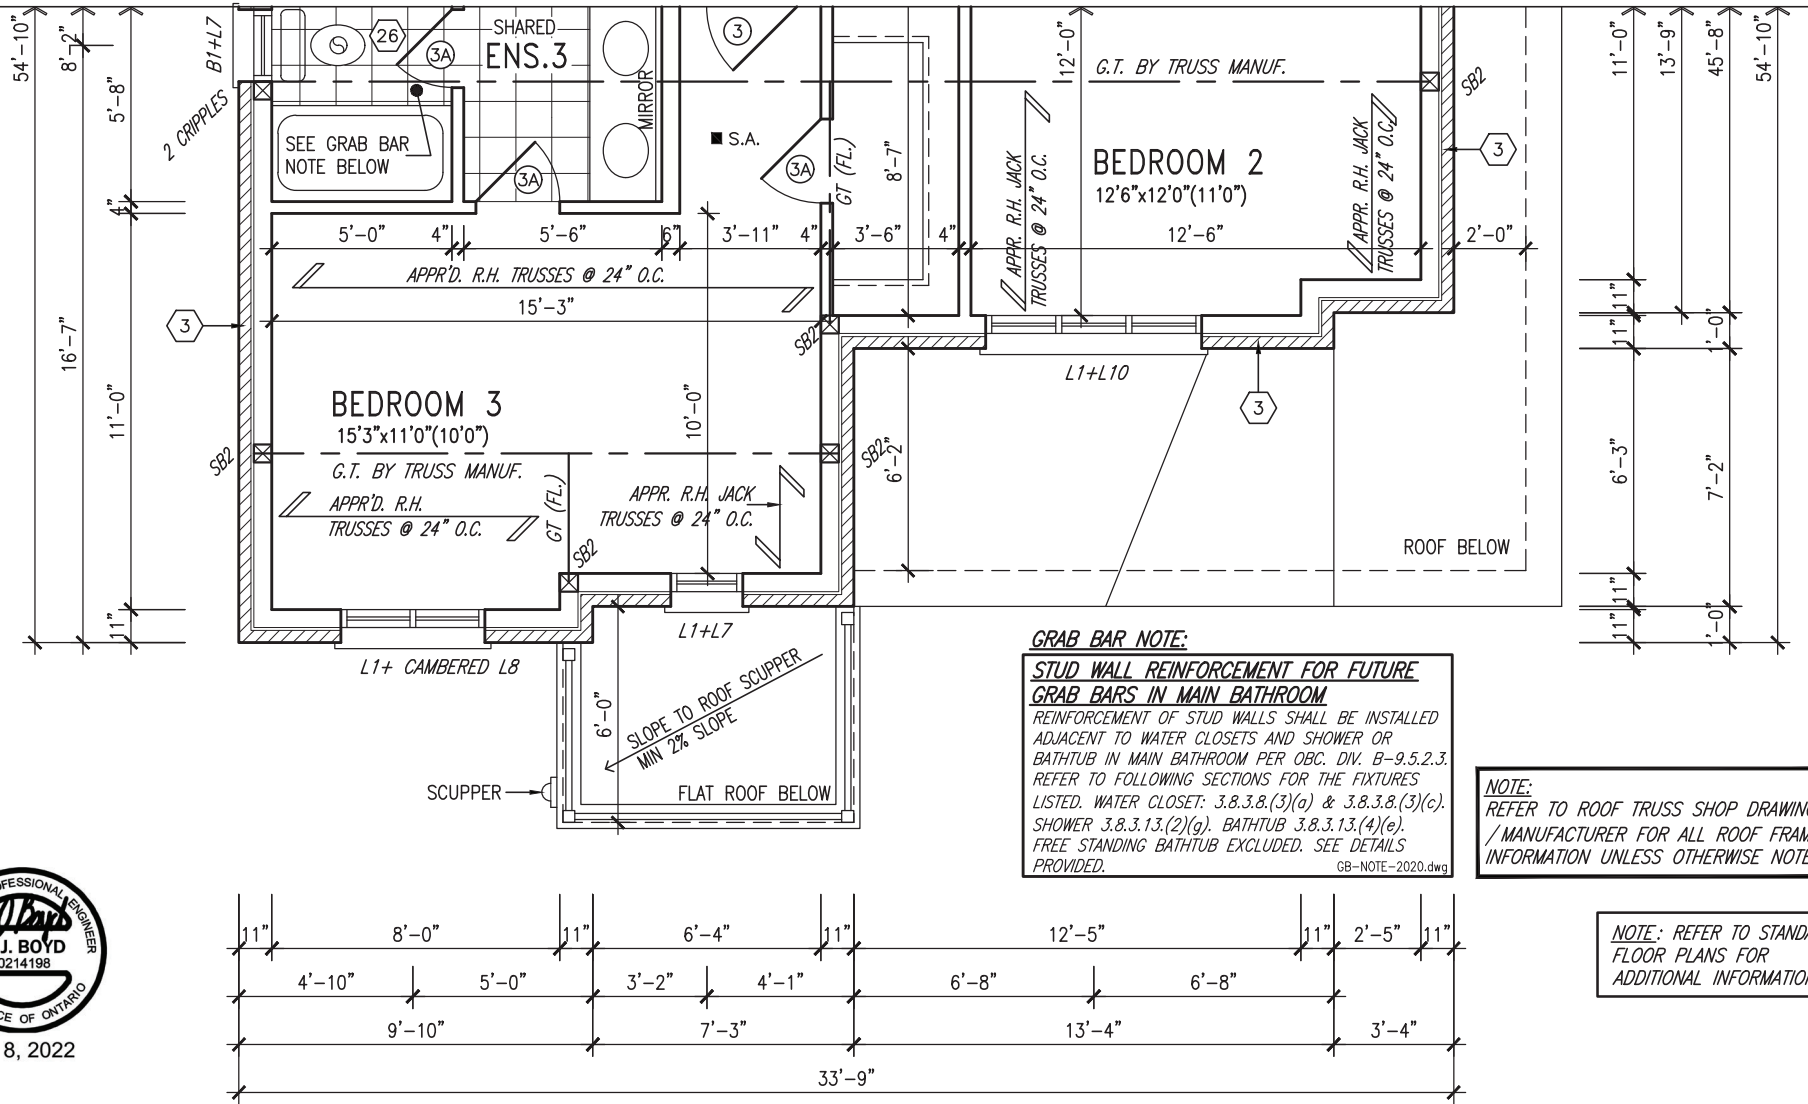NOTE:
 REFER TO ROOF TRUSS SHOP DRAWINGS / MANUFACTURER FOR ALL ROOF FRAMING INFORMATION UNLESS OTHERWISE NOTED.

NOTE:
 REFER TO STANDARD FLOOR PLANS FOR ADDITIONAL INFORMATION



MAR 8, 2022

PART. SECOND FLOOR PLAN 'B'

15C = 3 1/2" x 3 1/2" x 1/4" SQUARE
 H.S.S. 6x6x3/8" TOP AND BOTTOM
 PL. BASE PLATE 4 1/2" x 10 1/2" x 1/2"
 WITH 2- 1/2" x 12" x 2" HOOK ANCHORS. FIELD WELD COLUMN TO BASE PLATE

DOOR HEIGHTS	
CEILING HEIGHT	DOOR HEIGHT
11'0" or greater	8'0" (96")
10'0"	8'0" (96")
9'0"	6'8" (80")
8'0" or lower	6'8" (80")

CONTRACTOR TO CONFIRM HEIGHTS WITH BUILDER

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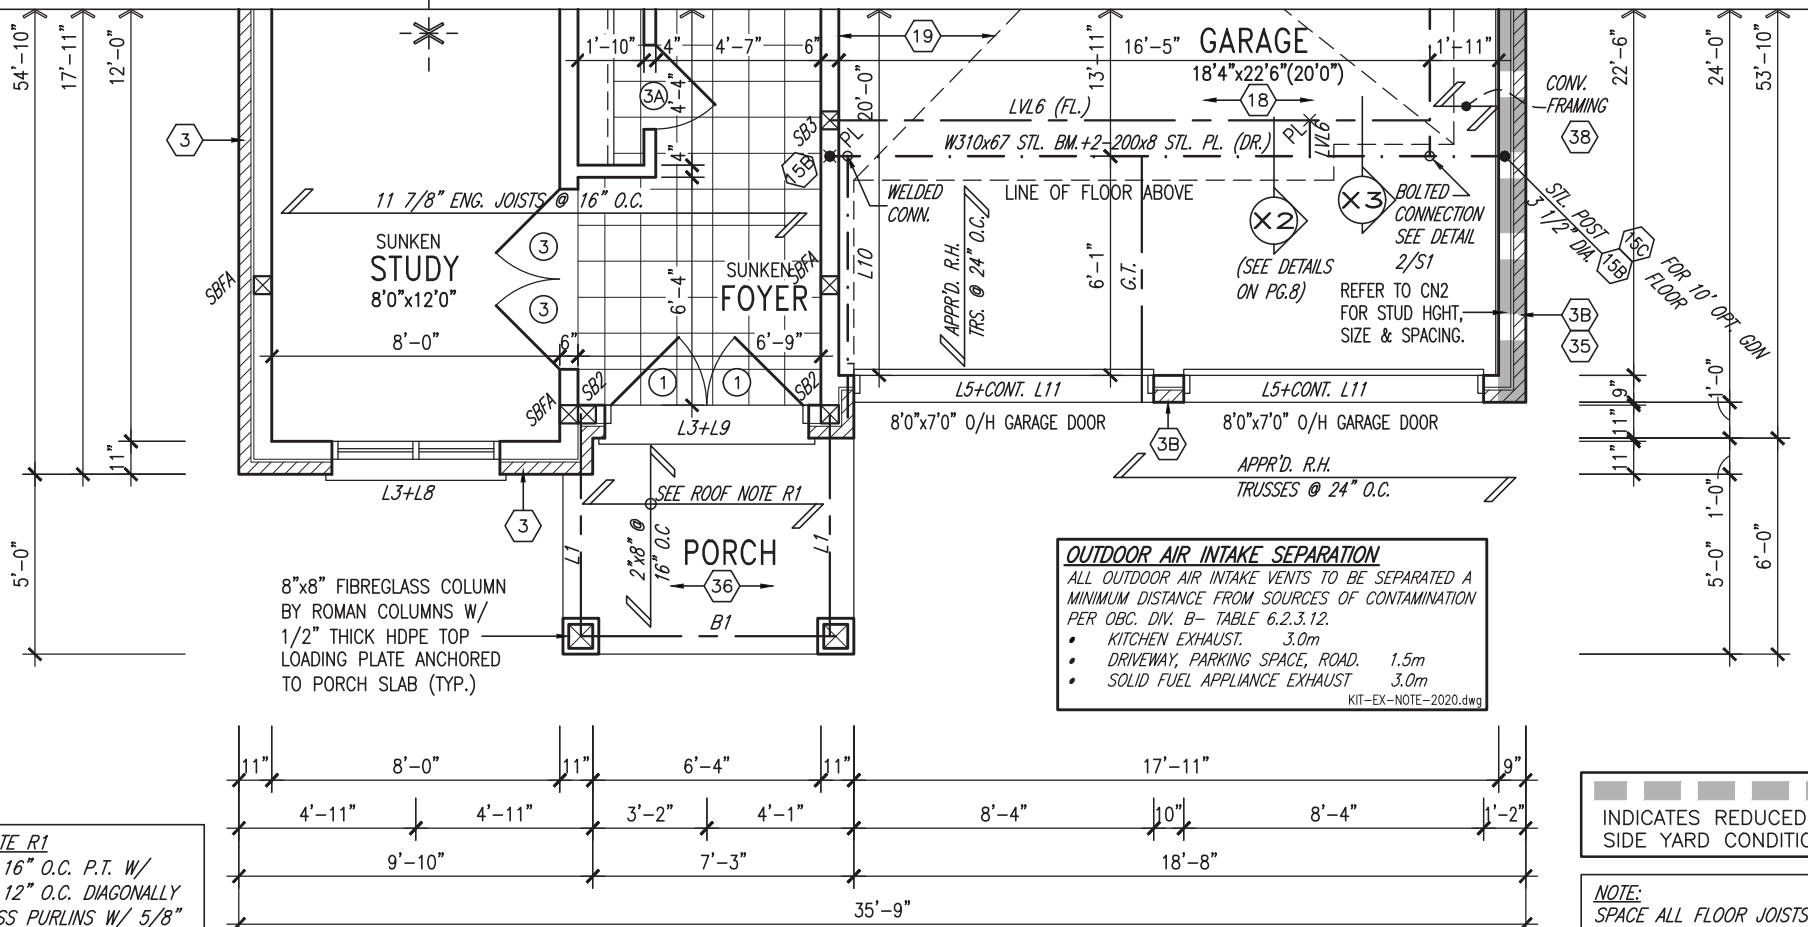
JOHN G. WILLIAMS LTD., ARCHITECT
 ARCHITECTURAL CONTROL REVIEW AND APPROVAL
 APPROVED BY: [Signature]
 DATE: MAR 15, 2022
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OUTDOOR AIR INTAKE SEPARATION
 ALL OUTDOOR AIR INTAKE VENTS TO BE SEPARATED A MINIMUM DISTANCE FROM SOURCES OF CONTAMINATION PER OBC, DIV. B- TABLE 6.2.3.12.
 • KITCHEN EXHAUST. 3.0m
 • DRIVEWAY, PARKING SPACE, ROAD. 1.5m
 • SOLID FUEL APPLIANCE EXHAUST 3.0m
 KIT-EX-NOTE-2020.dwg

NOTE:
 FLOOR FRAMING INFO REFER TO ENG SHOP DRAWINGS FOR ALL TRUSS-JOIST INFORMATION AND DETAILS. UNLESS OTHERWISE NOTED.

NOTE:
 ALL LVL'S SUPPORTING FLOOR LOADS ARE TO BE SPECIFIED BY THE FLOOR TRUSS MANUFACTURER.

NOTE:
 REFER TO STANDARD FLOOR PLANS FOR ADDITIONAL INFORMATION



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 • KITCHEN EXHAUST. 3.0m
 • DRIVEWAY, PARKING SPACE, ROAD. 1.5m
 • SOLID FUEL APPLIANCE EXHAUST 3.0m
 KIT-EX-NOTE-2020.dwg

ROOF NOTE R1
 2"x8" @ 16" O.C. P.T. W/
 2"x4" @ 12" O.C. DIAGONALLY
 CUT CROSS PURLINS W/ 5/8"
 EXTERIOR GRADE SHEATHING W/
 SINGLE PLY ROOF MEMBRANE


INDICATES REDUCED SIDE YARD CONDITION

NOTE:
 SPACE ALL FLOOR JOISTS @ 12" O.C. UNDER ALL CERAMIC TILE AREAS.

PART. GROUND FLOOR PLAN 'B'

9				The undersigned has reviewed and takes responsibility for this design and has the qualifications and meets the requirements set out in the Ontario Building Code to be a Designer.	 255 Consumers Rd Suite 120 Toronto ON M2J 1R4 t 416.630.2255 f 416.630.4782 va3design.com	BAYVIEW WELLINGTON project name GREEN VALLEY EAST municipality BRADFORD, ONTARIO	S42-19 project no. 16023
8			qualification information				
7			Wellington Jno-Baptiste 25591 name signature BCIN				
6			VA3 Design Inc. 42658 registration information				
5				Contractor must verify all dimensions on the job and report any discrepancy to the Designer before proceeding with the work. All drawings and specifications are instruments of service and the property of the Designer which must be returned at the completion of the work. Drawings are not to be scaled.	date OCTOBER 2021 checked by JWM scale 3/16" = 1'-0"	PART. FLOOR PLANS 'B' drawing no. 16023-S42-19	4
3	REVISED AS PER ENG COMMENTS	MAR 03-22	RC				
2	REVISED AS PER FLOOR / ROOF LAYOUT	FEB 24-22	RC				
1	ISSUED FOR CLIENT REVIEW	NOV 26-21	VA3				
no.	description	date	by				

APPROVED RAISED HEEL ROOF TRUSSES @ 24" O.C.

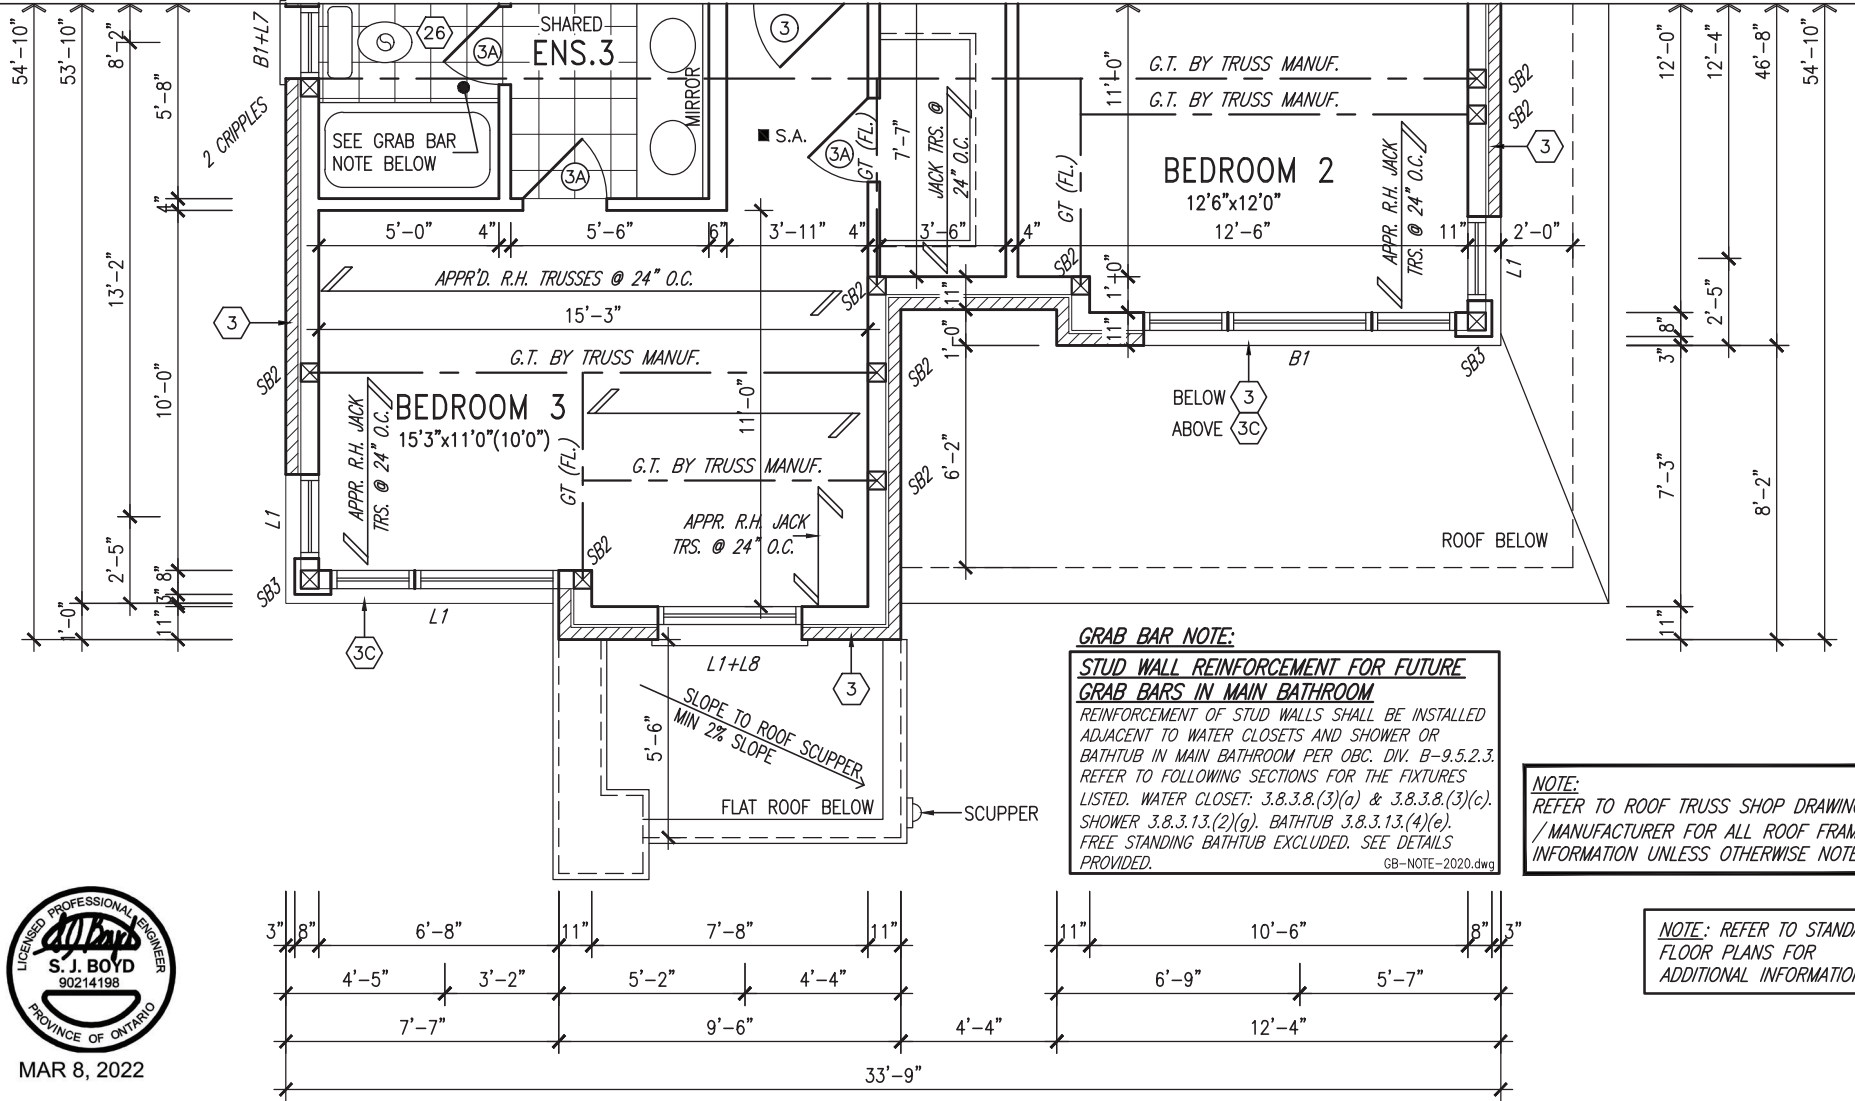

PART. SECOND FLOOR PLAN 'C'

DOOR HEIGHTS	
CEILING HEIGHT	DOOR HEIGHT
11'0" or greater	8'0" (96")
10'0"	8'0" (96")
9'0"	6'8" (80")
8'0" or lower	6'8" (80")

CONTRACTOR TO CONFIRM HEIGHTS WITH BUILDER

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JOHN G. WILLIAMS LTD., ARCHITECT
ARCHITECTURAL CONTROL REVIEW AND APPROVAL

APPROVED BY: _____
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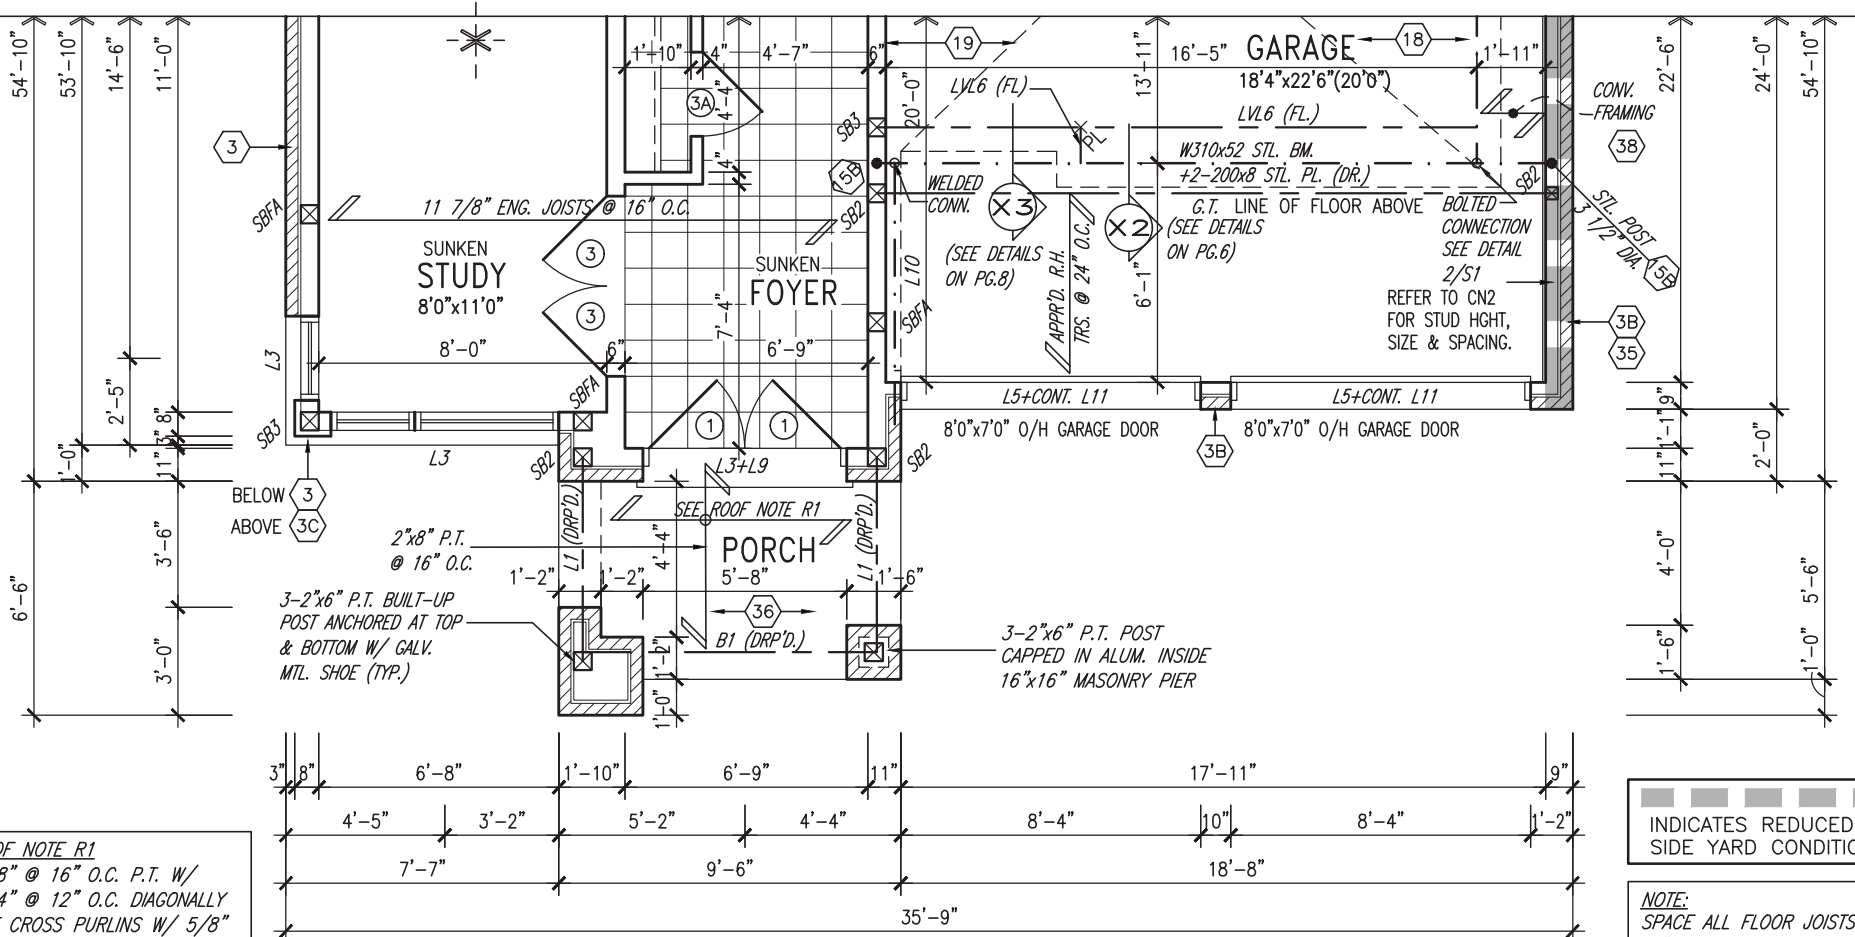
- KITCHEN EXHAUST. 3.0m
- DRIVEWAY, PARKING SPACE, ROAD. 1.5m
- SOLID FUEL APPLIANCE EXHAUST. 3.0m

KIT-EX-NOTE-2020.dwg

NOTE:
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NOTE:
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NOTE:
REFER TO STANDARD FLOOR PLANS FOR ADDITIONAL INFORMATION



PART. GROUND FLOOR PLAN 'C'

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8				qualification information
7				Wellington Jno-Baptiste 25591
6				name BCIN
5				VA3 Design Inc. 42658
4				registration information
3	REVISED AS PER ENG COMMENTS	MAR 03-22	RC	Contractor must verify all dimensions on the job and report any discrepancy to the Designer before proceeding with the work. All drawings and specifications are instruments of service and the property of the Designer which must be returned at the completion of the work. Drawings are not to be scaled.
2	REVISED AS PER FLOOR / ROOF LAYOUT	FEB 24-22	RC	
1	ISSUED FOR CLIENT REVIEW	NOV 26-21	VA3	
no.	description	date	by	

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Toronto ON M2J 1R4
t 416.630.2255 f 416.630.4782
va3design.com

BAYVIEW WELLINGTON S42-19


project name: GREEN VALLEY EAST municipality: BRADFORD, ONTARIO project no.: 16023

date: OCTOBER 2021 checked by: JWM scale: 3/16" = 1'-0"

drawing no.: 5

file name: 16023-S42-19

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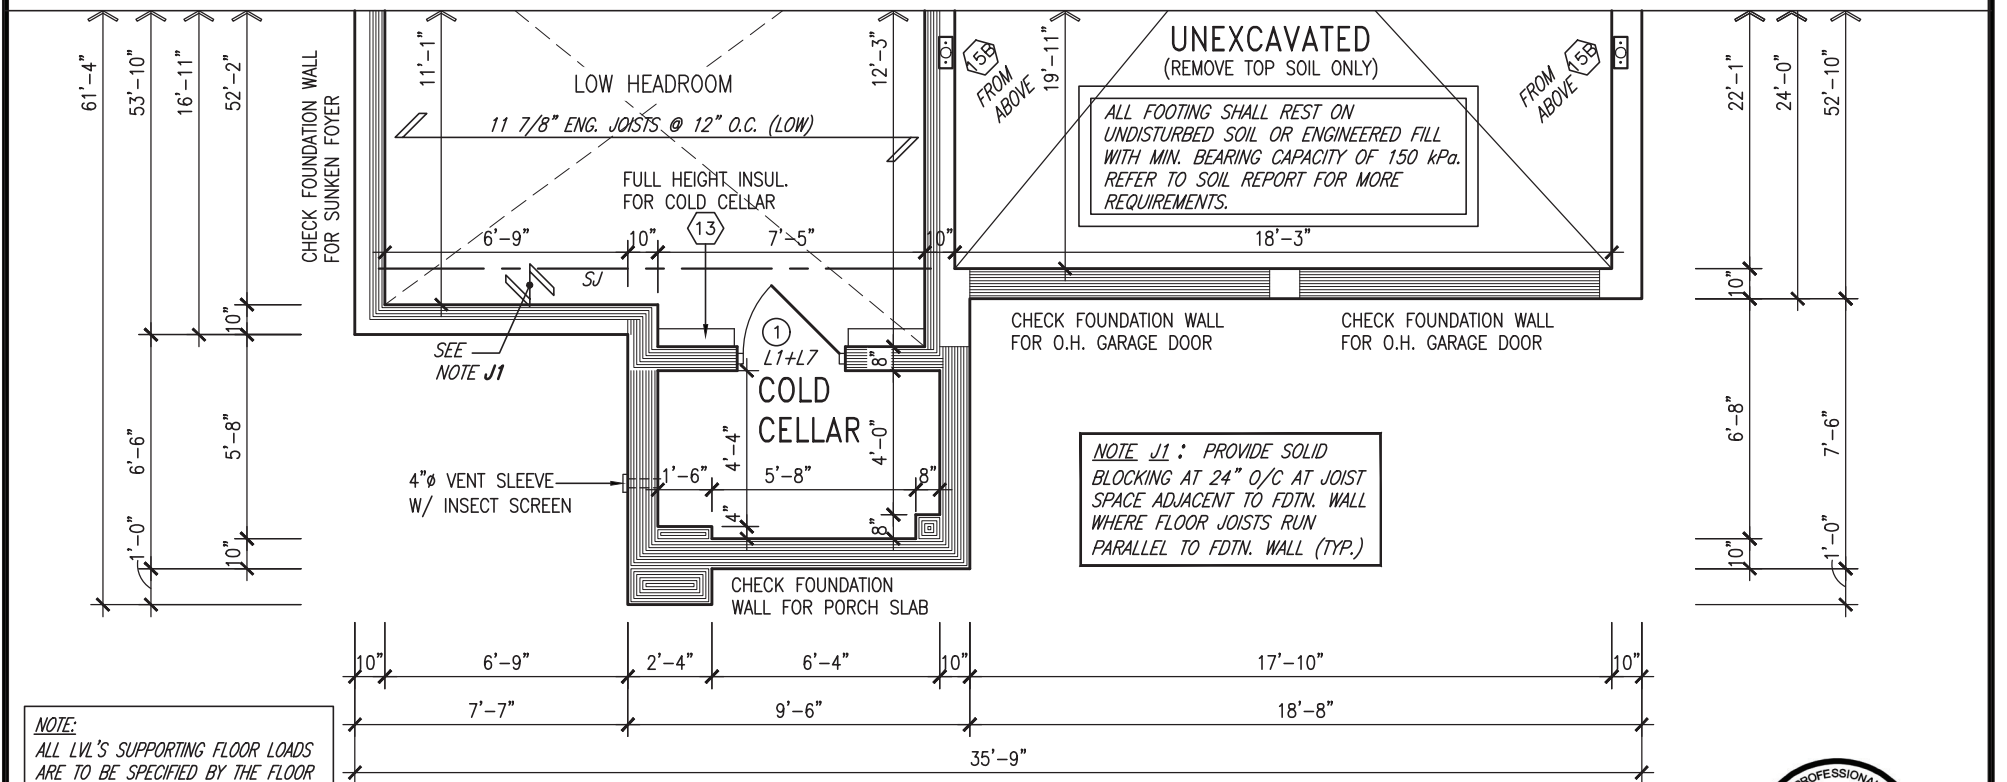
JOHN G. WILLIAMS LTD., ARCHITECT
ARCHITECTURAL CONTROL REVIEW AND APPROVAL

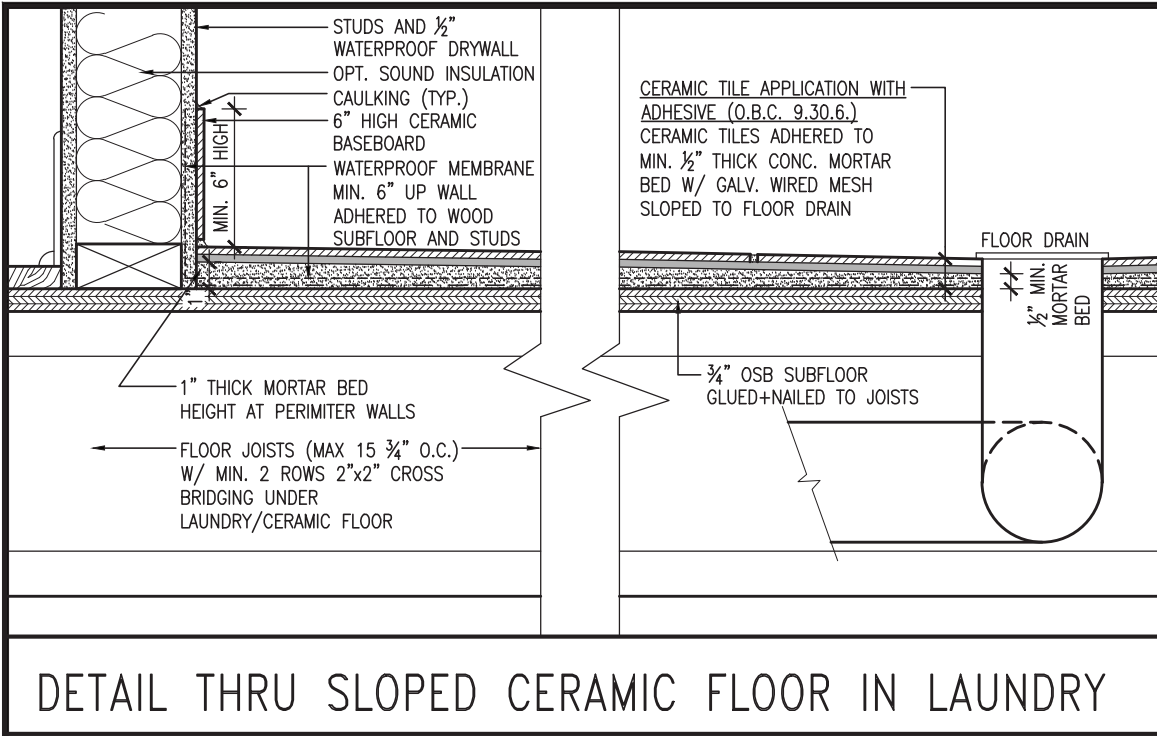APPROVED BY:

DATE: MAR 15, 2022

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DETAIL THRU SLOPED CERAMIC FLOOR IN LAUNDRY



PARTIAL BASEMENT PLAN 'C'




MAR 8, 2022

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NOTE: FLOOR FRAMING INFO REFER TO ENG SHOP DRAWINGS FOR ALL TRUSS-JOIST INFORMATION AND DETAILS. UNLESS OTHERWISE NOTED.

NOTE: REFER TO STANDARD FLOOR PLANS FOR ADDITIONAL INFORMATION

NOTE J1: PROVIDE SOLID BLOCKING AT 24" O/C AT JOIST SPACE ADJACENT TO FDTN. WALL WHERE FLOOR JOISTS RUN PARALLEL TO FDTN. WALL (TYP.)

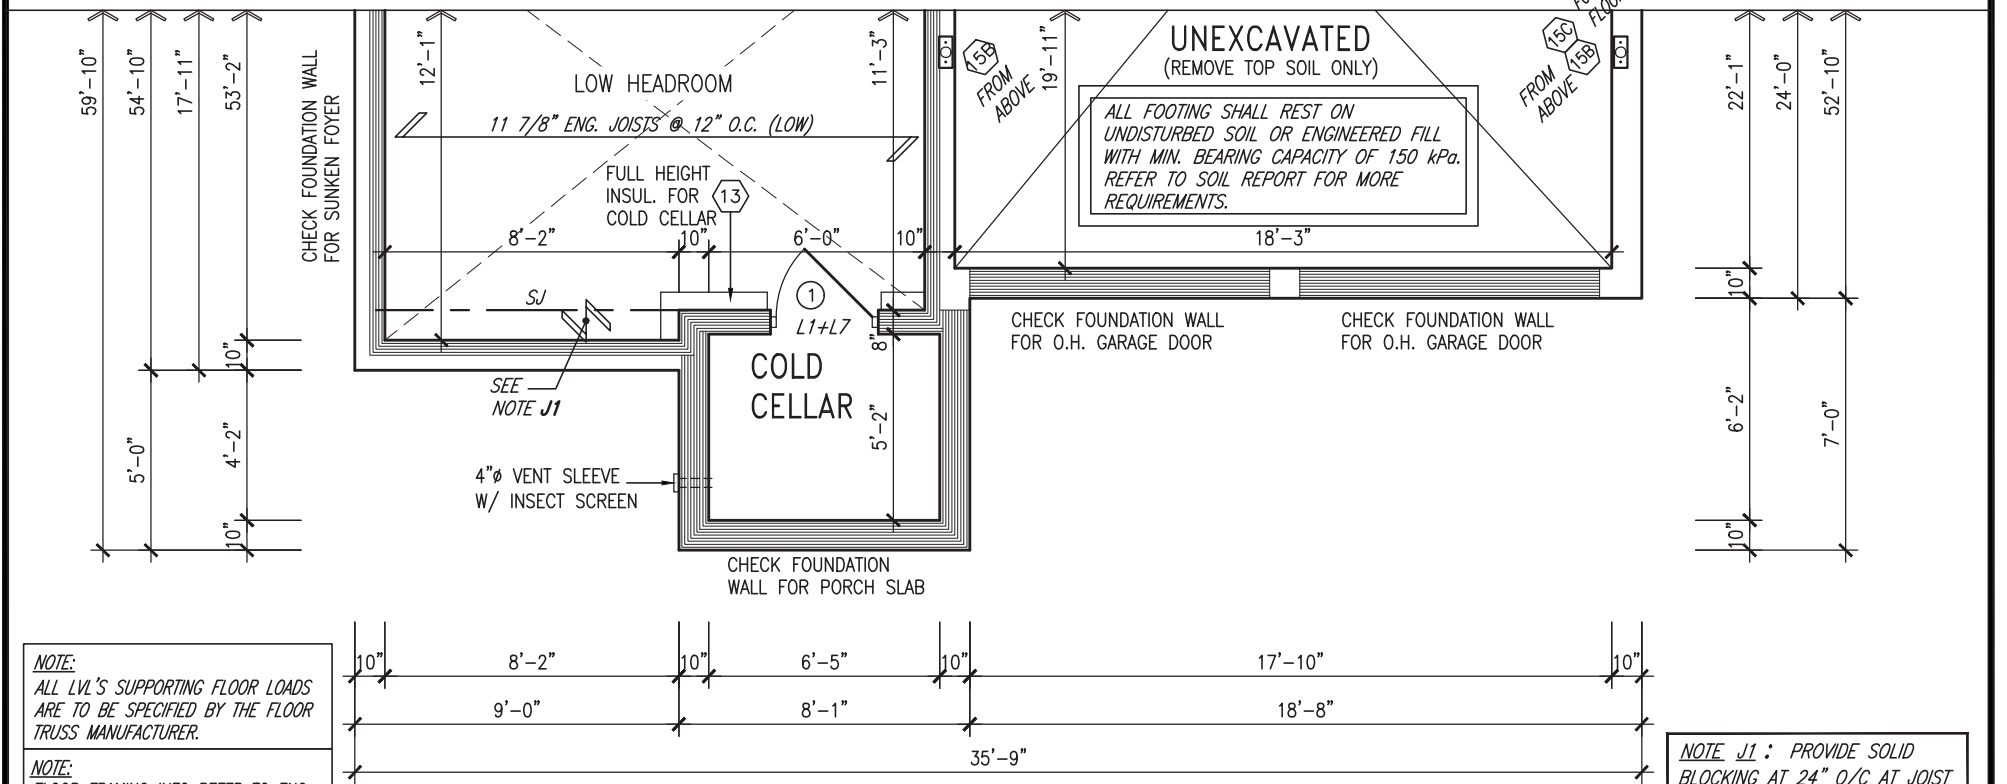

PARTIAL BASEMENT PLAN 'B'

NOTE J1: PROVIDE SOLID BLOCKING AT 24" O/C AT JOIST SPACE ADJACENT TO FDTN. WALL WHERE FLOOR JOISTS RUN PARALLEL TO FDTN. WALL (TYP.)

NOTE: ALL LVL'S SUPPORTING FLOOR LOADS ARE TO BE SPECIFIED BY THE FLOOR TRUSS MANUFACTURER.

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NOTE: REFER TO STANDARD FLOOR PLANS FOR ADDITIONAL INFORMATION

9	.	.	.
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no.	description	date	by

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Wellington Jno-Baptiste

name: Wellington Jno-Baptiste BCIN: 25591

registration information: VA3 Design Inc. 42658

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VA3 DESIGN

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t 416.630.2255 f 416.630.4782
va3design.com

BAYVIEW WELLINGTON

project name: GREEN VALLEY EAST municipality: BRADFORD, ONTARIO

project no.: 16023


date: OCTOBER 2021

drawn by: TP checked by: JWM scale: 3/16" = 1'-0"

file name: 16023-S42-19


drawing no.: 6

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PARTIAL BASEMENT PLAN W/
SUNKEN MUDROOM (-1R COND.)

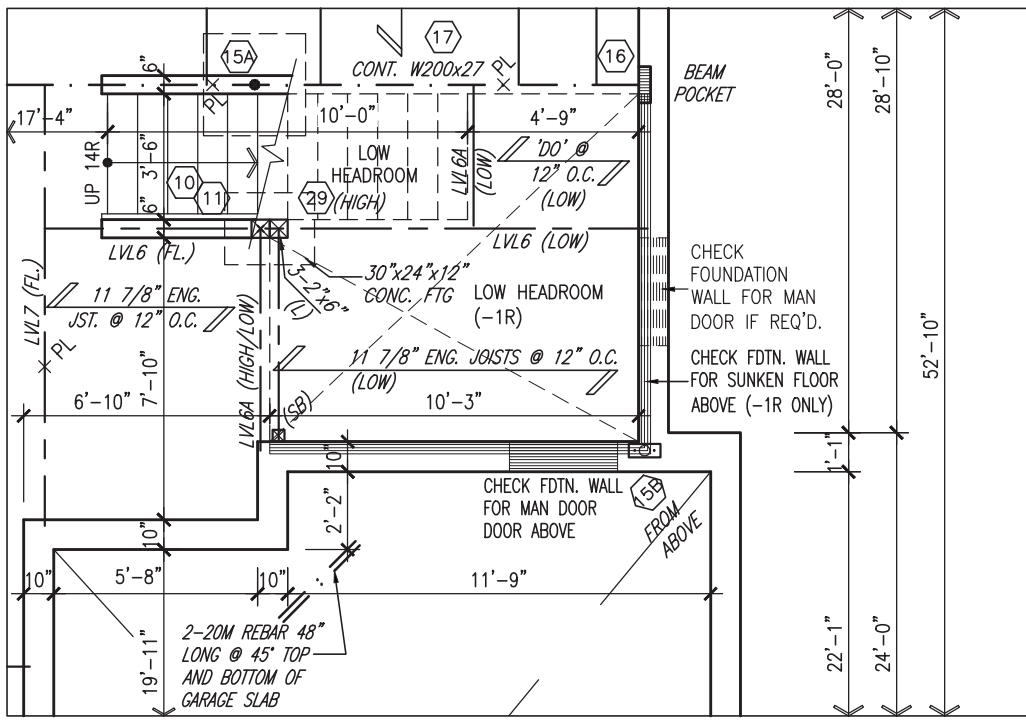NOTE: REFER TO STANDARD
FLOOR PLANS FOR
ADDITIONAL INFORMATION



PARTIAL BASEMENT PLAN W/ SUNKEN
MUDROOM (-2R TO -3R COND.)

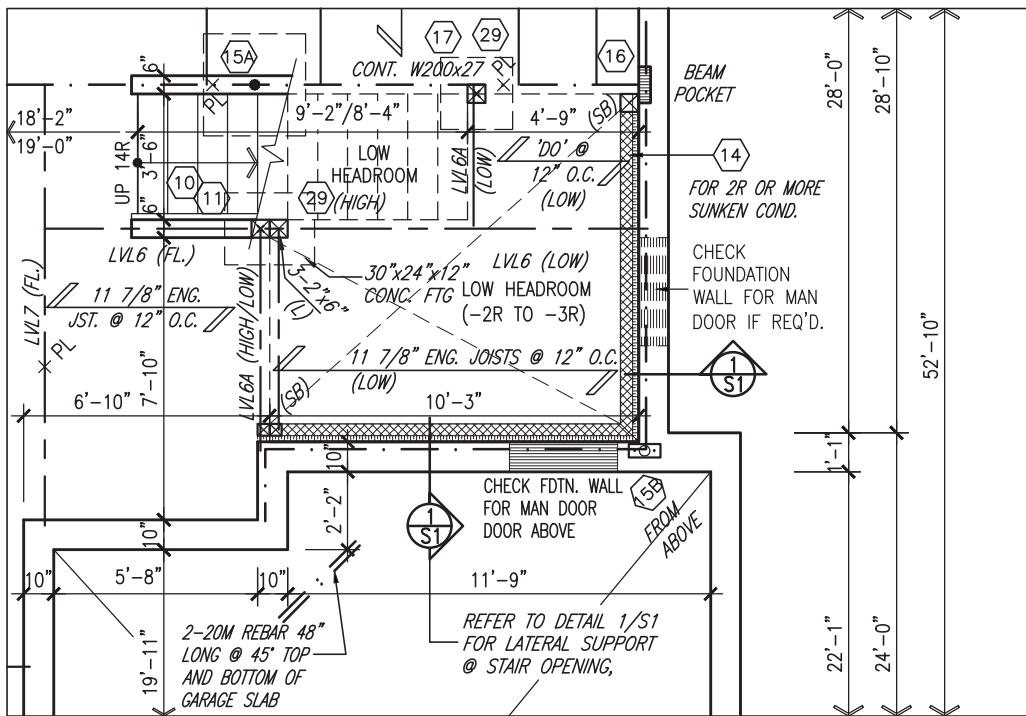
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JOHN G. WILLIAMS LTD., ARCHITECT
ARCHITECTURAL CONTROL REVIEW
AND APPROVAL

APPROVED BY: [Signature]
DATE: MAR 15, 2022

This stamp certifies compliance with the applicable Design Guidelines only and bears no further professional responsibility.



M11a 12" WALL JOG
SCALE: N.T.S.

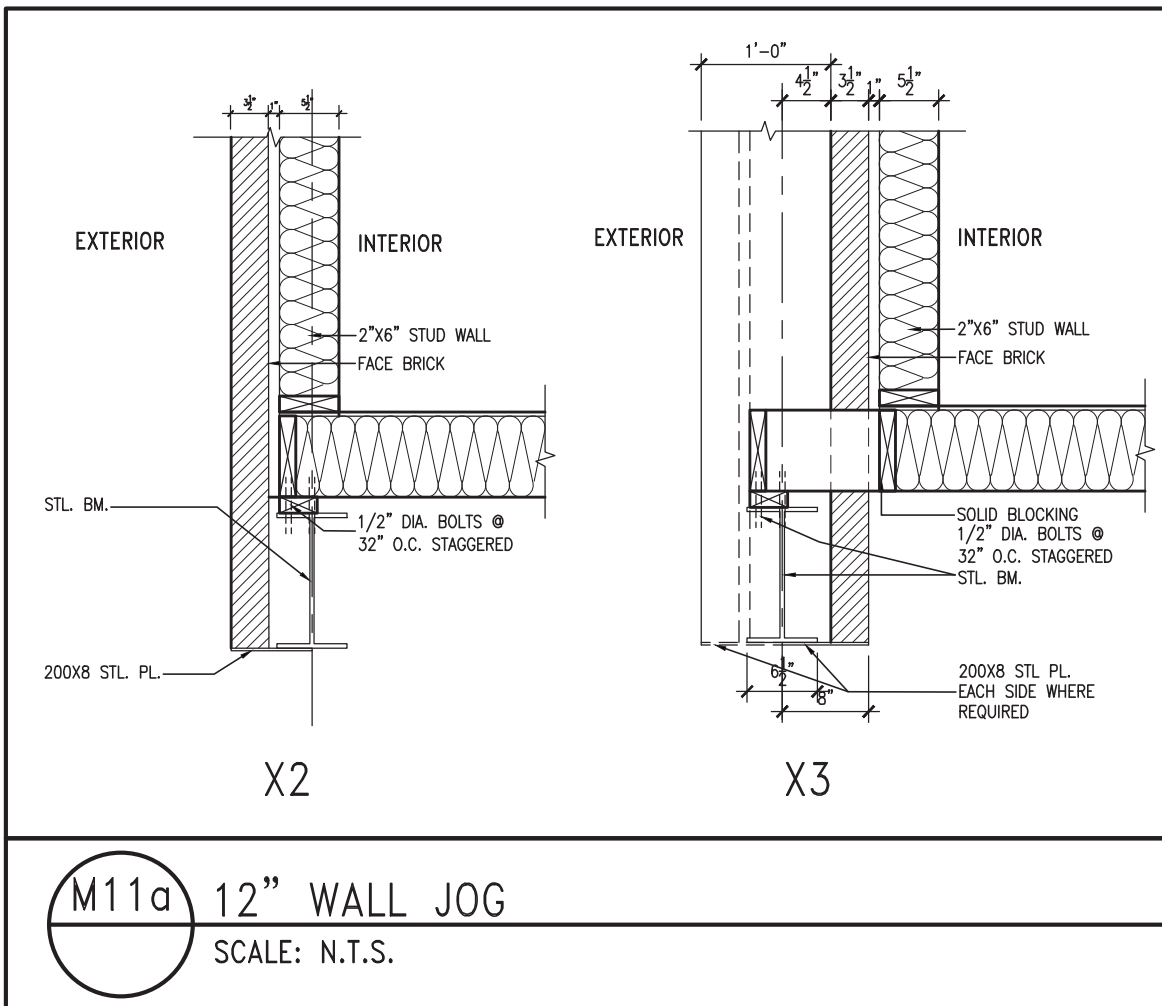


MAR 8, 2022

9	.	.	.
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7	.	.	.
6	.	.	.
5	.	.	.
4	.	.	.
3	REVISED AS PER ENG COMMENTS	MAR 03-22	RC
2	REVISED AS PER FLOOR / ROOF LAYOUT	FEB 24-22	RC
1	ISSUED FOR CLIENT REVIEW	NOV 26-21	VA3
no.	description	date	by


The undersigned has reviewed and takes responsibility for this design and has the qualifications and meets the requirements set out in the Ontario Building Code to be a Designer.
 qualification information
Wellington Jno-Baptiste 25591
 name BCIN
 registration information
VA3 Design Inc. 42658
 Contractor must verify all dimensions on the job and report any discrepancy to the Designer before proceeding with the work. All drawings and specifications are instruments of service and the property of the Designer which must be returned at the completion of the work. Drawings are not to be scaled.




BAYVIEW WELLINGTON		S42-19	
project name GREEN VALLEY EAST	municipality BRADFORD, ONTARIO	project no. 16023	
date OCTOBER 2021	checked by JWM	scale 3/16" = 1'-0"	file name 16023-S42-19
drawn by TP	PART. BASEMENT PLANS & DETAILS		drawing no. 7
RICHARD - H:\ARCHIVE\WORKING\2016\16023.BW\Units\42\16023-S42-19.dwg - Tue - Mar 8 2022 - 1:00 PM			

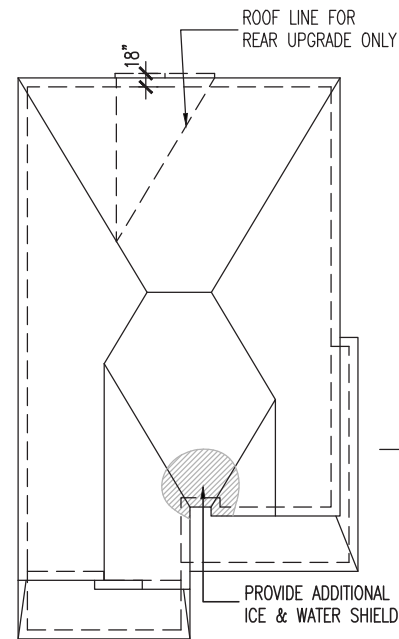

ROOF PLAN 'A'
N.T.S.

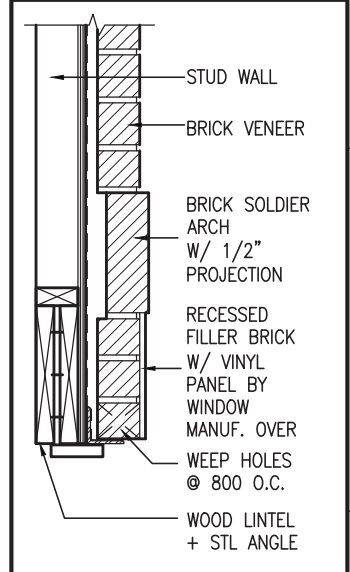

Y BRICK ARCH W/ VINYL PANEL BELOW DETAIL
N.T.S.

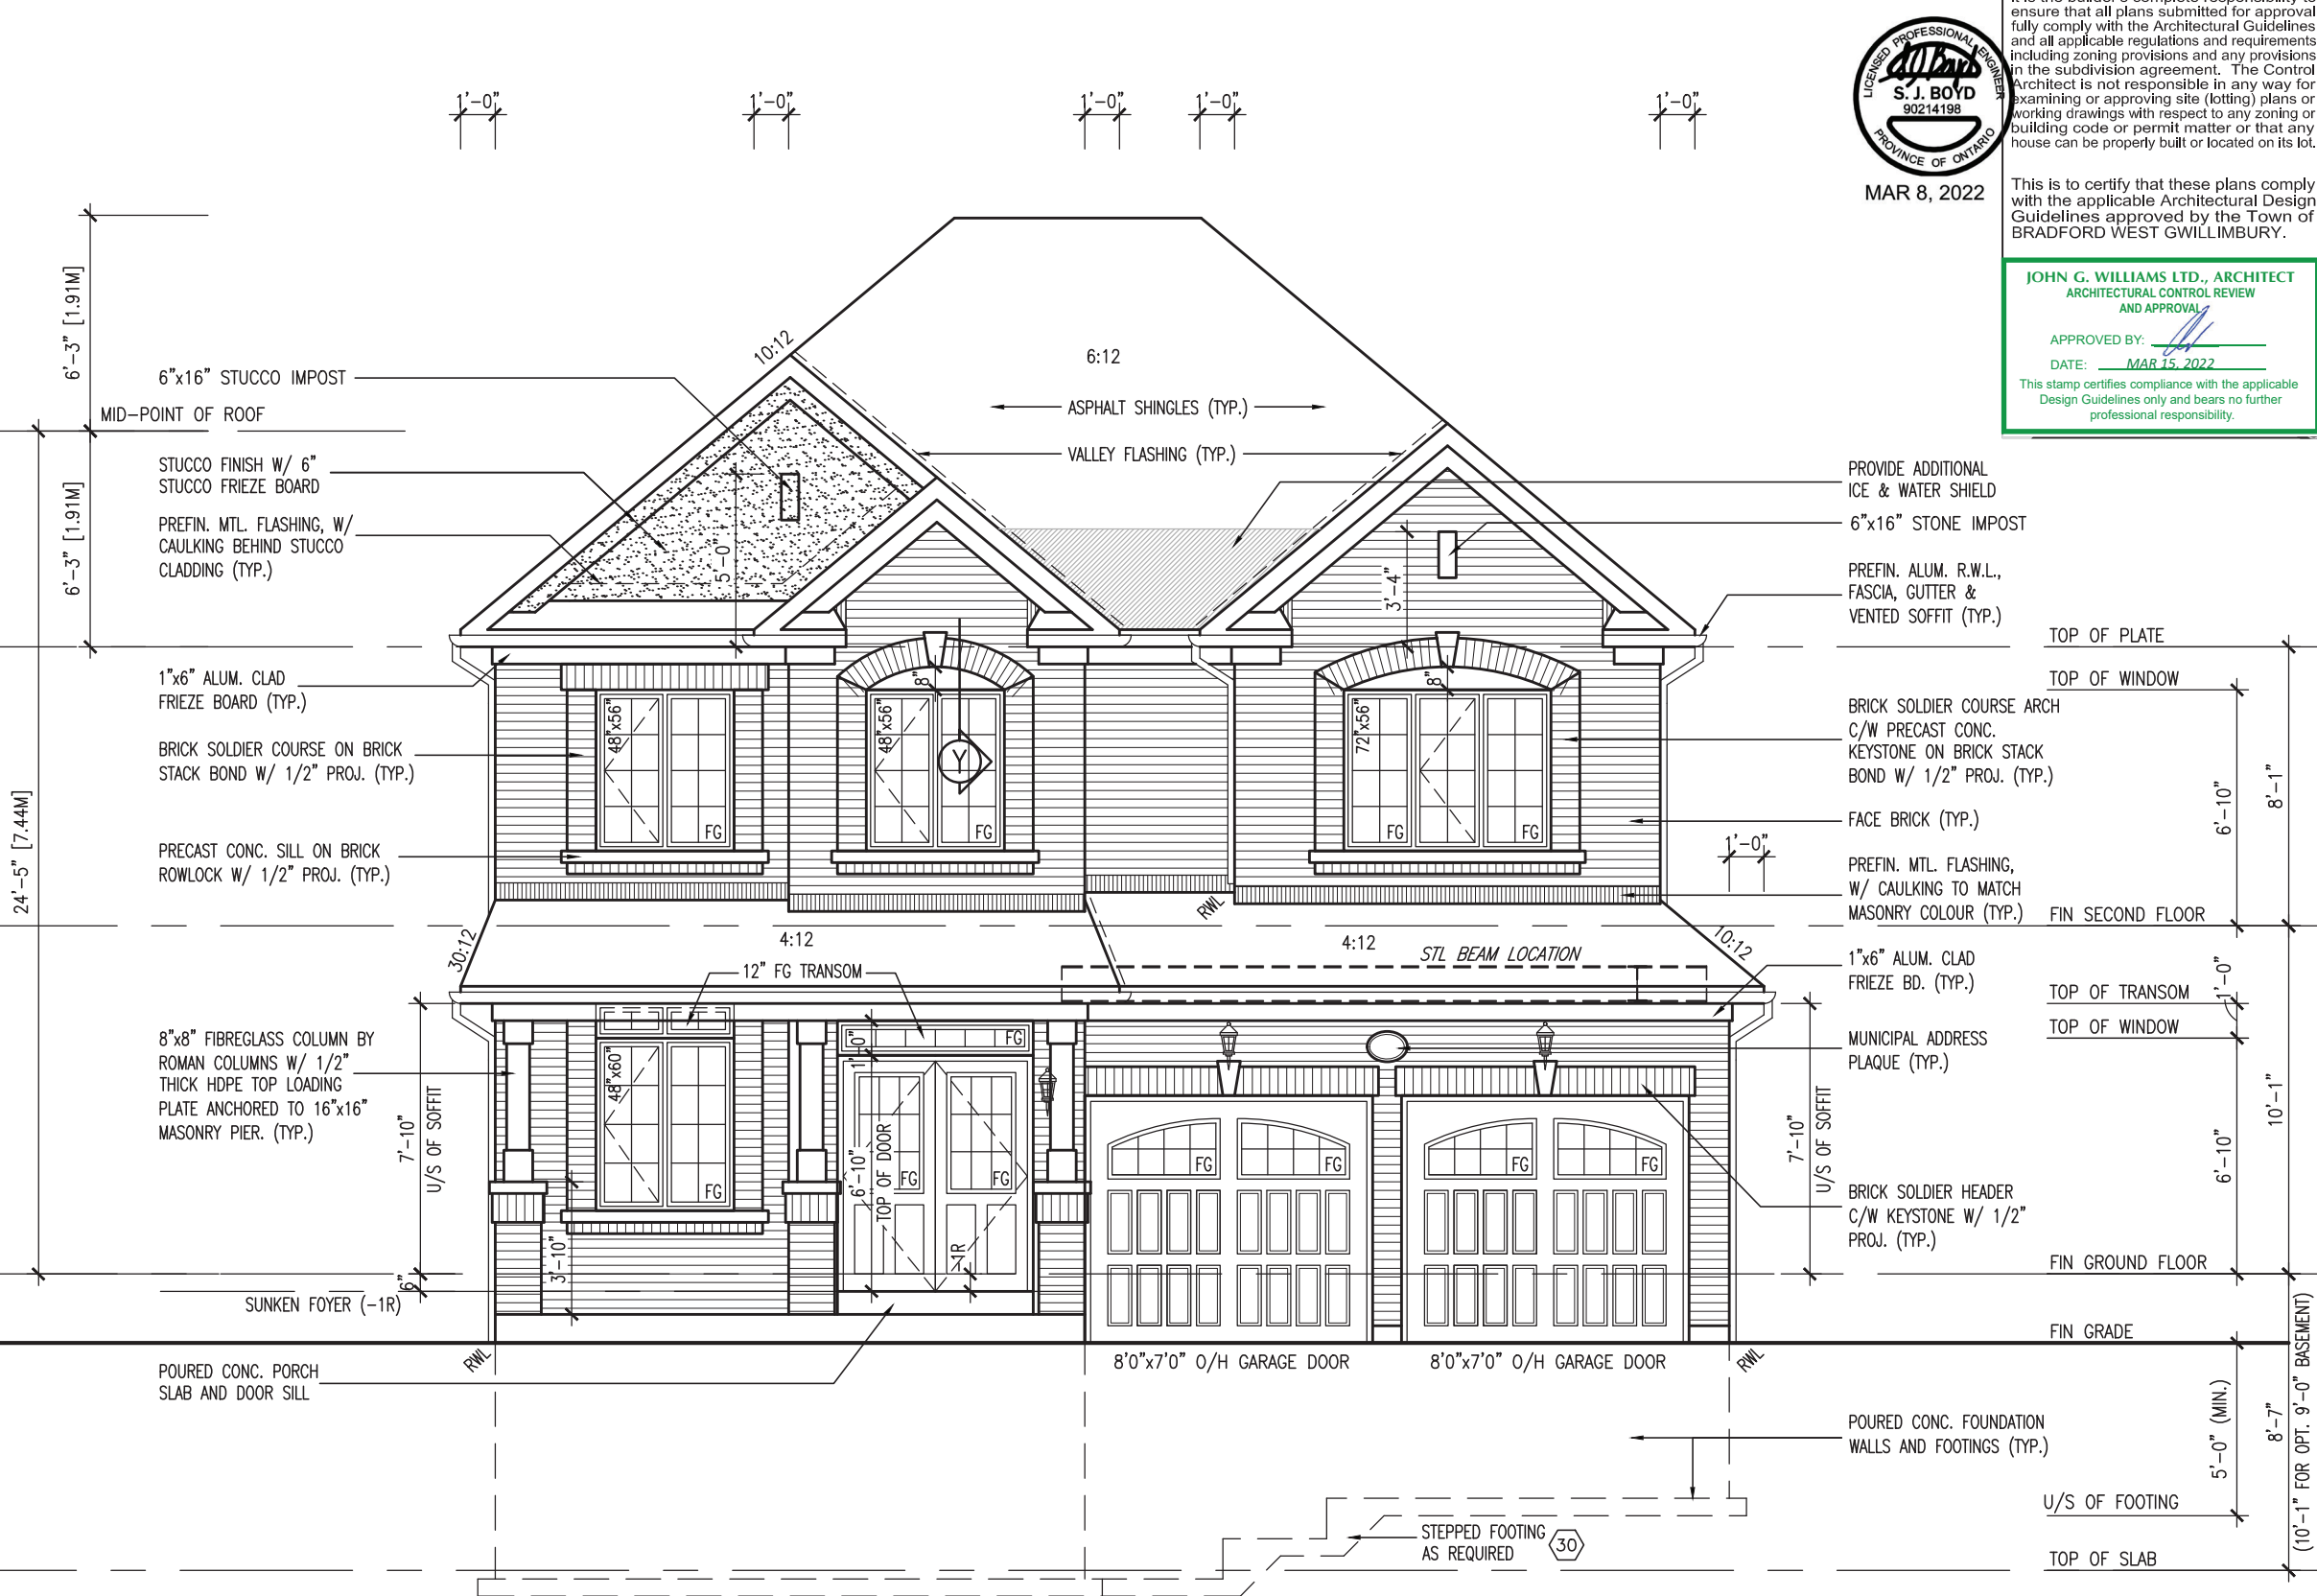

FRONT ELEVATION 'A'



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This is to certify that these plans comply with the applicable Architectural Design Guidelines approved by the Town of BRADFORD WEST GWILLIMBURY.

JOHN G. WILLIAMS LTD., ARCHITECT
ARCHITECTURAL CONTROL REVIEW AND APPROVAL

APPROVED BY: [Signature]
DATE: MAR 15, 2022

This stamp certifies compliance with the applicable Design Guidelines only and bears no further professional responsibility.

BAYVIEW WELLINGTON		S42-19	
GREEN VALLEY EAST		GREEN VALLEY EAST	
BRADFORD, ONTARIO		BRADFORD, ONTARIO	
project name	project no.	file name	drawing no.
16023	16023	16023-S42-19	8
checked by	scale	drawn by	date
JWM	3/16" = 1'-0"	JWM	OCTOBER 2021
checked by	scale	drawn by	date
JWM	3/16" = 1'-0"	JWM	OCTOBER 2021
checked by	scale	drawn by	date
JWM	3/16" = 1'-0"	JWM	OCTOBER 2021

VAS DESIGN
255 Consumers Rd, Suite 120
Toronto, ON M2J 1R4
t 416.630.2255 f 416.630.4782
vasdesign.com

Wellington Jno-Baptiste 25591 BCIN 42658

3. REVISED AS PER ENG COMMENTS MAR 03-22 RC
2. REVISED AS PER FLOOR / ROOF LAYOUT FEB 24-22 RC
1. ISSUED FOR CLIENT REVIEW NOV 26-21 VAS

no. description date by

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R.W.L. AS REQUIRED & AS PER MUNICIPALITY

NOTE: REFER TO FRONT ELEVATION FOR TYPICAL NOTE INFORMATION


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JOHN G. WILLIAMS LTD., ARCHITECT
ARCHITECTURAL CONTROL REVIEW AND APPROVAL

APPROVED BY: *[Signature]*
DATE: **MAR 15, 2022**

This stamp certifies compliance with the applicable Design Guidelines only and bears no further professional responsibility.



**** GLASS AREA ONLY ****

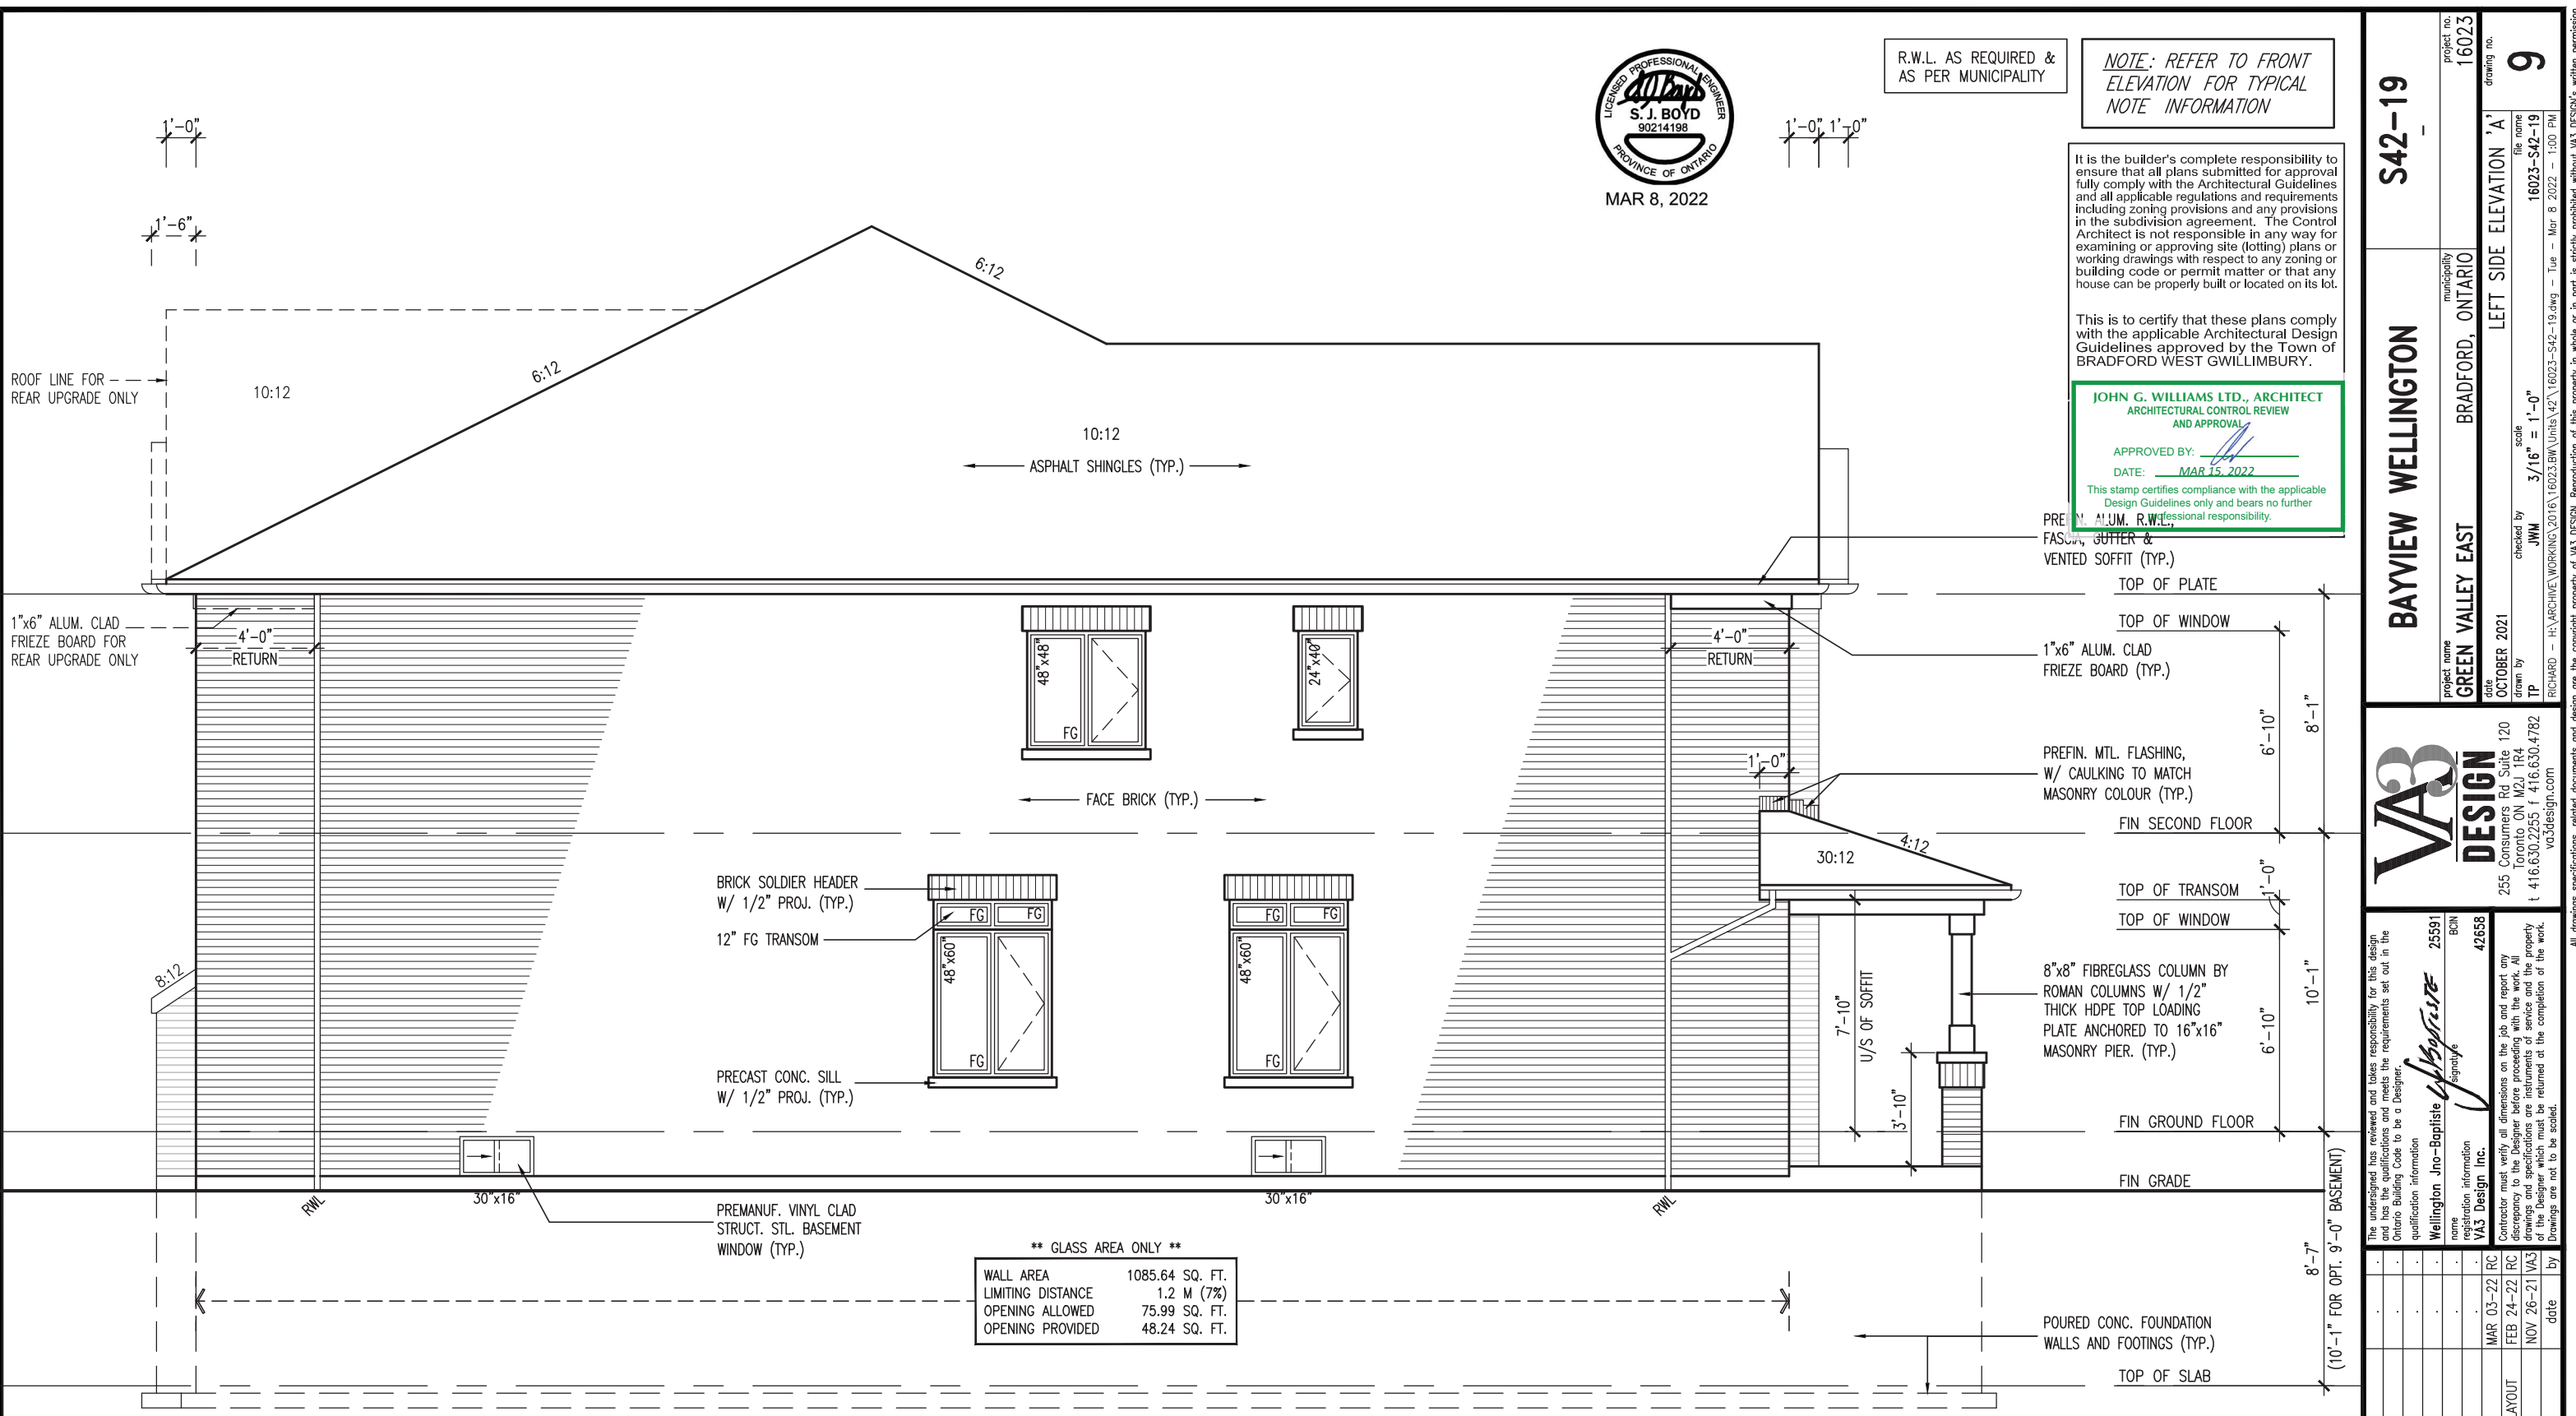WALL AREA	1085.64 SQ. FT.
LIMITING DISTANCE	1.2 M (7%)
OPENING ALLOWED	75.99 SQ. FT.
OPENING PROVIDED	48.24 SQ. FT.

LEFT SIDE ELEVATION 'A'

project no.	16023
drawing no.	9
project name	BAYVIEW WELLINGTON
municipality	BRADFORD, ONTARIO
project name	GREEN VALLEY EAST
date	OCTOBER 2021
checked by	JWM
scale	3/16" = 1'-0"
drawn by	TP
file name	16023-S42-19
date	MAR 8 2022 - 1:00 PM

VAS DESIGN
255 Consumers Rd, Suite 120
Toronto, ON M2J 1R4
t 416.630.2255 f 416.630.4782
vasdesign.com

The undersigned has reviewed and takes responsibility for this design and has the qualifications and meets the requirements set out in the Ontario Building Code to be a Designer.

Wellington Jno-Baptiste
signature
BCIN 25591
42658

name registration information VAS Design Inc.

3. REVISED AS PER ENG COMMENTS MAR 03-22 RC
2. REVISED AS PER FLOOR / ROOF LAYOUT FEB 24-22 RC
1. ISSUED FOR CLIENT REVIEW NOV 26-21 VAS

no. description by date

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BRICK VENEER CONSTRUCTION
 (FOR WALLS LESS THAN 1.2M (3'-11") FROM THE LOT LINE)
45 MINUTE FIRE RATED WALL
 PROVIDE A CONTINUOUS LAYER OF 12.7mm (1/2") TYPE 'X' GYPSUM BOARD (INTERIOR SIDE) INSTALLED SO THAT ALL EDGES ARE SUPPORTED, TAPED AND FILLED. SPACE BETWEEN WOOD STUDS TO BE FILLED WITH INSULATION CONFORMING TO CAN/ULC-S702, "MINERAL FIBRE THERMAL INSULATION FOR BUILDINGS" WITH A MASS OF NOT LESS THAN 1.22 Kg/SQ.M. AND MUST FILL AT LEAST 90% OF THE CAVITY THICKNESS. THE TYPE 'X' & INSULATION MUST BE RUN CONTINUOUSLY BEHIND ALL INTERSECTING PARTITIONS, MECHANICAL CHASES, BATHTUBS, SHOWERS, ETC. ENSURE INSULATION & TYPE 'X' IS INSTALLED IN GARAGE EXTERIOR WALLS. (REFER TO SECTION SB-2 OF OBC 2012-SUPPLEMENTARY STANDARDS)




R.W.L. AS REQUIRED & AS PER MUNICIPALITY

NOTE: REFER TO FRONT ELEVATION FOR TYPICAL NOTE INFORMATION

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ROOF LINE FOR REAR UPGRADE ONLY CONTROL REVIEW AND APPROVAL
 APPROVED BY: [Signature]
 DATE: MAR 15, 2022
VALLEY FLASHING FOR REAR UPGRADE ONLY
 This stamp certifies compliance with the applicable Architectural Guidelines only and bears no further professional responsibility.



**** GLASS AREA ONLY ****

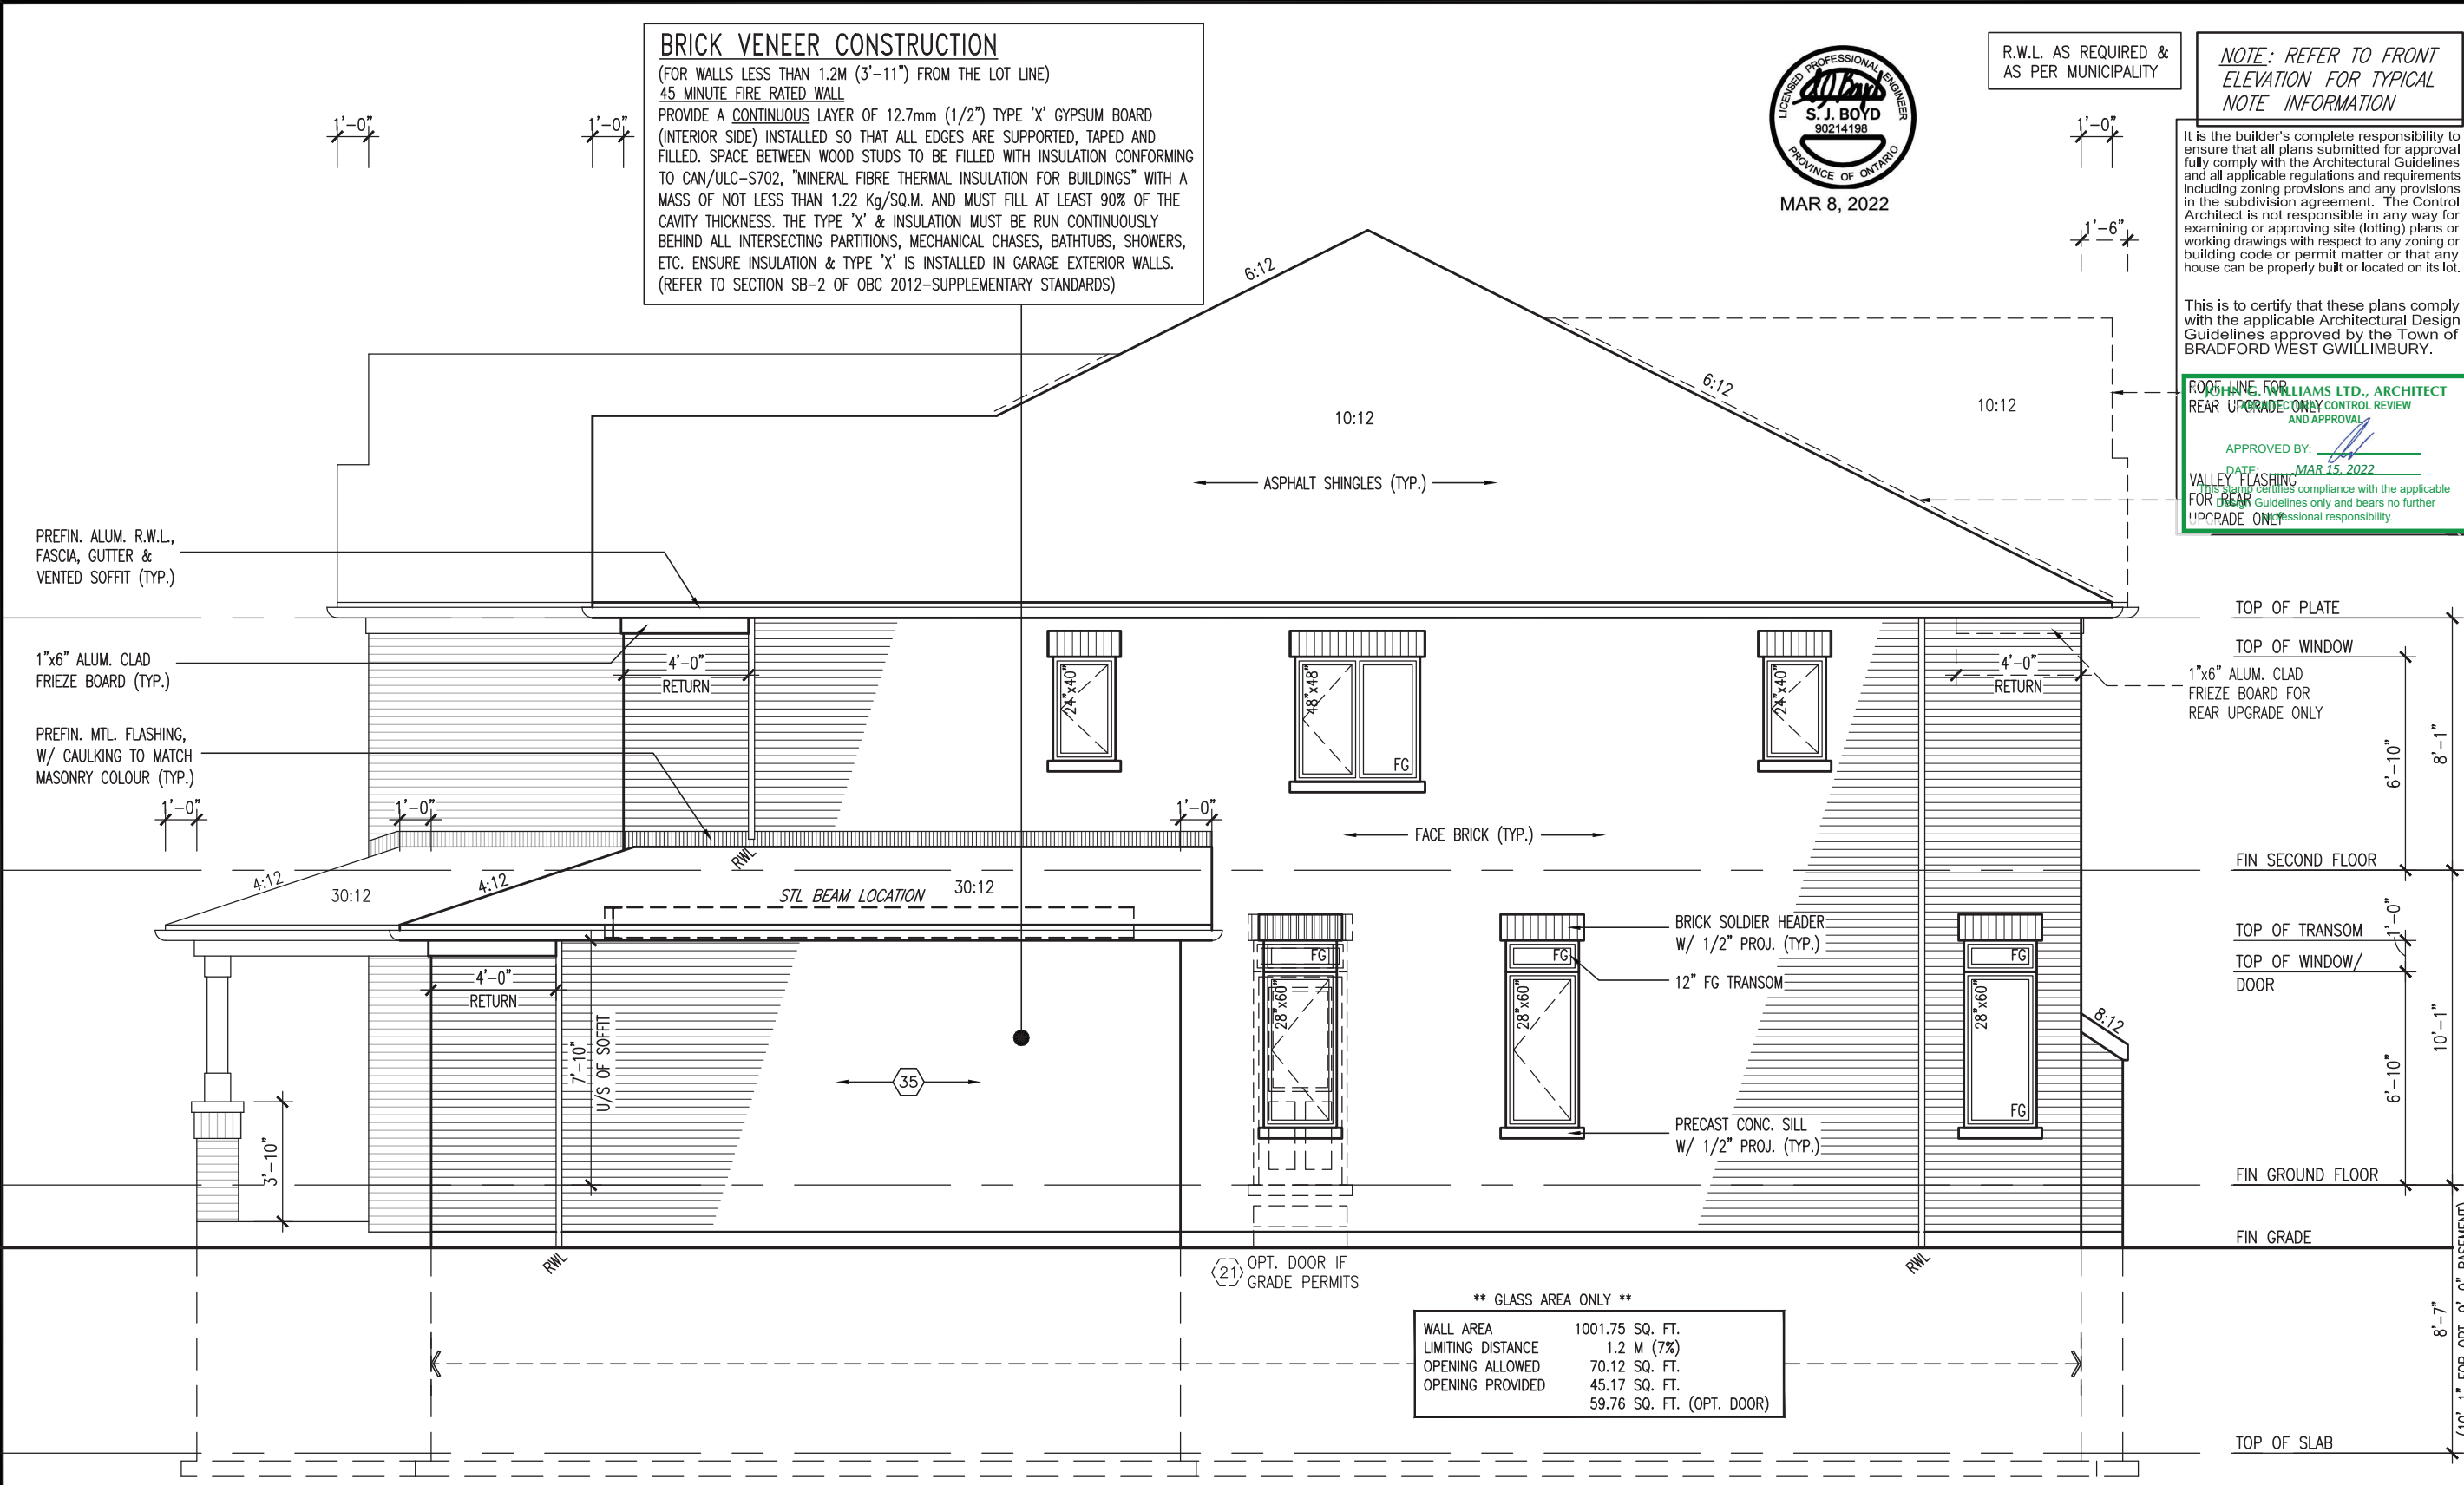WALL AREA	1001.75 SQ. FT.
LIMITING DISTANCE	1.2 M (7%)
OPENING ALLOWED	70.12 SQ. FT.
OPENING PROVIDED	45.17 SQ. FT.
	59.76 SQ. FT. (OPT. DOOR)

RIGHT SIDE ELEVATION 'A'

BAYVIEW WELLINGTON
 GREEN VALLEY EAST
 BRADFORD, ONTARIO

S42-19
 RIGHT SIDE ELEVATION 'A'

project no. 16023
 drawing no. 10

checked by JWM
 scale 3/16" = 1'-0"

date OCTOBER 2021
 drawn by TP

VAS DESIGN
 255 Consumers Rd, Suite 120
 Toronto, ON M2J 1R4
 t 416.630.2255 f 416.630.4782
 vasdesign.com

name Wellington Jno-Baptiste
 registration information 25591
 BCIN 42658
 VAS Design Inc.

3. REVISED AS PER ENG COMMENTS MAR 03-22 RC
 2. REVISED AS PER FLOOR / ROOF LAYOUT FEB 24-22 RC
 1. ISSUED FOR CLIENT REVIEW NOV 26-21 VAS


no. description date by

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JOHN G. WILLIAMS LTD., ARCHITECT
ARCHITECTURAL CONTROL REVIEW
AND APPROVAL

APPROVED BY: 
DATE: MAR 15, 2022

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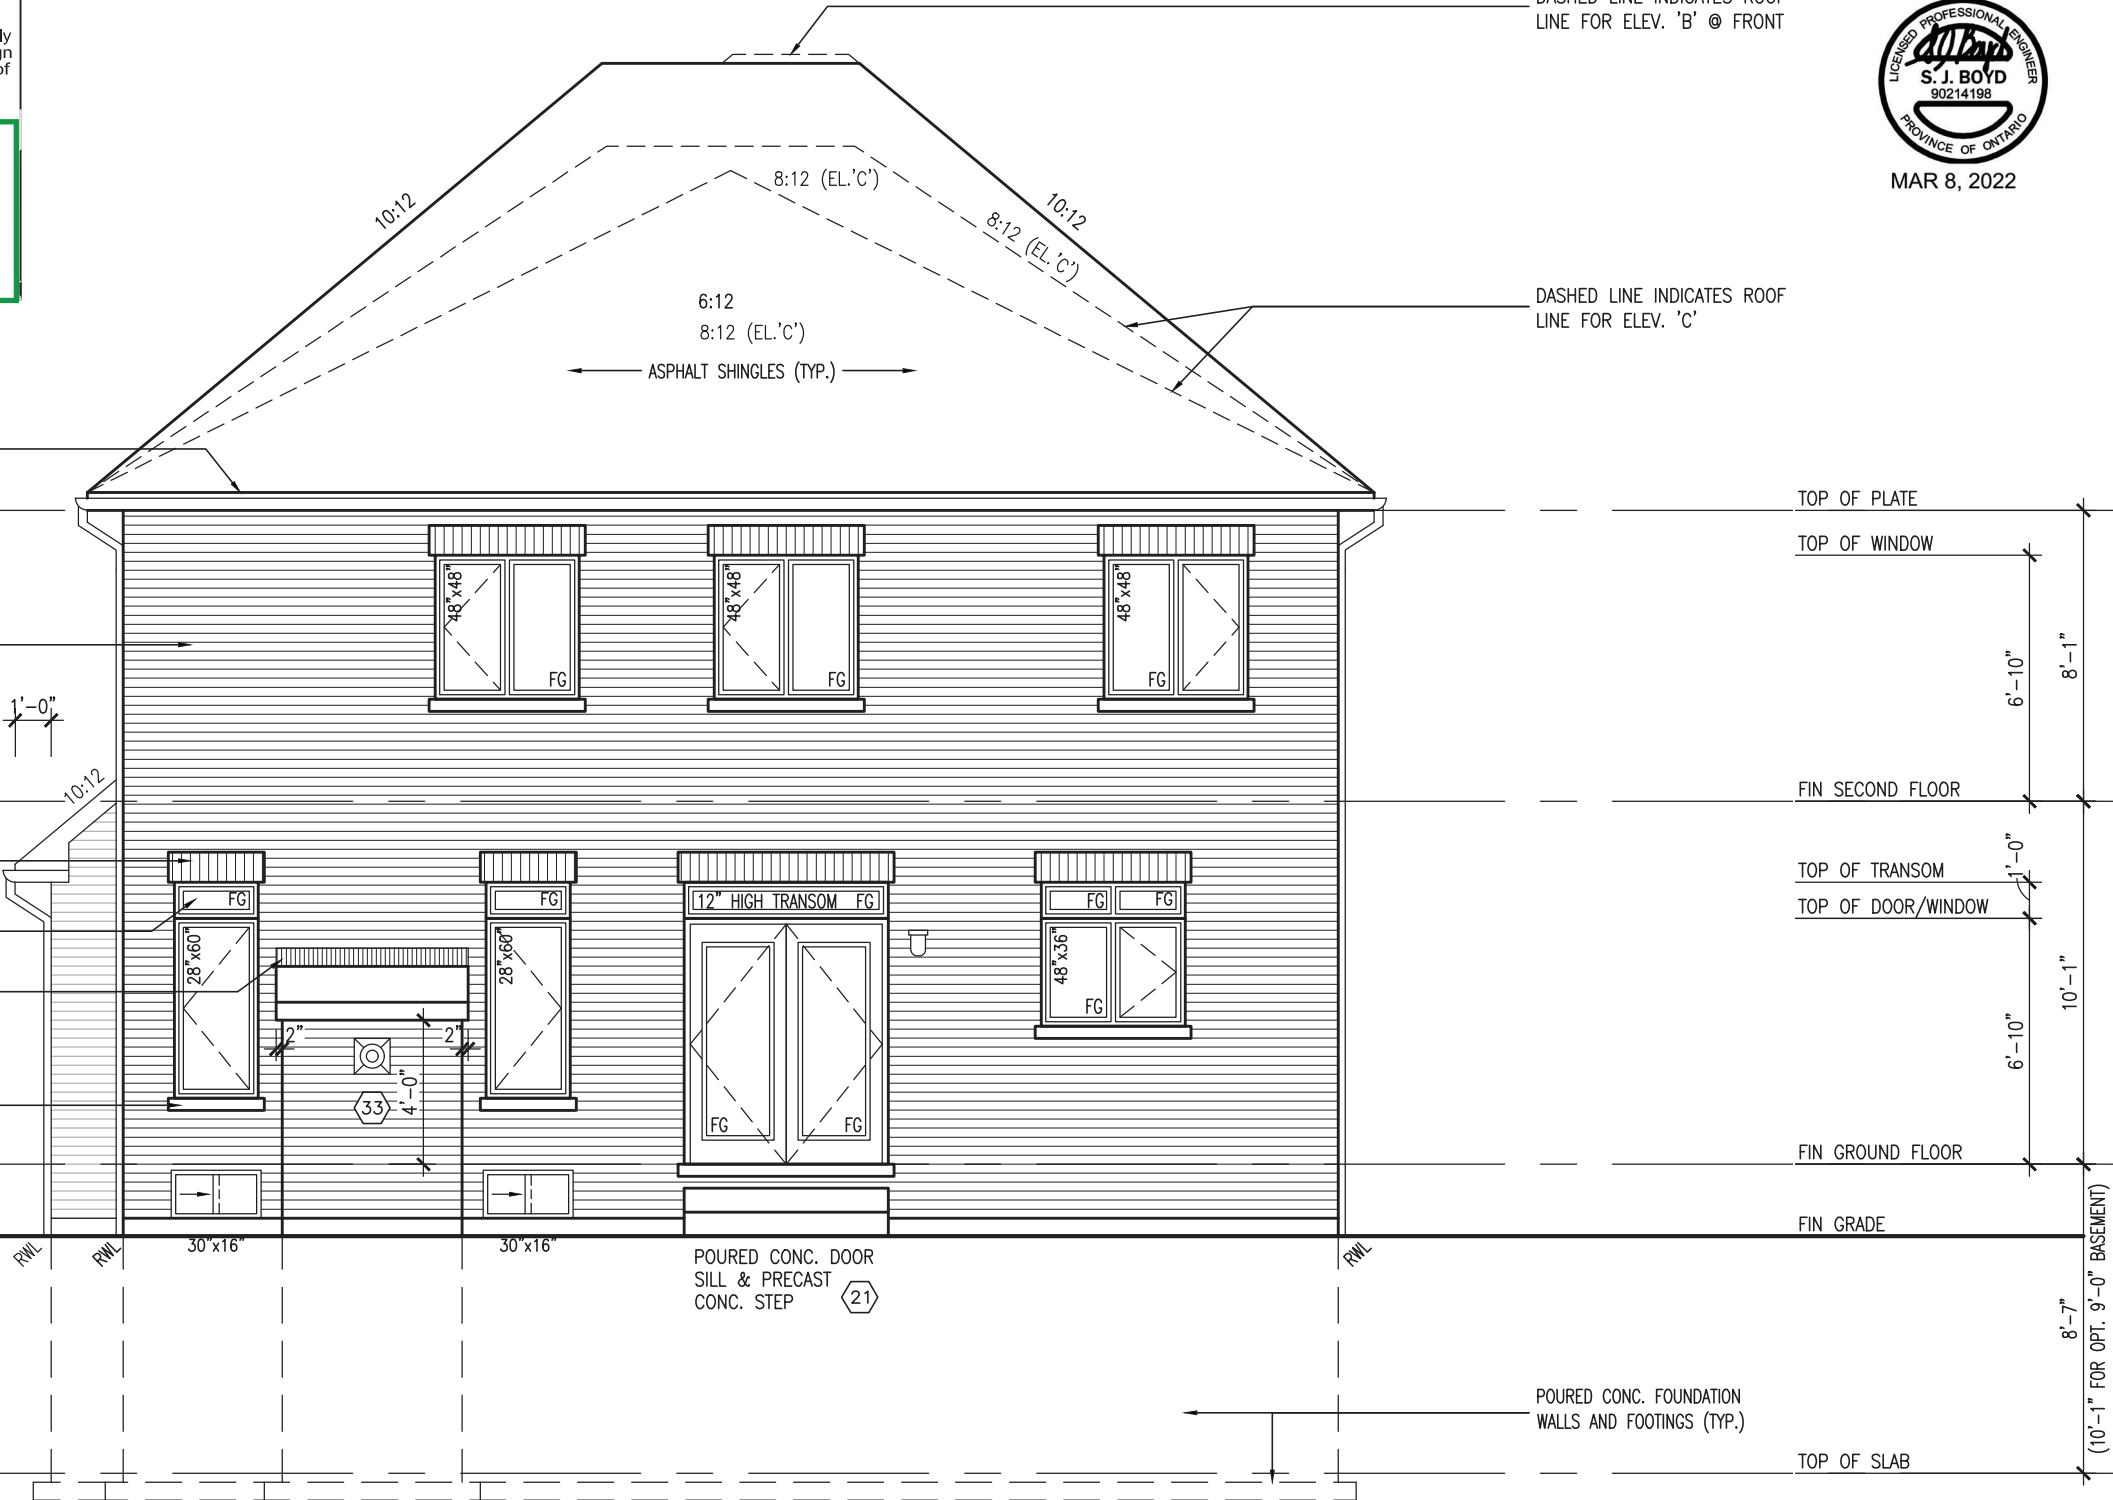
R.W.L. AS REQUIRED &
AS PER MUNICIPALITY

NOTE: REFER TO FRONT
ELEVATION FOR TYPICAL
NOTE INFORMATION



1'-0"

1'-0"



DASHED LINE INDICATES ROOF
LINE FOR ELEV. 'B' @ FRONT

DASHED LINE INDICATES ROOF
LINE FOR ELEV. 'C'

PREFIN. ALUM. R.W.L.,
FASCIA, GUTTER &
VENTED SOFFIT (TYP.)

FACE BRICK (TYP.)

BRICK SOLDIER HEADER
W/ 1/2" PROJ. (TYP.)

12" FG TRANSOM

PREFIN. MTL. FLASHING,
W/ CAULKING TO MATCH
MASONRY COLOUR (TYP.)

PRECAST CONC. SILL
W/ 1/2" PROJ. (TYP.)

POURED CONC. DOOR
SILL & PRECAST
CONC. STEP (21)

POURED CONC. FOUNDATION
WALLS AND FOOTINGS (TYP.)

TOP OF PLATE
TOP OF WINDOW
FIN SECOND FLOOR
TOP OF TRANSOM
TOP OF DOOR/WINDOW
FIN GROUND FLOOR
FIN GRADE
TOP OF SLAB

8'-1"
6'-10"
1'-0"
6'-10"
10'-1"
8'-7"
(10'-1" FOR OPT. 9'-0" BASEMENT)

REAR ELEVATION 'A'/'B'/'C'

S42-19

BAYVIEW WELLINGTON




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t 416.630.2255 f 416.630.4782
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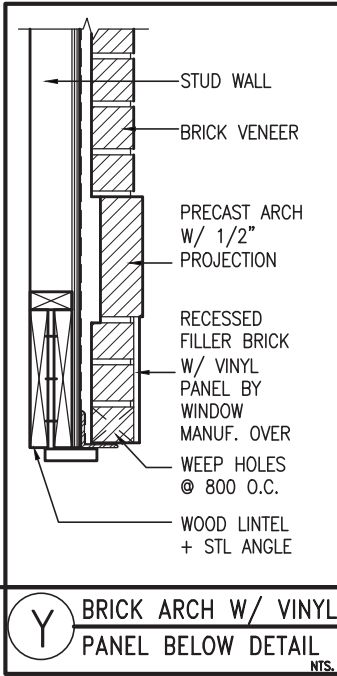
no.	description	date	by
9			
8			
7			
6			
5			
4			
3	REVISED AS PER ENG COMMENTS	MAR 03-22	RC
2	REVISED AS PER FLOOR / ROOF LAYOUT	FEB 24-22	RC
1	ISSUED FOR CLIENT REVIEW	NOV 26-21	VA3

project name: GREEN VALLEY EAST
municipality: BRADFORD, ONTARIO
project no.: 16023
drawing no.: 11
date: OCTOBER 2021
checked by: JWM
drawn by: TP
scale: 3/16" = 1'-0"
file name: 16023-S42-19



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ROOF PLAN 'B'
N.T.S.

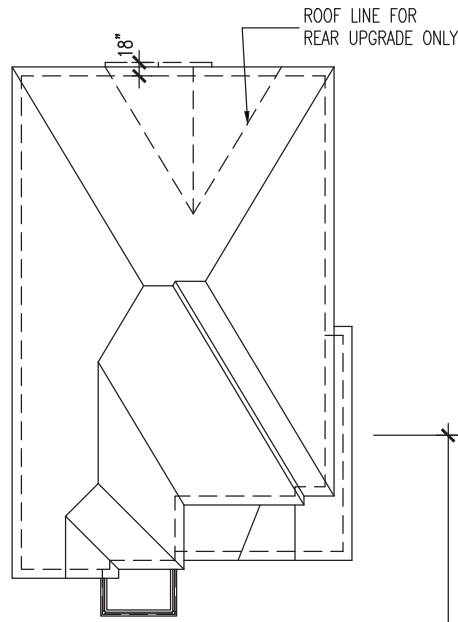

24'-6" [7.47M]



FRONT ELEVATION 'B'
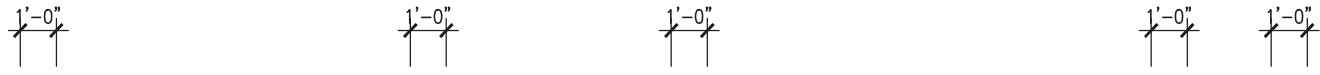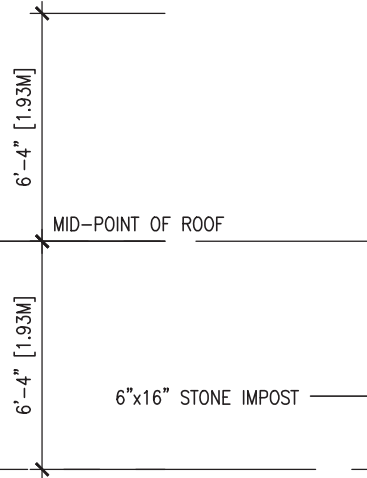
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JOHN G. WILLIAMS LTD., ARCHITECT
ARCHITECTURAL CONTROL REVIEW AND APPROVAL

APPROVED BY:

DATE: MAR 15, 2022

This stamp certifies compliance with the applicable Design Guidelines only and bears no further professional responsibility.



- ASPHALT SHINGLES (TYP.)
- VALLEY FLASHING (TYP.)
- PREFIN. ALUM. R.W.L., FASCIA, GUTTER & VENTED SOFFIT (TYP.)
- FACE BRICK (TYP.)
- PREFIN. MTL. FLASHING, W/ CAULKING TO MATCH MASONRY COLOUR (TYP.)
- 1"x6" ALUM. CLAD FRIEZE BD. (TYP.)
- MUNICIPAL ADDRESS PLAQUE (TYP.)
- 8" PRECAST CONC. HEADER W/ 1/2" PROJ. (TYP.)

- TOP OF PLATE
- TOP OF WINDOW
- 8'-1"
- 6'-10"
- FIN SECOND FLOOR
- TOP OF TRANSOM
- TOP OF WINDOW
- 10'-1"
- 6'-10"
- FIN GROUND FLOOR
- FIN GRADE
- 8'-7"
- 5'-0" (MIN.)
- (10'-1" FOR OPT. 9'-0" BASEMENT)
- U/S OF FOOTING
- TOP OF SLAB

BAYVIEW WELLINGTON		S42-19	
project name	GREEN VALLEY EAST	municipality	BRADFORD, ONTARIO
project no.	16023	drawing no.	12
date	OCTOBER 2021	checked by	JWM
drawn by	TP	scale	3/16" = 1'-0"
file name	16023-S42-19	drawn on	16023-S42-19
drawn by	TP	drawn on	16023-S42-19

1	ISSUED FOR CLIENT REVIEW	NOV 26-21	VA3
2	REVISED AS PER FLOOR / ROOF LAYOUT	FEB 24-22	RC
3	REVISED AS PER ENG COMMENTS	MAR 03-22	RC
4			
5			
6			
7			
8			
9			

The undersigned has reviewed and takes responsibility for this design and has the qualifications and meets the requirements set out in the Ontario Building Code to be a Designer.

Wellington Jno-Baptiste (signature)
BCIN 25591
BIN 42658

Contractor must verify all dimensions on the job and report any discrepancy to the Designer before proceeding with the work. All drawings and specifications are instruments of service and the property of the Designer which must be returned at the completion of the work. Drawings are not to be scaled.

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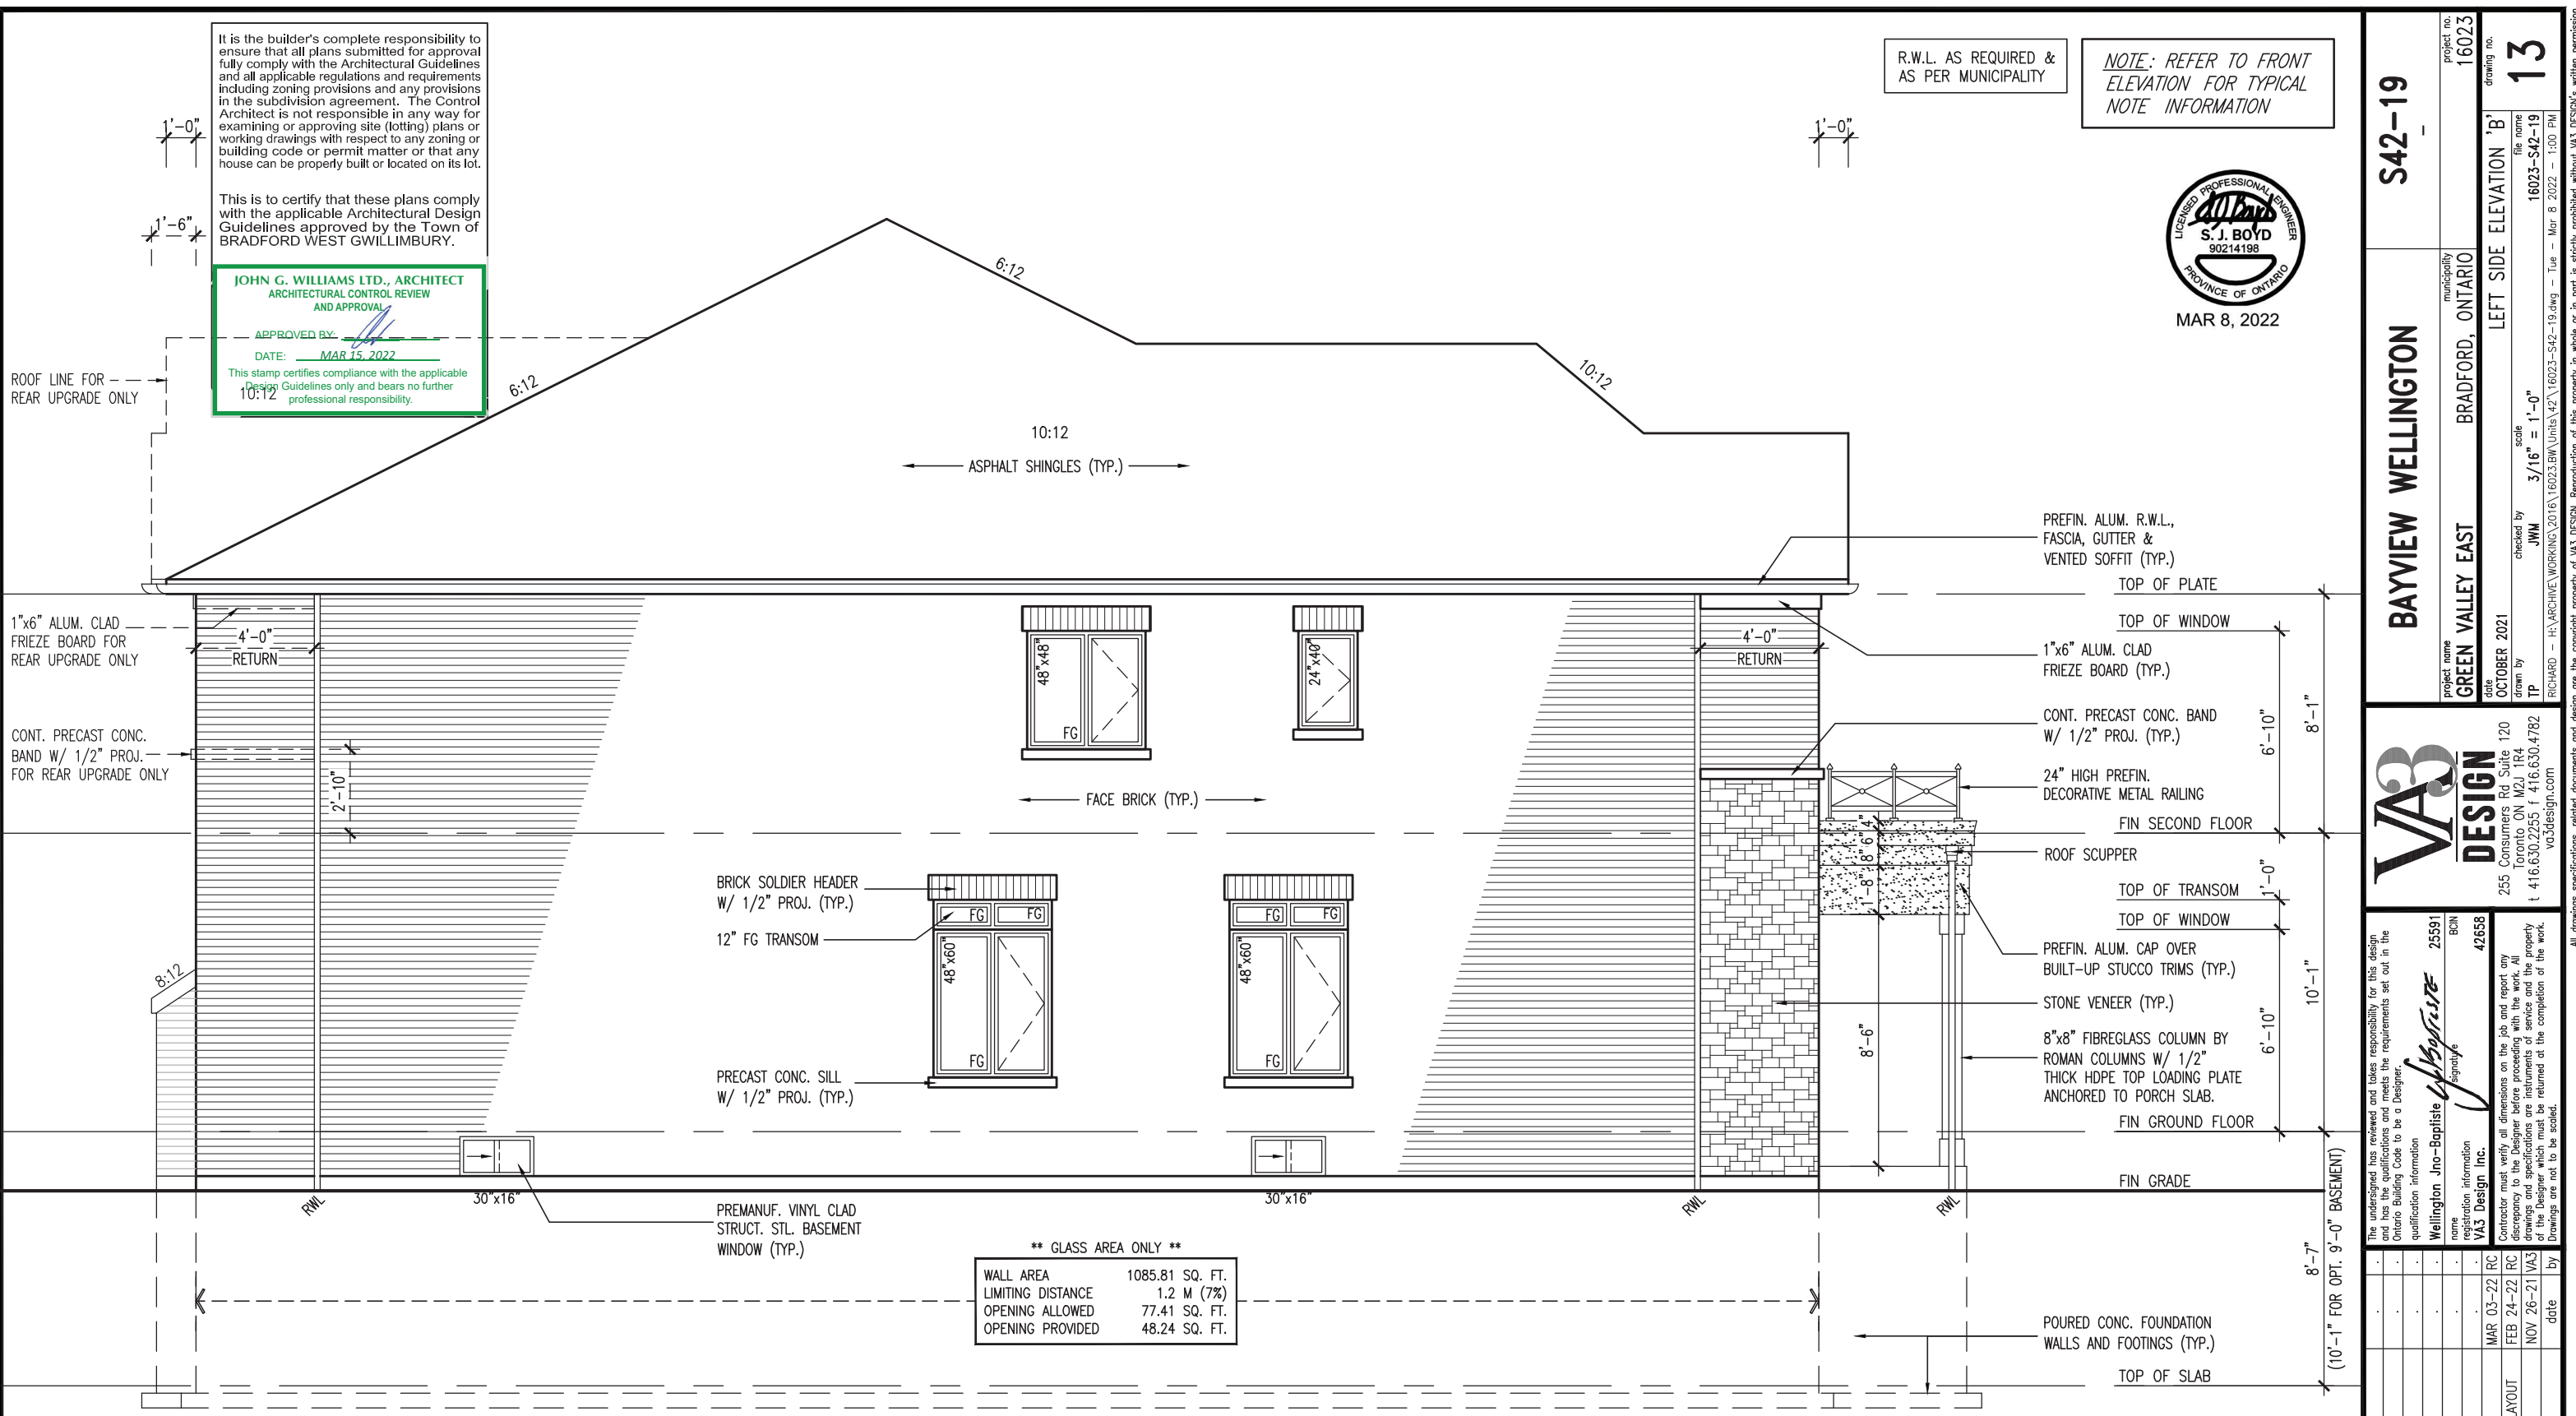
JOHN G. WILLIAMS LTD., ARCHITECT
ARCHITECTURAL CONTROL REVIEW AND APPROVAL

APPROVED BY: *[Signature]*
DATE: MAR 15, 2022

This stamp certifies compliance with the applicable Design Guidelines only and bears no further professional responsibility.

R.W.L. AS REQUIRED & AS PER MUNICIPALITY

NOTE: REFER TO FRONT ELEVATION FOR TYPICAL NOTE INFORMATION



**** GLASS AREA ONLY ****

WALL AREA	1085.81 SQ. FT.
LIMITING DISTANCE	1.2 M (7%)
OPENING ALLOWED	77.41 SQ. FT.
OPENING PROVIDED	48.24 SQ. FT.

LEFT SIDE ELEVATION 'B'

BAYVIEW WELLINGTON		S42-19	
project name	GREEN VALLEY EAST	municipality	BRADFORD, ONTARIO
project no.	16023	drawing no.	13
date	OCTOBER 2021	checked by	JWM
drawn by	TP	scale	3/16" = 1'-0"
file name	16023-S42-19	drawn on	16023-S42-19.dwg
drawn by	TP	drawn on	16023-S42-19.dwg
checked by	JWM	checked on	16023-S42-19.dwg
drawn by	TP	drawn on	16023-S42-19.dwg
checked by	JWM	checked on	16023-S42-19.dwg
drawn by	TP	drawn on	16023-S42-19.dwg

VAS DESIGN	
255 Consumers Rd. Suite 120	416.630.4782
Toronto, ON M2J 1R4	vasdesign.com
416.630.2255	

name	Wellington Jno-Baptiste	BCIN	25591
registration information	VAS Design Inc.	BCIN	42658
date	MAR 03-22	RC	
description	REVISED AS PER ENG COMMENTS		
date	FEB 24-22	RC	
description	REVISED AS PER FLOOR / ROOF LAYOUT		
date	NOV 26-21	VAS	
description	ISSUED FOR CLIENT REVIEW		

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JOHN G. WILLIAMS LTD., ARCHITECT
ARCHITECTURAL CONTROL REVIEW
AND APPROVAL

APPROVED BY: _____
DATE: MAR 15, 2022

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BRICK VENEER CONSTRUCTION

(FOR WALLS LESS THAN 1.2M (3'-11") FROM THE LOT LINE)

45 MINUTE FIRE RATED WALL


PROVIDE A CONTINUOUS LAYER OF 12.7mm (1/2") TYPE 'X' GYPSUM BOARD (INTERIOR SIDE) INSTALLED SO THAT ALL EDGES ARE SUPPORTED, TAPED AND FILLED. SPACE BETWEEN WOOD STUDS TO BE FILLED WITH INSULATION CONFORMING TO CAN/ULC-S702, "MINERAL FIBRE THERMAL INSULATION FOR BUILDINGS" WITH A MASS OF NOT LESS THAN 1.22 Kg/SQ.M. AND MUST FILL AT LEAST 90% OF THE CAVITY THICKNESS. THE TYPE 'X' & INSULATION MUST BE RUN CONTINUOUSLY BEHIND ALL INTERSECTING PARTITIONS, MECHANICAL CHASES, BATHTUBS, SHOWERS, ETC. ENSURE INSULATION & TYPE 'X' IS INSTALLED IN GARAGE EXTERIOR WALLS. (REFER TO SECTION SB-2 OF OBC 2012-SUPPLEMENTARY STANDARDS)

R.W.L. AS REQUIRED & AS PER MUNICIPALITY

NOTE: REFER TO FRONT ELEVATION FOR TYPICAL NOTE INFORMATION



MAR 8, 2022

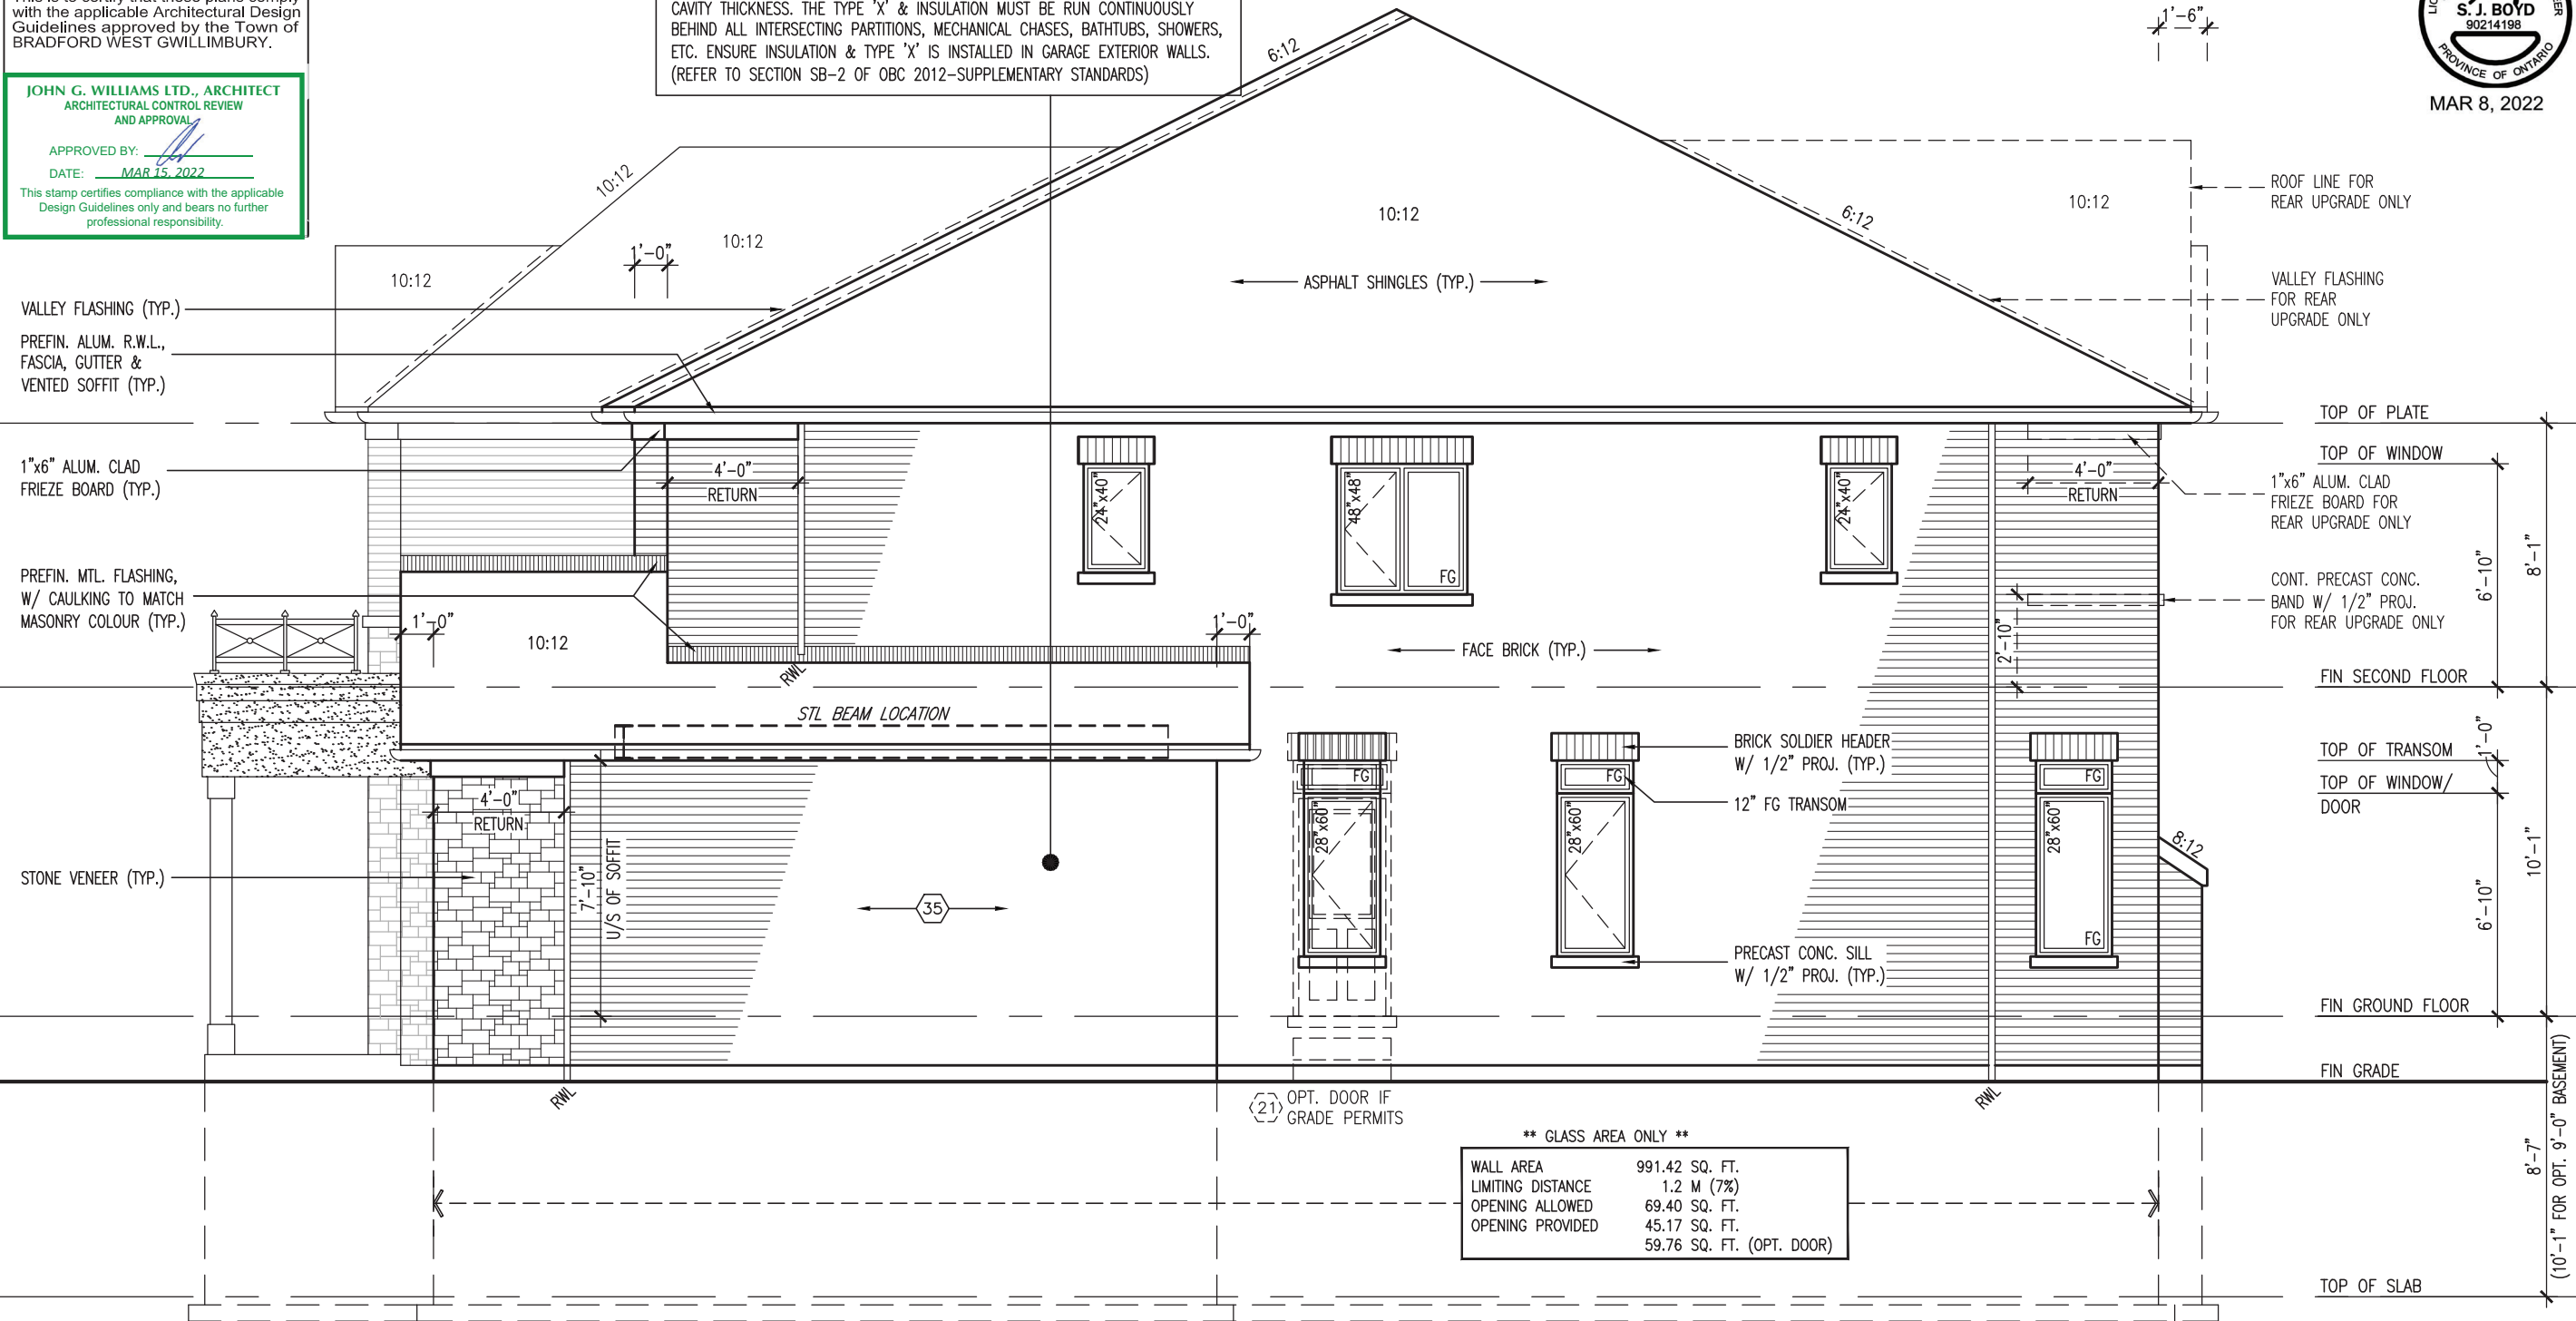

**** GLASS AREA ONLY ****

WALL AREA	991.42 SQ. FT.
LIMITING DISTANCE	1.2 M (7%)
OPENING ALLOWED	69.40 SQ. FT.
OPENING PROVIDED	45.17 SQ. FT.
	59.76 SQ. FT. (OPT. DOOR)

RIGHT SIDE ELEVATION 'B'

S42-19

BAYVIEW WELLINGTON

GREEN VALLEY EAST

BRADFORD, ONTARIO

project name

project no. 16023

drawing no. 14

file name 16023-S42-19

checked by JWM

scale 3/16" = 1'-0"



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Toronto, ON M2J 1R4
t 416.630.2255 f 416.630.4782
vas3design.com



name Jno-Baptiste
signature
registration information
BIN 25591
BCIN 42658



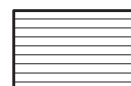
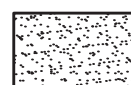
MAR 03-22 RC
FEB 24-22 RC
NOV 26-21 VAS3

REVISAS PER ENG COMMENTS
REVISED AS PER FLOOR / ROOF LAYOUT
ISSUED FOR CLIENT REVIEW

no. description

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-  STONE BY BRAMPTON BRICK FINESSE LINE OR SIMILAR
-  ALUMINUM PANEL
-  FACE BRICK
-  STUCCO FINISH

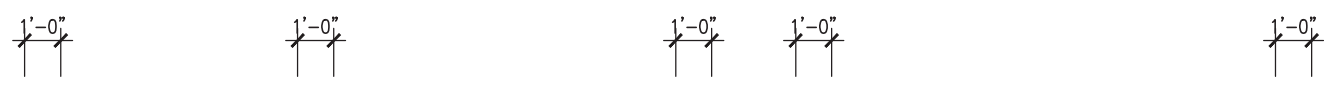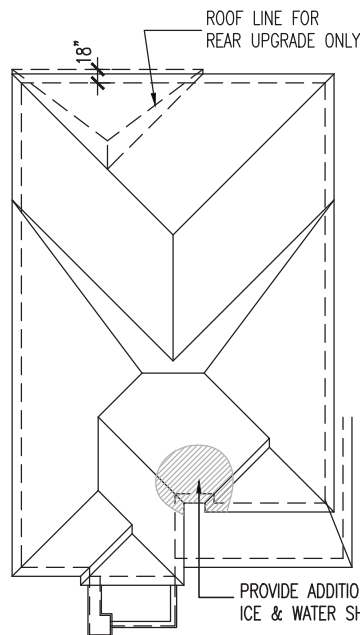ROOF PLAN 'C'
N.T.S.
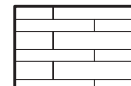
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JOHN G. WILLIAMS LTD., ARCHITECT
ARCHITECTURAL CONTROL REVIEW AND APPROVAL
APPROVED BY: 
DATE: MAR 15, 2022
This stamp certifies compliance with the applicable Design Guidelines only and bears no further professional responsibility.



FRONT ELEVATION 'C'


project name		project no.	
BAYVIEW WELLINGTON		16023	
municipality		drawing no.	
GREEN VALLEY EAST		15	
BRADFORD, ONTARIO		FRONT ELEVATION 'C'	
date		checked by	
OCTOBER 2021		JWM	
scale		3/16" = 1'-0"	
drawn by		file name	
TP		16023-S42-19	
RICHARD - H: ARCHIVE WORKING\2016\16023.BW\Units\42\16023-S42-19.dwg - Tue - Mar 8 2022 - 1:00 PM			

The undersigned has reviewed and takes responsibility for this design and has the qualifications and meets the requirements set out in the Ontario Building Code to be a Designer.	
Wellington Jno-Baptiste	25591 BCIN
signature	42658
name	registration information
JAS Design Inc.	VAS Design Inc.
3	REVISED AS PER ENG COMMENTS
2	REVISED AS PER FLOOR / ROOF LAYOUT
1	ISSUED FOR CLIENT REVIEW
no.	description
9	
8	
7	
6	
5	
4	
3	MAR 03-22 RC
2	FEB 24-22 RC
1	NOV 26-21 VAS
no.	date

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This is to certify that these plans comply with the applicable Architectural Design Guidelines approved by the Town of BRADFORD WEST GWILLIMBURY.

JOHN G. WILLIAMS LTD., ARCHITECT
ARCHITECTURAL CONTROL REVIEW
AND APPROVAL



APPROVED BY: 
DATE: MAR 13, 2022

This stamp certifies compliance with the applicable Design Guidelines only and bears no further professional responsibility.



R.W.L. AS REQUIRED &
AS PER MUNICIPALITY

NOTE: REFER TO FRONT
ELEVATION FOR TYPICAL
NOTE INFORMATION

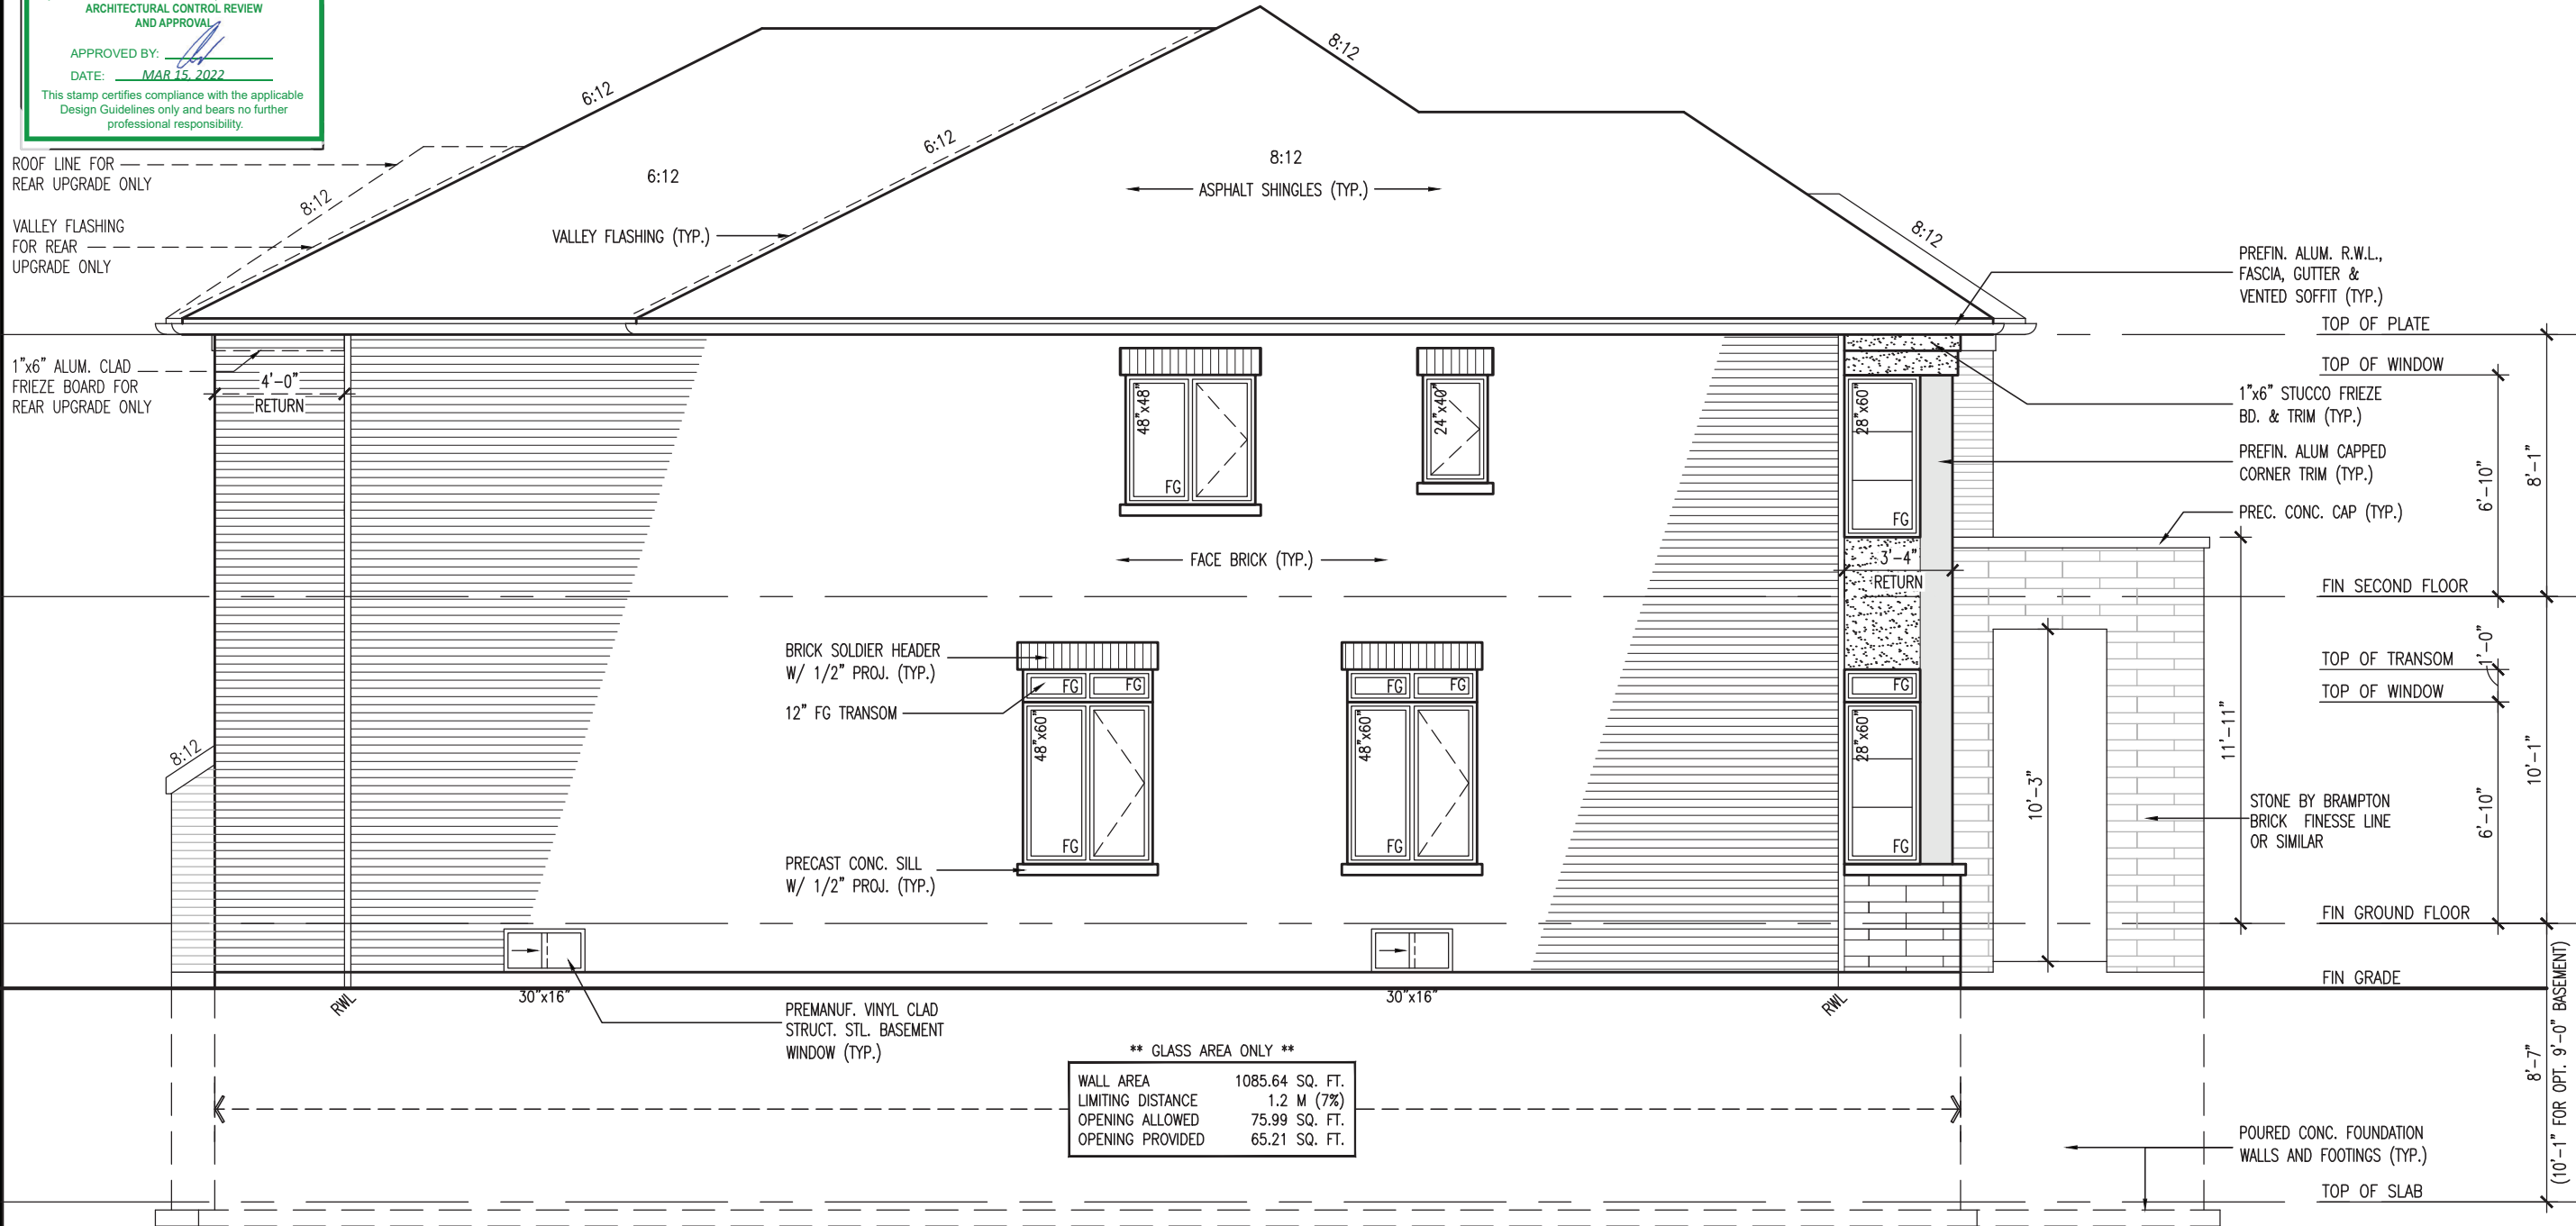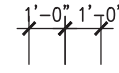

**** GLASS AREA ONLY ****

WALL AREA	1085.64 SQ. FT.
LIMITING DISTANCE	1.2 M (7%)
OPENING ALLOWED	75.99 SQ. FT.
OPENING PROVIDED	65.21 SQ. FT.

LEFT SIDE ELEVATION 'C'

S42-19

BAYVIEW WELLINGTON



255 Consumers Rd, Suite 120
Toronto, ON M2J 1R4
t 416.630.2255 f 416.630.4782
v3design.com

project name: GREEN VALLEY EAST
municipality: BRADFORD, ONTARIO
project no.: 16023
drawing no.: 16

9	DATE	BY	DESCRIPTION
8			
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3	REVISED AS PER ENG COMMENTS	MAR 03-22	RC
2	REVISED AS PER FLOOR / ROOF LAYOUT	FEB 24-22	RC
1	ISSUED FOR CLIENT REVIEW	NOV 26-21	VA3

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JOHN G. WILLIAMS LTD., ARCHITECT
ARCHITECTURAL CONTROL REVIEW AND APPROVAL

APPROVED BY: 
DATE: MAR 15, 2022

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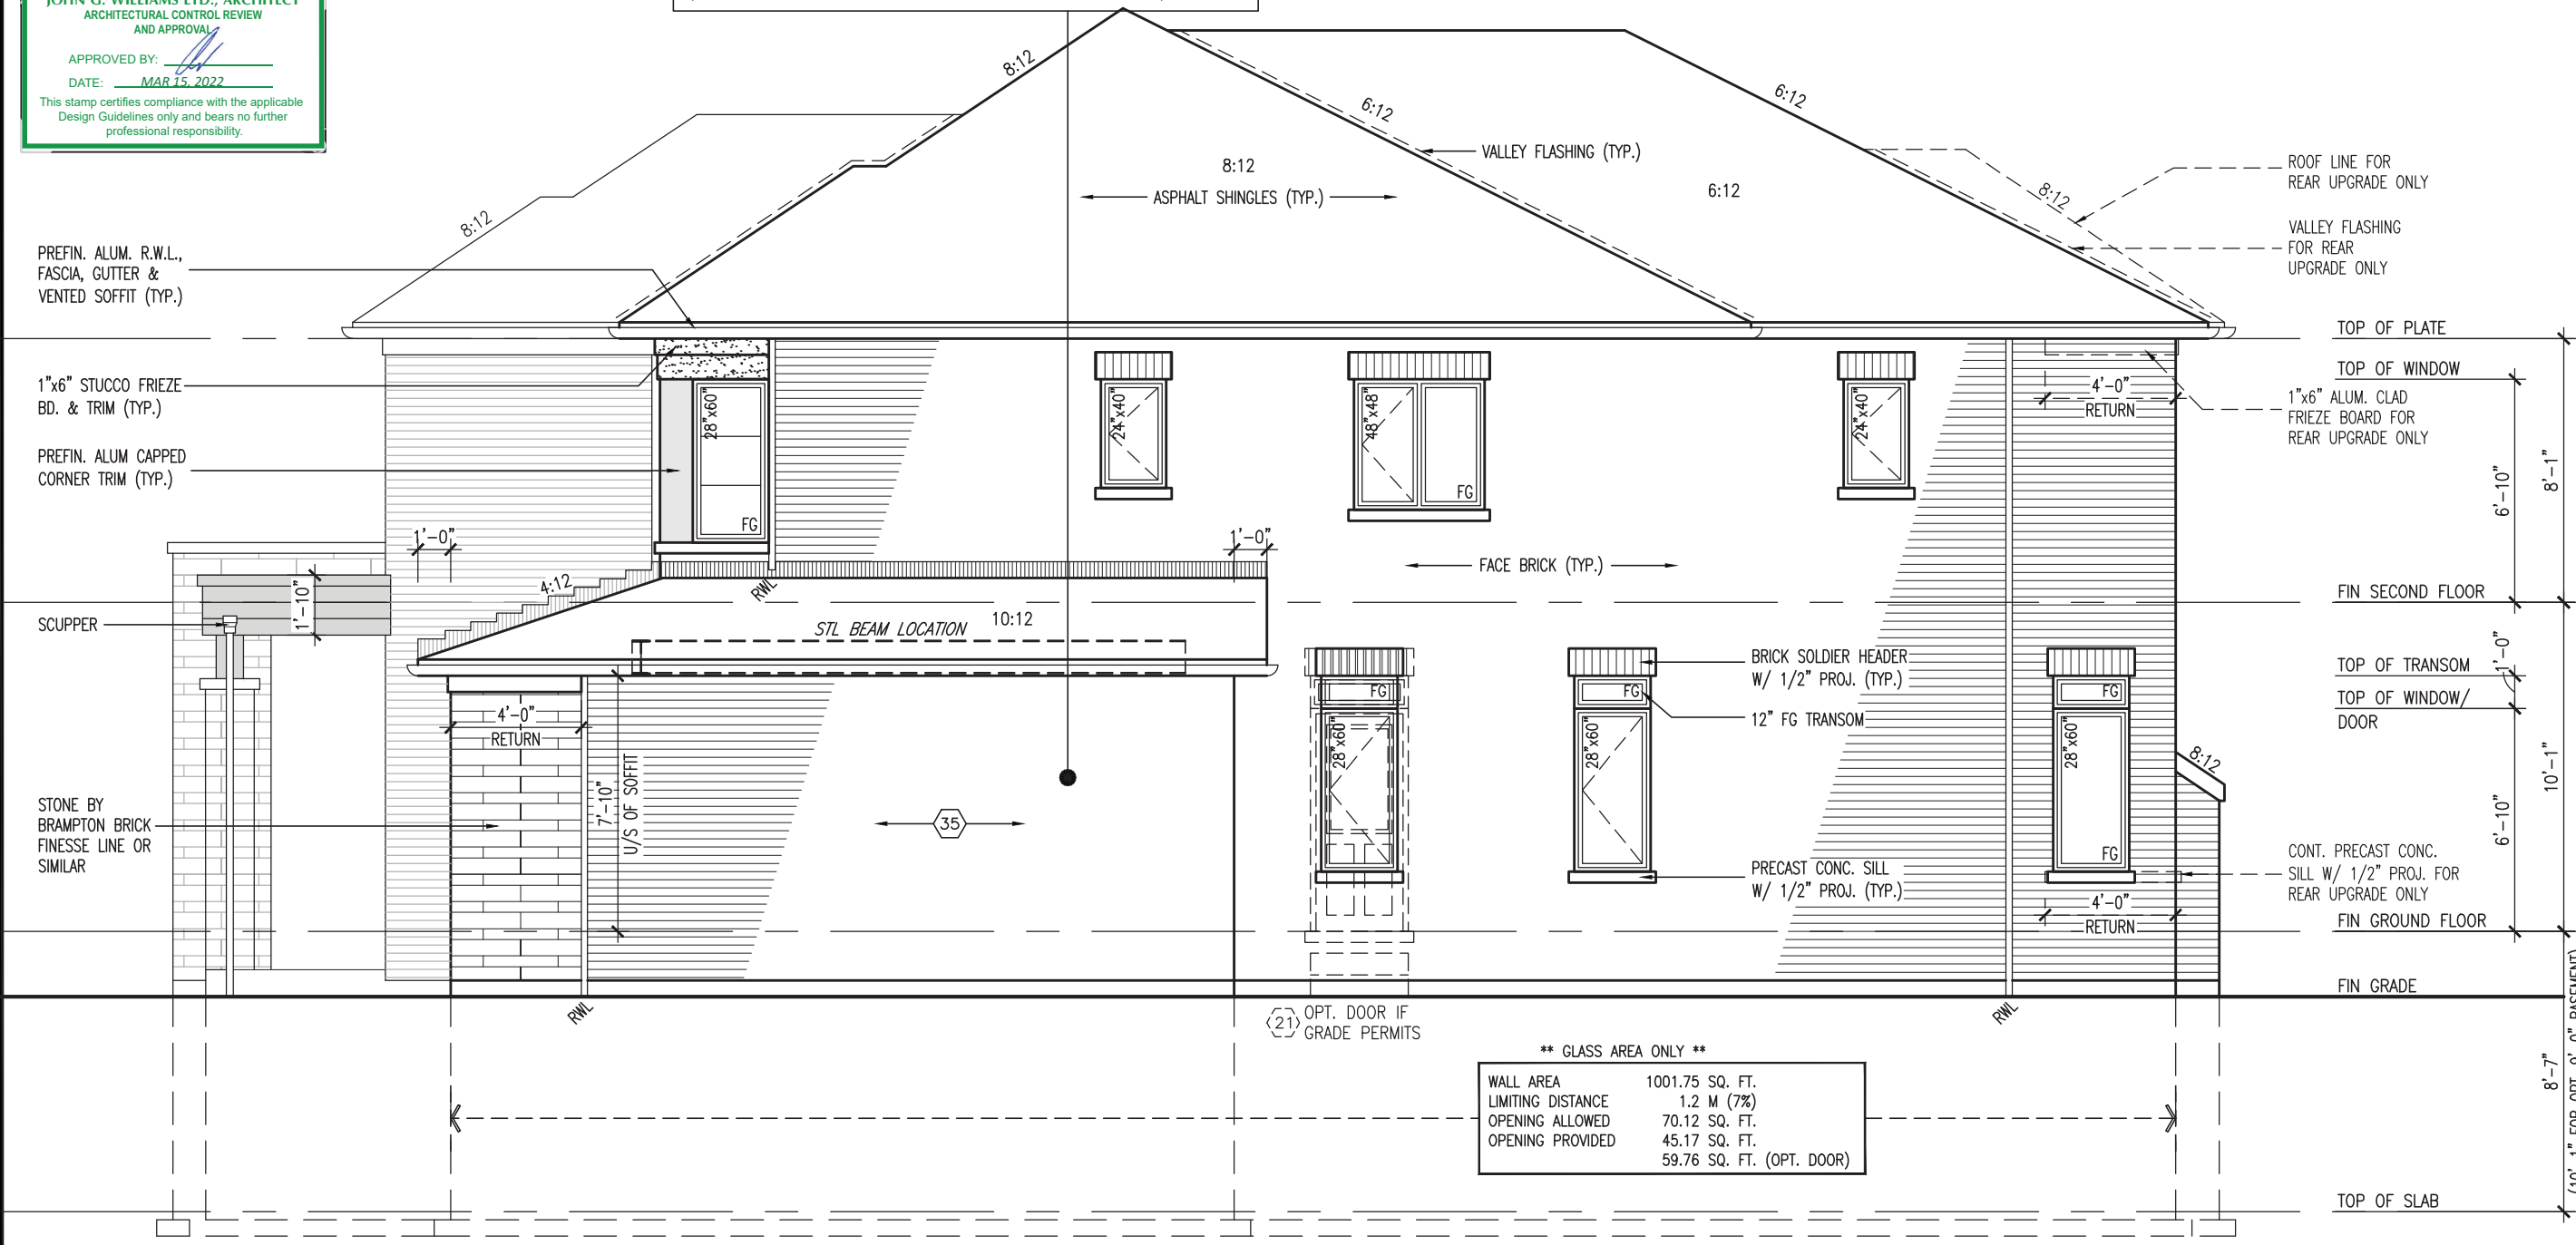
BRICK VENEER CONSTRUCTION

(FOR WALLS LESS THAN 1.2M (3'-11") FROM THE LOT LINE)
45 MINUTE FIRE RATED WALL
PROVIDE A CONTINUOUS LAYER OF 12.7mm (1/2") TYPE 'X' GYPSUM BOARD (INTERIOR SIDE) INSTALLED SO THAT ALL EDGES ARE SUPPORTED, TAPED AND FILLED. SPACE BETWEEN WOOD STUDS TO BE FILLED WITH INSULATION CONFORMING TO CAN/ULC-S702, "MINERAL FIBRE THERMAL INSULATION FOR BUILDINGS" WITH A MASS OF NOT LESS THAN 1.22 Kg/SQ.M. AND MUST FILL AT LEAST 90% OF THE CAVITY THICKNESS. THE TYPE 'X' & INSULATION MUST BE RUN CONTINUOUSLY BEHIND ALL INTERSECTING PARTITIONS, MECHANICAL CHASES, BATHTUBS, SHOWERS, ETC. ENSURE INSULATION & TYPE 'X' IS INSTALLED IN GARAGE EXTERIOR WALLS. (REFER TO SECTION SB-2 OF OBC 2012-SUPPLEMENTARY STANDARDS)



R.W.L. AS REQUIRED & AS PER MUNICIPALITY

NOTE: REFER TO FRONT ELEVATION FOR TYPICAL NOTE INFORMATION



**** GLASS AREA ONLY ****

WALL AREA	1001.75 SQ. FT.
LIMITING DISTANCE	1.2 M (7%)
OPENING ALLOWED	70.12 SQ. FT.
OPENING PROVIDED	45.17 SQ. FT.
	59.76 SQ. FT. (OPT. DOOR)

RIGHT SIDE ELEVATION 'C'

BAYVIEW WELLINGTON
GREEN VALLEY EAST
BRADFORD, ONTARIO

S42-19

project no. 16023
drawing no. 17

project name: GREEN VALLEY EAST
date: OCTOBER 2021
checked by: JWM
scale: 3/16" = 1'-0"

file name: 16023-S42-19
drawn by: TP
date: 16023-542-19.dwg
Tue - Mar 8 2022 - 1:00 PM

VAS DESIGN
255 Consumers Rd, Suite 120
Toronto, ON M2J 1R4
t 416.630.2255 f 416.630.4782
vasdesign.com


name: Wellington Jno-Baptiste
signature: 
BCIN: 25591
42658

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4.
3. REVISED AS PER ENG COMMENTS MAR 03-22 RC
2. REVISED AS PER FLOOR / ROOF LAYOUT FEB 24-22 RC
1. ISSUED FOR CLIENT REVIEW NOV 26-21 VAS

no. description date by

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AREA CALCULATIONS			
	ELEV. A	ELEV. B	ELEV. C
GROUND FLOOR AREA	1428.2 SF	1429.4 SF	1429.1 SF
SECOND FLOOR AREA	1701.7 SF	1703.9 SF	1702.6 SF
SUBTOTAL	3129.8 SF	3133.3 SF	3131.7 SF
DEDUCT ALL OPENINGS	0 SF	0 SF	0 SF
TOTAL NET AREA	3130 SF	3133 SF	3132 SF
	290.8 m2	291.1 m2	290.9 m2
FINISHED BSMT AREA	0 SF	0 SF	0 SF
TOTAL NET AREA W/ FIN BSMT	3130 SF	3133 SF	3132 SF
	290.8 m2	291.1 m2	290.9 m2
COVERAGE W/O PORCH	1863.5 SF	1864.7 SF	1864.4 SF
	173.1 m2	173.2 m2	173.2 m2
COVERAGE W/PORCH	1965.9 SF	1912.4 SF	1919.0 SF
	182.6 m2	177.7 m2	178.3 m2

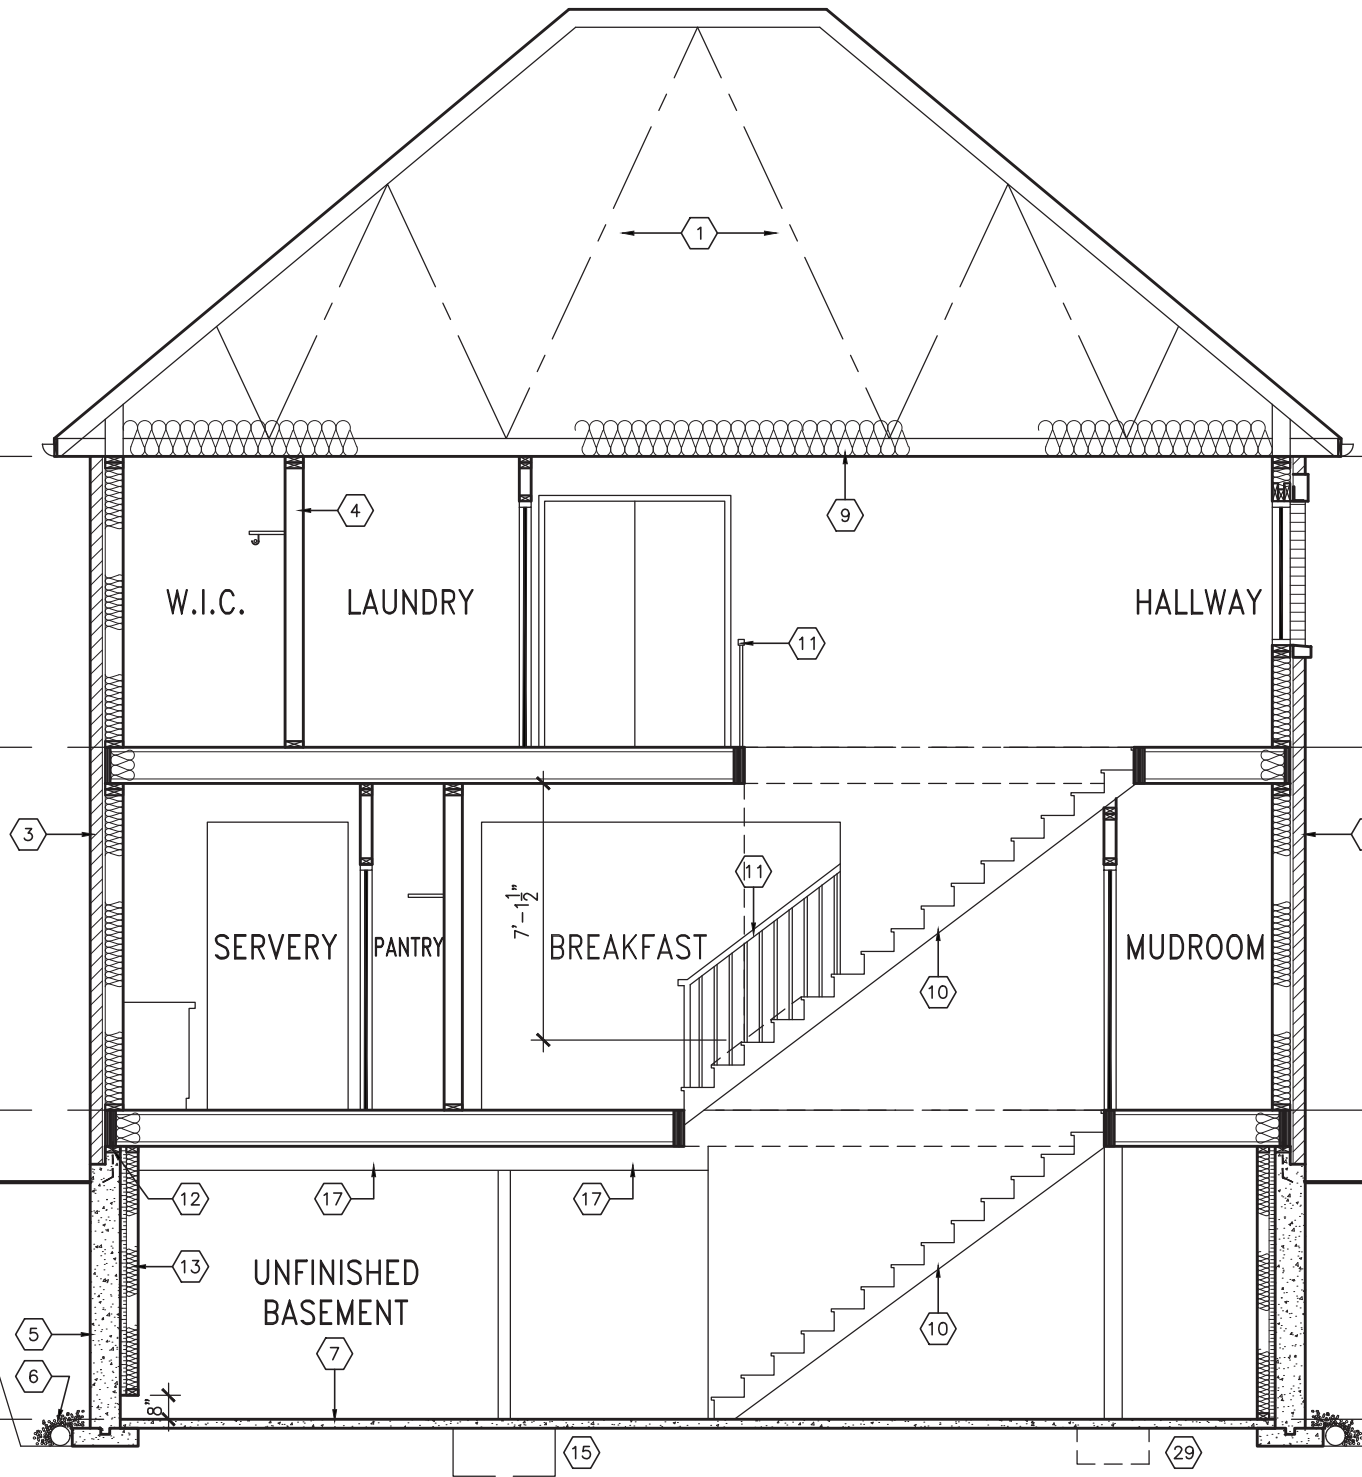

CROSS SECTION 'A-A'



TOP OF PLATE	
TOP OF WINDOW	
FIN SECOND FLOOR	6'-10"
FIN GROUND FLOOR	8'-1"
FIN GRADE	10'-1"
TOP OF SLAB	8'-7"
	(10'-1" FOR OPT. 9'-0" BASEMENT)


BAYVIEW WELLINGTON		S42-19	
project name	GREEN VALLEY EAST	municipality	BRADFORD, ONTARIO
project no.	16023	drawing no.	18
date	OCTOBER 2021	checked by	JWM
drawn by	TP	scale	3/16" = 1'-0"
file name	16023-S42-19	drawn by	TP
255 Consumers Rd, Suite 120 Toronto, ON M2J 1R4 t 416.630.2255 f 416.630.4782 vasdesign.com			
The undersigned has reviewed and takes responsibility for this design and has the qualifications and meets the requirements set out in the Ontario Building Code to be a Designer.		name: Wellington Jno-Baptiste registration information: VAS Design Inc. name: Jno-Baptiste signature: [Signature] BCIN: 25591 BCIN: 42658	
9			
8			
7			
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4			
3	REVISED AS PER ENG COMMENTS	MAR 03-22	RC
2	REVISED AS PER FLOOR / ROOF LAYOUT	FEB 24-22	RC
1	ISSUED FOR CLIENT REVIEW	NOV 26-21	VA3
no.	description	date	by

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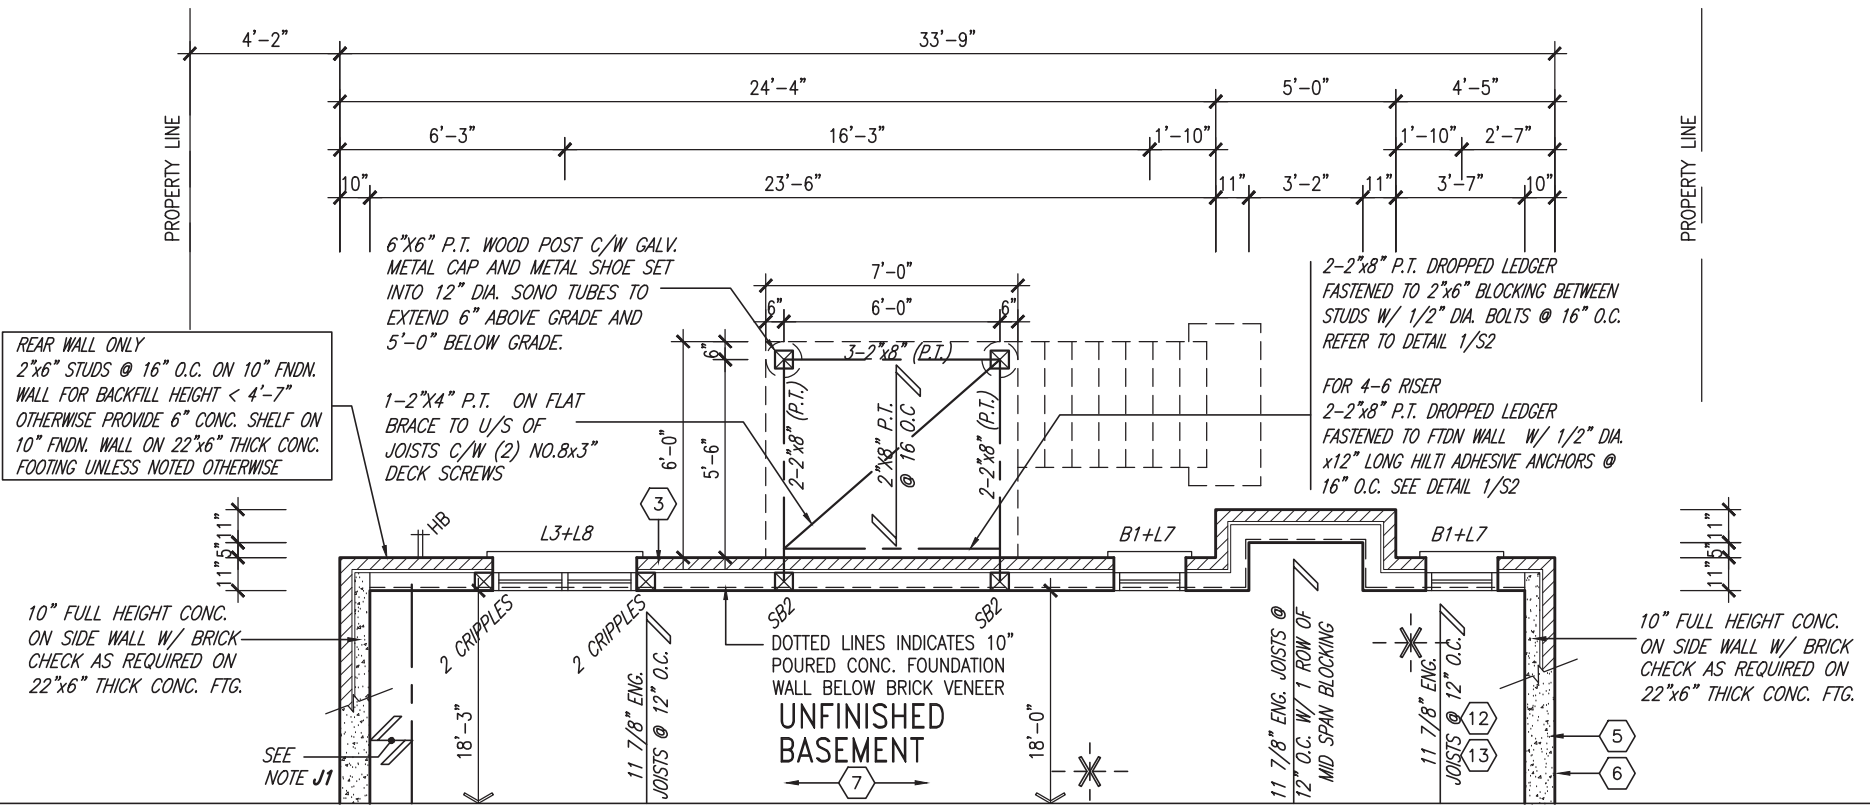
JOHN G. WILLIAMS LTD., ARCHITECT
ARCHITECTURAL CONTROL REVIEW
AND APPROVAL

APPROVED BY: 
DATE: MAR 15, 2022

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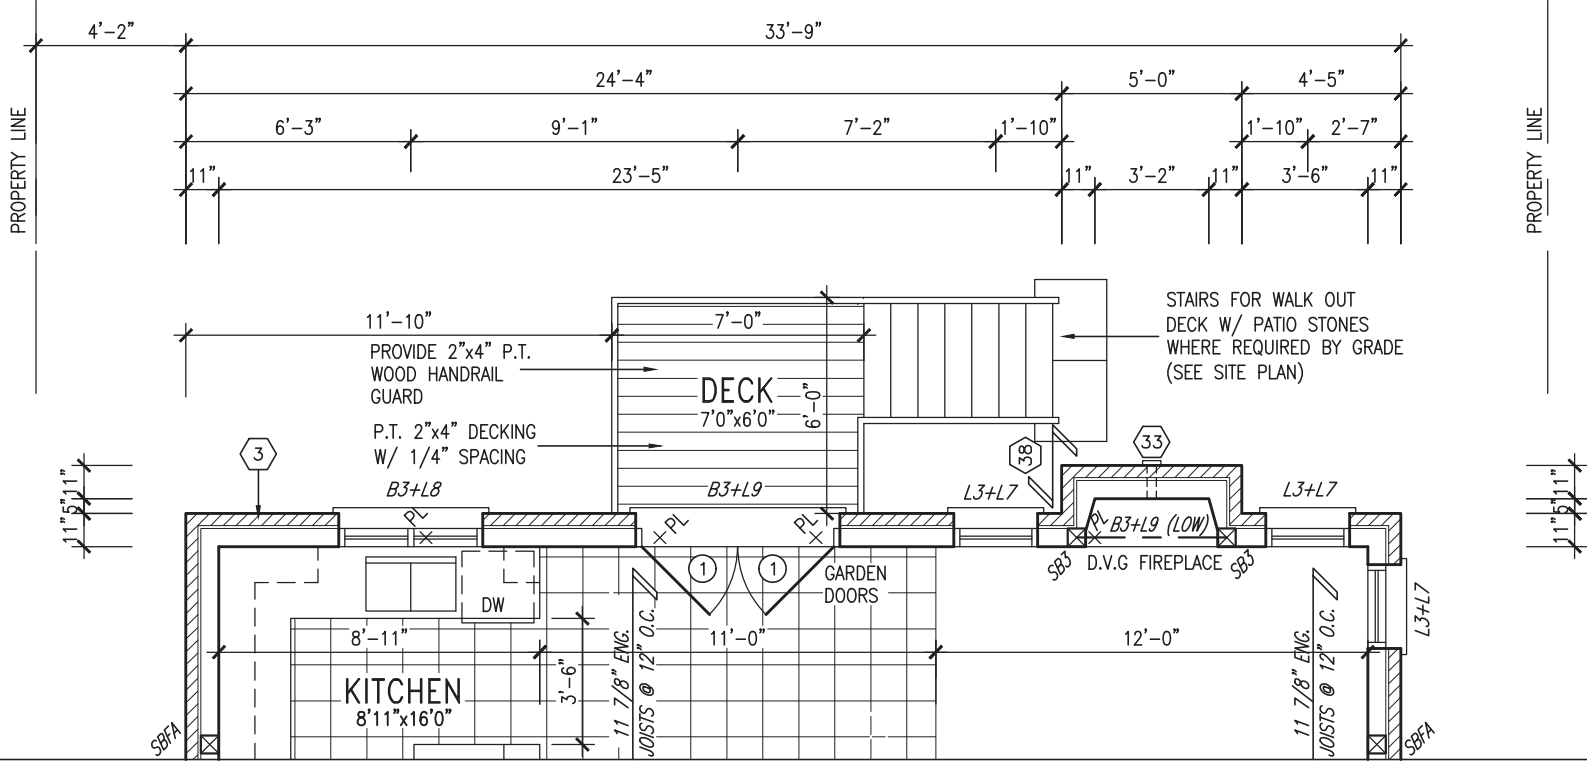


MAR 8, 2022



PARTIAL BASEMENT PLAN 'A' - W.O.D. CONDITION
(ELEV. 'B' & 'C' SIMILAR)

NOTE: REFER TO STANDARD FLOOR PLANS FOR ADDITIONAL INFORMATION



PARTIAL GROUND FLOOR PLAN 'A' - W.O.D. CONDITION
(ELEV. 'B' & 'C' SIMILAR)

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3	REVISED AS PER ENG COMMENTS	MAR 03-22	RC
2	REVISED AS PER FLOOR / ROOF LAYOUT	FEB 24-22	RC
1	ISSUED FOR CLIENT REVIEW	NOV 26-21	VA3
no.	description	date	by

The undersigned has reviewed and takes responsibility for this design and has the qualifications and meets the requirements set out in the Ontario Building Code to be a Designer.

qualification information
Wellington Jno-Baptiste 25591
 name BCIN
 registration information
VA3 Design Inc. 42658

Contractor must verify all dimensions on the job and report any discrepancy to the Designer before proceeding with the work. All drawings and specifications are instruments of service and the property of the Designer which must be returned at the completion of the work. Drawings are not to be scaled.




255 Consumers Rd Suite 120
Toronto ON M2J 1R4
t 416.630.2255 f 416.630.4782
va3design.com

BAYVIEW WELLINGTON		S42-19	
project name GREEN VALLEY EAST	municipality BRADFORD, ONTARIO	project no. 16023	
date OCTOBER 2021	checked by JWM	scale 3/16" = 1'-0"	file name 16023-S42-19
drawn by TP	checked by JWM	scale 3/16" = 1'-0"	drawing no. 19
RICHARD - H:\ARCHIVE\WORKING\2016\16023.BW\Units\42\16023-S42-19.dwg - Tue - Mar 8 2022 - 1:00 PM			

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JOHN G. WILLIAMS LTD., ARCHITECT
ARCHITECTURAL CONTROL REVIEW
AND APPROVAL

APPROVED BY: 
DATE: MAR 15, 2022

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R.W.L. AS REQUIRED & AS PER MUNICIPALITY

NOTE: REFER TO FRONT ELEVATION FOR TYPICAL NOTE INFORMATION



DASHED LINE INDICATES ROOF LINE FOR ELEV. 'B' @ FRONT

DASHED LINE INDICATES ROOF LINE FOR ELEV. 'C'

PREFIN. ALUM. R.W.L., FASCIA, GUTTER & VENTED SOFFIT (TYP.)

FACE BRICK (TYP.)

BRICK SOLDIER HEADER W/ 1/2" PROJ. (TYP.)

12" FG TRANSOM


PREFIN. MTL. FLASHING, W/ CAULKING TO MATCH MASONRY COLOUR (TYP.)

PRECAST CONC. SILL W/ 1/2" PROJ. (TYP.)

PROVIDE 2"x4" P.T. WOOD HANDRAIL GUARD W/ 2"x2" P.T. WOOD PICKETS @ 4" MAX.

6"x6" P.T. WOOD POST C/W GALV. METAL CAP AND METAL SHOE SET INTO 12" DIA. SONO TUBES TO EXTEND 6" ABOVE GRADE AND 5'-0" BELOW GRADE.

POURED CONC. FOUNDATION WALLS AND FOOTINGS (TYP.)

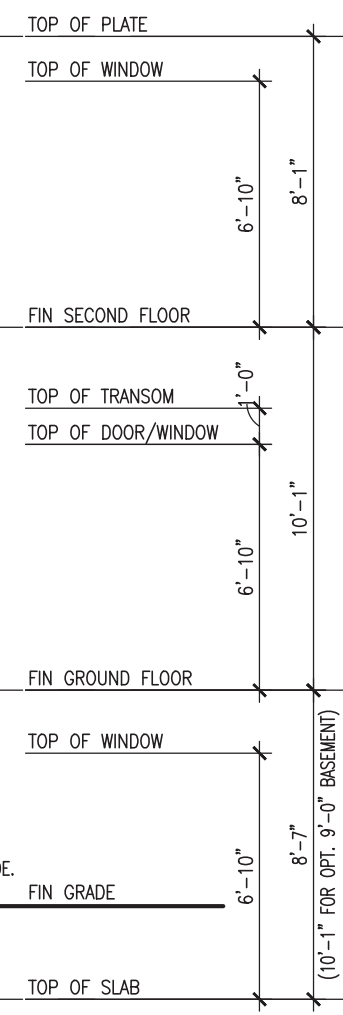

REAR ELEVATION 'A'/'B'/'C' - W.O.D. CONDITION

BASEMENT WINDOW SIZES
4R-8R USE 30"x24" VINYL CLAD STRUCTURAL STEEL FRAME BASEMENT WINDOWS

BAYVIEW WELLINGTON		S42-19	
project name	GREEN VALLEY EAST	municipality	BRADFORD, ONTARIO
project no.	16023	drawing no.	20
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drawn by	TP	checked by	JWM
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file name	16023-S42-19	checked by	JWM
scale	3/16" = 1'-0"	checked by	JWM
drawn by	TP	checked by	JWM
date	OCTOBER 2021	checked by	JWM
drawn by	TP	checked by	JWM
file name	16023-S42-19	checked by	JWM
scale	3/16" = 1'-0"	checked by	JWM
drawn by	TP	checked by	JWM
date	OCTOBER 2021	checked by	JWM
drawn by	TP	checked by	JWM
file name	16023-S42-19	checked by	JWM
scale	3/16" = 1'-0"	checked by	JWM
drawn by	TP	checked by	JWM
date	OCTOBER 2021	checked by	JWM
drawn by	TP	checked by	JWM
file name	16023-S42-19	checked by	JWM
scale	3/16" = 1'-0"	checked by	JWM
drawn by	TP	checked by	JWM
date	OCTOBER 2021	checked by	JWM
drawn by	TP	checked by	JWM
file name	16023-S42-19	checked by	JWM
scale	3/16" = 1'-0"	checked by	JWM
drawn by	TP	checked by	JWM
date	OCTOBER 2021	checked by	JWM
drawn by	TP	checked by	JWM
file name	16023-S42-19	checked by	JWM
scale	3/16" = 1'-0"	checked by	JWM
drawn by	TP	checked by	JWM
date			

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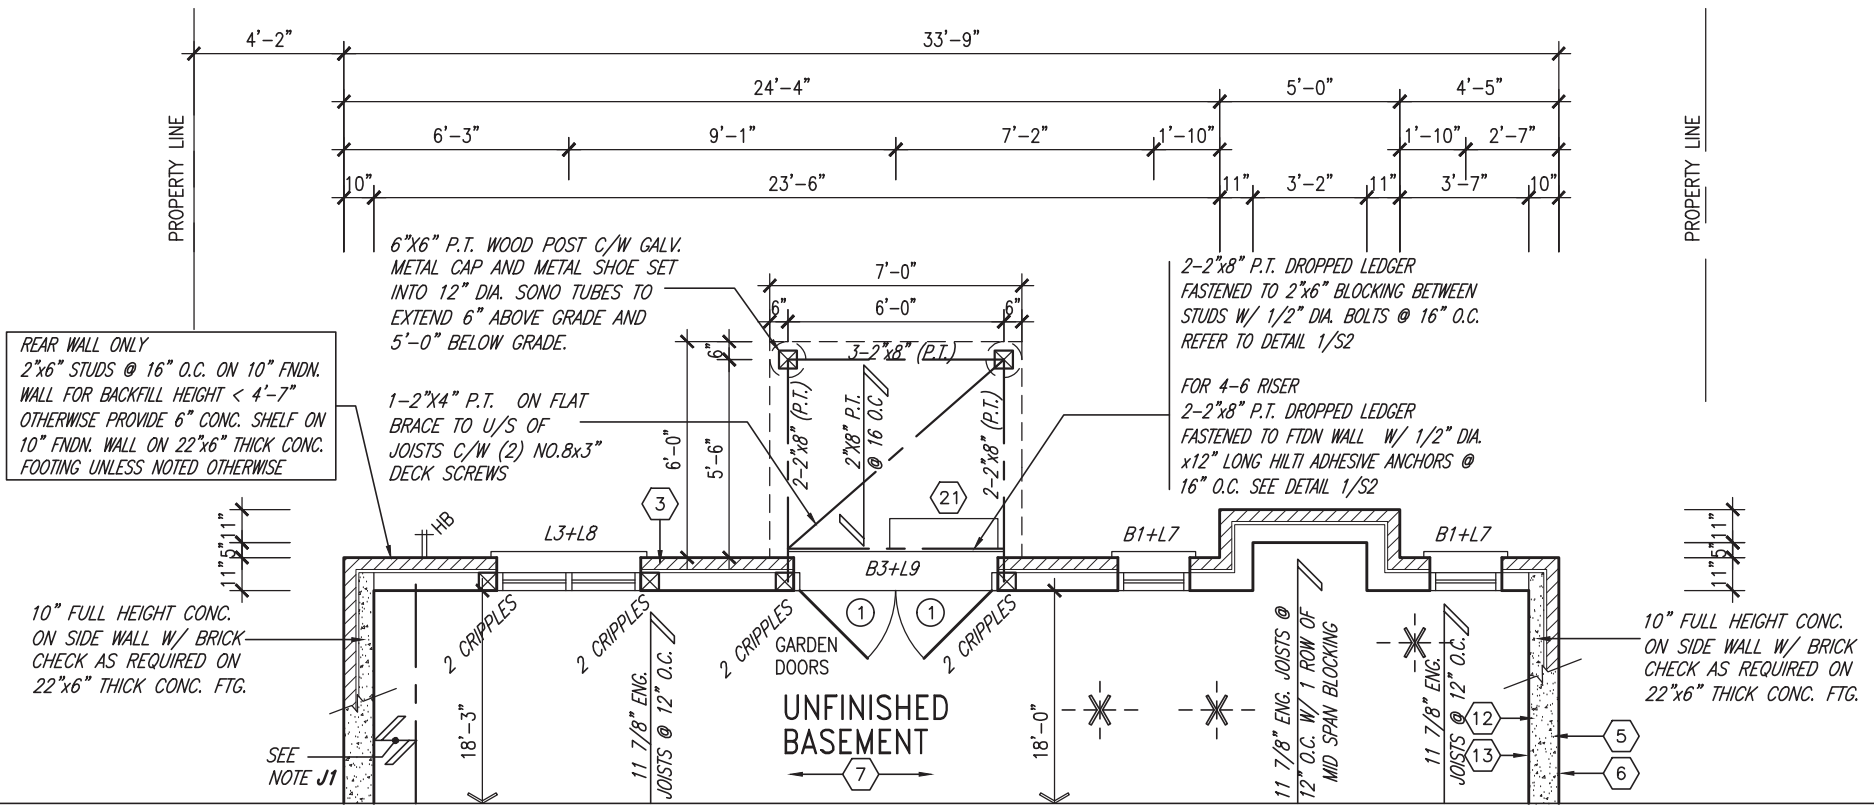
This is to certify that these plans comply with the applicable Architectural Design Guidelines approved by the BRADFORD / WEST GWILLIMBURY.

JOHN G. WILLIAMS LTD., ARCHITECT
ARCHITECTURAL CONTROL REVIEW
AND APPROVAL

APPROVED BY:


DATE: MAR 15, 2022

This stamp certifies compliance with the applicable Design Guidelines only and bears no further professional responsibility.



PARTIAL BASEMENT PLAN 'A' - W.O.B. CONDITION
(ELEV. 'B' & 'C' SIMILAR)

NOTE: REFER TO STANDARD FLOOR PLANS FOR ADDITIONAL INFORMATION

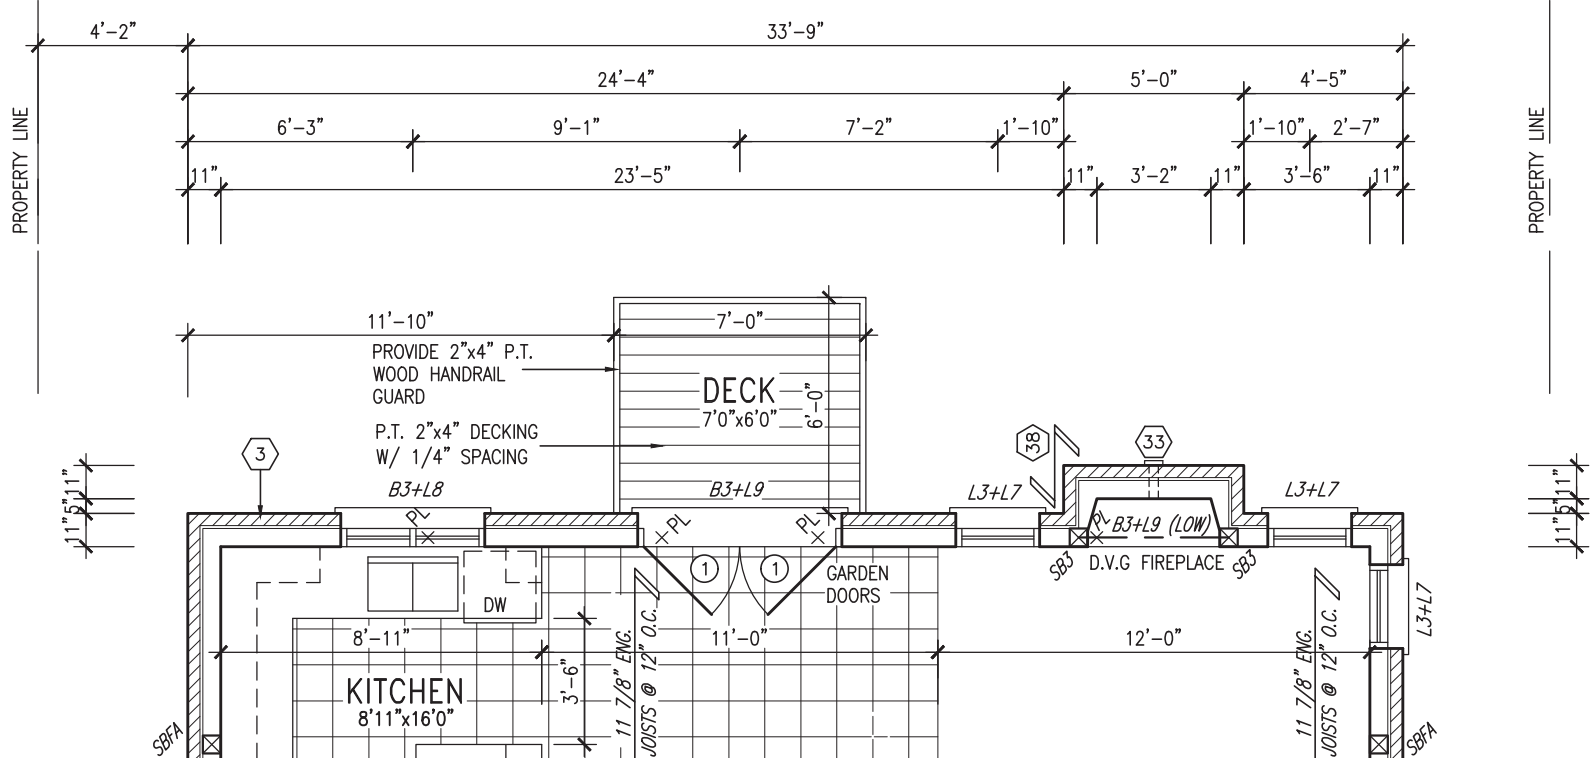

PARTIAL GROUND FLOOR PLAN 'A' - W.O.B. CONDITION
(ELEV. 'B' & 'C' SIMILAR)



MAR 8, 2022

9	.	.	The undersigned has reviewed and takes responsibility for this design and has the qualifications and meets the requirements set out in the Ontario Building Code to be a Designer.	 255 Consumers Rd Suite 120 Toronto ON M2J 1R4 t 416.630.2255 f 416.630.4782 va3design.com	BAYVIEW WELLINGTON project name GREEN VALLEY EAST municipality BRADFORD, ONTARIO	S42-19 project no. 16023
8	.	.	qualification information			
7	.	.	Wellington Jno-Baptiste 25591 name signature BCIN			
6	.	.	VA3 Design Inc. 42658 registration information			
5	.	.	Contractor must verify all dimensions on the job and report any discrepancy to the Designer before proceeding with the work. All drawings and specifications are instruments of service and the property of the Designer which must be returned at the completion of the work. Drawings are not to be scaled.	date OCTOBER 2021 drawn by TP	scale 3/16" = 1'-0" checked by JWM	file name 16023-S42-19 drawing no. 21
3	REVISED AS PER ENG COMMENTS	MAR 03-22	RC			
2	REVISED AS PER FLOOR / ROOF LAYOUT	FEB 24-22	RC			
1	ISSUED FOR CLIENT REVIEW	NOV 26-21	VA3			
no.	description	date	by			

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JOHN G. WILLIAMS LTD., ARCHITECT
 ARCHITECTURAL CONTROL REVIEW
 AND APPROVAL

APPROVED BY: *[Signature]*
 DATE: MAR 15, 2022

This stamp certifies compliance with the applicable Design Guidelines only and bears no further professional responsibility.


R.W.L. AS REQUIRED & AS PER MUNICIPALITY

NOTE: REFER TO FRONT ELEVATION FOR TYPICAL NOTE INFORMATION



DASHED LINE INDICATES ROOF LINE FOR ELEV. 'B' @ FRONT

DASHED LINE INDICATES ROOF LINE FOR ELEV. 'C'

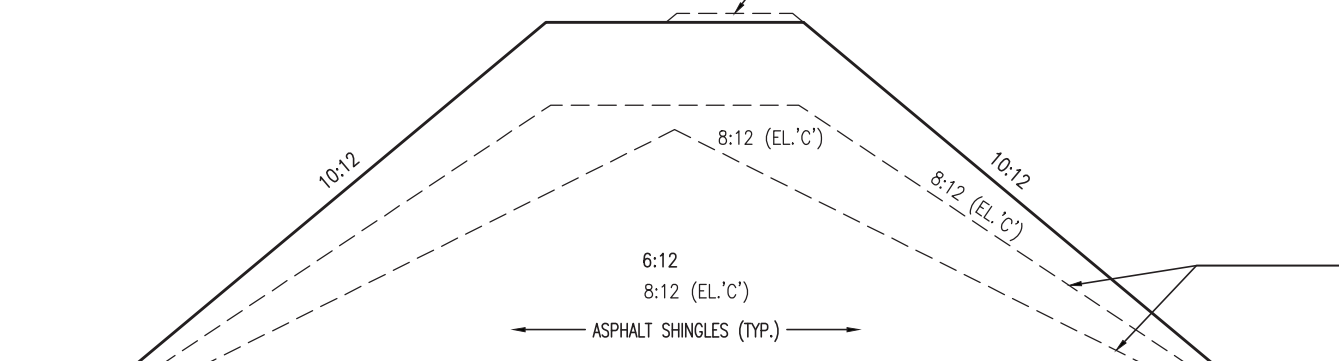


PREFIN. ALUM. R.W.L., FASCIA, GUTTER & VENTED SOFFIT (TYP.)

FACE BRICK (TYP.)

BRICK SOLDIER HEADER W/ 1/2" PROJ. (TYP.)
 12" FG TRANSOM
 PREFIN. MTL. FLASHING, W/ CAULKING TO MATCH MASONRY COLOUR (TYP.)

PRECAST CONC. SILL W/ 1/2" PROJ. (TYP.)

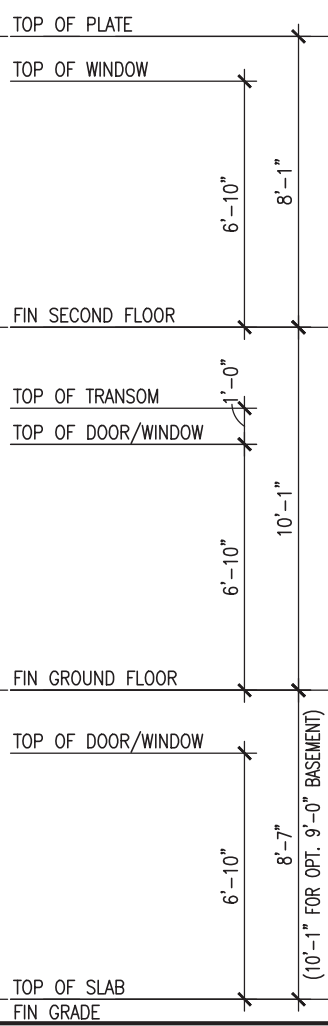

PROVIDE 2"x4" P.T. WOOD HANDRAIL GUARD W/ 2"x2" P.T. WOOD PICKETS @ 4" MAX.

2"x6" P.T. CROSS BRACING

6"x6" P.T. WOOD POST C/W GALV. METAL CAP AND METAL SHOE SET INTO 12" DIA. SONO TUBES TO EXTEND 6" ABOVE GRADE AND 5'-0" BELOW GRADE.

POURED CONC. FOUNDATION WALLS AND FOOTINGS (TYP.)

REAR ELEVATION 'A'/'B'/'C' - W.O.B. CONDITION

BAYVIEW WELLINGTON		S42-19	
project name	GREEN VALLEY EAST	municipality	BRADFORD, ONTARIO
project no.	16023	drawing no.	22
date	OCTOBER 2021	checked by	JWM
drawn by	TP	scale	3/16" = 1'-0"
file name	16023-S42-19	project name	REAR ELEVATION 'A' - W.O.B. COND.
date	MAR 03-22	revision	3
description	REVISED AS PER ENG COMMENTS	date	MAR 03-22
description	REVISED AS PER FLOOR / ROOF LAYOUT	date	FEB 24-22
description	ISSUED FOR CLIENT REVIEW	date	NOV 26-21

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 Toronto, ON M2J 1R4
 t 416.630.2255 f 416.630.4782
 vasdesign.com


Wellington Jno-Baptiste
 BCIN 25591
 42658

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 Contractor must verify all dimensions on the job and report any discrepancy to the Designer before proceeding with the work. All drawings and specifications are instruments of service and the property of the Designer which must be returned at the completion of the work. Drawings are not to be scaled.

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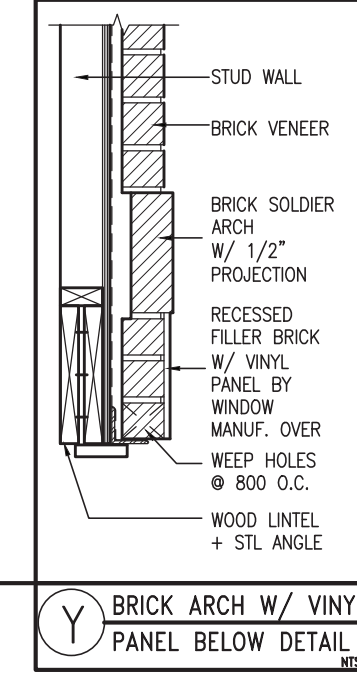
JOHN G. WILLIAMS LTD., ARCHITECT
ARCHITECTURAL CONTROL REVIEW
AND APPROVAL

APPROVED BY: 
DATE: MAR 15, 2022


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R.W.L. AS REQUIRED &
AS PER MUNICIPALITY

*NOTE: REFER TO FRONT
ELEVATION FOR TYPICAL
NOTE INFORMATION*



Y BRICK ARCH W/ VINYL
PANEL BELOW DETAIL
NTS.

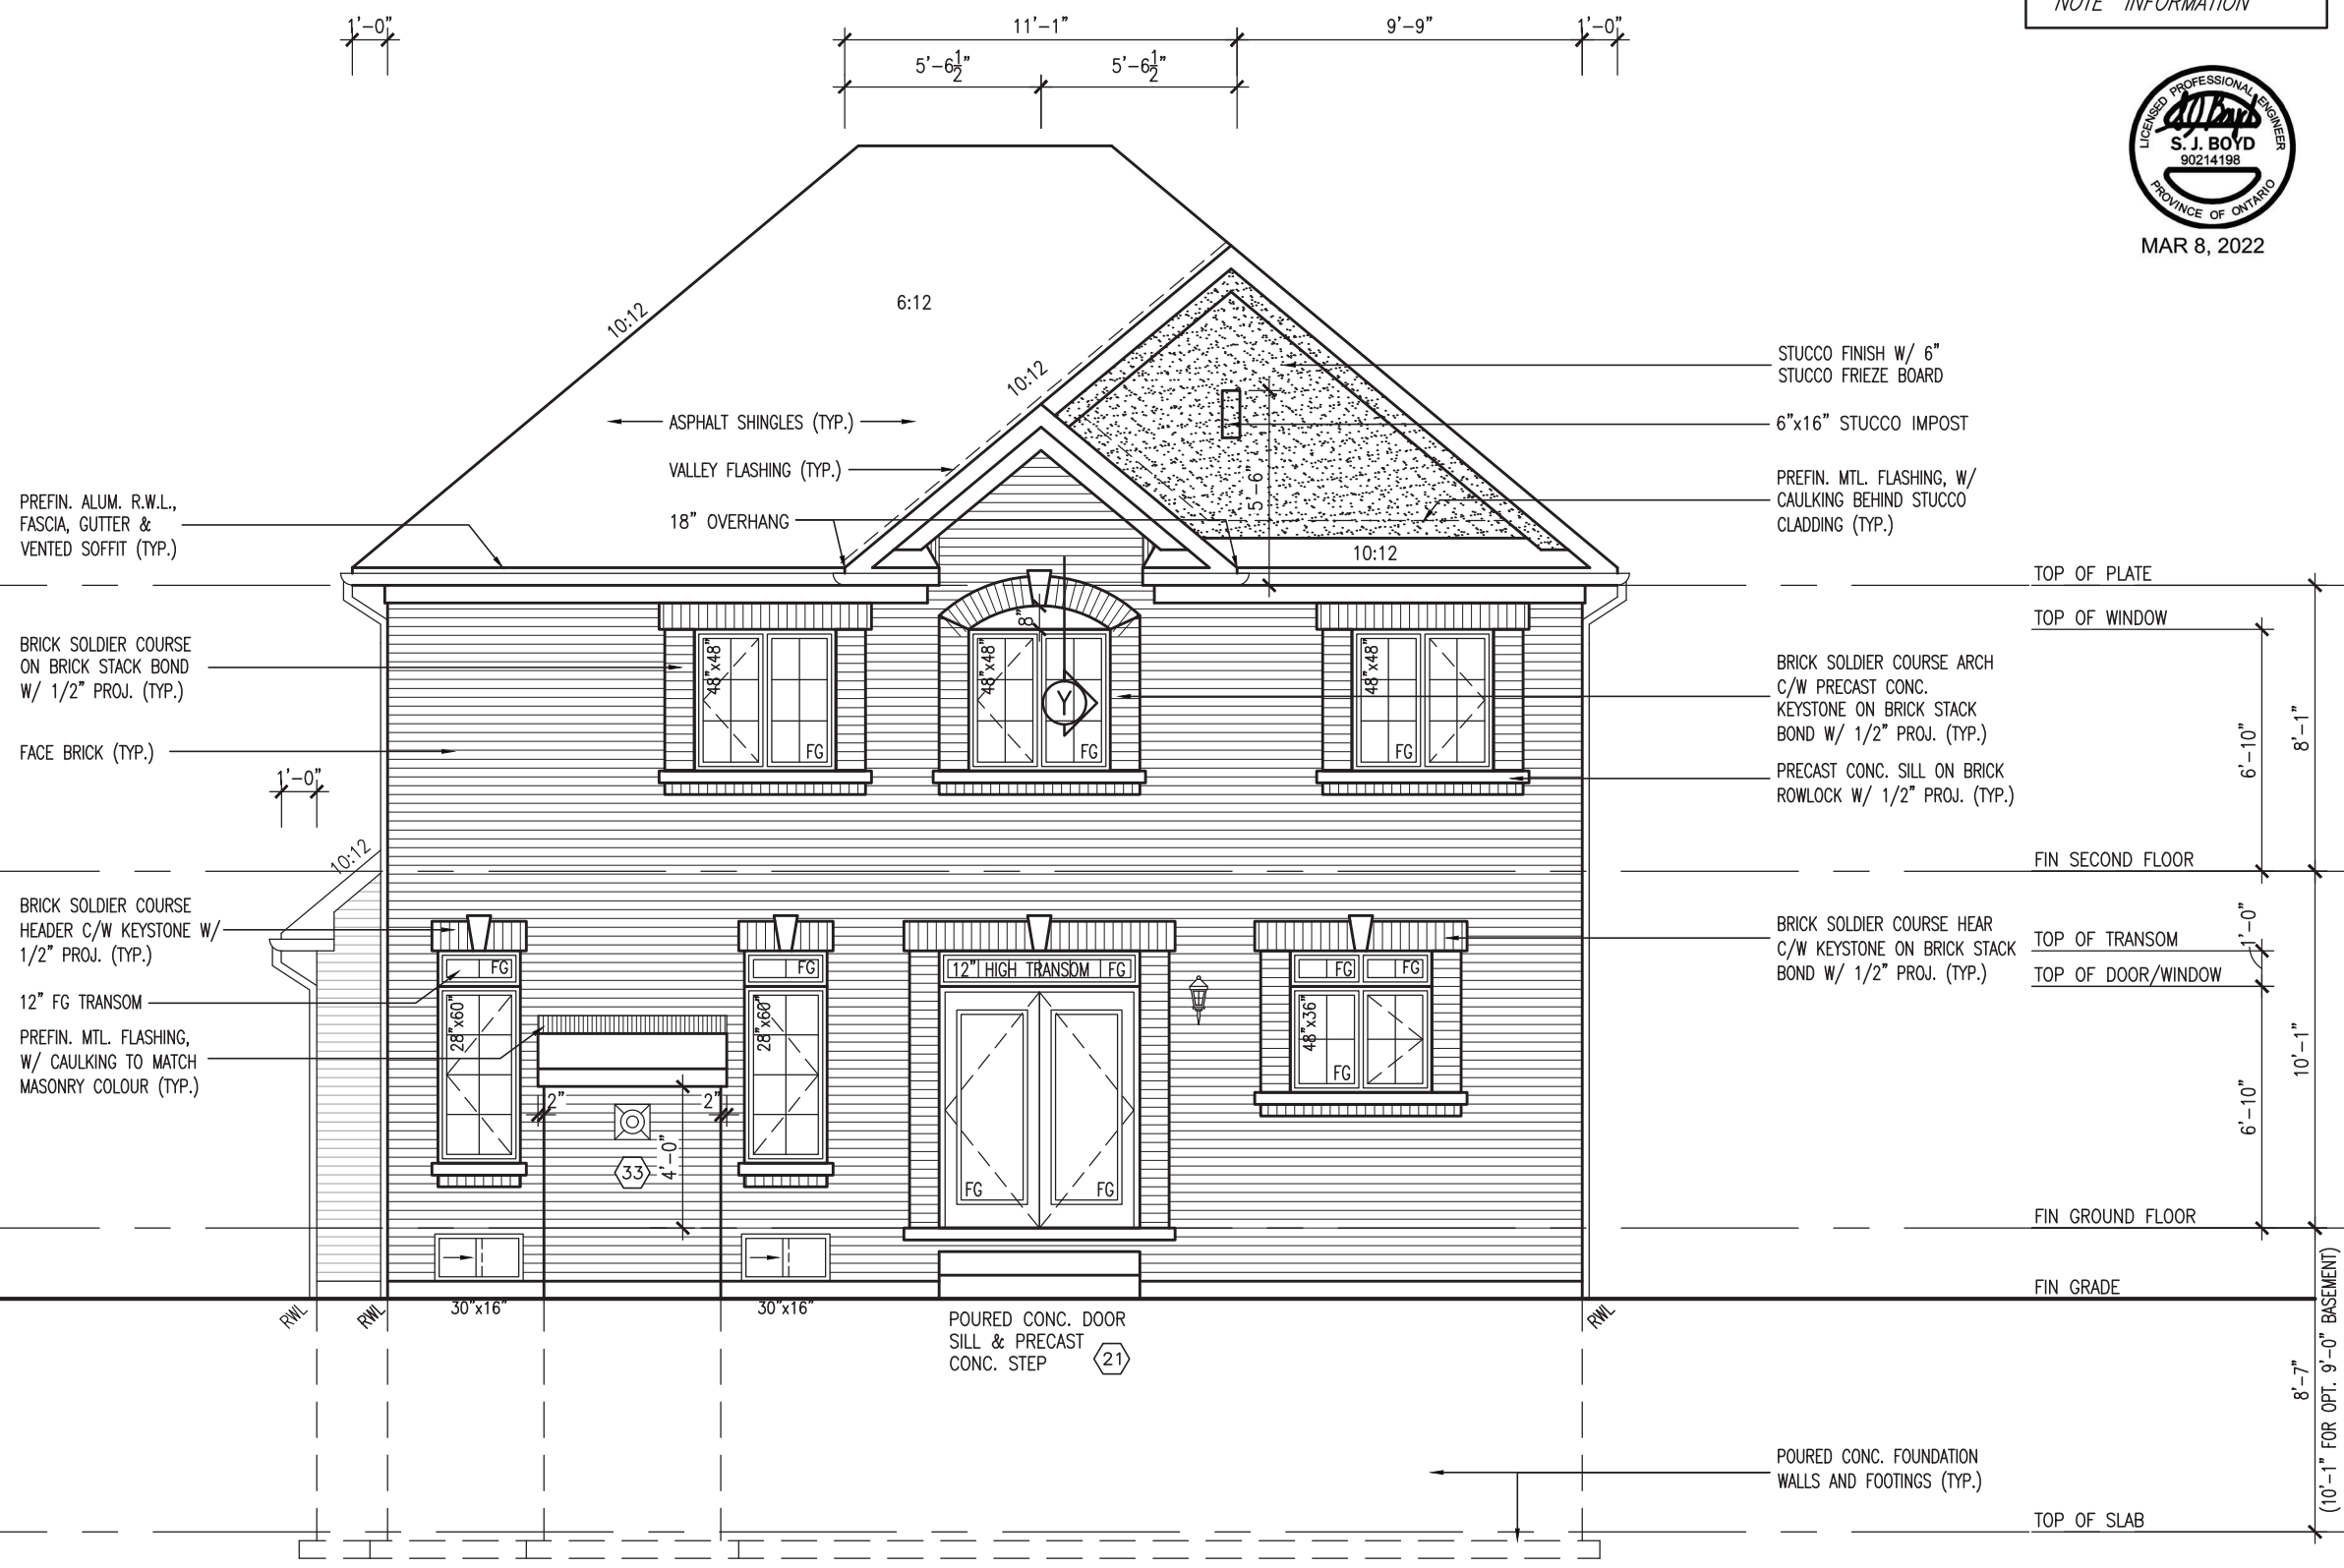

REAR UPGRADE ELEVATION 'A'

project no.	16023	drawing no.	23
project name	GREEN VALLEY EAST	file name	16023-S42-19
municipality	BRADFORD, ONTARIO	scale	3/16" = 1'-0"
checked by	JWM	drawn by	TP
date	OCTOBER 2021	checked by	JWM
date	OCTOBER 2021	checked by	JWM
date	OCTOBER 2021	checked by	JWM

no.	description	date	by
9			
8			
7			
6			
5			
4			
3	REVISED AS PER ENG COMMENTS	MAR 03-22	RC
2	REVISED AS PER FLOOR / ROOF LAYOUT	FEB 24-22	RC
1	ISSUED FOR CLIENT REVIEW	NOV 26-21	VA3

name	Wellington Jno-Baptiste	BCIN	25591
registration information	VA3 Design Inc.	BCIN	42658

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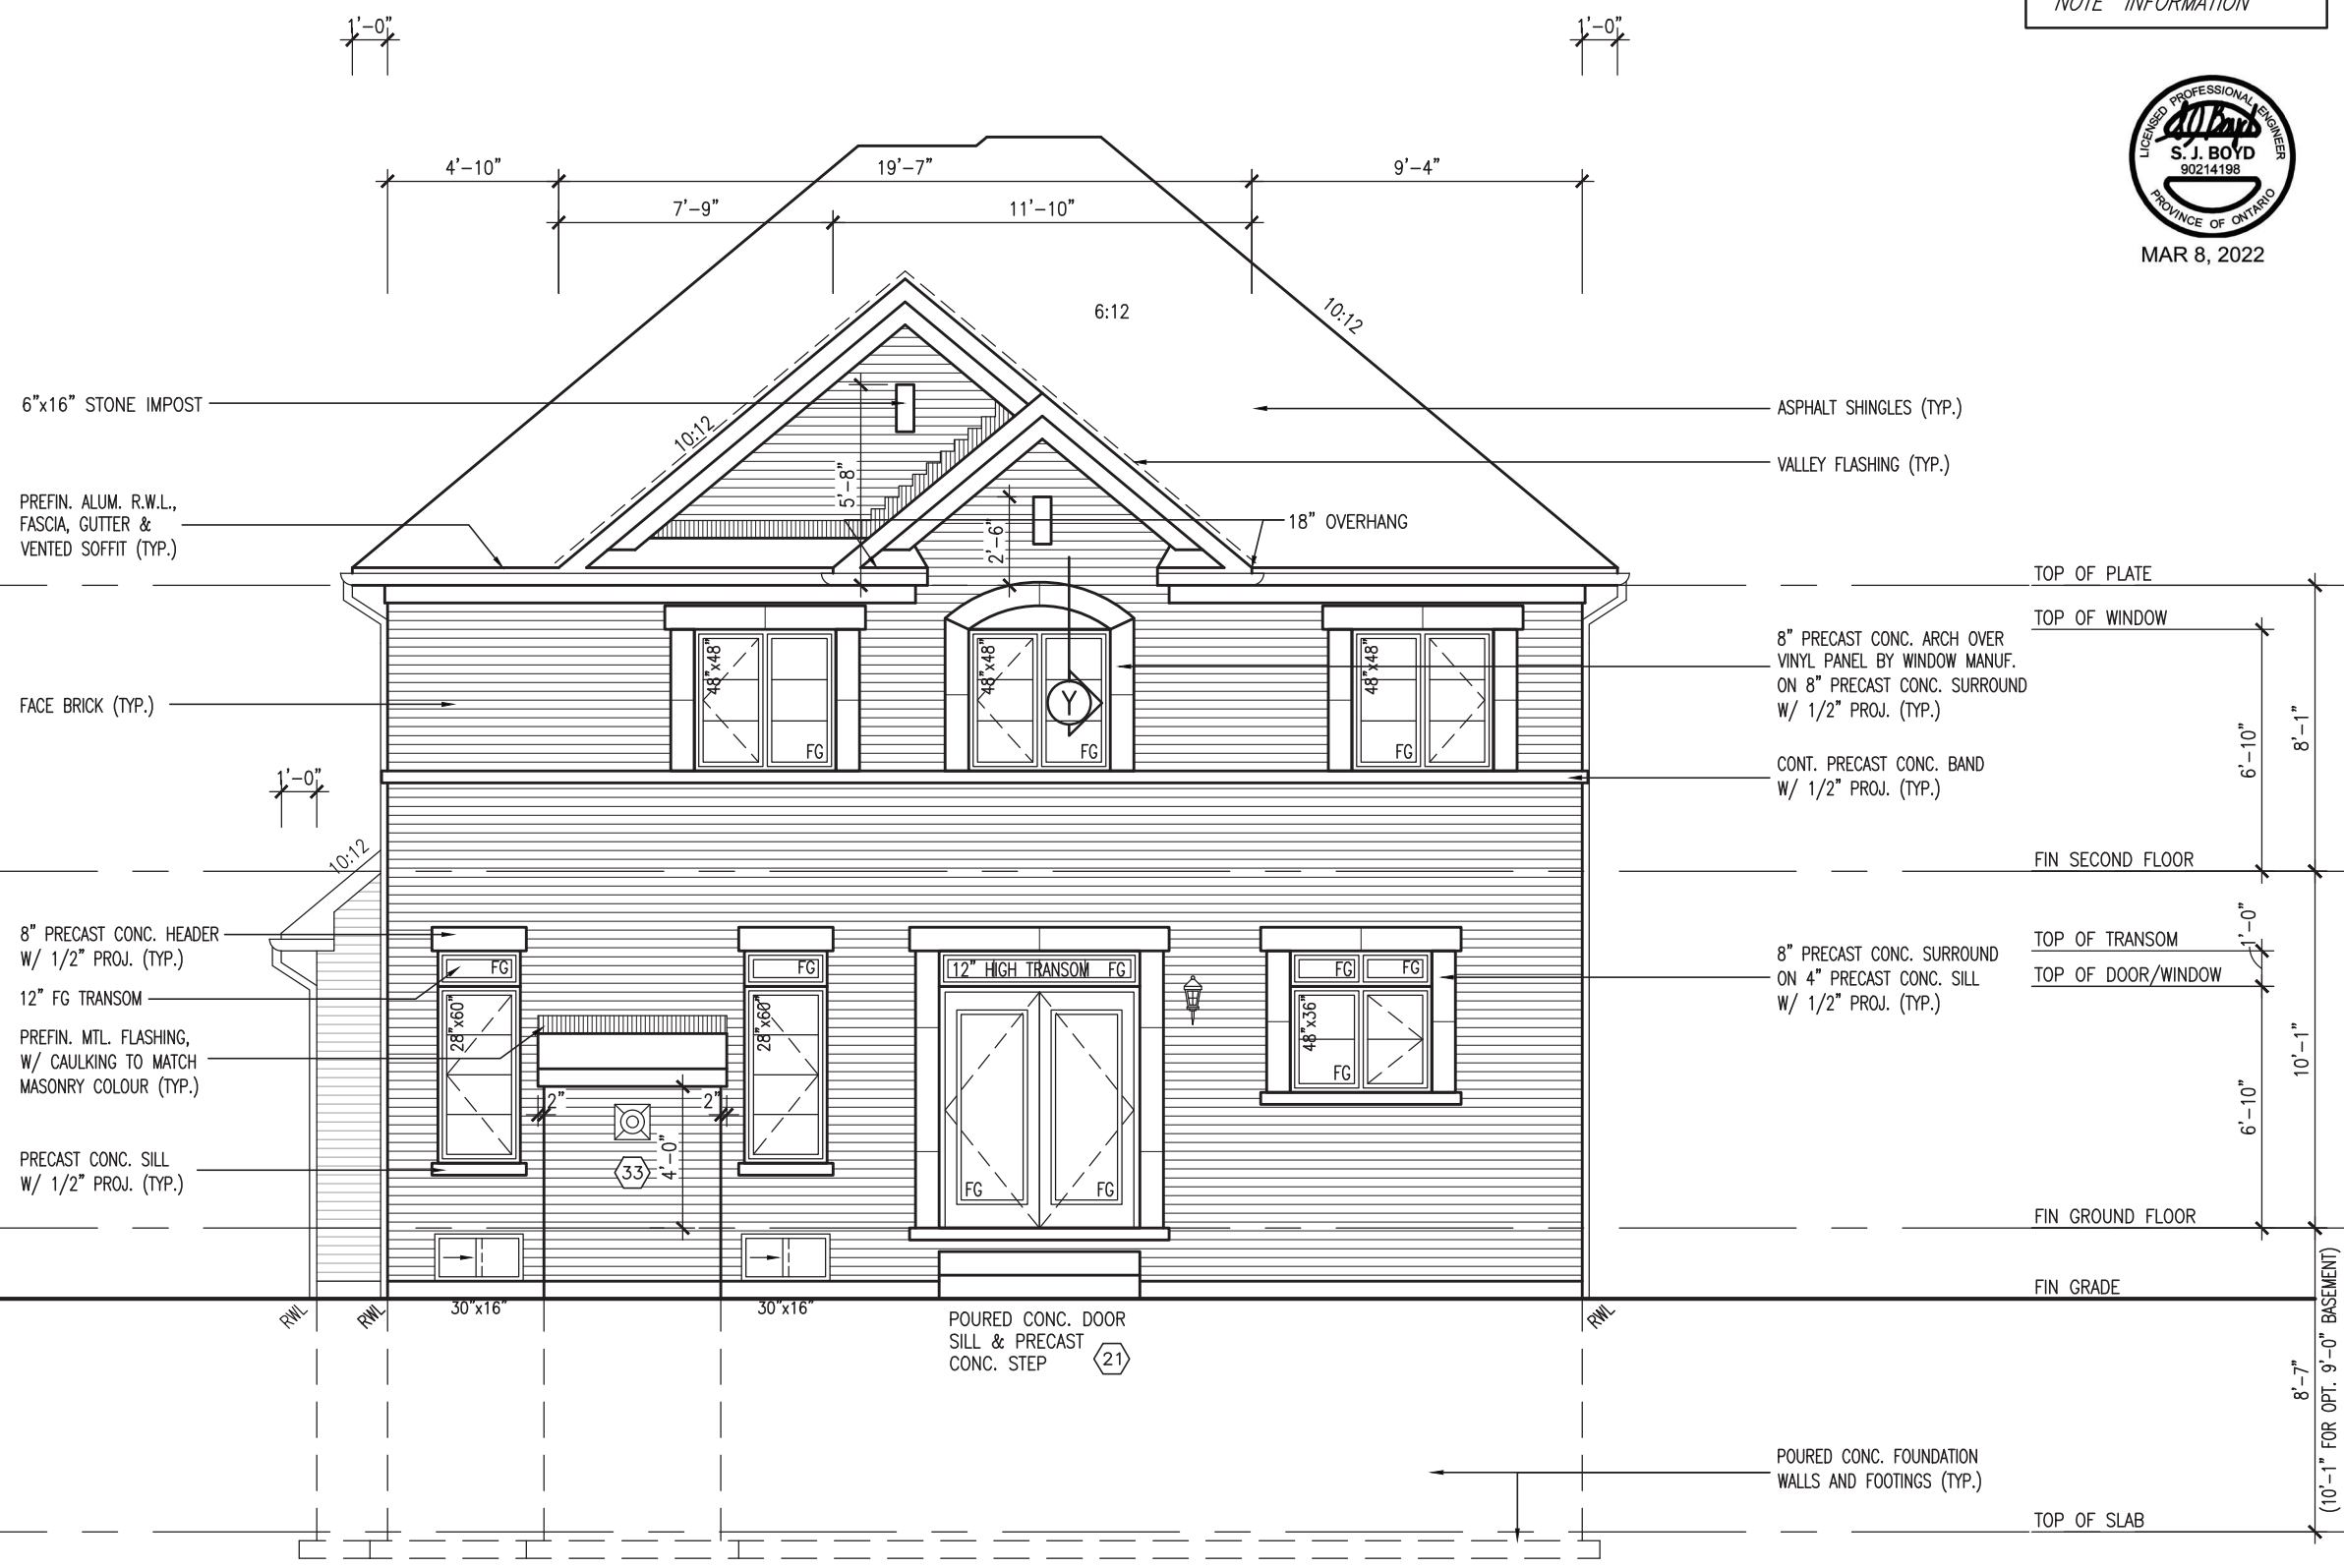
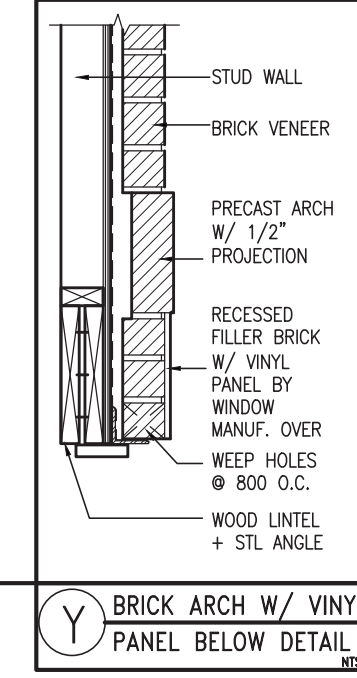
JOHN G. WILLIAMS LTD., ARCHITECT
ARCHITECTURAL CONTROL REVIEW
AND APPROVAL

APPROVED BY: _____
DATE: MAR 15, 2022

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R.W.L. AS REQUIRED &
AS PER MUNICIPALITY

NOTE: REFER TO FRONT
ELEVATION FOR TYPICAL
NOTE INFORMATION




REAR UPGRADE ELEVATION 'B'

project no. 16023		drawing no. 24	
project name S42-19		file name 16023-S42-19	
municipality BAYVIEW WELLINGTON		date OCTOBER 2021	
BRADFORD, ONTARIO		checked by JMW	
GREEN VALLEY EAST		scale 3/16" = 1'-0"	
BRADFORD, ONTARIO		drawn by TP	
REAR UPGRADE ELEVATION 'B'		RICHARD - H:\ARCHIVE\WORKING\2016\16023\B\Units\42\16023-S42-19.dwg - Tue - Mar 8 2022 - 1:00 PM	
		255 Consumers Rd, Suite 120 Toronto, ON M2J 1R4 t 416.630.2255 f 416.630.4782 v3design.com	
The undersigned has reviewed and takes responsibility for this design and has the qualifications and meets the requirements set out in the Ontario Building Code to be a Designer.		name Jno-Baptiste registration information 25591 BCIN 42658 VAS Design Inc.	
Contractor must verify all dimensions on the job and report any discrepancy to the Designer before proceeding with the work. All drawings and specifications are instruments of service and the property of the Designer which must be returned at the completion of the work. Drawings are not to be scaled.		MAR 03-22 RC FEB 24-22 RC NOV 26-21 VAS by date	
9	REVISED AS PER ENG COMMENTS		
8	REVISED AS PER FLOOR / ROOF LAYOUT		
7	ISSUED FOR CLIENT REVIEW		
6			
5			
4			
3			
2			
1			


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ARCHITECTURAL CONTROL REVIEW
AND APPROVAL

APPROVED BY: 
DATE: MAR 15, 2022

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GRAB BAR NOTE:


STUD WALL REINFORCEMENT FOR FUTURE GRAB BARS IN MAIN BATHROOM

REINFORCEMENT OF STUD WALLS SHALL BE INSTALLED ADJACENT TO WATER CLOSETS AND SHOWER OR BATHTUB IN MAIN BATHROOM PER OBC. DIV. B-9.5.2.3. REFER TO FOLLOWING SECTIONS FOR THE FIXTURES LISTED. WATER CLOSET: 3.8.3.8.(3)(a) & 3.8.3.8.(3)(c). SHOWER 3.8.3.13.(2)(g). BATHTUB 3.8.3.13.(4)(e). FREE STANDING BATHTUB EXCLUDED. SEE DETAILS PROVIDED. GB-NOTE-2020.dwg

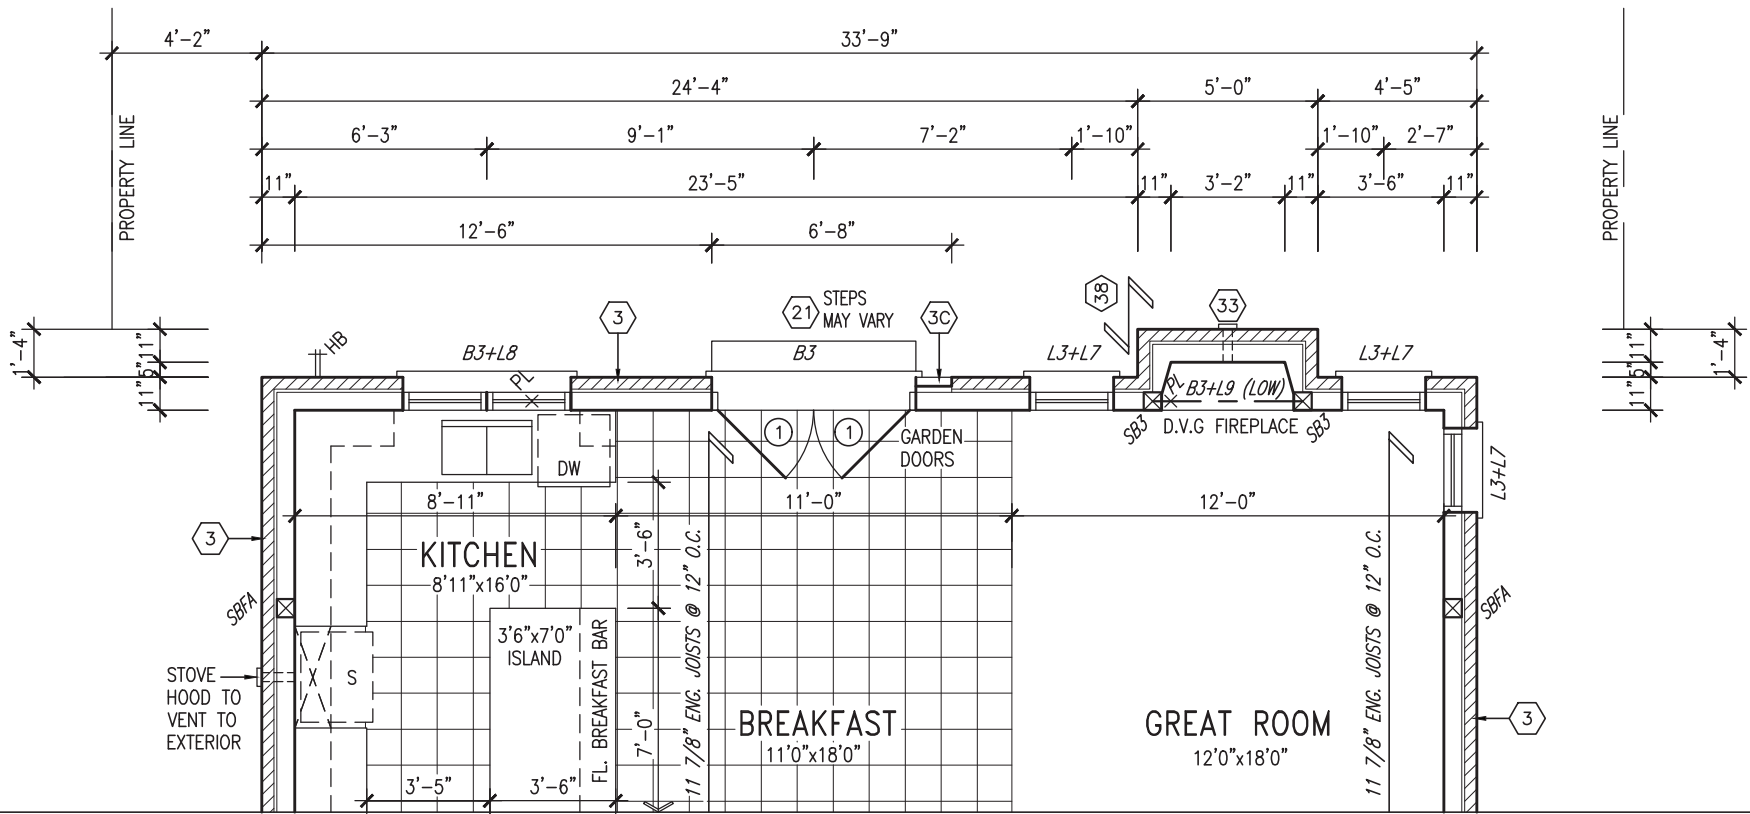PARTIAL SECOND FLOOR PLAN 'C' W/ REAR UPGRADE

NOTE: REFER TO ROOF TRUSS SHOP DRAWINGS / MANUFACTURER FOR ALL ROOF FRAMING INFORMATION UNLESS OTHERWISE NOTED.

NOTE: REFER TO STANDARD FLOOR PLANS FOR ADDITIONAL INFORMATION

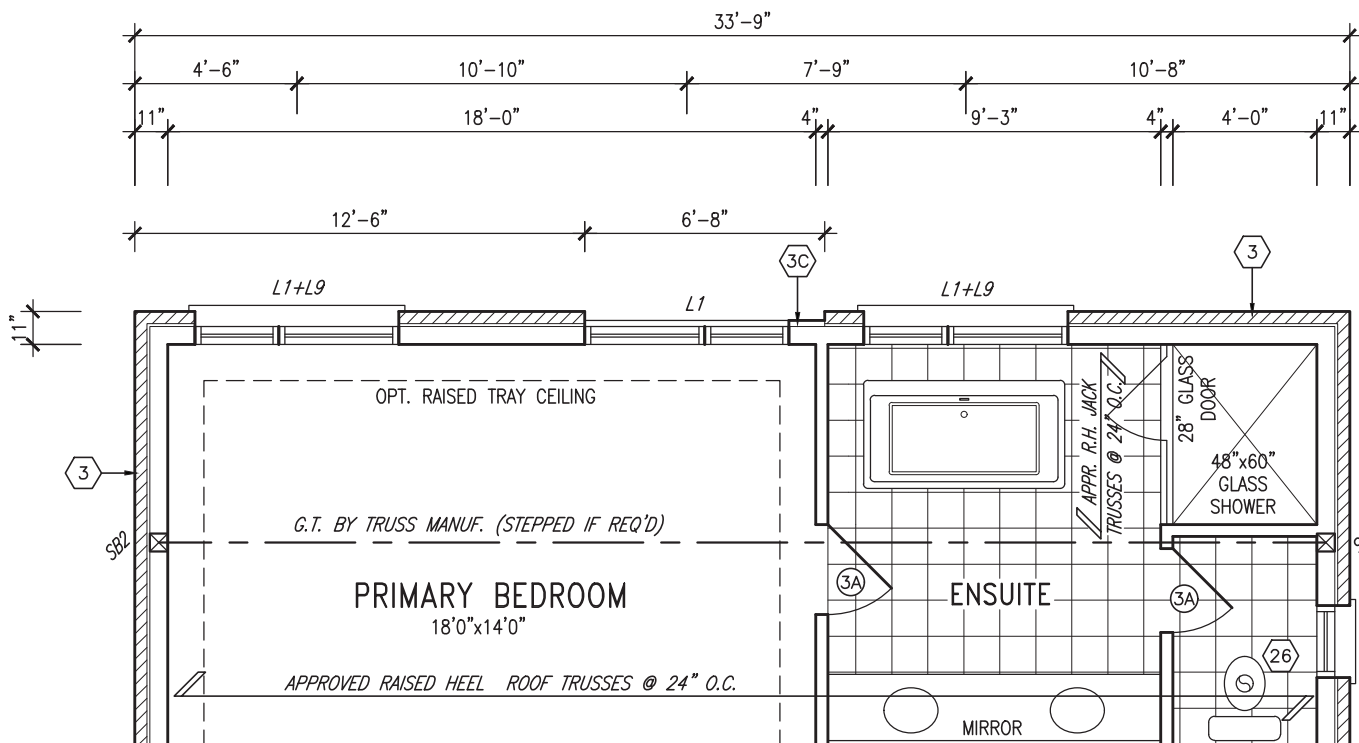

MAR 8, 2022

PARTIAL GROUND FLOOR PLAN 'C' W/ REAR UPGRADE

NOTE: REFER TO STANDARD FLOOR PLANS FOR ADDITIONAL INFORMATION

NOTE: ALL LVL'S SUPPORTING FLOOR LOADS ARE TO BE SPECIFIED BY THE FLOOR TRUSS MANUFACTURER.

NOTE: FLOOR FRAMING INFO REFER TO ENG SHOP DRAWINGS FOR ALL TRUSS-JOIST INFORMATION AND DETAILS. UNLESS OTHERWISE NOTED.

NOTE: SPACE ALL FLOOR JOISTS @ 12" O.C. UNDER ALL CERAMIC TILE AREAS.

OUTDOOR AIR INTAKE SEPARATION

ALL OUTDOOR AIR INTAKE VENTS TO BE SEPARATED A MINIMUM DISTANCE FROM SOURCES OF CONTAMINATION PER OBC. DIV. B- TABLE 6.2.3.12.

- KITCHEN EXHAUST. 3.0m
- DRIVEWAY, PARKING SPACE, ROAD. 1.5m
- SOLID FUEL APPLIANCE EXHAUST 3.0m

KIT-EX-NOTE-2020.dwg

9	.	.	.	The undersigned has reviewed and takes responsibility for this design and has the qualifications and meets the requirements set out in the Ontario Building Code to be a Designer.
8	.	.	.	qualification information
7	.	.	.	Wellington Jno-Baptiste 25591
6	.	.	.	name registration information BCIN
5	.	.	.	VA3 Design Inc. 42658
4	.	.	.	Contractor must verify all dimensions on the job and report any discrepancy to the Designer before proceeding with the work. All drawings and specifications are instruments of service and the property of the Designer which must be returned at the completion of the work. Drawings are not to be scaled.
3	REVISED AS PER ENG COMMENTS	MAR 03-22	RC	
2	REVISED AS PER FLOOR / ROOF LAYOUT	FEB 24-22	RC	
1	ISSUED FOR CLIENT REVIEW	NOV 26-21	VA3	
no.	description	date	by	

VA3 DESIGN
255 Consumers Rd Suite 120
Toronto ON M2J 1R4
t 416.630.2255 f 416.630.4782
va3design.com

BAYVIEW WELLINGTON
GREEN VALLEY EAST
BRADFORD, ONTARIO

S42-19
project no. 16023
drawing no. 25
date: OCTOBER 2021
checked by: JWM
scale: 3/16" = 1'-0"
file name: 16023-S42-19
RICHARD - H:\ARCHIVE\WORKING\2016\16023.BW\Units\42\16023-S42-19.dwg - Tue - Mar 8 2022 - 1:00 PM

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JOHN G. WILLIAMS LTD., ARCHITECT
ARCHITECTURAL CONTROL REVIEW
AND APPROVAL

APPROVED BY: _____
DATE: MAR 15, 2022

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R.W.L. AS REQUIRED &
AS PER MUNICIPALITY

NOTE: REFER TO FRONT
ELEVATION FOR TYPICAL
NOTE INFORMATION



MAR 8, 2022



STUCCO FINISH W/ 6"
STUCCO FRIEZE BOARD

6"x16" STUCCO IMPOST

PREFIN. MTL. FLASHING, W/
CAULKING BEHIND STUCCO
CLADDING (TYP.)

TOP OF PLATE

TOP OF WINDOW

BRICK SOLDIER COURSE ARCH
C/W PRECAST CONC.
KEYSTONE ON BRICK STACK
BOND W/ 1/2" PROJ. (TYP.)

PRECAST CONC. SILL ON BRICK
ROWLOCK W/ 1/2" PROJ. (TYP.)

FIN SECOND FLOOR

BRICK SOLDIER COURSE HEAR
C/W KEYSTONE ON BRICK STACK
BOND W/ 1/2" PROJ. (TYP.)

TOP OF TRANSOM

TOP OF DOOR/WINDOW

PROVIDE 2"x4" P.T. WOOD
HANDRAIL GUARD W/ 2"x2" P.T.
WOOD PICKETS @ 4" MAX.

FIN GROUND FLOOR

6"x6" P.T. WOOD POST C/W
GALV. METAL CAP AND METAL
SHOE SET INTO 12" DIA. SONO
TUBES TO EXTEND 6" ABOVE
GRADE AND 5'-0" BELOW GRADE.


TOP OF WINDOW

FIN GRADE

POURED CONC. FOUNDATION
WALLS AND FOOTINGS (TYP.)

TOP OF SLAB

8'-1"
6'-10"
1'-0"
10'-1"
6'-10"
8'-7"
(10'-1" FOR OPT. 9'-0" BASEMENT)

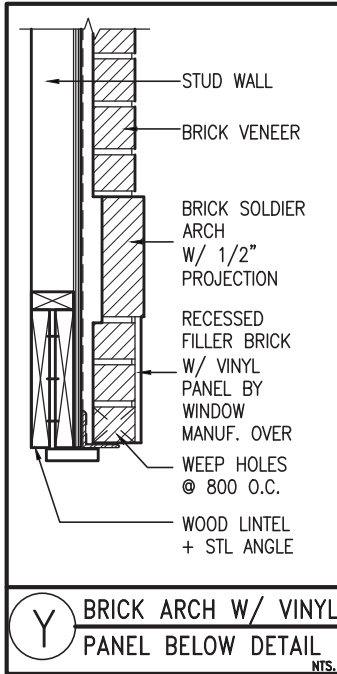

BRICK ARCH W/ VINYL
PANEL BELOW DETAIL
NTS.

REAR UPGRADE ELEVATION 'A' - W.O.D. CONDITION

S42-19

BAYVIEW WELLINGTON



255 Consumers Rd. Suite 120
Toronto, ON M2J 1R4
t 416.630.2255 f 416.630.4782
vo3design.com

no.	description	date	by
3	REVISED AS PER ENG COMMENTS	MAR 03-22 RC	
2	REVISED AS PER FLOOR / ROOF LAYOUT	FEB 24-22 RC	
1	ISSUED FOR CLIENT REVIEW	NOV 26-21 VA3	

project no. 16023
drawing no. 27
municipality BRADFORD, ONTARIO
project name GREEN VALLEY EAST
date OCTOBER 2021
checked by JMW
drawn by TP
scale 3/16" = 1'-0"
file name 16023-S42-19
RICHARD - H. ARCHIVE WORKING\2016\16023\16023-S42-19.dwg - Tue - Mar 8 2022 - 1:00 PM

BRADFORD, ONTARIO
REAR UPGRADE ELEVATION 'A' - W.O.D. COND.

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Toronto, ON M2J 1R4
t 416.630.2255 f 416.630.4782
vo3design.com

Wellington Jno-Baptiste
BIN 25591
BCIN 42658
VA3 Design Inc.

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JOHN G. WILLIAMS LTD., ARCHITECT
ARCHITECTURAL CONTROL REVIEW
AND APPROVAL

APPROVED BY: *[Signature]*
DATE: **MAR 15, 2022**


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R.W.L. AS REQUIRED & AS PER MUNICIPALITY

NOTE: REFER TO FRONT ELEVATION FOR TYPICAL NOTE INFORMATION



MAR 8, 2022

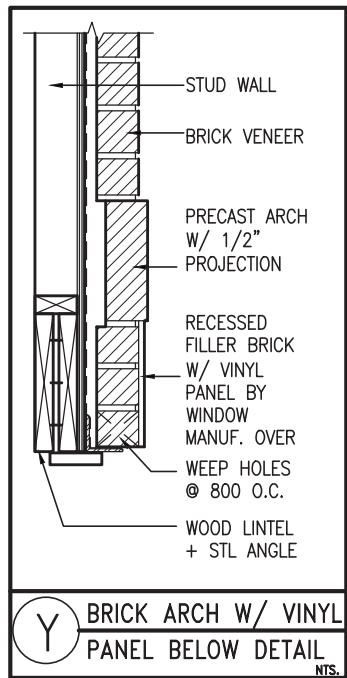

- 6"x16" STONE IMPOST
- PREFIN. ALUM. R.W.L., FASCIA, GUTTER & VENTED SOFFIT (TYP.)
- FACE BRICK (TYP.)
- 8" PRECAST CONC. ARCH OVER VINYL PANEL BY WINDOW MANUF. ON 8" PRECAST CONC. SURROUND W/ 1/2" PROJ. (TYP.)
- CONT. PRECAST CONC. BAND W/ 1/2" PROJ. (TYP.)
- 8" PRECAST CONC. SURROUND ON 4" PRECAST CONC. SILL W/ 1/2" PROJ. (TYP.)
- PROVIDE 2"x4" P.T. WOOD HANDRAIL GUARD W/ 2"x2" P.T. WOOD PICKETS @ 4" MAX.
- 6"x6" P.T. WOOD POST C/W GALV. METAL CAP AND METAL SHOE SET INTO 12" DIA. SONO TUBES TO EXTEND 6" ABOVE GRADE AND 5'-0" BELOW GRADE.
- ASPHALT SHINGLES (TYP.)
- VALLEY FLASHING (TYP.)
- 18" OVERHANG
- TOP OF PLATE
- TOP OF WINDOW
- FIN SECOND FLOOR
- TOP OF TRANSOM
- TOP OF DOOR/WINDOW
- FIN GROUND FLOOR
- TOP OF WINDOW
- FIN GRADE
- TOP OF SLAB
- POURED CONC. FOUNDATION WALLS AND FOOTINGS (TYP.)

BAYVIEW WELLINGTON

S42-19

GREEN VALLEY EAST
BRADFORD, ONTARIO

REAR UPGRADE ELEVATION 'B' - W.O.D. COND.

project no. 16023
drawing no. 28
file name 16023-S42-19
checked by JWM
drawn by TP
scale 3/16" = 1'-0"

date OCTOBER 2021
checked by JWM
drawn by TP

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VAS DESIGN
255 Consumers Rd, Suite 120
Toronto, ON M2J 1R4
t 416.630.2255 f 416.630.4782
vasdesign.com

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[Signature]
Wellington, Jno-Baptiste
name Wellington, Jno-Baptiste
registration information VAS Design Inc.
BCIN 25591
BIN 42658

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
no.	description	date	by
9	REVISED AS PER ENG COMMENTS	MAR 03-22	RC
8	REVISED AS PER FLOOR / ROOF LAYOUT	FEB 24-22	RC
7	ISSUED FOR CLIENT REVIEW	NOV 26-21	VA3

REAR UPGRADE ELEVATION 'B' - W.O.D. CONDITION

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This is to certify that these plans comply with the applicable Architectural Design Guidelines approved by the Town of BRADFORD WEST GWILLIMBURY.

JOHN G. WILLIAMS LTD., ARCHITECT
ARCHITECTURAL CONTROL REVIEW
AND APPROVAL

APPROVED BY: 
DATE: MAR 15, 2022


This stamp certifies compliance with the applicable Design Guidelines only and bears no further professional responsibility.

R.W.L. AS REQUIRED &
AS PER MUNICIPALITY

NOTE: REFER TO FRONT
ELEVATION FOR TYPICAL
NOTE INFORMATION




MAR 8, 2022

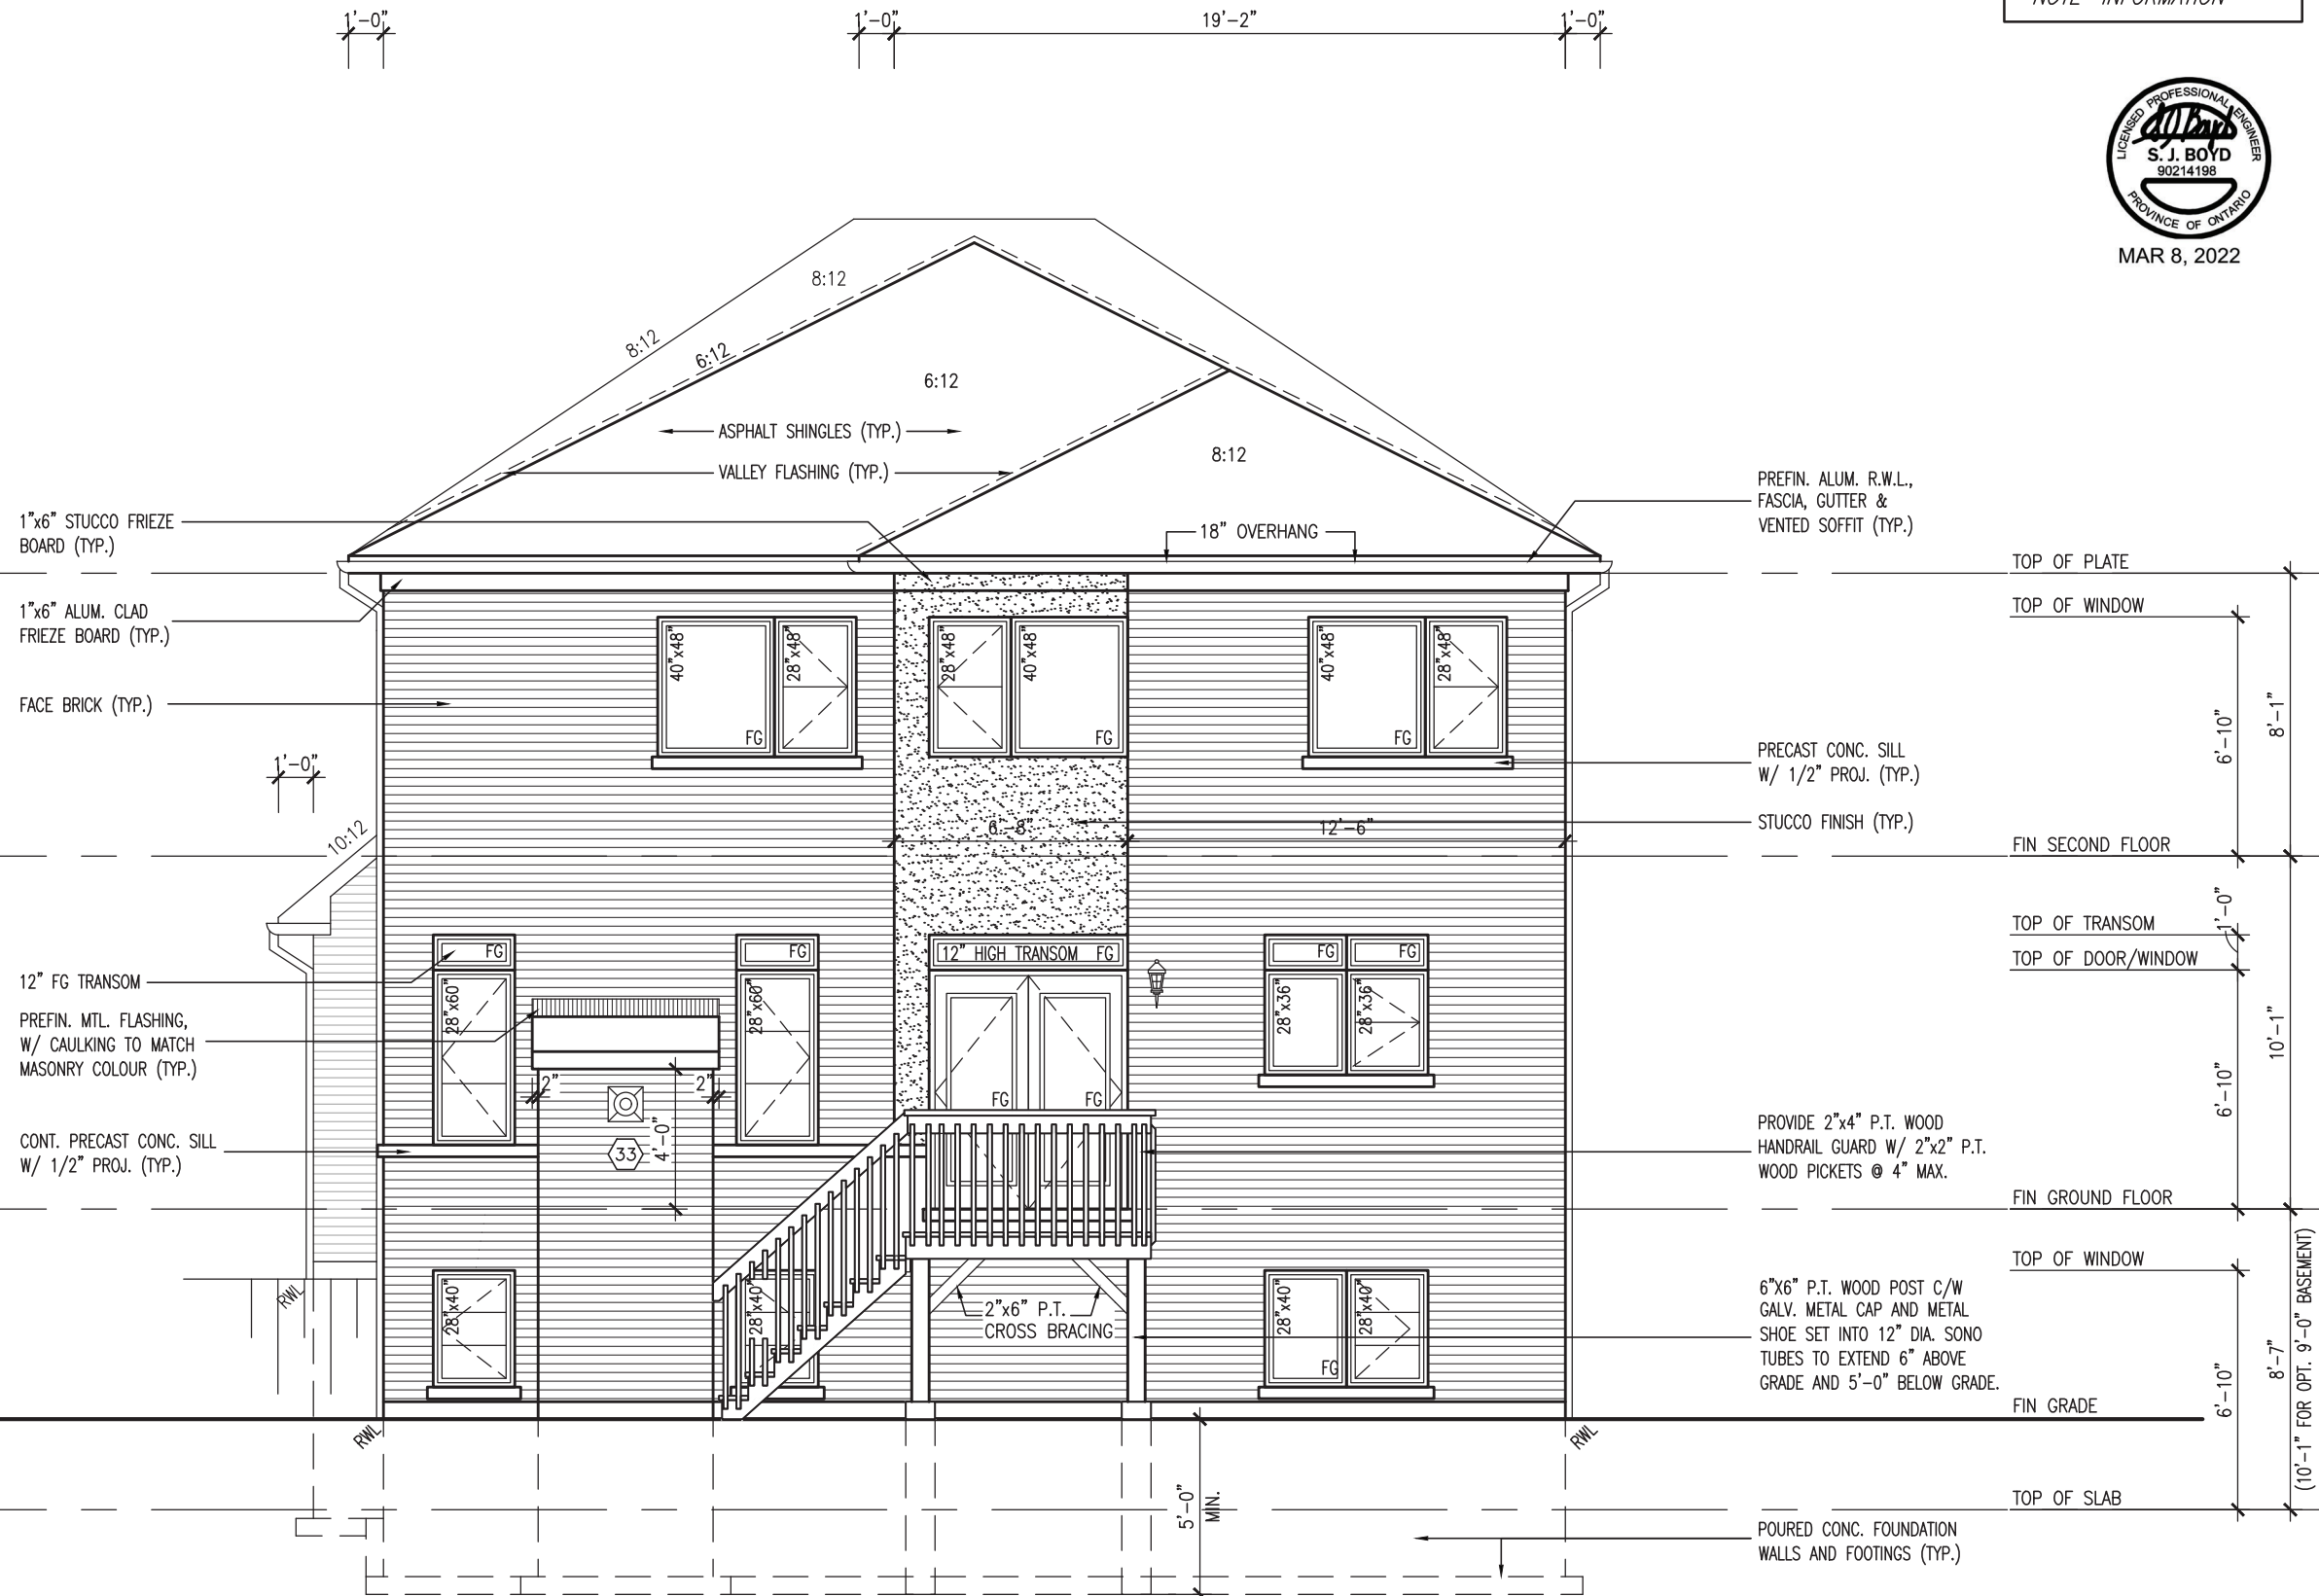

REAR UPGRADE ELEVATION 'C' - W.O.D. CONDITION

project name		GREEN VALLEY EAST		municipality		BRADFORD, ONTARIO	
project no.		16023		drawing no.		29	
date		OCTOBER 2021		checked by		J.W.M.	
drawn by		TP		scale		3/16" = 1'-0"	
file name		16023-S42-19		project no.		16023	
drawing no.		29		drawing no.		29	
description		REAR UPGRADE ELEVATION 'C' - W.O.D. COND.		description		REAR UPGRADE ELEVATION 'C' - W.O.D. COND.	
no.		date		no.		date	
3		MAR 03-22 RC		4		NOV 26-21 VA3	
2		REVISED AS PER FLOOR / ROOF LAYOUT		3		NOV 26-21 VA3	
1		ISSUED FOR CLIENT REVIEW		2		NOV 26-21 VA3	
9				1		NOV 26-21 VA3	
8				2		NOV 26-21 VA3	
7				3		NOV 26-21 VA3	
6				4		NOV 26-21 VA3	
5				5		NOV 26-21 VA3	
4				6		NOV 26-21 VA3	
3				7		NOV 26-21 VA3	
2				8		NOV 26-21 VA3	
1				9		NOV 26-21 VA3	




Wellington Jno-Baptiste
BCIN 25591
42658
name: Wellington Jno-Baptiste
signature: 
registration information: VAS Design Inc.
Contractor must verify all dimensions on the job and report any discrepancy to the Designer before proceeding with the work. All drawings and specifications are instruments of service and the property of the Designer which must be returned at the completion of the work. Drawings are not to be scaled.

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JOHN G. WILLIAMS LTD., ARCHITECT
ARCHITECTURAL CONTROL REVIEW
AND APPROVAL

APPROVED BY: 
DATE: MAR 15, 2022


This stamp certifies compliance with the applicable Design Guidelines only and bears no further professional responsibility.

R.W.L. AS REQUIRED & AS PER MUNICIPALITY

NOTE: REFER TO FRONT ELEVATION FOR TYPICAL NOTE INFORMATION



MAR 8, 2022

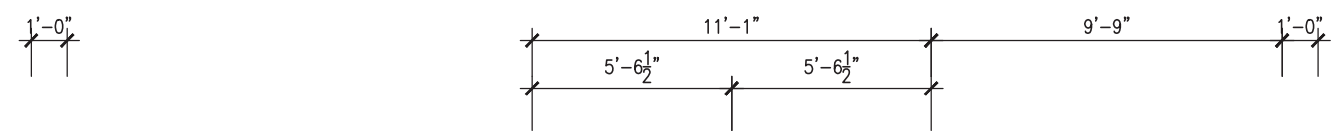

PREFIN. ALUM. R.W.L., FASCIA, GUTTER & VENTED SOFFIT (TYP.)

BRICK SOLDIER COURSE ON BRICK STACK BOND W/ 1/2" PROJ. (TYP.)

FACE BRICK (TYP.)

BRICK SOLDIER COURSE HEADER C/W KEystone W/ 1/2" PROJ. (TYP.)

12" FG TRANSOM

PREFIN. MTL. FLASHING, W/ CAULKING TO MATCH MASONRY COLOUR (TYP.)

STUCCO FINISH W/ 6" STUCCO FRIEZE BOARD

6"x16" STUCCO IMPOST

PREFIN. MTL. FLASHING, W/ CAULKING BEHIND STUCCO CLADDING (TYP.)

BRICK SOLDIER COURSE ARCH C/W PRECAST CONC. KEystone ON BRICK STACK BOND W/ 1/2" PROJ. (TYP.)

PRECAST CONC. SILL ON BRICK ROWLOCK W/ 1/2" PROJ. (TYP.)


BRICK SOLDIER COURSE HEAR C/W KEystone ON BRICK STACK BOND W/ 1/2" PROJ. (TYP.)

PROVIDE 2"x4" P.T. WOOD HANDRAIL GUARD W/ 2"x2" P.T. WOOD PICKETS @ 4" MAX.

2"x6" P.T. CROSS BRACING

6"x6" P.T. WOOD POST C/W GALV. METAL CAP AND METAL SHOE SET INTO 12" DIA. SONO TUBES TO EXTEND 6" ABOVE GRADE AND 5'-0" BELOW GRADE.

POURED CONC. FOUNDATION WALLS AND FOOTINGS (TYP.)

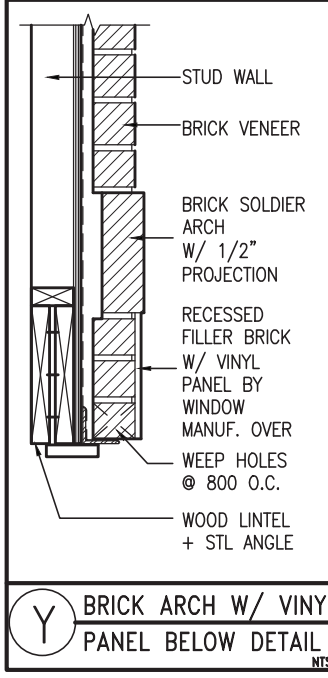

Y BRICK ARCH W/ VINYL PANEL BELOW DETAIL
NTS.



REAR UPGRADE ELEVATION 'A' - W.O.B. CONDITION

project name BAYVIEW WELLINGTON		municipality BRADFORD, ONTARIO	
project no. S42-19		drawing no. 30	
project name GREEN VALLEY EAST		municipality BRADFORD, ONTARIO	
project no. 16023		drawing no. 30	
date OCTOBER 2021		file name 16023-S42-19	
drawn by TP		checked by JWM	
scale 3/16" = 1'-0"		date MAR 8, 2022 - 1:01 PM	
project name REAR UPGRADE ELEVATION 'A' - W.O.D. COND.			
project no. 16023-542-19			

9	REVISED AS PER ENG COMMENTS	MAR 03-22	RC
8	REVISED AS PER FLOOR / ROOF LAYOUT	FEB 24-22	RC
7	ISSUED FOR CLIENT REVIEW	NOV 26-21	VA3
6			
5			
4			
3			
2			
1			

signature <i>[Signature]</i>	BCIN 25591
name Wellington Jno-Baptiste	BCIN 42658
registration information VA3 Design Inc.	

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JOHN G. WILLIAMS LTD., ARCHITECT
ARCHITECTURAL CONTROL REVIEW
AND APPROVAL

APPROVED BY:
DATE: MAR 15, 2022

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R.W.L. AS REQUIRED &
AS PER MUNICIPALITY

*NOTE: REFER TO FRONT
ELEVATION FOR TYPICAL
NOTE INFORMATION*



6"x16" STONE IMPOST

PREFIN. ALUM. R.W.L.,
FASCIA, GUTTER &
VENTED SOFFIT (TYP.)

ASPHALT SHINGLES (TYP.)
VALLEY FLASHING (TYP.)

FACE BRICK (TYP.)

8" PRECAST CONC. ARCH OVER
VINYL PANEL BY WINDOW MANUF.
ON 8" PRECAST CONC. SURROUND
W/ 1/2" PROJ. (TYP.)

CONT. PRECAST CONC. BAND
W/ 1/2" PROJ. (TYP.)

TOP OF PLATE
TOP OF WINDOW
8'-1"
FIN SECOND FLOOR
TOP OF TRANSOM
TOP OF DOOR/WINDOW
1'-0"
6'-10"
10'-1"
FIN GROUND FLOOR
TOP OF DOOR/WINDOW
8'-7"
6'-10"
(10'-1" FOR OPT. 9'-0" BASEMENT)
TOP OF SLAB
FIN GRADE

8" PRECAST CONC. HEADER
W/ 1/2" PROJ. (TYP.)
12" FG TRANSOM
PREFIN. MTL. FLASHING,
W/ CAULKING TO MATCH
MASONRY COLOUR (TYP.)
PRECAST CONC. SILL
W/ 1/2" PROJ. (TYP.)


8" PRECAST CONC. SURROUND
ON 4" PRECAST CONC. SILL
W/ 1/2" PROJ. (TYP.)

PROVIDE 2"x4" P.T. WOOD
HANDRAIL GUARD W/ 2"x2" P.T.
WOOD PICKETS @ 4" MAX.

2"x6" P.T.
CROSS BRACING

6"x6" P.T. WOOD POST C/W
GALV. METAL CAP AND METAL
SHOE SET INTO 12" DIA. SONO
TUBES TO EXTEND 6" ABOVE
GRADE AND 5'-0" BELOW GRADE.

POURED CONC. FOUNDATION
WALLS AND FOOTINGS (TYP.)

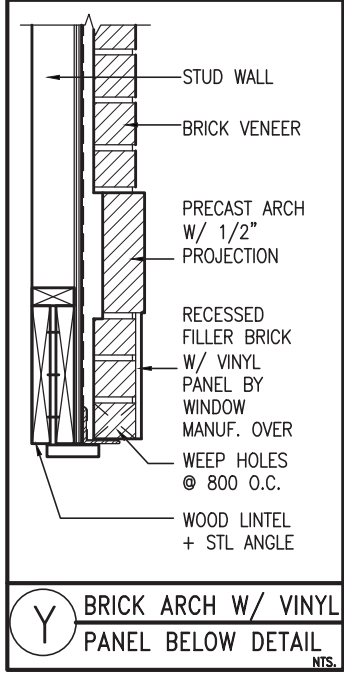

REAR UPGRADE ELEVATION 'B' - W.O.B. CONDITION

project name		GREEN VALLEY EAST		municipality		BRADFORD, ONTARIO	
project no.		16023		drawing no.		31	
date		OCTOBER 2021		checked by		JMW	
drawn by		TP		scale		3/16" = 1'-0"	
project name		BAYVIEW WELLINGTON		project no.		S42-19	
project name		GREEN VALLEY EAST		project no.		16023	
date		OCTOBER 2021		checked by		JMW	
drawn by		TP		scale		3/16" = 1'-0"	
project name		REAR UPGRADE ELEVATION 'B' - W.O.D. COND.		project no.		16023-S42-19	
date		OCTOBER 2021		checked by		JMW	
drawn by		TP		scale		3/16" = 1'-0"	
project name		BAYVIEW WELLINGTON		project no.		S42-19	
project name		GREEN VALLEY EAST		project no.		16023	
date		OCTOBER 2021		checked by		JMW	
drawn by		TP		scale		3/16" = 1'-0"	
project name		REAR UPGRADE ELEVATION 'B' - W.O.D. COND.		project no.		16023-S42-19	
date		OCTOBER 2021		checked by		JMW	
drawn by		TP		scale		3/16" = 1'-0"	
project name		BAYVIEW WELLINGTON		project no.		S42-19	
project name		GREEN VALLEY EAST		project no.		16023	
date		OCTOBER 2021		checked by		JMW	
drawn by		TP		scale		3/16" = 1'-0"	
project name		REAR UPGRADE ELEVATION 'B' - W.O.D. COND.		project no.		16023-S42-19	
date		OCTOBER 2021		checked by		JMW	
drawn by		TP		scale		3/16" = 1'-0"	
project name		BAYVIEW WELLINGTON		project no.		S42-19	
project name		GREEN VALLEY EAST		project no.		16023	
date		OCTOBER 2021		checked by		JMW	
drawn by		TP		scale		3/16" = 1'-0"	
project name		REAR UPGRADE ELEVATION 'B' - W.O.D. COND.		project no.		16023-S42-19	
date		OCTOBER 2021		checked by		JMW	
drawn by		TP		scale		3/16" = 1'-0"	

VAS DESIGN
255 Consumers Rd, Suite 120
Toronto, ON M2J 1R4
t 416.630.2255 f 416.630.4782
vasdesign.com

The undersigned has reviewed and takes responsibility for this design and has the qualifications and meets the requirements set out in the Ontario Building Code to be a Designer.

Wellington Jno-Baptiste
signature
BCIN 25591
BIN 42658

3. REVISED AS PER ENG COMMENTS
2. REVISED AS PER FLOOR / ROOF LAYOUT
1. ISSUED FOR CLIENT REVIEW


no. description

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ARCHITECTURAL CONTROL REVIEW
AND APPROVAL

APPROVED BY: 
DATE: MAR 15, 2022


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R.W.L. AS REQUIRED &
AS PER MUNICIPALITY

NOTE: REFER TO FRONT
ELEVATION FOR TYPICAL
NOTE INFORMATION



MAR 8, 2022

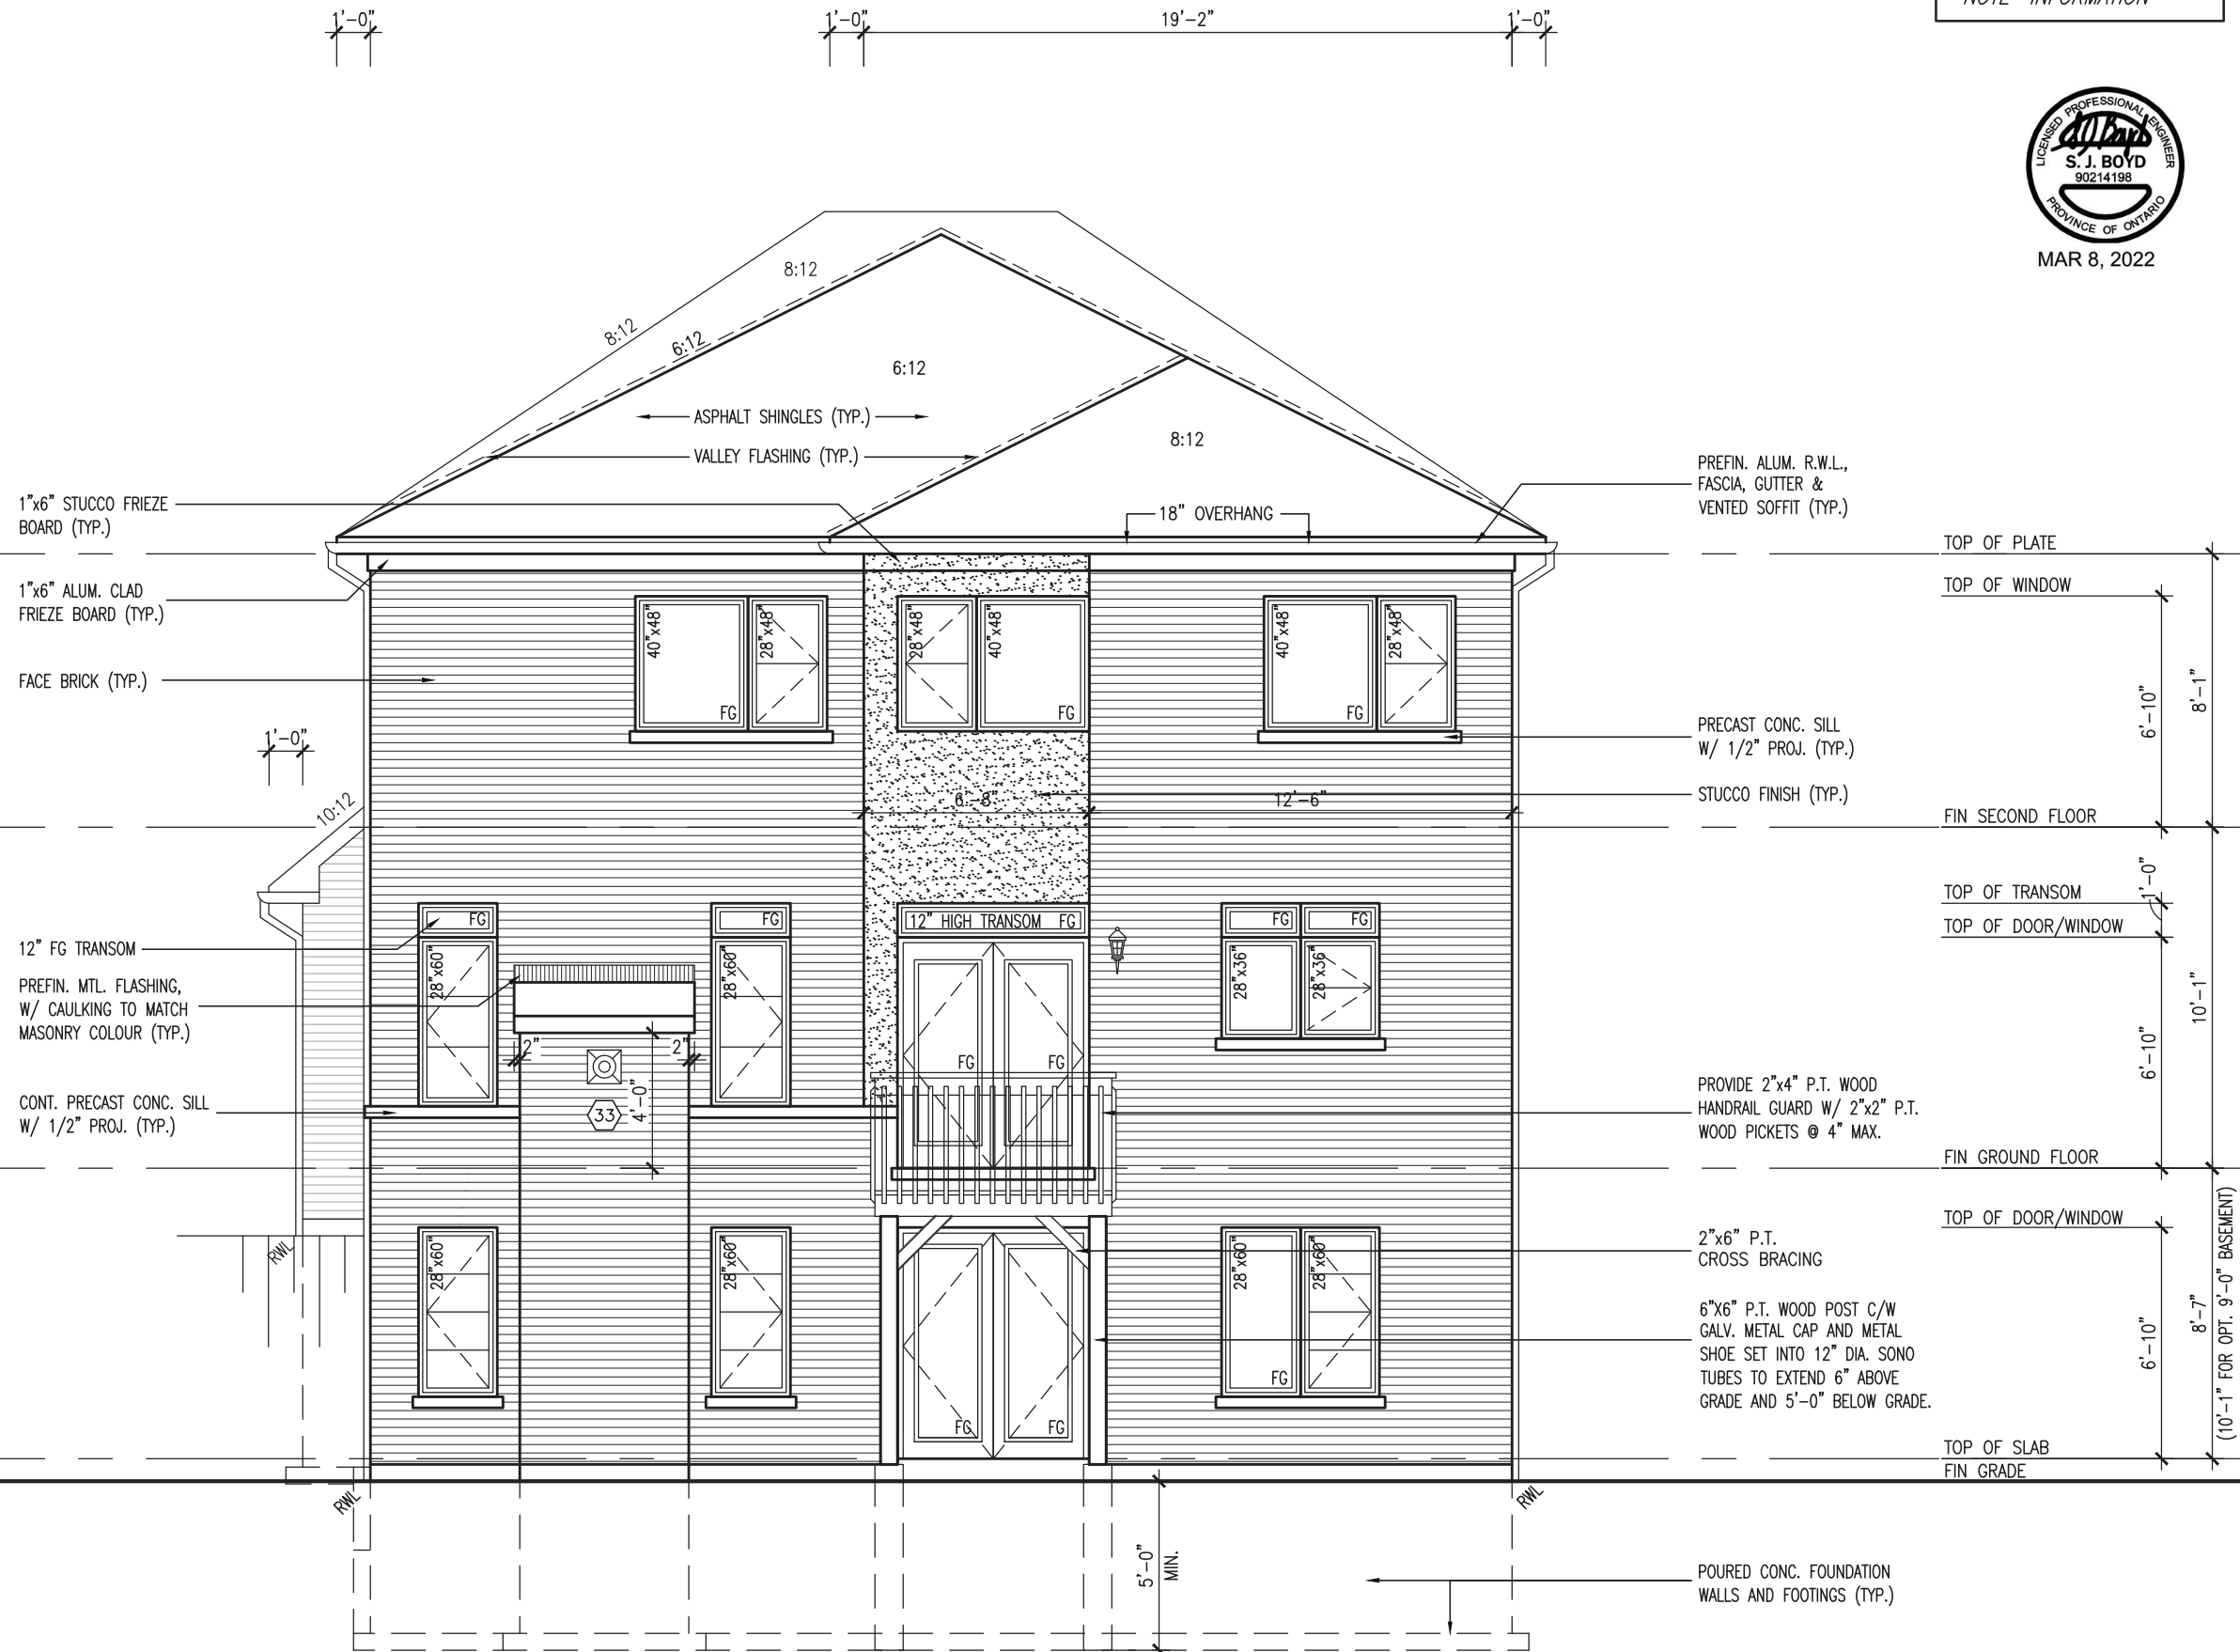

REAR UPGRADE ELEVATION 'C' - W.O.B. CONDITION

project name BAYVIEW WELLINGTON		municipality BRADFORD, ONTARIO		project no. 16023
project name GREEN VALLEY EAST		municipality BRADFORD, ONTARIO		drawing no. 32
date OCTOBER 2021		date OCTOBER 2021		file name 16023-S42-19
checked by JWM		checked by JWM		scale 3/16" = 1'-0"
drawn by TP		drawn by TP		drawn by TP

 DESIGN 255 Consumers Rd. Suite 120 Toronto, ON M2J 1R4 t 416.630.2255 f 416.630.4782 v3design.com	
The undersigned has reviewed and takes responsibility for this design and has the qualifications and meets the requirements set out in the Ontario Building Code to be a Designer. qualification information name Wellington Jno-Baptiste registration information VAS Design Inc. name Wellington Jno-Baptiste BCIN 25591 42658	Contractor must verify all dimensions on the job and report any discrepancy to the Designer before proceeding with the work. All drawings and specifications are instruments of service and the property of the Designer which must be returned at the completion of the work. Drawings are not to be scaled.
3 REVISED AS PER ENG COMMENTS MAR 03-22 RC 2 REVISED AS PER FLOOR / ROOF LAYOUT FEB 24-22 RC 1 ISSUED FOR CLIENT REVIEW NOV 26-21 VAS3	date by .

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UNINSULATED OPENINGS (PER OBC. SB-12,3.1.1(7))				
STANDARD & REAR UPGRADE-9' GDN. FL.	S42-19 ELEVATION A	ENERGY EFFICIENCY - OBC SB12		
	ELEVATION	WALL AREA S.F.	OPENING S.F.	PERCENTAGE
	FRONT	664 S.F.	134.86 S.F.	20.31 %
	LEFT SIDE	1106 S.F.	77.33 S.F.	6.99 %
	RIGHT SIDE	1106 S.F.	71.33 S.F.	6.45 %
	REAR	681 S.F.	143.05 S.F.	21.01 %
* OPENINGS OMITTED AS PER SB-12 3.1.1.9(4) MAX 19.9 S.F. REFER TO ELEVATION FOR LOCATION		0.00 S.F.		
TOTAL SQ. FT.	3557.00 S.F.	426.57 S.F.	11.99 %	
TOTAL SQ. M.	330.45 S.M.	39.63 S.M.	11.99 %	
UNINSULATED OPENINGS (PER OBC. SB-12,3.1.1(7))				
STANDARD & REAR UPGRADE W/ SIDE DOOR 9' GDN. FL.	S42-19 ELEVATION A	ENERGY EFFICIENCY - OBC SB12		
	ELEVATION	WALL AREA S.F.	OPENING S.F.	PERCENTAGE
	FRONT	664 S.F.	134.86 S.F.	20.31 %
	LEFT SIDE	1106 S.F.	77.33 S.F.	6.99 %
	RIGHT SIDE	1106 S.F.	80.83 S.F.	7.31 %
	REAR	681 S.F.	143.05 S.F.	21.01 %
* OPENINGS OMITTED AS PER SB-12 3.1.1.9(4) MAX 19.9 S.F. REFER TO ELEVATION FOR LOCATION		0.00 S.F.		
TOTAL SQ. FT.	3557.00 S.F.	436.07 S.F.	12.26 %	
TOTAL SQ. M.	330.45 S.M.	40.51 S.M.	12.26 %	

UNINSULATED OPENINGS (PER OBC. SB-12,3.1.1(7))				
STANDARD & REAR UPGRADE 9' GDN. FL.	S42-19 ELEVATION A -W.O.D.	ENERGY EFFICIENCY - OBC SB12		
	ELEVATION	WALL AREA S.F.	OPENING S.F.	PERCENTAGE
	FRONT	664 S.F.	134.86 S.F.	20.31 %
	LEFT SIDE	1106 S.F.	77.33 S.F.	6.99 %
	RIGHT SIDE	1106 S.F.	71.33 S.F.	6.45 %
	REAR	816 S.F.	165.28 S.F.	20.25 %
* OPENINGS OMITTED AS PER SB-12 3.1.1.9(4) MAX 19.9 S.F. REFER TO ELEVATION FOR LOCATION		0.00 S.F.		
TOTAL SQ. FT.	3692.00 S.F.	448.80 S.F.	12.16 %	
TOTAL SQ. M.	343.00 S.M.	41.69 S.M.	12.16 %	
UNINSULATED OPENINGS (PER OBC. SB-12,3.1.1(7))				
STANDARD & REAR UPGRADE W/ SIDE DOOR 9' GDN. FL.	S42-19 ELEVATION A -W.O.D.	ENERGY EFFICIENCY - OBC SB12		
	ELEVATION	WALL AREA S.F.	OPENING S.F.	PERCENTAGE
	FRONT	664 S.F.	134.86 S.F.	20.31 %
	LEFT SIDE	1106 S.F.	77.33 S.F.	6.99 %
	RIGHT SIDE	1106 S.F.	80.83 S.F.	7.31 %
	REAR	816 S.F.	165.28 S.F.	20.25 %
* OPENINGS OMITTED AS PER SB-12 3.1.1.9(4) MAX 19.9 S.F. REFER TO ELEVATION FOR LOCATION		0.00 S.F.		
TOTAL SQ. FT.	3692.00 S.F.	458.30 S.F.	12.41 %	
TOTAL SQ. M.	343.00 S.M.	42.58 S.M.	12.41 %	

UNINSULATED OPENINGS (PER OBC. SB-12,3.1.1(7))				
STANDARD & REAR UPGRADE 9' GDN. FL.	S42-19 ELEVATION A -W.O.B.	ENERGY EFFICIENCY - OBC SB12		
	ELEVATION	WALL AREA S.F.	OPENING S.F.	PERCENTAGE
	FRONT	664 S.F.	134.86 S.F.	20.31 %
	LEFT SIDE	1106 S.F.	77.33 S.F.	6.99 %
	RIGHT SIDE	1106 S.F.	71.33 S.F.	6.45 %
	REAR	925 S.F.	218.44 S.F.	23.62 %
* OPENINGS OMITTED AS PER SB-12 3.1.1.9(4) MAX 19.9 S.F. REFER TO ELEVATION FOR LOCATION		0.00 S.F.		
TOTAL SQ. FT.	3801.00 S.F.	501.96 S.F.	13.21 %	
TOTAL SQ. M.	353.12 S.M.	46.63 S.M.	13.21 %	
UNINSULATED OPENINGS (PER OBC. SB-12,3.1.1(7))				
STANDARD & REAR UPGRADE W/ SIDE DOOR 9' GDN. FL.	S42-19 ELEVATION A -W.O.B.	ENERGY EFFICIENCY - OBC SB12		
	ELEVATION	WALL AREA S.F.	OPENING S.F.	PERCENTAGE
	FRONT	664 S.F.	134.86 S.F.	20.31 %
	LEFT SIDE	1106 S.F.	77.33 S.F.	6.99 %
	RIGHT SIDE	1106 S.F.	80.83 S.F.	7.31 %
	REAR	925 S.F.	218.44 S.F.	23.62 %
* OPENINGS OMITTED AS PER SB-12 3.1.1.9(4) MAX 19.9 S.F. REFER TO ELEVATION FOR LOCATION		0.00 S.F.		
TOTAL SQ. FT.	3801.00 S.F.	511.46 S.F.	13.46 %	
TOTAL SQ. M.	353.12 S.M.	47.52 S.M.	13.46 %	

UNINSULATED OPENINGS (PER OBC. SB-12,3.1.1(7))				
STANDARD & REAR UPGRADE 9' GDN. FL.	S42-19 ELEVATION B	ENERGY EFFICIENCY - OBC SB12		
	ELEVATION	WALL AREA S.F.	OPENING S.F.	PERCENTAGE
	FRONT	664 S.F.	125.53 S.F.	18.91 %
	LEFT SIDE	1106 S.F.	77.33 S.F.	6.99 %
	RIGHT SIDE	1106 S.F.	71.33 S.F.	6.45 %
	REAR	681 S.F.	143.05 S.F.	21.01 %
* OPENINGS OMITTED AS PER SB-12 3.1.1.9(4) MAX 19.9 S.F. REFER TO ELEVATION FOR LOCATION		0.00 S.F.		
TOTAL SQ. FT.	3557.00 S.F.	417.24 S.F.	11.73 %	
TOTAL SQ. M.	330.45 S.M.	38.76 S.M.	11.73 %	
UNINSULATED OPENINGS (PER OBC. SB-12,3.1.1(7))				
STANDARD & REAR UPGRADE W/ SIDE DOOR 9' GDN. FL.	S42-19 ELEVATION B	ENERGY EFFICIENCY - OBC SB12		
	ELEVATION	WALL AREA S.F.	OPENING S.F.	PERCENTAGE
	FRONT	664 S.F.	125.53 S.F.	18.91 %
	LEFT SIDE	1106 S.F.	77.33 S.F.	6.99 %
	RIGHT SIDE	1106 S.F.	80.83 S.F.	7.31 %
	REAR	681 S.F.	143.05 S.F.	21.01 %
* OPENINGS OMITTED AS PER SB-12 3.1.1.9(4) MAX 19.9 S.F. REFER TO ELEVATION FOR LOCATION		0.00 S.F.		
TOTAL SQ. FT.	3557.00 S.F.	426.74 S.F.	12.00 %	
TOTAL SQ. M.	330.45 S.M.	39.65 S.M.	12.00 %	

UNINSULATED OPENINGS (PER OBC. SB-12,3.1.1(7))				
STANDARD & REAR UPGRADE 9' GDN. FL.	S42-19 ELEVATION B -W.O.D.	ENERGY EFFICIENCY - OBC SB12		
	ELEVATION	WALL AREA S.F.	OPENING S.F.	PERCENTAGE
	FRONT	664 S.F.	125.53 S.F.	18.91 %
	LEFT SIDE	1106 S.F.	77.33 S.F.	6.99 %
	RIGHT SIDE	1106 S.F.	71.33 S.F.	6.45 %
	REAR	816 S.F.	165.28 S.F.	20.25 %
* OPENINGS OMITTED AS PER SB-12 3.1.1.9(4) MAX 19.9 S.F. REFER TO ELEVATION FOR LOCATION		0.00 S.F.		
TOTAL SQ. FT.	3692.00 S.F.	439.47 S.F.	11.90 %	
TOTAL SQ. M.	343.00 S.M.	40.83 S.M.	11.90 %	
UNINSULATED OPENINGS (PER OBC. SB-12,3.1.1(7))				
STANDARD & REAR UPGRADE W/ SIDE DOOR 9' GDN. FL.	S42-19 ELEVATION B -W.O.D.	ENERGY EFFICIENCY - OBC SB12		
	ELEVATION	WALL AREA S.F.	OPENING S.F.	PERCENTAGE
	FRONT	664 S.F.	125.53 S.F.	18.91 %
	LEFT SIDE	1106 S.F.	77.33 S.F.	6.99 %
	RIGHT SIDE	1106 S.F.	80.83 S.F.	7.31 %
	REAR	816 S.F.	165.28 S.F.	20.25 %
* OPENINGS OMITTED AS PER SB-12 3.1.1.9(4) MAX 19.9 S.F. REFER TO ELEVATION FOR LOCATION		0.00 S.F.		
TOTAL SQ. FT.	3692.00 S.F.	448.97 S.F.	12.16 %	
TOTAL SQ. M.	343.00 S.M.	41.71 S.M.	12.16 %	

UNINSULATED OPENINGS (PER OBC. SB-12,3.1.1(7))				
STANDARD & REAR UPGRADE 9' GDN. FL.	S42-19 ELEVATION B -W.O.B.	ENERGY EFFICIENCY - OBC SB12		
	ELEVATION	WALL AREA S.F.	OPENING S.F.	PERCENTAGE
	FRONT	664 S.F.	125.53 S.F.	18.91 %
	LEFT SIDE	1106 S.F.	77.33 S.F.	6.99 %
	RIGHT SIDE	1106 S.F.	71.33 S.F.	6.45 %
	REAR	925 S.F.	218.44 S.F.	23.62 %
* OPENINGS OMITTED AS PER SB-12 3.1.1.9(4) MAX 19.9 S.F. REFER TO ELEVATION FOR LOCATION		0.00 S.F.		
TOTAL SQ. FT.	3801.00 S.F.	492.63 S.F.	12.96 %	
TOTAL SQ. M.	353.12 S.M.	45.77 S.M.	12.96 %	
UNINSULATED OPENINGS (PER OBC. SB-12,3.1.1(7))				
STANDARD & REAR UPGRADE W/ SIDE DOOR 9' GDN. FL.	S42-19 ELEVATION B -W.O.B.	ENERGY EFFICIENCY - OBC SB12		
	ELEVATION	WALL AREA S.F.	OPENING S.F.	PERCENTAGE
	FRONT	664 S.F.	125.53 S.F.	18.91 %
	LEFT SIDE	1106 S.F.	77.33 S.F.	6.99 %
	RIGHT SIDE	1106 S.F.	80.83 S.F.	7.31 %
	REAR	925 S.F.	218.44 S.F.	23.62 %
* OPENINGS OMITTED AS PER SB-12 3.1.1.9(4) MAX 19.9 S.F. REFER TO ELEVATION FOR LOCATION		0.00 S.F.		
TOTAL SQ. FT.	3801.00 S.F.	502.13 S.F.	13.21 %	
TOTAL SQ. M.	353.12 S.M.	46.65 S.M.	13.21 %	



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The undersigned has reviewed and takes responsibility for this design and has the qualifications and meets the requirements set out in the Ontario Building Code to be a Designer.
qualification information
Wellington Jno-Baptiste
signature
25591 BCIN
42658
name
registration information
VAS Design Inc.
Contractor must verify all dimensions on the job and report any discrepancy to the Designer before proceeding with the work. All drawings and specifications are instruments of service and the property of the Designer which must be returned at the completion of the work. Drawings are not to be scaled.

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3	REVISED AS PER ENG COMMENTS	MAR 03-22	RC						
2	REVISED AS PER FLOOR / ROOF LAYOUT	FEB 24-22	RC						
1	ISSUED FOR CLIENT REVIEW	NOV 26-21	VA3						
no.	description	date	by						

BAYVIEW WELLINGTON

S42-19

project no. 16023
drawing no. 33
municipality BRADFORD, ONTARIO
project name GREEN VALLEY EAST
date OCTOBER 2021
checked by JWM
drawn by TP
scale 3/16" = 1'-0"

UNINSULATED OPENINGS (PER OBC. SB-12,3.1.1(7))				
STANDARD 9' GDN. FL.	S42-19 ELEVATION C	ENERGY EFFICIENCY - OBC SB12		
	ELEVATION	WALL AREA S.F.	OPENING S.F.	PERCENTAGE
	FRONT	664 S.F.	182.31 S.F.	27.46 %
	LEFT SIDE	1106 S.F.	103.00 S.F.	9.31 %
	RIGHT SIDE	1106 S.F.	83.00 S.F.	7.50 %
	REAR	681 S.F.	143.05 S.F.	21.01 %
* OPENINGS OMITTED AS PER SB-12 3.1.1.9(4) MAX 19.9 S.F. REFER TO ELEVATION FOR LOCATION		0.00 S.F.		
TOTAL SQ. FT.	3557.00 S.F.	511.36 S.F.	14.38 %	
TOTAL SQ. M.	330.45 S.M.	47.51 S.M.	14.38 %	
UNINSULATED OPENINGS (PER OBC. SB-12,3.1.1(7))				
STANDARD W/ SIDE DOOR 9' GDN. FL.	S42-19 ELEVATION C	ENERGY EFFICIENCY - OBC SB12		
	ELEVATION	WALL AREA S.F.	OPENING S.F.	PERCENTAGE
	FRONT	664 S.F.	182.31 S.F.	27.46 %
	LEFT SIDE	1106 S.F.	103.00 S.F.	9.31 %
	RIGHT SIDE	1106 S.F.	92.50 S.F.	8.36 %
	REAR	681 S.F.	143.05 S.F.	21.01 %
* OPENINGS OMITTED AS PER SB-12 3.1.1.9(4) MAX 19.9 S.F. REFER TO ELEVATION FOR LOCATION		0.00 S.F.		
TOTAL SQ. FT.	3557.00 S.F.	520.86 S.F.	14.64 %	
TOTAL SQ. M.	330.45 S.M.	48.39 S.M.	14.64 %	

UNINSULATED OPENINGS (PER OBC. SB-12,3.1.1(7))				
STANDARD 9' GDN. FL.	S42-19 ELEVATION C -W.O.D.	ENERGY EFFICIENCY - OBC SB12		
	ELEVATION	WALL AREA S.F.	OPENING S.F.	PERCENTAGE
	FRONT	664 S.F.	182.31 S.F.	27.46 %
	LEFT SIDE	1106 S.F.	103.00 S.F.	9.31 %
	RIGHT SIDE	1106 S.F.	83.00 S.F.	7.50 %
	REAR	816 S.F.	165.28 S.F.	20.25 %
* OPENINGS OMITTED AS PER SB-12 3.1.1.9(4) MAX 19.9 S.F. REFER TO ELEVATION FOR LOCATION		0.00 S.F.		
TOTAL SQ. FT.	3692.00 S.F.	533.59 S.F.	14.45 %	
TOTAL SQ. M.	343.00 S.M.	49.57 S.M.	14.45 %	
UNINSULATED OPENINGS (PER OBC. SB-12,3.1.1(7))				
STANDARD W/ SIDE DOOR 9' GDN. FL.	S42-19 ELEVATION C -W.O.D.	ENERGY EFFICIENCY - OBC SB12		
	ELEVATION	WALL AREA S.F.	OPENING S.F.	PERCENTAGE
	FRONT	664 S.F.	182.31 S.F.	27.46 %
	LEFT SIDE	1106 S.F.	103.00 S.F.	9.31 %
	RIGHT SIDE	1106 S.F.	92.50 S.F.	8.36 %
	REAR	816 S.F.	165.28 S.F.	20.25 %
* OPENINGS OMITTED AS PER SB-12 3.1.1.9(4) MAX 19.9 S.F. REFER TO ELEVATION FOR LOCATION		0.00 S.F.		
TOTAL SQ. FT.	3692.00 S.F.	543.09 S.F.	14.71 %	
TOTAL SQ. M.	343.00 S.M.	50.45 S.M.	14.71 %	

UNINSULATED OPENINGS (PER OBC. SB-12,3.1.1(7))				
STANDARD 9' GDN. FL.	S42-19 ELEVATION C -W.O.B.	ENERGY EFFICIENCY - OBC SB12		
	ELEVATION	WALL AREA S.F.	OPENING S.F.	PERCENTAGE
	FRONT	664 S.F.	182.31 S.F.	27.46 %
	LEFT SIDE	1106 S.F.	103.00 S.F.	9.31 %
	RIGHT SIDE	1106 S.F.	83.00 S.F.	7.50 %
	REAR	925 S.F.	218.44 S.F.	23.62 %
* OPENINGS OMITTED AS PER SB-12 3.1.1.9(4) MAX 19.9 S.F. REFER TO ELEVATION FOR LOCATION		0.00 S.F.		
TOTAL SQ. FT.	3801.00 S.F.	586.75 S.F.	15.44 %	
TOTAL SQ. M.	353.12 S.M.	54.51 S.M.	15.44 %	
UNINSULATED OPENINGS (PER OBC. SB-12,3.1.1(7))				
STANDARD W/ SIDE DOOR 9' GDN. FL.	S42-19 ELEVATION C -W.O.B.	ENERGY EFFICIENCY - OBC SB12		
	ELEVATION	WALL AREA S.F.	OPENING S.F.	PERCENTAGE
	FRONT	664 S.F.	182.31 S.F.	27.46 %
	LEFT SIDE	1106 S.F.	103.00 S.F.	9.31 %
	RIGHT SIDE	1106 S.F.	92.50 S.F.	8.36 %
	REAR	925 S.F.	218.44 S.F.	23.62 %
* OPENINGS OMITTED AS PER SB-12 3.1.1.9(4) MAX 19.9 S.F. REFER TO ELEVATION FOR LOCATION		0.00 S.F.		
TOTAL SQ. FT.	3801.00 S.F.	596.25 S.F.	15.69 %	
TOTAL SQ. M.	353.12 S.M.	55.39 S.M.	15.69 %	

UNINSULATED OPENINGS (PER OBC. SB-12,3.1.1(7))				
REAR UPGRADE 9' GDN. FL.	S42-19 ELEVATION C	ENERGY EFFICIENCY - OBC SB12		
	ELEVATION	WALL AREA S.F.	OPENING S.F.	PERCENTAGE
	FRONT	664 S.F.	182.31 S.F.	27.46 %
	LEFT SIDE	1106 S.F.	103.00 S.F.	9.31 %
	RIGHT SIDE	1106 S.F.	83.00 S.F.	7.50 %
	REAR	681 S.F.	165.71 S.F.	24.33 %
* OPENINGS OMITTED AS PER SB-12 3.1.1.9(4) MAX 19.9 S.F. REFER TO ELEVATION FOR LOCATION		0.00 S.F.		
TOTAL SQ. FT.	3557.00 S.F.	534.02 S.F.	15.01 %	
TOTAL SQ. M.	330.45 S.M.	49.61 S.M.	15.01 %	
UNINSULATED OPENINGS (PER OBC. SB-12,3.1.1(7))				
REAR UPGRADE W/ SIDE DOOR 9' GDN. FL.	S42-19 ELEVATION C	ENERGY EFFICIENCY - OBC SB12		
	ELEVATION	WALL AREA S.F.	OPENING S.F.	PERCENTAGE
	FRONT	664 S.F.	182.31 S.F.	27.46 %
	LEFT SIDE	1106 S.F.	103.00 S.F.	9.31 %
	RIGHT SIDE	1106 S.F.	92.50 S.F.	8.36 %
	REAR	681 S.F.	165.71 S.F.	24.33 %
* OPENINGS OMITTED AS PER SB-12 3.1.1.9(4) MAX 19.9 S.F. REFER TO ELEVATION FOR LOCATION		0.00 S.F.		
TOTAL SQ. FT.	3557.00 S.F.	543.52 S.F.	15.28 %	
TOTAL SQ. M.	330.45 S.M.	50.49 S.M.	15.28 %	

UNINSULATED OPENINGS (PER OBC. SB-12,3.1.1(7))				
REAR UPGRADE 9' GDN. FL.	S42-19 ELEVATION C -W.O.D.	ENERGY EFFICIENCY - OBC SB12		
	ELEVATION	WALL AREA S.F.	OPENING S.F.	PERCENTAGE
	FRONT	664 S.F.	182.31 S.F.	27.46 %
	LEFT SIDE	1106 S.F.	103.00 S.F.	9.31 %
	RIGHT SIDE	1106 S.F.	83.00 S.F.	7.50 %
	REAR	816 S.F.	190.17 S.F.	23.31 %
* OPENINGS OMITTED AS PER SB-12 3.1.1.9(4) MAX 19.9 S.F. REFER TO ELEVATION FOR LOCATION		0.00 S.F.		
TOTAL SQ. FT.	3692.00 S.F.	558.48 S.F.	15.13 %	
TOTAL SQ. M.	343.00 S.M.	51.88 S.M.	15.13 %	
UNINSULATED OPENINGS (PER OBC. SB-12,3.1.1(7))				
REAR UPGRADE W/ SIDE DOOR 9' GDN. FL.	S42-19 ELEVATION C -W.O.D.	ENERGY EFFICIENCY - OBC SB12		
	ELEVATION	WALL AREA S.F.	OPENING S.F.	PERCENTAGE
	FRONT	664 S.F.	182.31 S.F.	27.46 %
	LEFT SIDE	1106 S.F.	103.00 S.F.	9.31 %
	RIGHT SIDE	1106 S.F.	92.50 S.F.	8.36 %
	REAR	816 S.F.	190.17 S.F.	23.31 %
* OPENINGS OMITTED AS PER SB-12 3.1.1.9(4) MAX 19.9 S.F. REFER TO ELEVATION FOR LOCATION		0.00 S.F.		
TOTAL SQ. FT.	3692.00 S.F.	567.98 S.F.	15.38 %	
TOTAL SQ. M.	343.00 S.M.	52.77 S.M.	15.38 %	

UNINSULATED OPENINGS (PER OBC. SB-12,3.1.1(7))				
REAR UPGRADE 9' GDN. FL.	S42-19 ELEVATION C -W.O.B.	ENERGY EFFICIENCY - OBC SB12		
	ELEVATION	WALL AREA S.F.	OPENING S.F.	PERCENTAGE
	FRONT	664 S.F.	182.31 S.F.	27.46 %
	LEFT SIDE	1106 S.F.	103.00 S.F.	9.31 %
	RIGHT SIDE	1106 S.F.	83.00 S.F.	7.50 %
	REAR	925 S.F.	244.44 S.F.	26.43 %
* OPENINGS OMITTED AS PER SB-12 3.1.1.9(4) MAX 19.9 S.F. REFER TO ELEVATION FOR LOCATION		0.00 S.F.		
TOTAL SQ. FT.	3801.00 S.F.	612.75 S.F.	16.12 %	
TOTAL SQ. M.	353.12 S.M.	56.93 S.M.	16.12 %	
UNINSULATED OPENINGS (PER OBC. SB-12,3.1.1(7))				
REAR UPGRADE W/ SIDE DOOR 9' GDN. FL.	S42-19 ELEVATION C -W.O.B.	ENERGY EFFICIENCY - OBC SB12		
	ELEVATION	WALL AREA S.F.	OPENING S.F.	PERCENTAGE
	FRONT	664 S.F.	182.31 S.F.	27.46 %
	LEFT SIDE	1106 S.F.	103.00 S.F.	9.31 %
	RIGHT SIDE	1106 S.F.	92.50 S.F.	8.36 %
	REAR	925 S.F.	244.44 S.F.	26.43 %
* OPENINGS OMITTED AS PER SB-12 3.1.1.9(4) MAX 19.9 S.F. REFER TO ELEVATION FOR LOCATION		0.00 S.F.		
TOTAL SQ. FT.	3801.00 S.F.	622.25 S.F.	16.37 %	
TOTAL SQ. M.	353.12 S.M.	57.81 S.M.	16.37 %	



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t 416.630.2255 f 416.630.4782
vasdesign.com

The undersigned has reviewed and takes responsibility for this design and has the qualifications and meets the requirements set out in the Ontario Building Code to be a Designer.
 qualification information
 name Wellington Jno-Baptiste
 registration information 25591 BCIN
 VAS Design Inc. 42658
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3	REVISED AS PER ENG COMMENTS	MAR 03-22	RC						
2	REVISED AS PER FLOOR / ROOF LAYOUT	FEB 24-22	RC						
1	ISSUED FOR CLIENT REVIEW	NOV 26-21	VA3						
no.	description	date	by						

BAYVIEW WELLINGTON
S42-19
 GREEN VALLEY EAST
 BRADFORD, ONTARIO
 project name
 project no. 16023
 drawing no. 34
 SB-12 CHARTS
 file name 16023-S42-19
 checked by JWM
 date OCTOBER 2021
 scale 3/16" = 1'-0"
 drawn by TP
 RICHARD - H:\ARCHIVE\WORKING\2016\16023\BW Units\42\16023-S42-19.dwg - Tue - Mar 8 2022 - 1:01 PM

UNINSULATED OPENINGS (PER OBC. SB-12,3.1.1(7))				
STANDARD & REAR UPGRADE 9' GDN. FL. & 9' BASEMENT	S42-19 ELEVATION A -W.O.B.	ENERGY EFFICIENCY - OBC SB12		
	ELEVATION	WALL AREA S.F.	OPENING S.F.	PERCENTAGE
	FRONT	664 S.F.	134.86 S.F.	20.31 %
	LEFT SIDE	1106 S.F.	77.33 S.F.	6.99 %
	RIGHT SIDE	1106 S.F.	71.33 S.F.	6.45 %
	REAR	959 S.F.	218.44 S.F.	22.78 %
	* OPENINGS OMITTED AS PER SB-12 3.1.1.9(4) MAX 19.9 S.F. REFER TO ELEVATION FOR LOCATION		0.00 S.F.	
TOTAL SQ. FT.	3835.00 S.F.	501.96 S.F.	13.09 %	
TOTAL SQ. M.	356.28 S.M.	46.63 S.M.	13.09 %	
UNINSULATED OPENINGS (PER OBC. SB-12,3.1.1(7))				
STANDARD & REAR UPGRADE W/ SIDE DOOR 9' GDN. FL. & 9' BASEMENT	S42-19 ELEVATION A -W.O.B.	ENERGY EFFICIENCY - OBC SB12		
	ELEVATION	WALL AREA S.F.	OPENING S.F.	PERCENTAGE
	FRONT	664 S.F.	134.86 S.F.	20.31 %
	LEFT SIDE	1106 S.F.	77.33 S.F.	6.99 %
	RIGHT SIDE	1106 S.F.	80.83 S.F.	7.31 %
	REAR	959 S.F.	218.44 S.F.	22.78 %
	* OPENINGS OMITTED AS PER SB-12 3.1.1.9(4) MAX 19.9 S.F. REFER TO ELEVATION FOR LOCATION		0.00 S.F.	
TOTAL SQ. FT.	3835.00 S.F.	511.46 S.F.	13.34 %	
TOTAL SQ. M.	356.28 S.M.	47.52 S.M.	13.34 %	

UNINSULATED OPENINGS (PER OBC. SB-12,3.1.1(7))				
STANDARD & REAR UPGRADE 9' GDN. FL. & 9' BASEMENT	S42-19 ELEVATION B -W.O.B.	ENERGY EFFICIENCY - OBC SB12		
	ELEVATION	WALL AREA S.F.	OPENING S.F.	PERCENTAGE
	FRONT	664 S.F.	125.53 S.F.	18.91 %
	LEFT SIDE	1106 S.F.	77.33 S.F.	6.99 %
	RIGHT SIDE	1106 S.F.	71.33 S.F.	6.45 %
	REAR	959 S.F.	218.44 S.F.	22.78 %
	* OPENINGS OMITTED AS PER SB-12 3.1.1.9(4) MAX 19.9 S.F. REFER TO ELEVATION FOR LOCATION		0.00 S.F.	
TOTAL SQ. FT.	3835.00 S.F.	492.63 S.F.	12.85 %	
TOTAL SQ. M.	356.28 S.M.	45.77 S.M.	12.85 %	
UNINSULATED OPENINGS (PER OBC. SB-12,3.1.1(7))				
STANDARD & REAR UPGRADE W/ SIDE DOOR 9' GDN. FL. & 9' BASEMENT	S42-19 ELEVATION B -W.O.B.	ENERGY EFFICIENCY - OBC SB12		
	ELEVATION	WALL AREA S.F.	OPENING S.F.	PERCENTAGE
	FRONT	664 S.F.	125.53 S.F.	18.91 %
	LEFT SIDE	1106 S.F.	77.33 S.F.	6.99 %
	RIGHT SIDE	1106 S.F.	80.83 S.F.	7.31 %
	REAR	959 S.F.	218.44 S.F.	22.78 %
	* OPENINGS OMITTED AS PER SB-12 3.1.1.9(4) MAX 19.9 S.F. REFER TO ELEVATION FOR LOCATION		0.00 S.F.	
TOTAL SQ. FT.	3835.00 S.F.	502.13 S.F.	13.09 %	
TOTAL SQ. M.	356.28 S.M.	46.65 S.M.	13.09 %	

UNINSULATED OPENINGS (PER OBC. SB-12,3.1.1(7))				
STANDARD 9' GDN. FL. & 9' BASEMENT	S42-19 ELEVATION C -W.O.B.	ENERGY EFFICIENCY - OBC SB12		
	ELEVATION	WALL AREA S.F.	OPENING S.F.	PERCENTAGE
	FRONT	664 S.F.	182.31 S.F.	27.46 %
	LEFT SIDE	1106 S.F.	103.00 S.F.	9.31 %
	RIGHT SIDE	1106 S.F.	83.00 S.F.	7.50 %
	REAR	959 S.F.	218.44 S.F.	22.78 %
	* OPENINGS OMITTED AS PER SB-12 3.1.1.9(4) MAX 19.9 S.F. REFER TO ELEVATION FOR LOCATION		0.00 S.F.	
TOTAL SQ. FT.	3835.00 S.F.	586.75 S.F.	15.30 %	
TOTAL SQ. M.	356.28 S.M.	54.51 S.M.	15.30 %	
UNINSULATED OPENINGS (PER OBC. SB-12,3.1.1(7))				
STANDARD W/ SIDE DOOR 9' GDN. FL. & 9' BASEMENT	S42-19 ELEVATION C -W.O.B.	ENERGY EFFICIENCY - OBC SB12		
	ELEVATION	WALL AREA S.F.	OPENING S.F.	PERCENTAGE
	FRONT	664 S.F.	182.31 S.F.	27.46 %
	LEFT SIDE	1106 S.F.	103.00 S.F.	9.31 %
	RIGHT SIDE	1106 S.F.	92.50 S.F.	8.36 %
	REAR	959 S.F.	218.44 S.F.	22.78 %
	* OPENINGS OMITTED AS PER SB-12 3.1.1.9(4) MAX 19.9 S.F. REFER TO ELEVATION FOR LOCATION		0.00 S.F.	
TOTAL SQ. FT.	3835.00 S.F.	596.25 S.F.	15.55 %	
TOTAL SQ. M.	356.28 S.M.	55.39 S.M.	15.55 %	

UNINSULATED OPENINGS (PER OBC. SB-12,3.1.1(7))				
REAR UPGRADE 9' GDN. FL. & 9' BASEMENT	S42-19 ELEVATION C -W.O.B.	ENERGY EFFICIENCY - OBC SB12		
	ELEVATION	WALL AREA S.F.	OPENING S.F.	PERCENTAGE
	FRONT	664 S.F.	182.31 S.F.	27.46 %
	LEFT SIDE	1106 S.F.	103.00 S.F.	9.31 %
	RIGHT SIDE	1106 S.F.	83.00 S.F.	7.50 %
	REAR	959 S.F.	244.44 S.F.	25.49 %
	* OPENINGS OMITTED AS PER SB-12 3.1.1.9(4) MAX 19.9 S.F. REFER TO ELEVATION FOR LOCATION		0.00 S.F.	
TOTAL SQ. FT.	3835.00 S.F.	612.75 S.F.	15.98 %	
TOTAL SQ. M.	356.28 S.M.	56.93 S.M.	15.98 %	
UNINSULATED OPENINGS (PER OBC. SB-12,3.1.1(7))				
REAR UPGRADE W/ SIDE DOOR 9' GDN. FL. & 9' BASEMENT	S42-19 ELEVATION C -W.O.B.	ENERGY EFFICIENCY - OBC SB12		
	ELEVATION	WALL AREA S.F.	OPENING S.F.	PERCENTAGE
	FRONT	664 S.F.	182.31 S.F.	27.46 %
	LEFT SIDE	1106 S.F.	103.00 S.F.	9.31 %
	RIGHT SIDE	1106 S.F.	92.50 S.F.	8.36 %
	REAR	959 S.F.	244.44 S.F.	25.49 %
	* OPENINGS OMITTED AS PER SB-12 3.1.1.9(4) MAX 19.9 S.F. REFER TO ELEVATION FOR LOCATION		0.00 S.F.	
TOTAL SQ. FT.	3835.00 S.F.	622.25 S.F.	16.23 %	
TOTAL SQ. M.	356.28 S.M.	57.81 S.M.	16.23 %	



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4									
3	REVISED AS PER ENG COMMENTS	MAR 03-22	RC						
2	REVISED AS PER FLOOR / ROOF LAYOUT	FEB 24-22	RC						
1	ISSUED FOR CLIENT REVIEW	NOV 26-21	VA3						
no.	description	date	by						

The undersigned has reviewed and takes responsibility for this design and has the qualifications and meets the requirements set out in the Ontario Building Code to be a Designer.

qualification information
 Wellington Jno-Baptiste
 name
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 BCIN 42658

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project no. 16023
 drawing no. 35


project name GREEN VALLEY EAST
 municipality BRADFORD, ONTARIO

file name 16023-S42-19


checked by JWM
 scale 3/16" = 1'-0"
 date OCTOBER 2021
 drawn by TP

RICHARD - H:\ARCHIVE\WORKING\2016\16023\16023-S42-19.dwg - Tue - Mar 8 2022 - 1:01 PM


BAYVIEW WELLINGTON
 S42-19

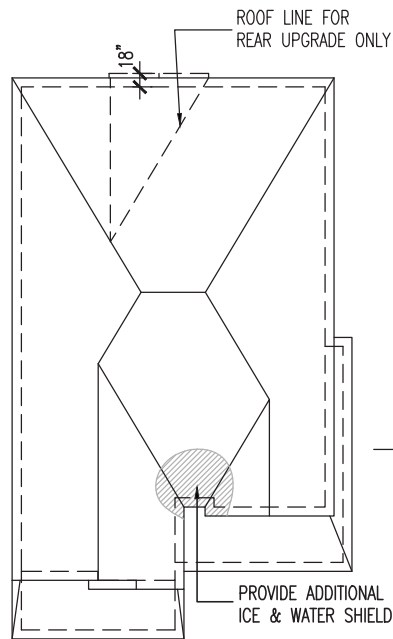

ROOF PLAN 'A'
N.T.S.

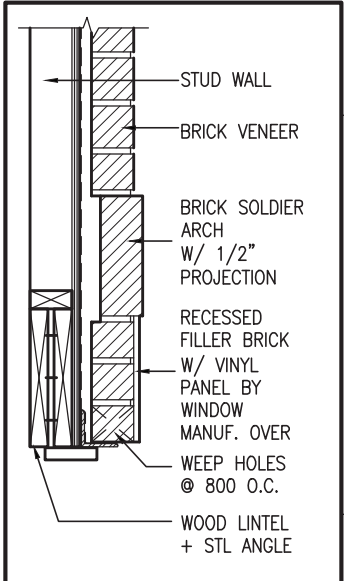

Y BRICK ARCH W/ VINYL PANEL BELOW DETAIL
N.T.S.

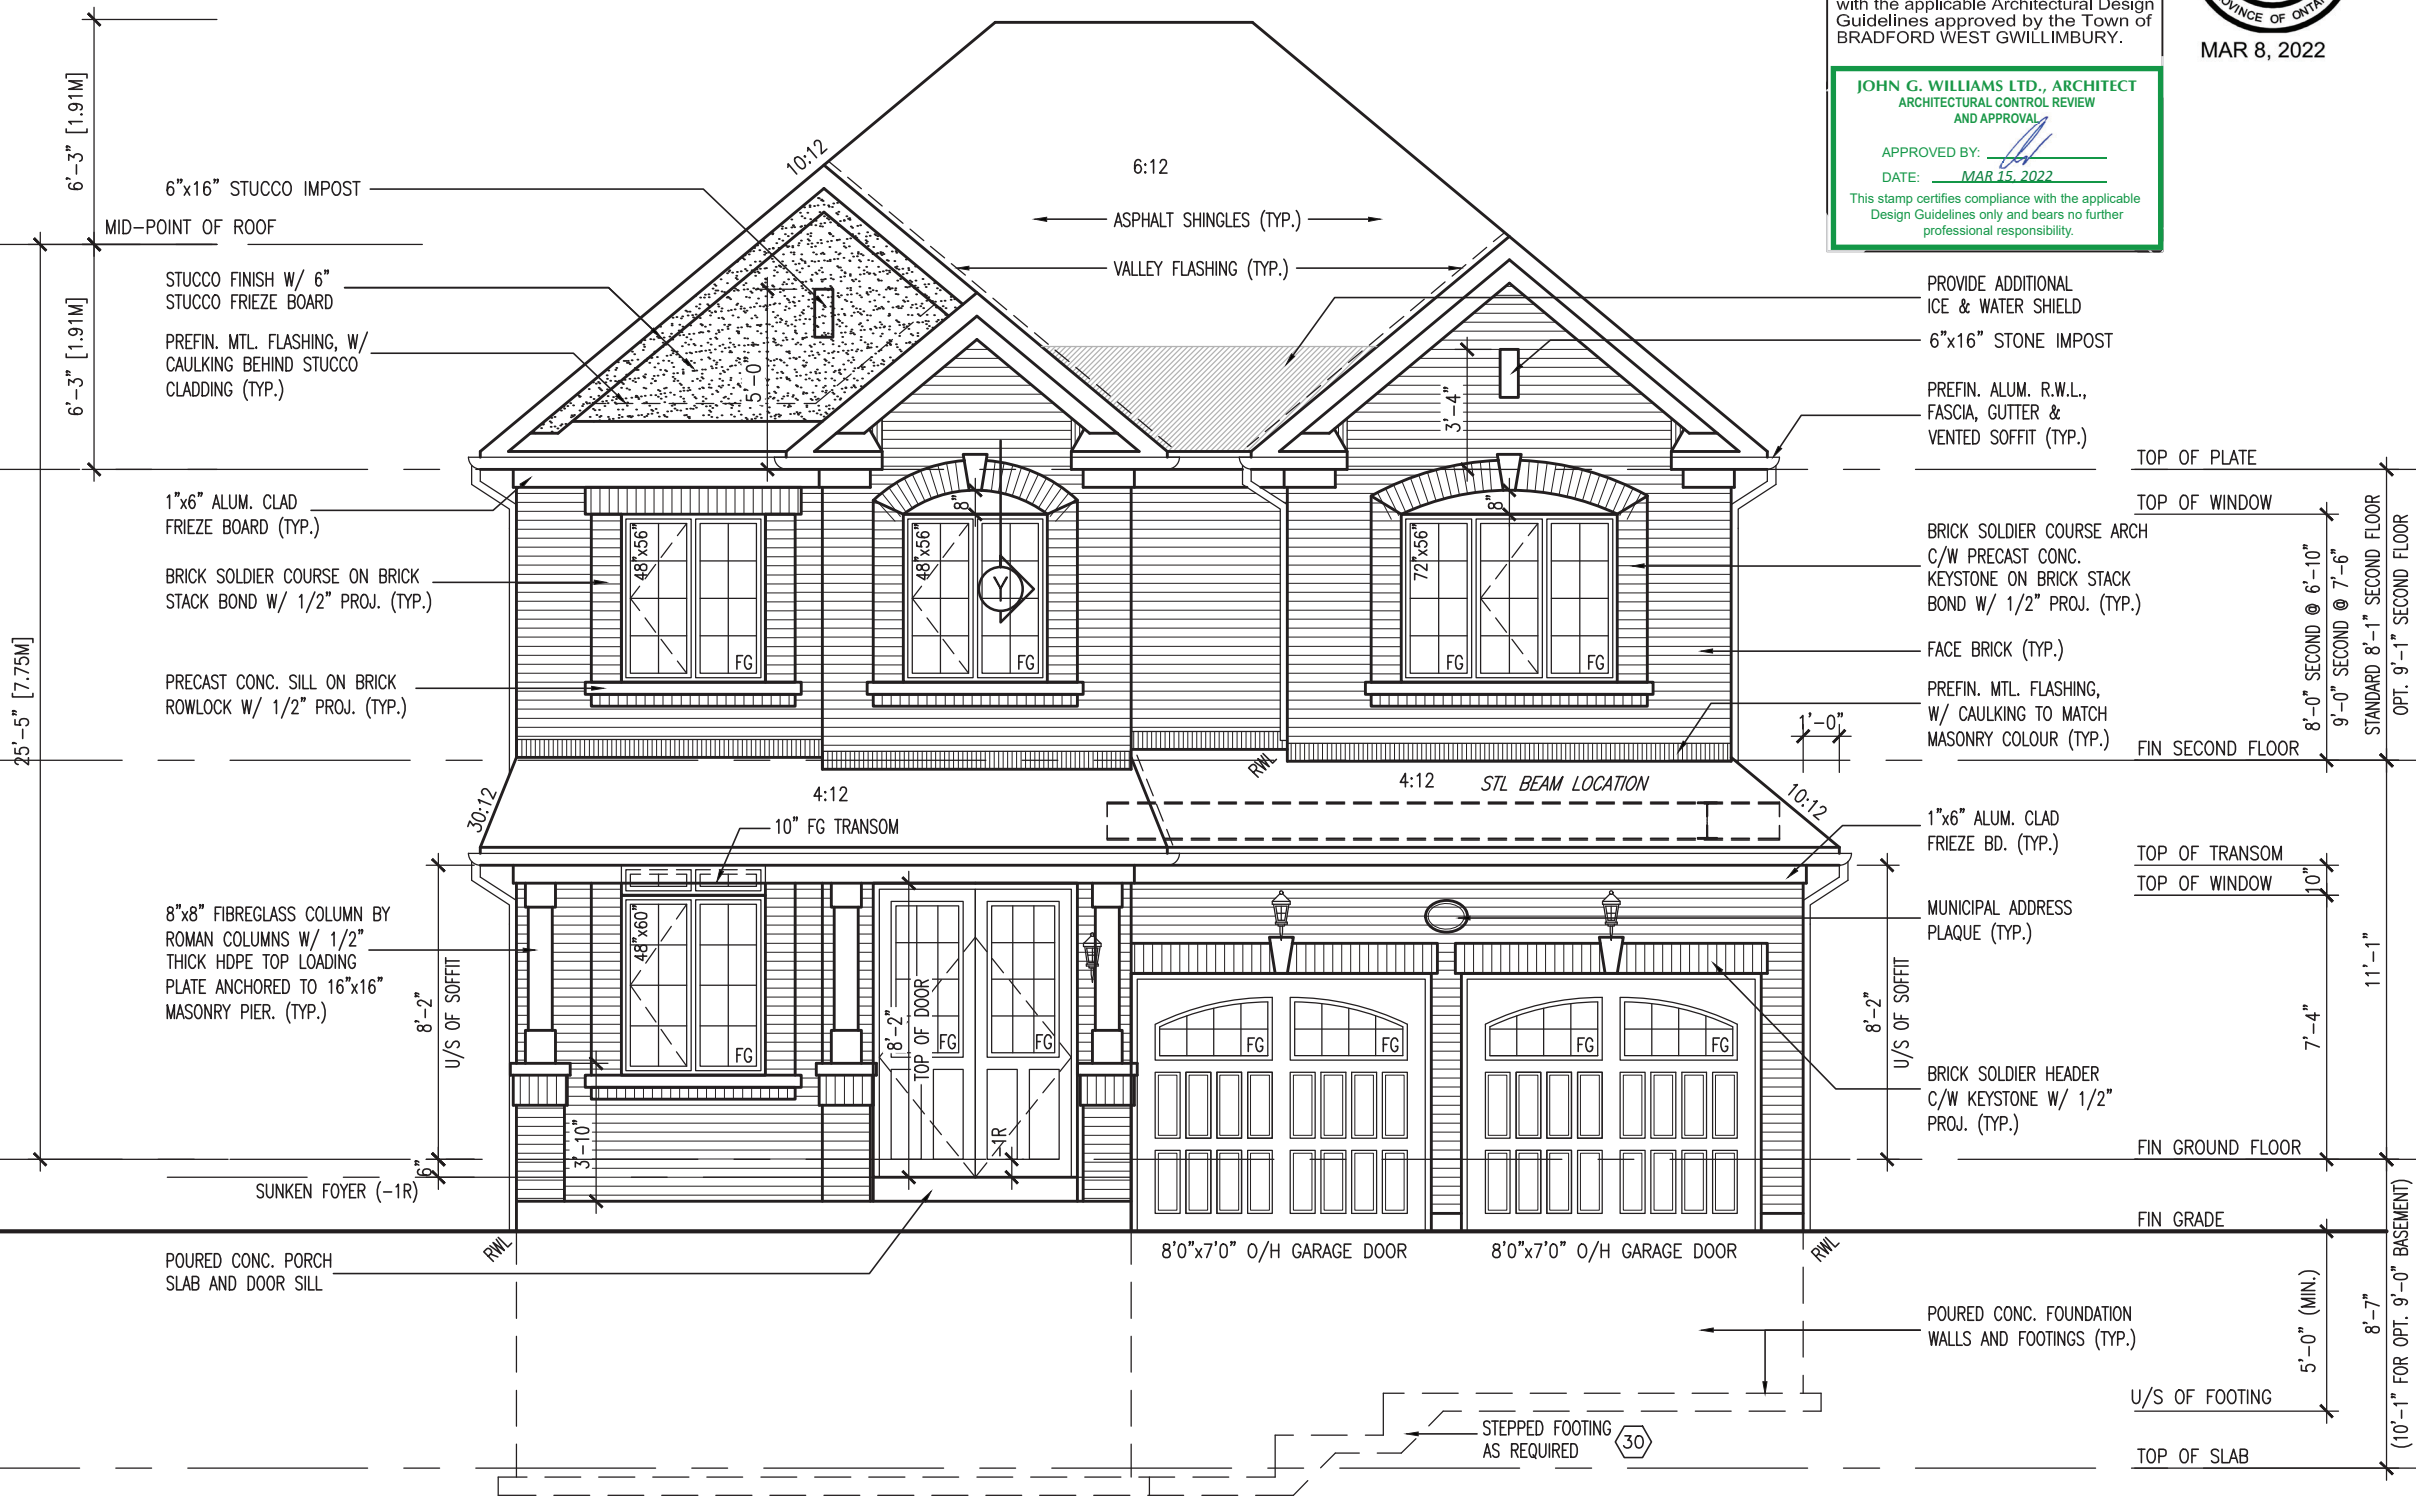

FRONT ELEVATION 'A'

10' GROUND

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This is to certify that these plans comply with the applicable Architectural Guidelines approved by the Town of BRADFORD WEST GWILLIMBURY.

JOHN G. WILLIAMS LTD., ARCHITECT
ARCHITECTURAL CONTROL REVIEW AND APPROVAL

APPROVED BY:

DATE: MAR 15, 2022

This stamp certifies compliance with the applicable Design Guidelines only and bears no further professional responsibility.



project no.	16023
drawing no.	36
file name	16023-S42-19
checked by	JWM
scale	3/16" = 1'-0"
drawn by	TP
date	OCTOBER 2021
municipality	BRADFORD, ONTARIO
project name	BAYVIEW WELLINGTON
project no.	S42-19
front elevation	FRONT ELEVATION 'A'


VAS DESIGN

255 Consumers Rd, Suite 120
Toronto, ON M2J 1R4
t 416.630.2255 f 416.630.4782
vasdesign.com

name	Wellington Jno-Baptiste	BCIN	25591
registration information	VAS Design Inc.	BCIN	42658
name	MAR 03-22	RC	
revised as per eng comments	FEB 24-22	RC	
revised as per floor / roof layout	NOV 26-21	VAS	
issued for client review			
no.	description	date	by

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R.W.L. AS REQUIRED & AS PER MUNICIPALITY

NOTE: REFER TO FRONT ELEVATION FOR TYPICAL NOTE INFORMATION
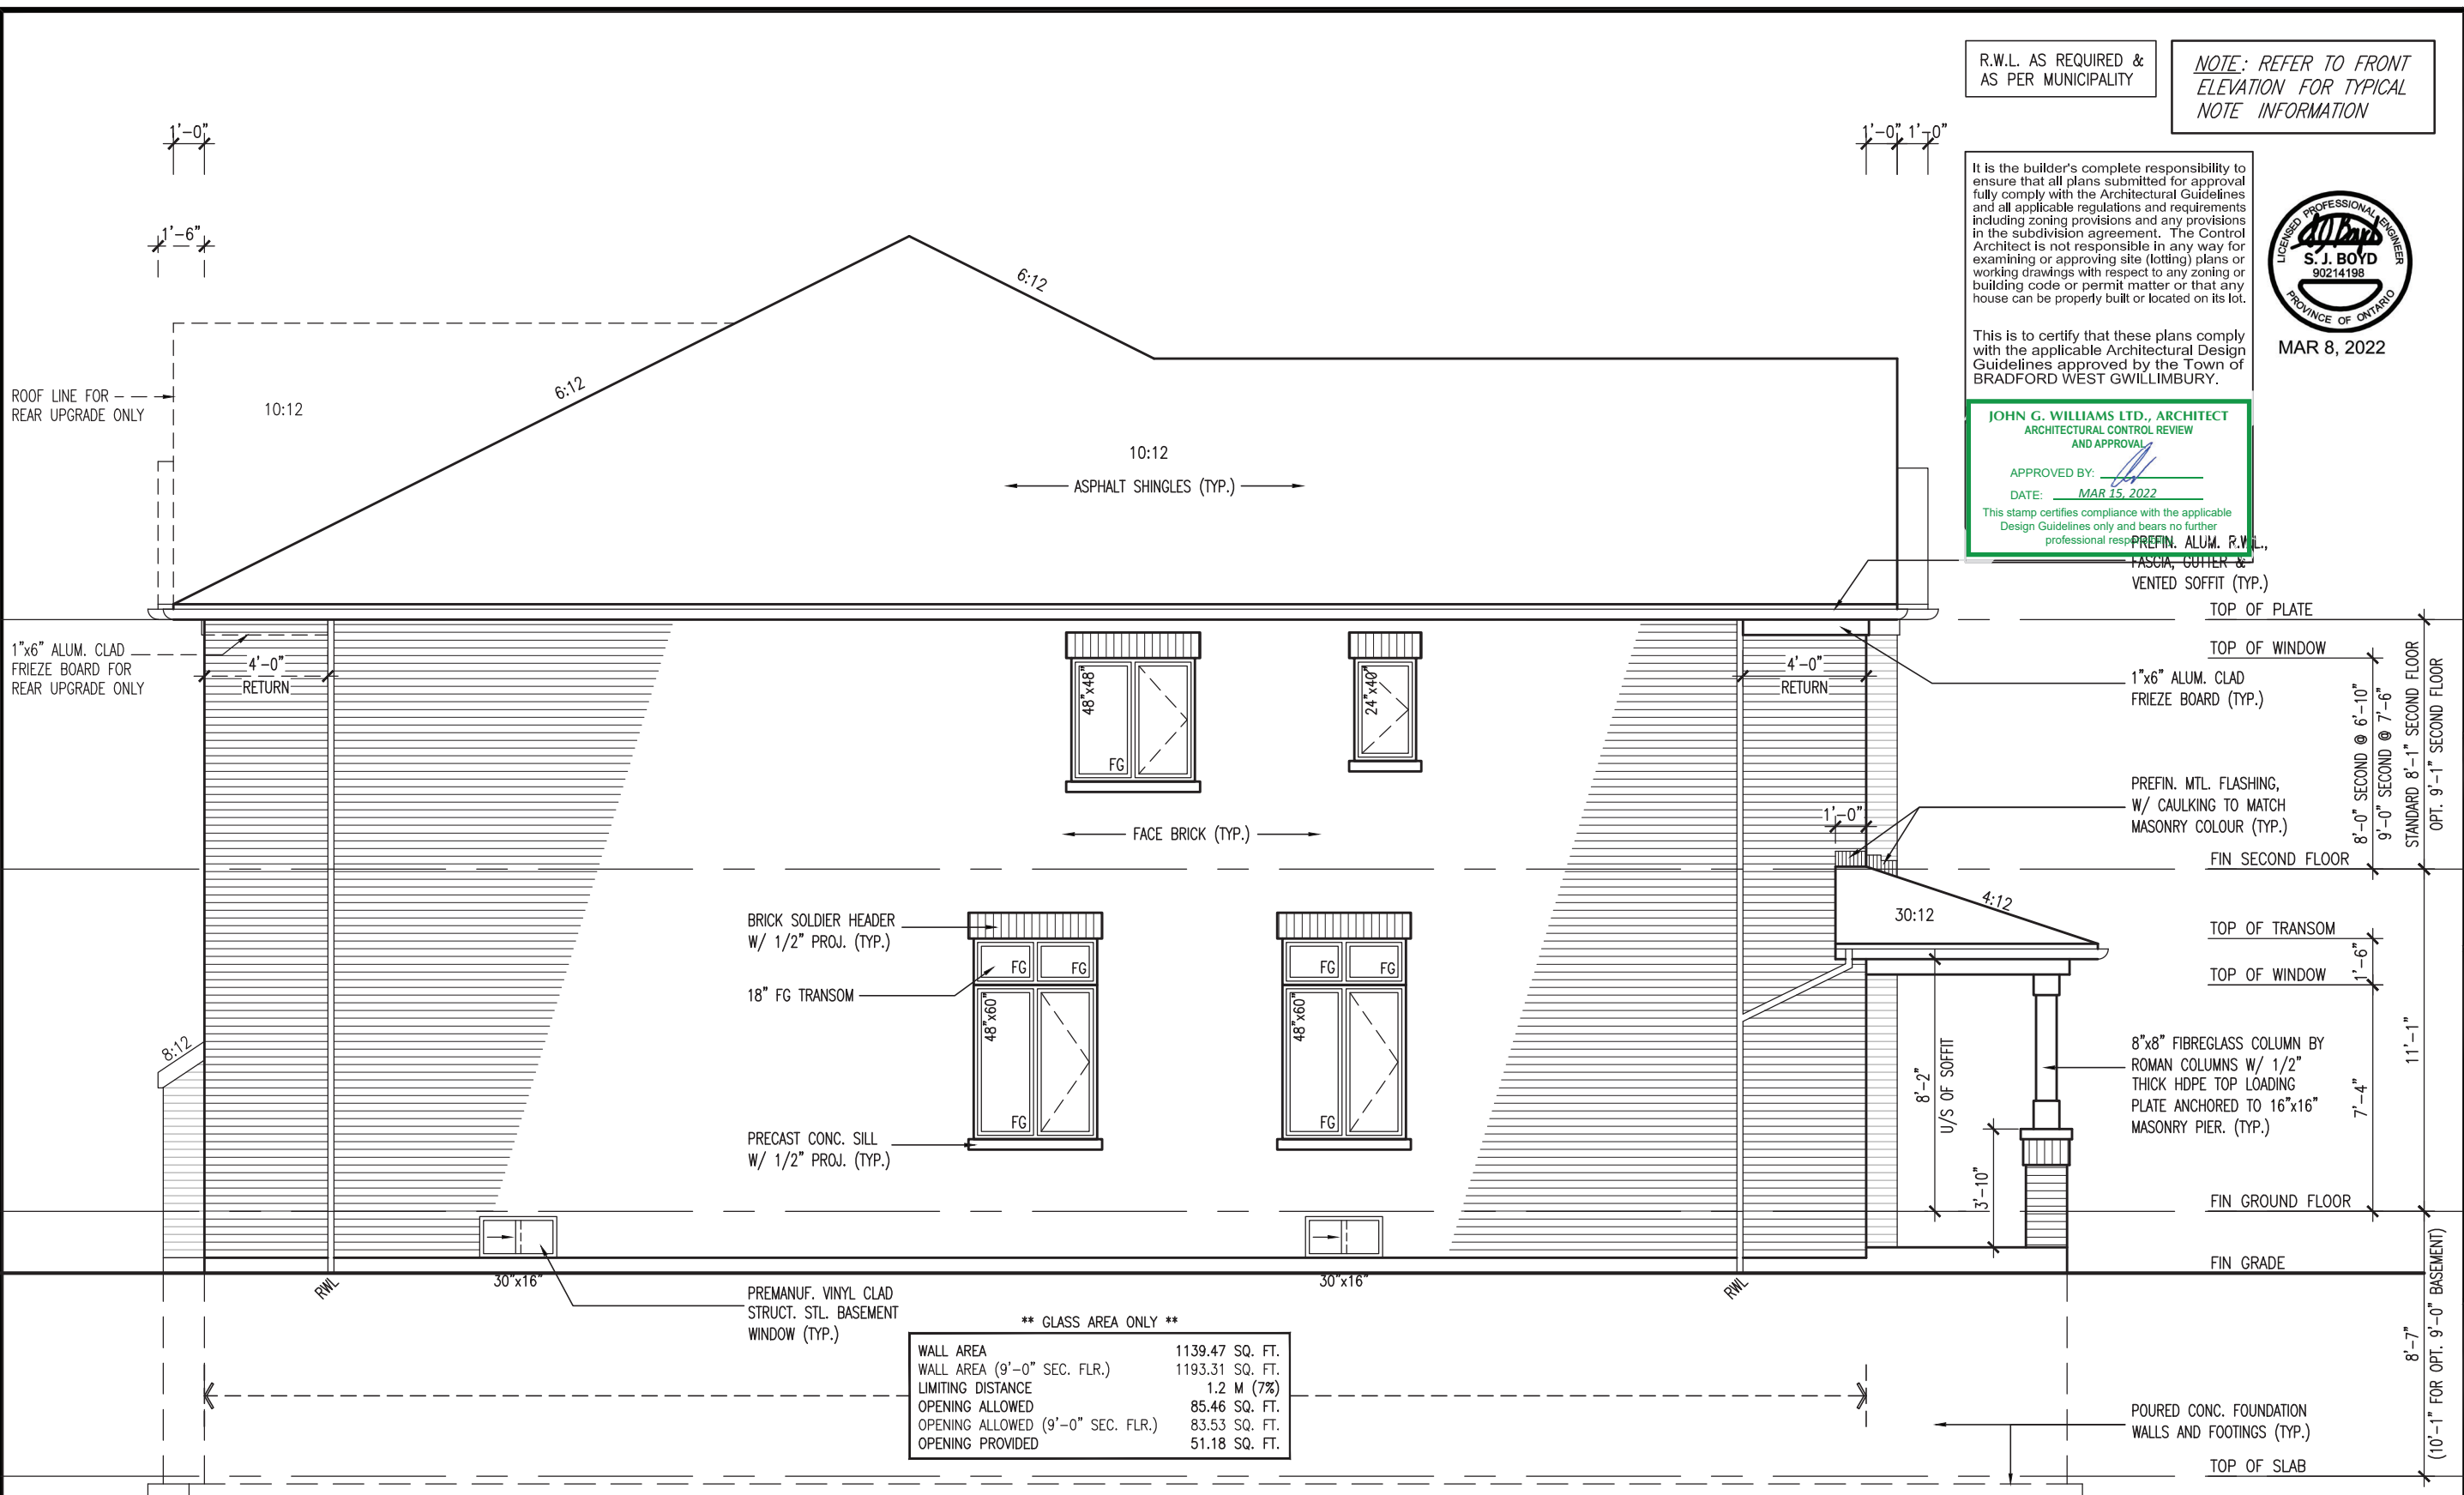
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JOHN G. WILLIAMS LTD., ARCHITECT
ARCHITECTURAL CONTROL REVIEW AND APPROVAL

APPROVED BY: _____
DATE: MAR 15, 2022

This stamp certifies compliance with the applicable Design Guidelines only and bears no further professional responsibility.



project no. 16023
drawing no. 37

project name BAYVIEW WELLINGTON
municipality BRADFORD, ONTARIO

project name GREEN VALLEY EAST
municipality BRADFORD, ONTARIO

LEFT SIDE ELEVATION 'A'

checked by JMW
scale 3/16" = 1'-0"

date OCTOBER 2021
drawn by TP

file name 16023-S42-19
RICHARD - H:\ARCHIVE\WORKING\2016\16023.BW\Units\42\16023-S42-19.dwg - Tue - Mar 8 2022 - 1:01 PM

VAS DESIGN
255 Consumers Rd, Suite 120
Toronto, ON M2J 1R4
t 416.630.2255 f 416.630.4782
vasdesign.com

The undersigned has reviewed and takes responsibility for this design and has the qualifications and meets the requirements set out in the Ontario Building Code to be a Designer.

Wellington, Jno-Baptiste
name Jno-Baptiste
registration information VAS Design Inc.
BCIN 25591
BCIN 42658

Contractor must verify all dimensions on the job and report any discrepancy to the Designer before proceeding with the work. All drawings and specifications are instruments of service and the property of the Designer which must be returned at the completion of the work. Drawings are not to be scaled.

**** GLASS AREA ONLY ****

WALL AREA	1139.47 SQ. FT.
WALL AREA (9'-0" SEC. FLR.)	1193.31 SQ. FT.
LIMITING DISTANCE	1.2 M (7%)
OPENING ALLOWED	85.46 SQ. FT.
OPENING ALLOWED (9'-0" SEC. FLR.)	83.53 SQ. FT.
OPENING PROVIDED	51.18 SQ. FT.

10' GROUND

LEFT SIDE ELEVATION 'A'


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3	REVISED AS PER ENG COMMENTS	MAR 03-22	RC		
2	REVISED AS PER FLOOR / ROOF LAYOUT	FEB 24-22	RC		
1	ISSUED FOR CLIENT REVIEW	NOV 26-21	VAS		
no.	description	date	by		

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JOHN G. WILLIAMS LTD., ARCHITECT
ARCHITECTURAL CONTROL REVIEW AND APPROVAL


APPROVED BY: 
DATE: MAR 15, 2022

This stamp certifies compliance with the applicable Design Guidelines only and bears no further professional responsibility.

BRICK VENEER CONSTRUCTION
(FOR WALLS LESS THAN 1.2M (3'-11") FROM THE LOT LINE)
45 MINUTE FIRE RATED WALL
PROVIDE A CONTINUOUS LAYER OF 12.7mm (1/2") TYPE 'X' GYPSUM BOARD (INTERIOR SIDE) INSTALLED SO THAT ALL EDGES ARE SUPPORTED, TAPED AND FILLED. SPACE BETWEEN WOOD STUDS TO BE FILLED WITH INSULATION CONFORMING TO CAN/ULC-S702, "MINERAL FIBRE THERMAL INSULATION FOR BUILDINGS" WITH A MASS OF NOT LESS THAN 1.22 Kg/SQ.M. AND MUST FILL AT LEAST 90% OF THE CAVITY THICKNESS. THE TYPE 'X' & INSULATION MUST BE RUN CONTINUOUSLY BEHIND ALL INTERSECTING PARTITIONS, MECHANICAL CHASES, BATHTUBS, SHOWERS, ETC. ENSURE INSULATION & TYPE 'X' IS INSTALLED IN GARAGE EXTERIOR WALLS. (REFER TO SECTION SB-2 OF OBC 2012-SUPPLEMENTARY STANDARDS)

R.W.L. AS REQUIRED & AS PER MUNICIPALITY

NOTE: REFER TO FRONT ELEVATION FOR TYPICAL NOTE INFORMATION

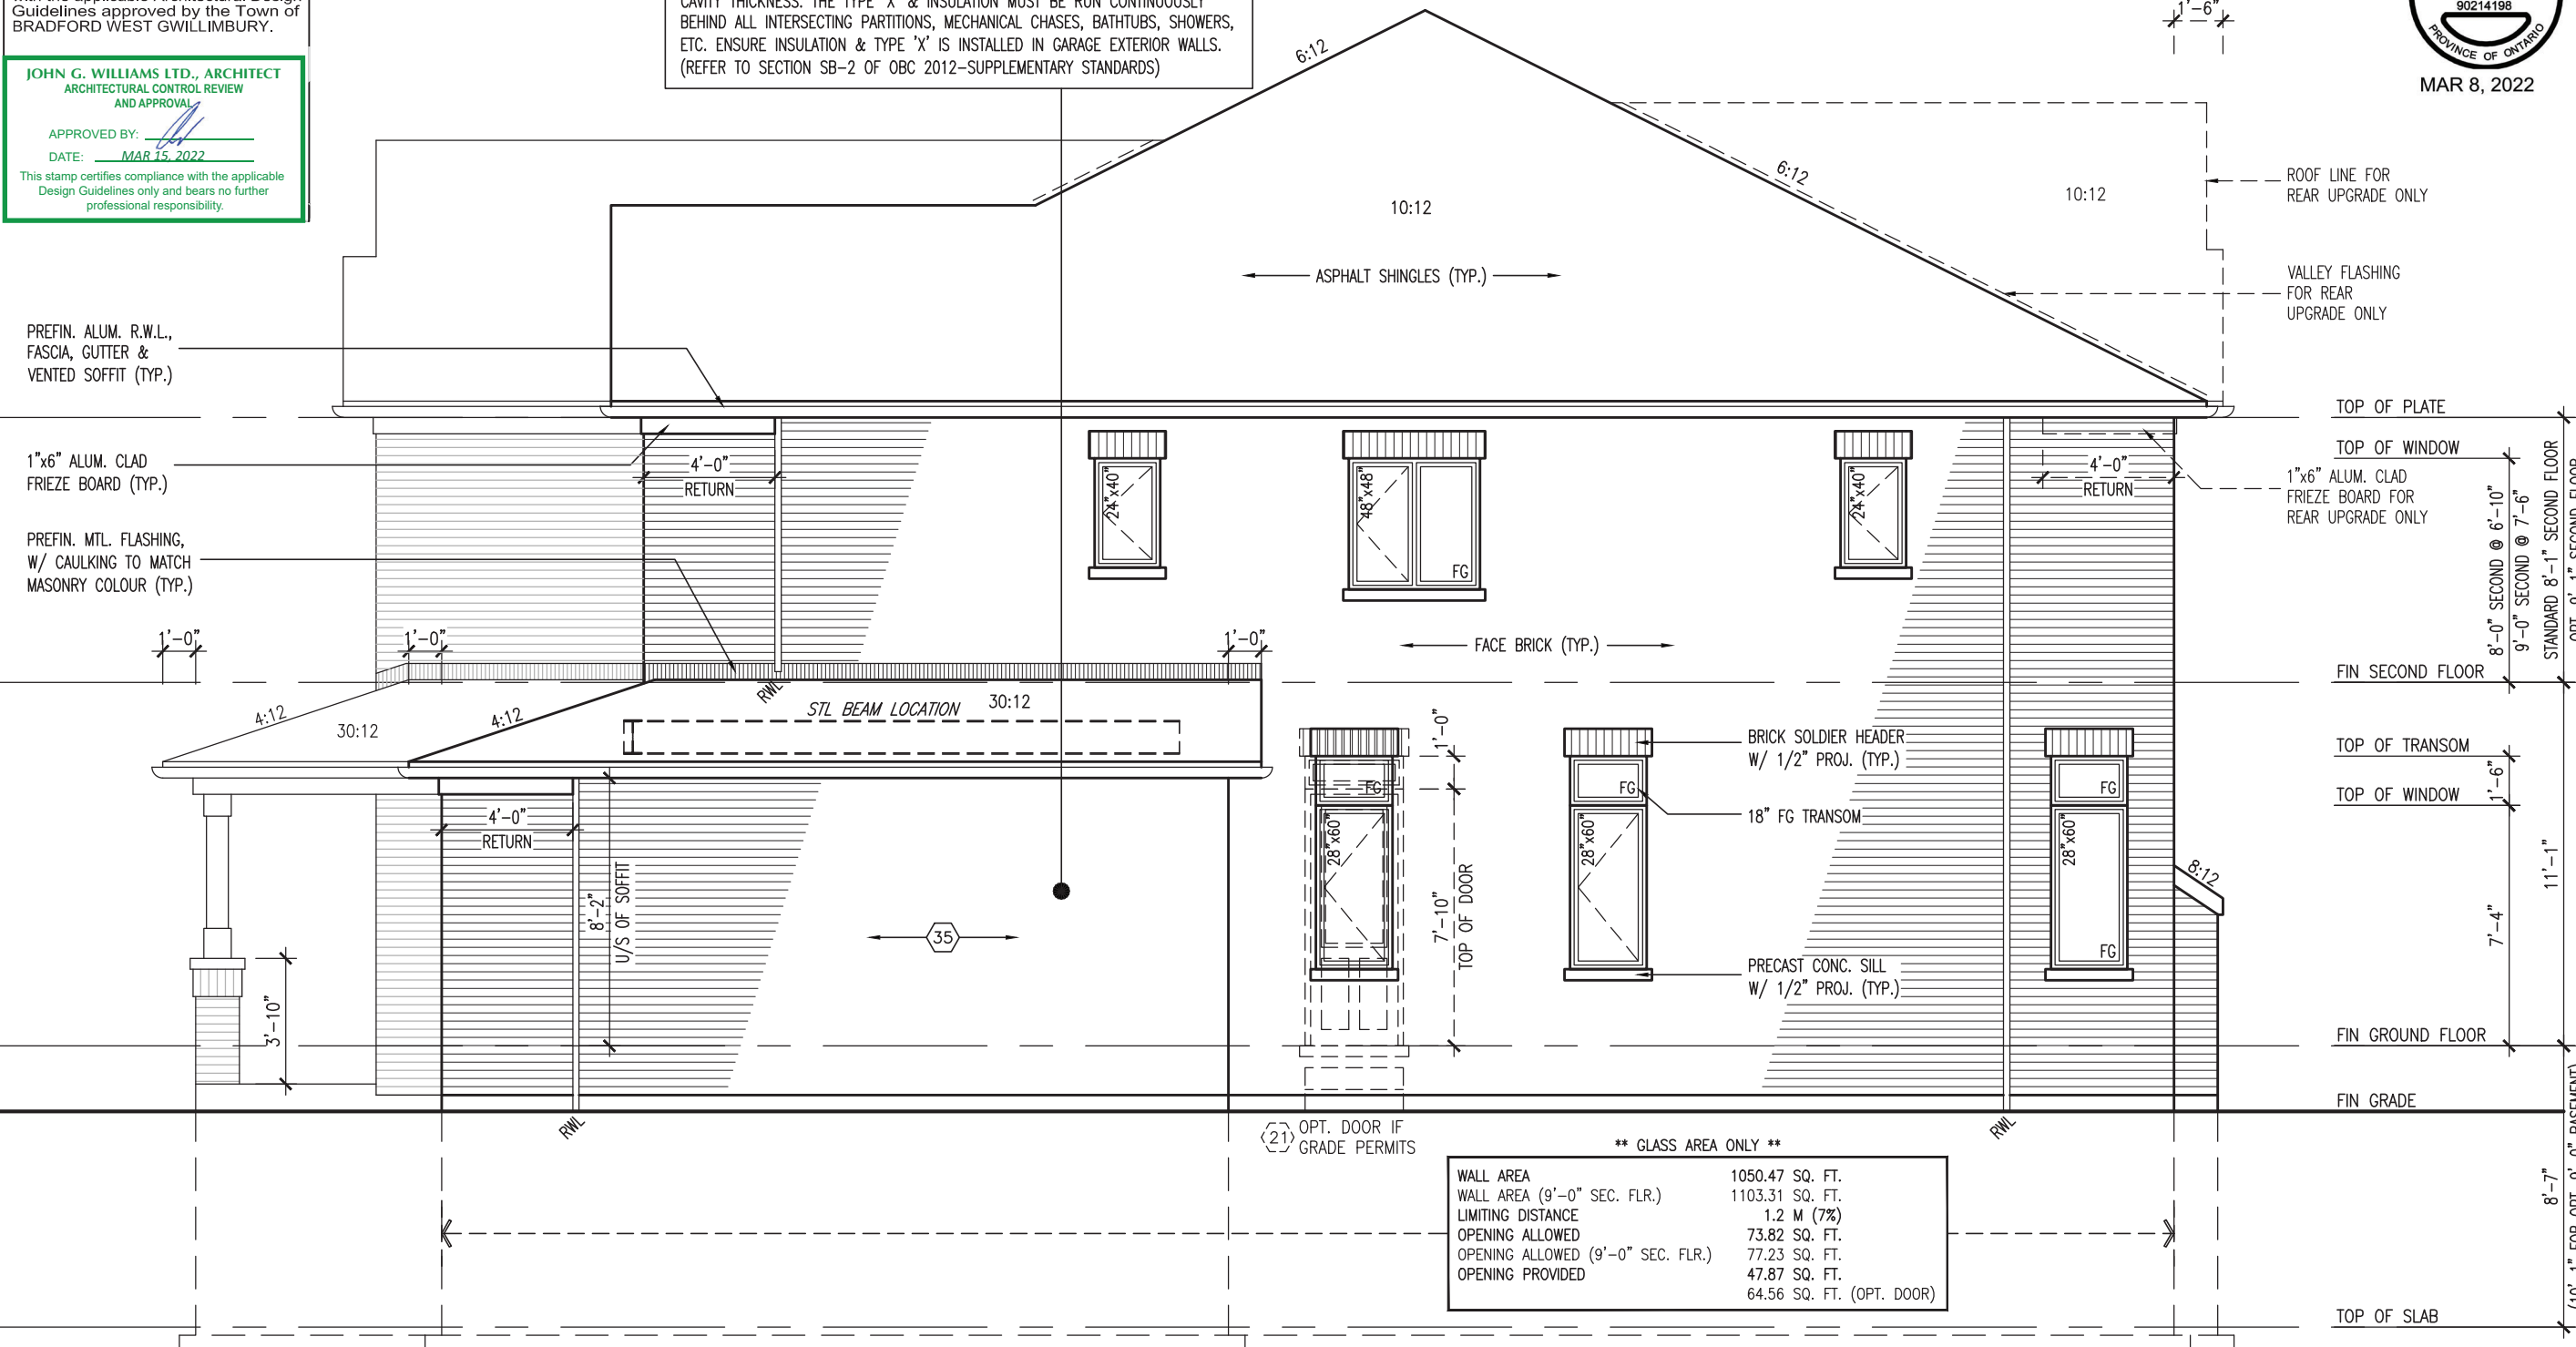

**** GLASS AREA ONLY ****

WALL AREA	1050.47 SQ. FT.
WALL AREA (9'-0" SEC. FLR.)	1103.31 SQ. FT.
LIMITING DISTANCE	1.2 M (7%)
OPENING ALLOWED	73.82 SQ. FT.
OPENING ALLOWED (9'-0" SEC. FLR.)	77.23 SQ. FT.
OPENING PROVIDED	47.87 SQ. FT.
	64.56 SQ. FT. (OPT. DOOR)

10' GROUND

RIGHT SIDE ELEVATION 'A'

BAYVIEW WELLINGTON **S42-19**

GREEN VALLEY EAST **BRADFORD, ONTARIO**

project name: **GREEN VALLEY EAST** municipality: **BRADFORD, ONTARIO** project no.: **16023**

date: **OCTOBER 2021** checked by: **JWM** scale: **3/16" = 1'-0"** drawing no.: **38**

drawn by: **TP** file name: **16023-S42-19**

drawn by: **TP** scale: **3/16" = 1'-0"** date: **MAR 8, 2022**

VAS DESIGN
255 Consumers Rd, Suite 120
Toronto, ON M2J 1R4
t 416.630.2255 f 416.630.4782
vasdesign.com

name: **Wellington Jno-Baptiste** registration information: **VAS Design Inc.** BCIN: **25591** BCIN: **42658**

signature: 

3. REVISED AS PER ENG COMMENTS MAR 03-22 RC
2. REVISED AS PER FLOOR / ROOF LAYOUT FEB 24-22 RC
1. ISSUED FOR CLIENT REVIEW NOV 26-21 VAS

no. description by date

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R.W.L. AS REQUIRED & AS PER MUNICIPALITY

NOTE: REFER TO FRONT ELEVATION FOR TYPICAL NOTE INFORMATION



10' GROUND


REAR ELEVATION 'A'/'B'/'C'

project no.	16023
drawing no.	39
project name	GREEN VALLEY EAST
municipality	BRADFORD, ONTARIO
date	OCTOBER 2021
checked by	JWM
drawn by	TP
scale	3/16" = 1'-0"
file name	16023-S42-19
date	MAR 8, 2022
author	RICHARD - H. ARCHIVE WORKING\2016\16023-S42-19.dwg - Tue - Mar 8 2022 - 1:01 PM


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3	REVISED AS PER ENG COMMENTS	MAR 03-22	RC
2	REVISED AS PER FLOOR / ROOF LAYOUT	FEB 24-22	RC
1	ISSUED FOR CLIENT REVIEW	NOV 26-21	VA3
no.	description	date	by

name	Wellington Jno-Baptiste	BCIN	25591
registration information	VA3 Design Inc.	BCIN	42658
Contractor must verify all dimensions on the job and report any discrepancy to the Designer before proceeding with the work. All drawings and specifications are instruments of service and the property of the Designer which must be returned at the completion of the work. Drawings are not to be scaled.			

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ROOF PLAN 'B'
N.T.S.

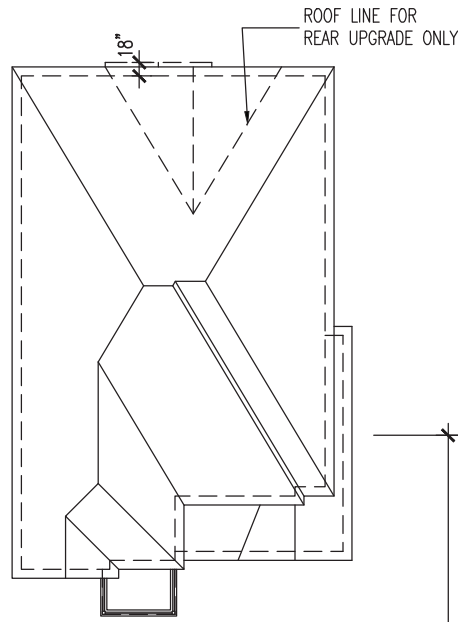

BRICK ARCH W/ VINYL
PANEL BELOW DETAIL
N.T.S.

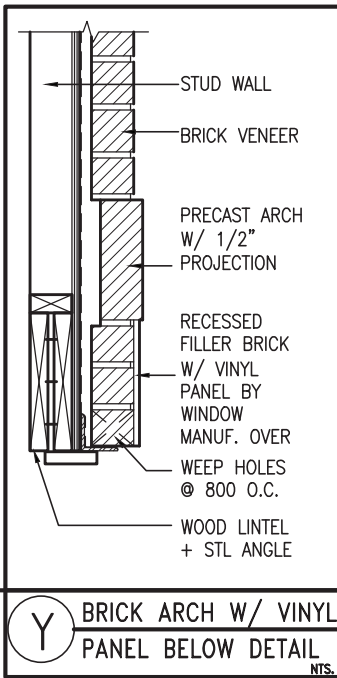8" PRECAST CONC. ARCH OVER
VINYL PANEL BY WINDOW MANUF.
ON 8" PRECAST CONC. SURROUND
W/ 1/2" PROJ. (TYP.)

CONT. PRECAST CONC. BAND
W/ 1/2" PROJ. (TYP.)

24" HIGH PREFIN.
DECORATIVE METAL RAILING

ROOF SCUPPER
PREFIN. ALUM. CAP OVER
BUILT-UP STUCCO TRIMS (TYP.)


8" PRECAST CONC. SURROUND
ON 4" PRECAST CONC. SILL
W/ 1/2" PROJ. (TYP.)

8"x8" FIBREGLASS COLUMN BY
ROMAN COLUMNS W/ 1/2"
THICK HDPE TOP LOADING PLATE
ANCHORED TO PORCH SLAB.

STONE VENEER (TYP.)

SUNKEN FOYER (-1R)

POURED CONC. PORCH
SLAB AND DOOR SILL

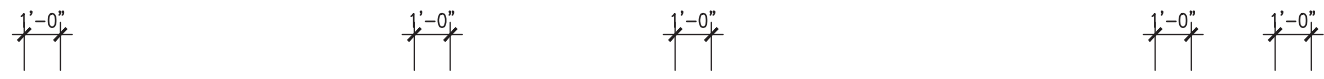

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JOHN G. WILLIAMS LTD., ARCHITECT
ARCHITECTURAL CONTROL REVIEW
AND APPROVAL

APPROVED BY: *[Signature]*
DATE: MAR 15, 2022

This stamp certifies compliance with the applicable Design Guidelines only and bears no further professional responsibility.



ASPHALT SHINGLES (TYP.)
VALLEY FLASHING (TYP.)
PREFIN. ALUM. R.W.L.,
FASCIA, GUTTER &
VENTED SOFFIT (TYP.)

FACE BRICK (TYP.)

PREFIN. MTL. FLASHING,
W/ CAULKING TO MATCH
MASONRY COLOUR (TYP.)

1"x6" ALUM. CLAD
FRIEZE BD. (TYP.)

MUNICIPAL ADDRESS
PLAQUE (TYP.)

8" PRECAST CONC. HEADER
W/ 1/2" PROJ. (TYP.)

POURED CONC. FOUNDATION
WALLS AND FOOTINGS (TYP.)

STEPPED FOOTING
AS REQUIRED

- TOP OF PLATE
- TOP OF WINDOW
- 8'-0" SECOND @ 6'-10"
- 9'-0" SECOND @ 7'-6"
- STANDARD 8'-1" SECOND FLOOR
- OPT. 9'-1" SECOND FLOOR
- FIN SECOND FLOOR
- TOP OF TRANSOM
- TOP OF WINDOW
- 11'-1"
- 7'-4"
- FIN GROUND FLOOR
- FIN GRADE
- 8'-7"
- 8'-1" FOR OPT. 9'-0" BASEMENT
- U/S OF FOOTING
- TOP OF SLAB

10' GROUND

FRONT ELEVATION 'B'

BAYVIEW WELLINGTON
GREEN VALLEY EAST
BRADFORD, ONTARIO

project no. 16023
drawing no. 40

file name 16023-S42-19
checked by JWM
scale 3/16" = 1'-0"
date OCTOBER 2021
drawn by TP

VAS DESIGN
255 Consumers Rd. Suite 120
Toronto, ON M2J 1R4
t 416.630.2255 f 416.630.4782
vasdesign.com

name Wellington Jno-Baptiste
signature
BCIN 25591
42658

3. REVISED AS PER ENG COMMENTS
2. REVISED AS PER FLOOR / ROOF LAYOUT
1. ISSUED FOR CLIENT REVIEW

date by

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no. description

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R.W.L. AS REQUIRED & AS PER MUNICIPALITY

NOTE: REFER TO FRONT ELEVATION FOR TYPICAL NOTE INFORMATION



MAR 8, 2022

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This is to certify that these plans comply with the applicable Architectural Design Guidelines approved by the Town of BRADFORD WEST WILLIMBURY.

JOHN G. WILLIAMS LTD., ARCHITECT
ARCHITECTURAL CONTROL REVIEW AND APPROVAL

APPROVED BY: _____
DATE: MAR 15, 2022

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PREFIN. ALUM. F.W.L., FASCIA, GUTTER & VENTED SOFFIT (TYP.)

4'-0" RETURN

1"x6" ALUM. CLAD FRIEZE BOARD (TYP.)

CONT. PRECAST CONC. BAND W/ 1/2" PROJ. (TYP.)

24" HIGH PREFIN. DECORATIVE METAL RAILING FIN SECOND FLOOR

ROOF SCUPPER

PREFIN. ALUM. CAP OVER BUILT-UP STUCCO TRIMS (TYP.)

STONE VENEER (TYP.)

8"x8" FIBREGLASS COLUMN BY ROMAN COLUMNS W/ 1/2" THICK HDPE TOP LOADING PLATE ANCHORED TO PORCH SLAB.

POURED CONC. FOUNDATION WALLS AND FOOTINGS (TYP.)

TOP OF PLATE

TOP OF WINDOW

1"x6" ALUM. CLAD FRIEZE BOARD (TYP.)

CONT. PRECAST CONC. BAND W/ 1/2" PROJ. (TYP.)

24" HIGH PREFIN. DECORATIVE METAL RAILING FIN SECOND FLOOR

ROOF SCUPPER

PREFIN. ALUM. CAP OVER BUILT-UP STUCCO TRIMS (TYP.)

STONE VENEER (TYP.)

8"x8" FIBREGLASS COLUMN BY ROMAN COLUMNS W/ 1/2" THICK HDPE TOP LOADING PLATE ANCHORED TO PORCH SLAB.

FIN SECOND FLOOR

TOP OF TRANSOM

TOP OF WINDOW

PREFIN. ALUM. CAP OVER BUILT-UP STUCCO TRIMS (TYP.)

STONE VENEER (TYP.)

8"x8" FIBREGLASS COLUMN BY ROMAN COLUMNS W/ 1/2" THICK HDPE TOP LOADING PLATE ANCHORED TO PORCH SLAB.

FIN GROUND FLOOR

FIN GRADE

8'-7" (10'-1" FOR OPT. 9'-0" BASEMENT)

8'-2"

7'-4"

11'-1"

1'-6"

8'-0" SECOND @ 6'-10"

9'-0" SECOND @ 7'-6"

STANDARD 8'-1" SECOND FLOOR

OPT. 9'-1" SECOND FLOOR

**** GLASS AREA ONLY ****

WALL AREA	1160.64 SQ. FT.
WALL AREA (9'-0" SEC. FLR.)	1215.47 SQ. FT.
LIMITING DISTANCE	1.2 M (7%)
OPENING ALLOWED	81.24 SQ. FT.
OPENING ALLOWED (9'-0" SEC. FLR.)	85.08 SQ. FT.
OPENING PROVIDED	51.18 SQ. FT.

LEFT SIDE ELEVATION 'B'

10' GROUND

project no.	16023
drawing no.	41
project name	BAYVIEW WELLINGTON
municipality	BRADFORD, ONTARIO
file name	16023-S42-19
scale	3/16" = 1'-0"
checked by	JWM
drawn by	TP
date	OCTOBER 2021
date	MAR 8, 2022

VAS DESIGN
255 Consumers Rd, Suite 120
Toronto, ON M2J 1R4
t 416.630.2255 f 416.630.4782
vasdesign.com

name	Wellington Jno-Baptiste	BCIN	25591
registration information	VAS Design Inc.	BCIN	42658
date	MAR 03-22	RC	
description	REVISED AS PER ENG COMMENTS		
date	FEB 24-22	RC	
description	REVISED AS PER FLOOR / ROOF LAYOUT		
date	NOV 26-21	VAS	
description	ISSUED FOR CLIENT REVIEW		

The undersigned has reviewed and takes responsibility for this design and has the qualifications and meets the requirements set out in the Ontario Building Code to be a Designer.

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JOHN G. WILLIAMS LTD., ARCHITECT
ARCHITECTURAL CONTROL REVIEW AND APPROVAL

APPROVED BY:


DATE: MAR 15, 2022

This stamp certifies compliance with the applicable Design Guidelines only and bears no further professional responsibility.

BRICK VENEER CONSTRUCTION
(FOR WALLS LESS THAN 1.2M (3'-11") FROM THE LOT LINE)
45 MINUTE FIRE RATED WALL
PROVIDE A CONTINUOUS LAYER OF 12.7mm (1/2") TYPE 'X' GYPSUM BOARD (INTERIOR SIDE) INSTALLED SO THAT ALL EDGES ARE SUPPORTED, TAPED AND FILLED. SPACE BETWEEN WOOD STUDS TO BE FILLED WITH INSULATION CONFORMING TO CAN/ULC-S702, "MINERAL FIBRE THERMAL INSULATION FOR BUILDINGS" WITH A MASS OF NOT LESS THAN 1.22 Kg/SQ.M. AND MUST FILL AT LEAST 90% OF THE CAVITY THICKNESS. THE TYPE 'X' & INSULATION MUST BE RUN CONTINUOUSLY BEHIND ALL INTERSECTING PARTITIONS, MECHANICAL CHASES, BATHTUBS, SHOWERS, ETC. ENSURE INSULATION & TYPE 'X' IS INSTALLED IN GARAGE EXTERIOR WALLS. (REFER TO SECTION SB-2 OF OBC 2012-SUPPLEMENTARY STANDARDS)

R.W.L. AS REQUIRED & AS PER MUNICIPALITY

NOTE: REFER TO FRONT ELEVATION FOR TYPICAL NOTE INFORMATION

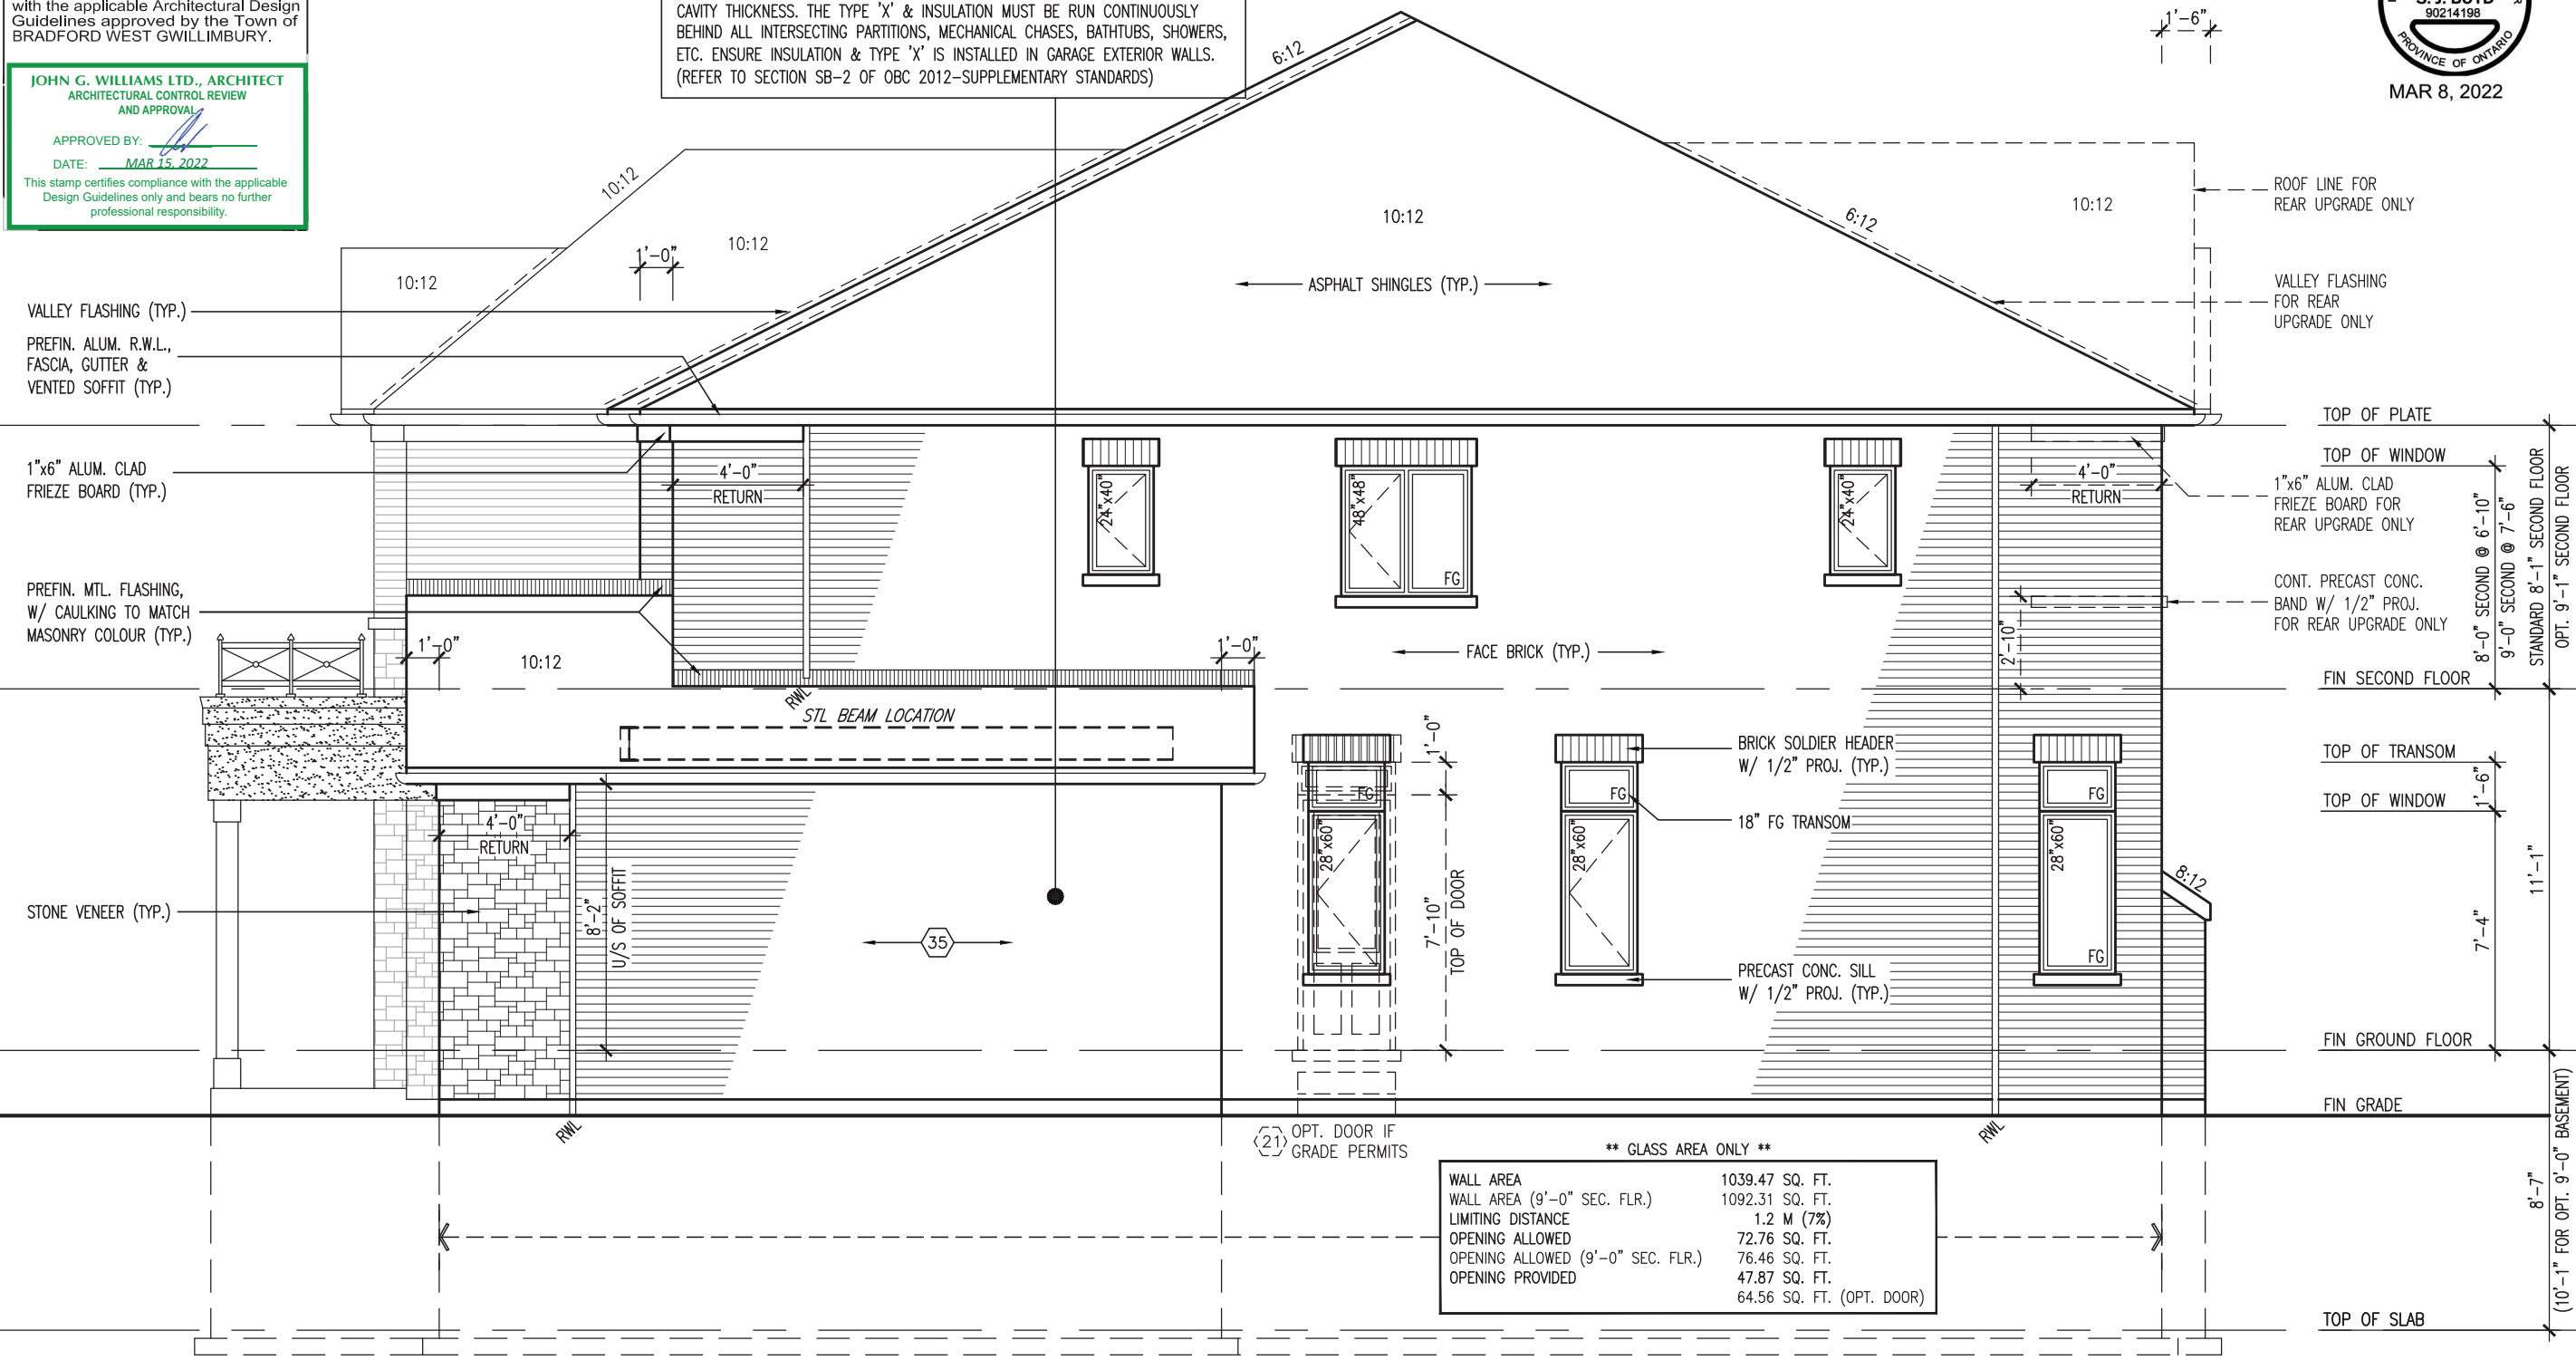

**** GLASS AREA ONLY ****

WALL AREA	1039.47 SQ. FT.
WALL AREA (9'-0" SEC. FLR.)	1092.31 SQ. FT.
LIMITING DISTANCE	1.2 M (7%)
OPENING ALLOWED	72.76 SQ. FT.
OPENING ALLOWED (9'-0" SEC. FLR.)	76.46 SQ. FT.
OPENING PROVIDED	47.87 SQ. FT.
	64.56 SQ. FT. (OPT. DOOR)

10' GROUND

RIGHT SIDE ELEVATION 'B'

BAYVIEW WELLINGTON S42-19

GREEN VALLEY EAST BRADFORD, ONTARIO

VA3 DESIGN

255 Consumers Rd, Suite 120
Toronto, ON M2J 1R4
t 416.630.2255 f 416.630.4782
v3design.com


project name: GREEN VALLEY EAST
municipality: BRADFORD, ONTARIO
project no.: 16023
drawing no.: 42

checked by: JWM
scale: 3/16" = 1'-0"
date: OCTOBER 2021
drawn by: TP

name: Wellington Jno-Baptiste
signature:
registration information: VAS Design Inc.
BCIN: 25591
BCIN: 42658

3. REVISED AS PER ENG COMMENTS MAR 03-22 RC
2. REVISED AS PER FLOOR / ROOF LAYOUT FEB 24-22 RC
1. ISSUED FOR CLIENT REVIEW NOV 26-21 VAS

no. description date by

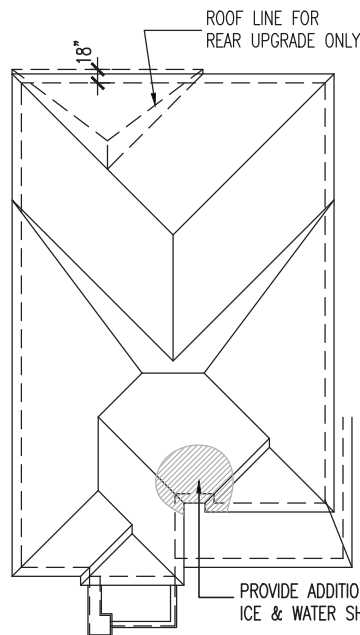

ROOF PLAN 'C'
N.T.S.


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JOHN G. WILLIAMS LTD., ARCHITECT
ARCHITECTURAL CONTROL REVIEW
AND APPROVAL

APPROVED BY: *[Signature]*
DATE: MAR 15, 2022

This stamp certifies compliance with the applicable Design Guidelines only and bears no further professional responsibility.



- STONE BY BRAMPTON BRICK FINESSE LINE OR SIMILAR
- ALUMINUM PANEL
- FACE BRICK
- STUCCO FINISH

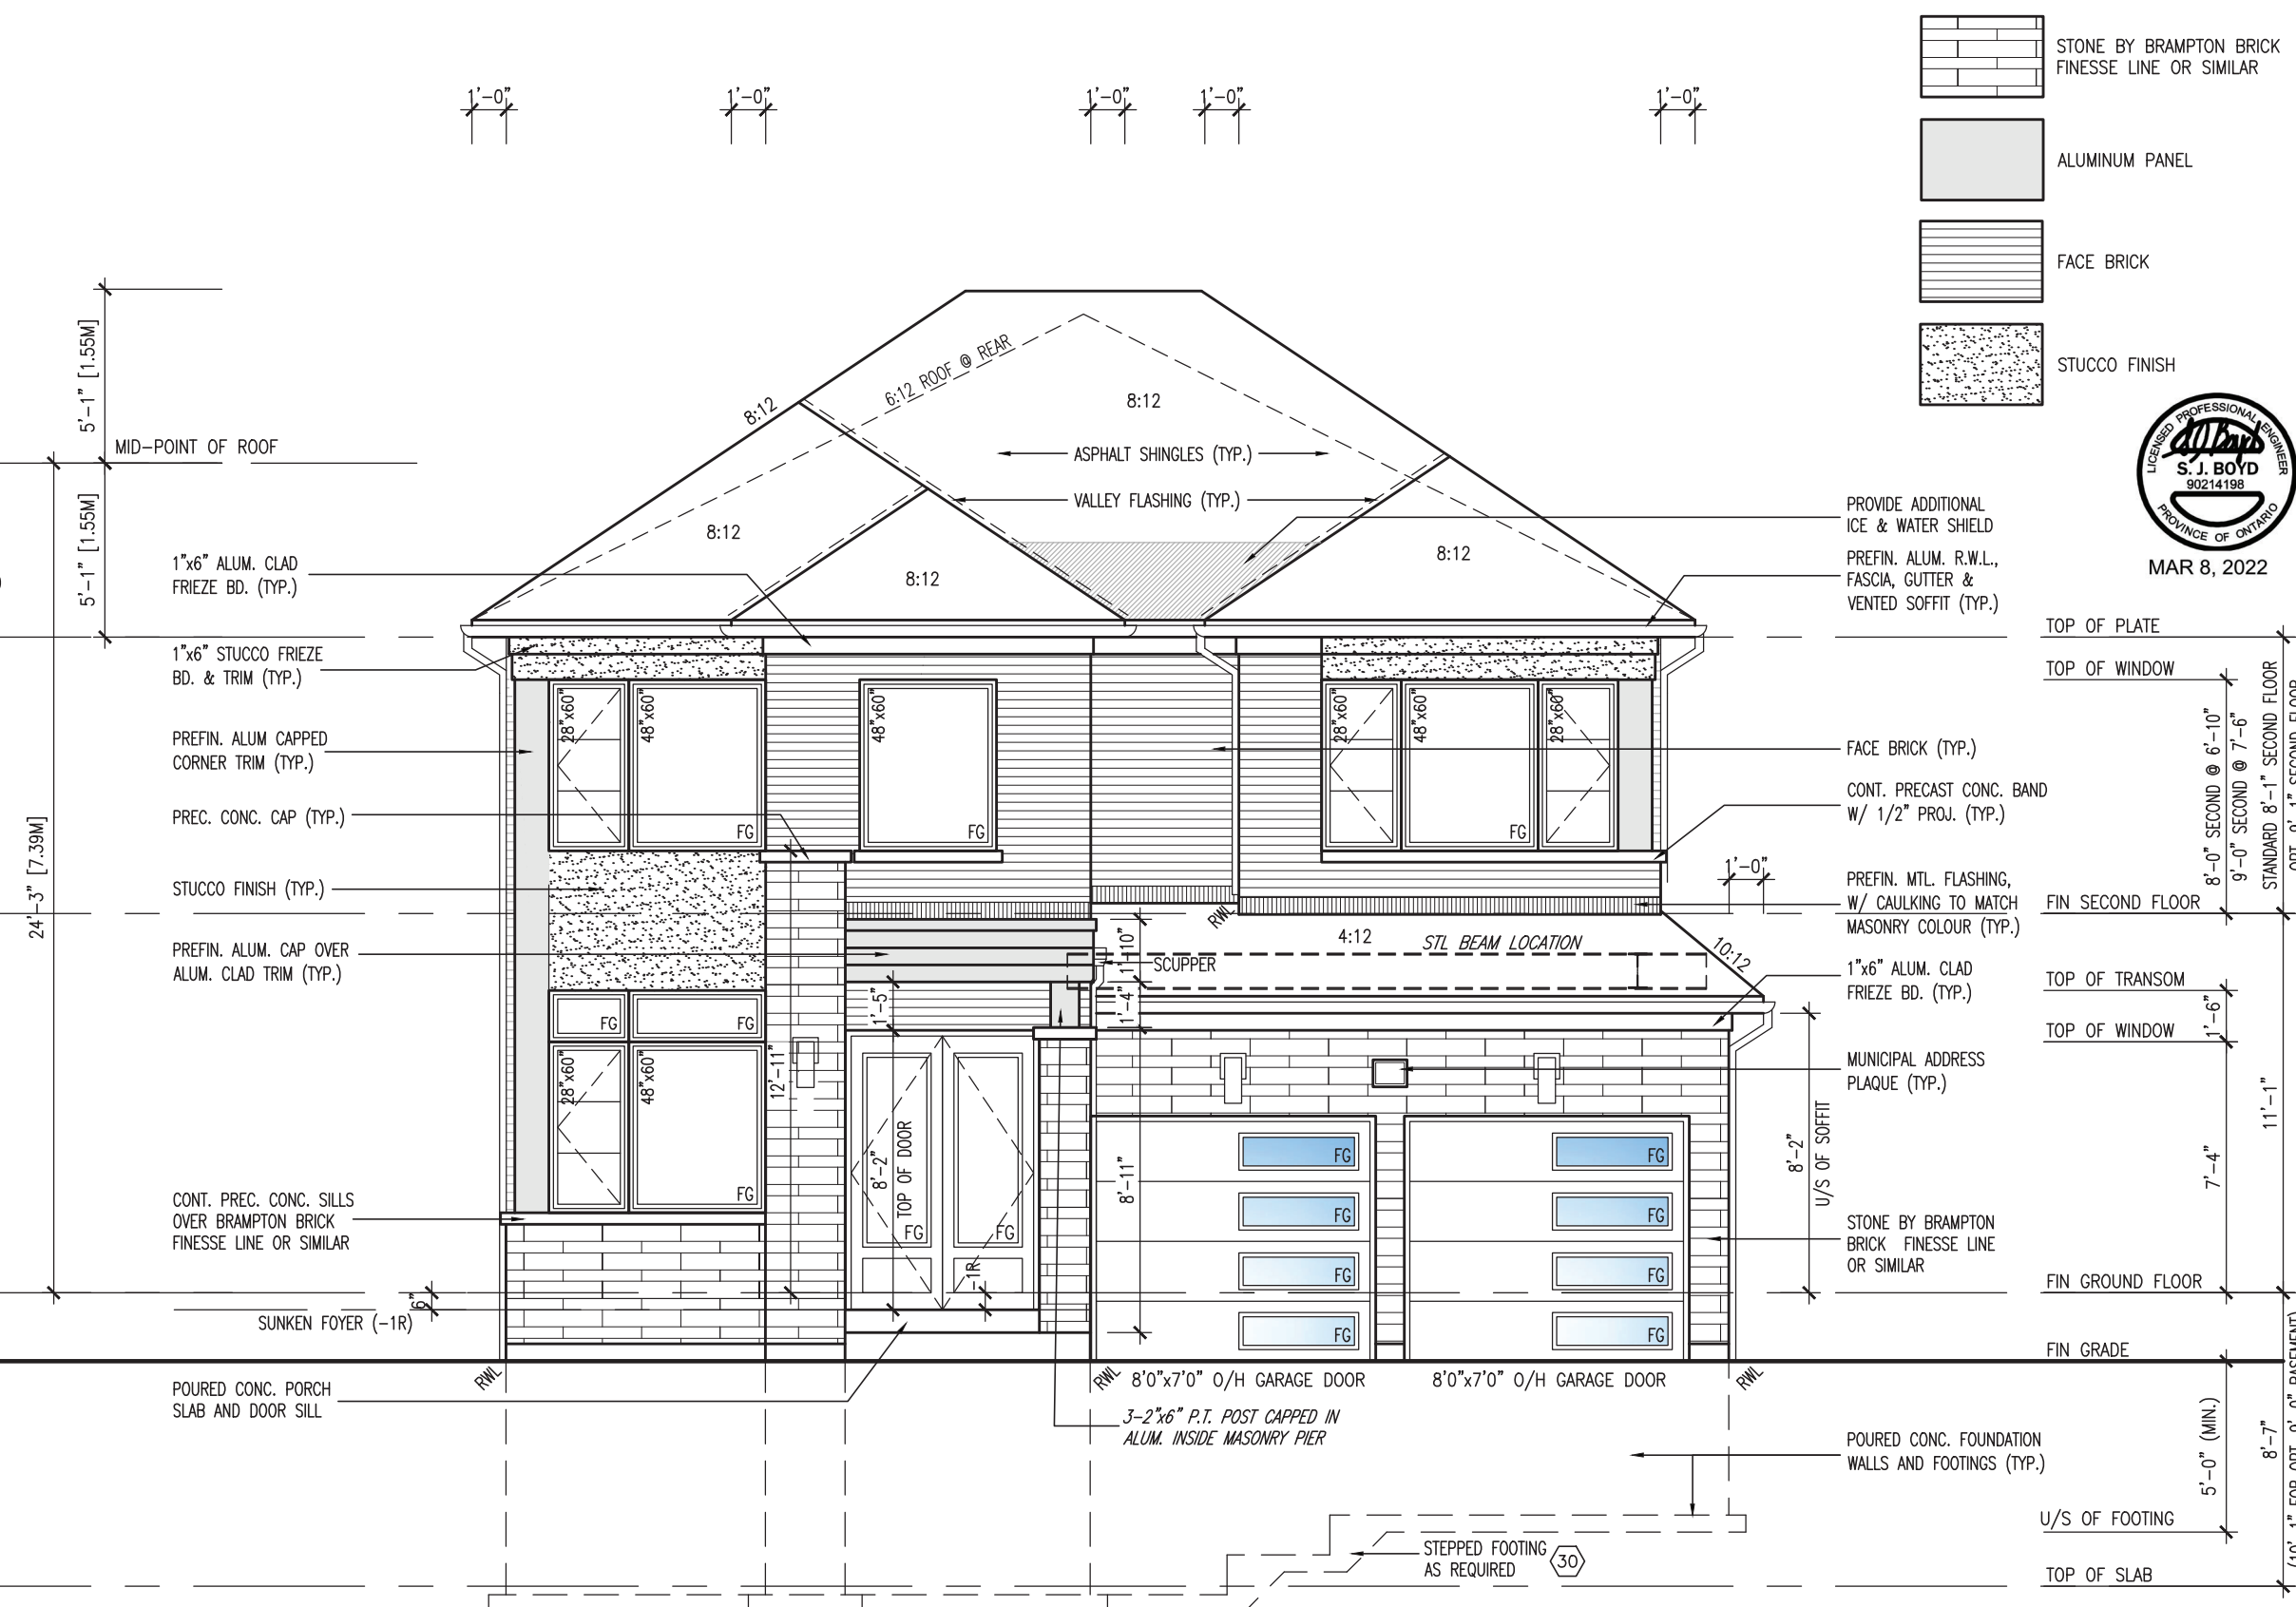

- PROVIDE ADDITIONAL ICE & WATER SHIELD
- PREFIN. ALUM. R.W.L., FASCIA, GUTTER & VENTED SOFFIT (TYP.)
- FACE BRICK (TYP.)
- CONT. PRECAST CONC. BAND W/ 1/2" PROJ. (TYP.)
- PREFIN. MTL. FLASHING, W/ CAULKING TO MATCH MASONRY COLOUR (TYP.)
- 1"x6" ALUM. CLAD FRIEZE BD. (TYP.)
- MUNICIPAL ADDRESS PLAQUE (TYP.)
- STONE BY BRAMPTON BRICK FINESSE LINE OR SIMILAR
- POURED CONC. FOUNDATION WALLS AND FOOTINGS (TYP.)

10' GROUND

FRONT ELEVATION 'C'

BAYVIEW WELLINGTON
GREEN VALLEY EAST
BRADFORD, ONTARIO

project no. 16023
drawing no. 43

file name 16023-S42-19
scale 3/16" = 1'-0"
checked by JWM
drawn by TP
date OCTOBER 2021

VA3 DESIGN
255 Consumers Rd, Suite 120
Toronto, ON M2J 1R4
t 416.630.2255 f 416.630.4782
vo3design.com

signature: *[Signature]* BCIN 25591
name: Wellington Jno-Baptiste
registration information: VAS Design Inc. 42658

no.	description	date	by
3	REVISED AS PER ENG COMMENTS	MAR 03-22	RC
2	REVISED AS PER FLOOR / ROOF LAYOUT	FEB 24-22	RC
1	ISSUED FOR CLIENT REVIEW	NOV 26-21	VA3

The undersigned has reviewed and takes responsibility for this design and has the qualifications and meets the requirements set out in the Ontario Building Code to be a Designer.

10'-1" FOR OPT. 9'-0" BASEMENT

R.W.L. AS REQUIRED & AS PER MUNICIPALITY


NOTE: REFER TO FRONT ELEVATION FOR TYPICAL NOTE INFORMATION



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This is to certify that these plans comply with the applicable Architectural Design Guidelines approved by the Town of BRADFORD WEST GWILLIMBURY.

JOHN G. WILLIAMS LTD., ARCHITECT
ARCHITECTURAL CONTROL REVIEW AND APPROVAL
APPROVED BY: [Signature]
DATE: MAR 15, 2022
This stamp certifies compliance with the applicable Design Guidelines only and bears no further professional responsibility.

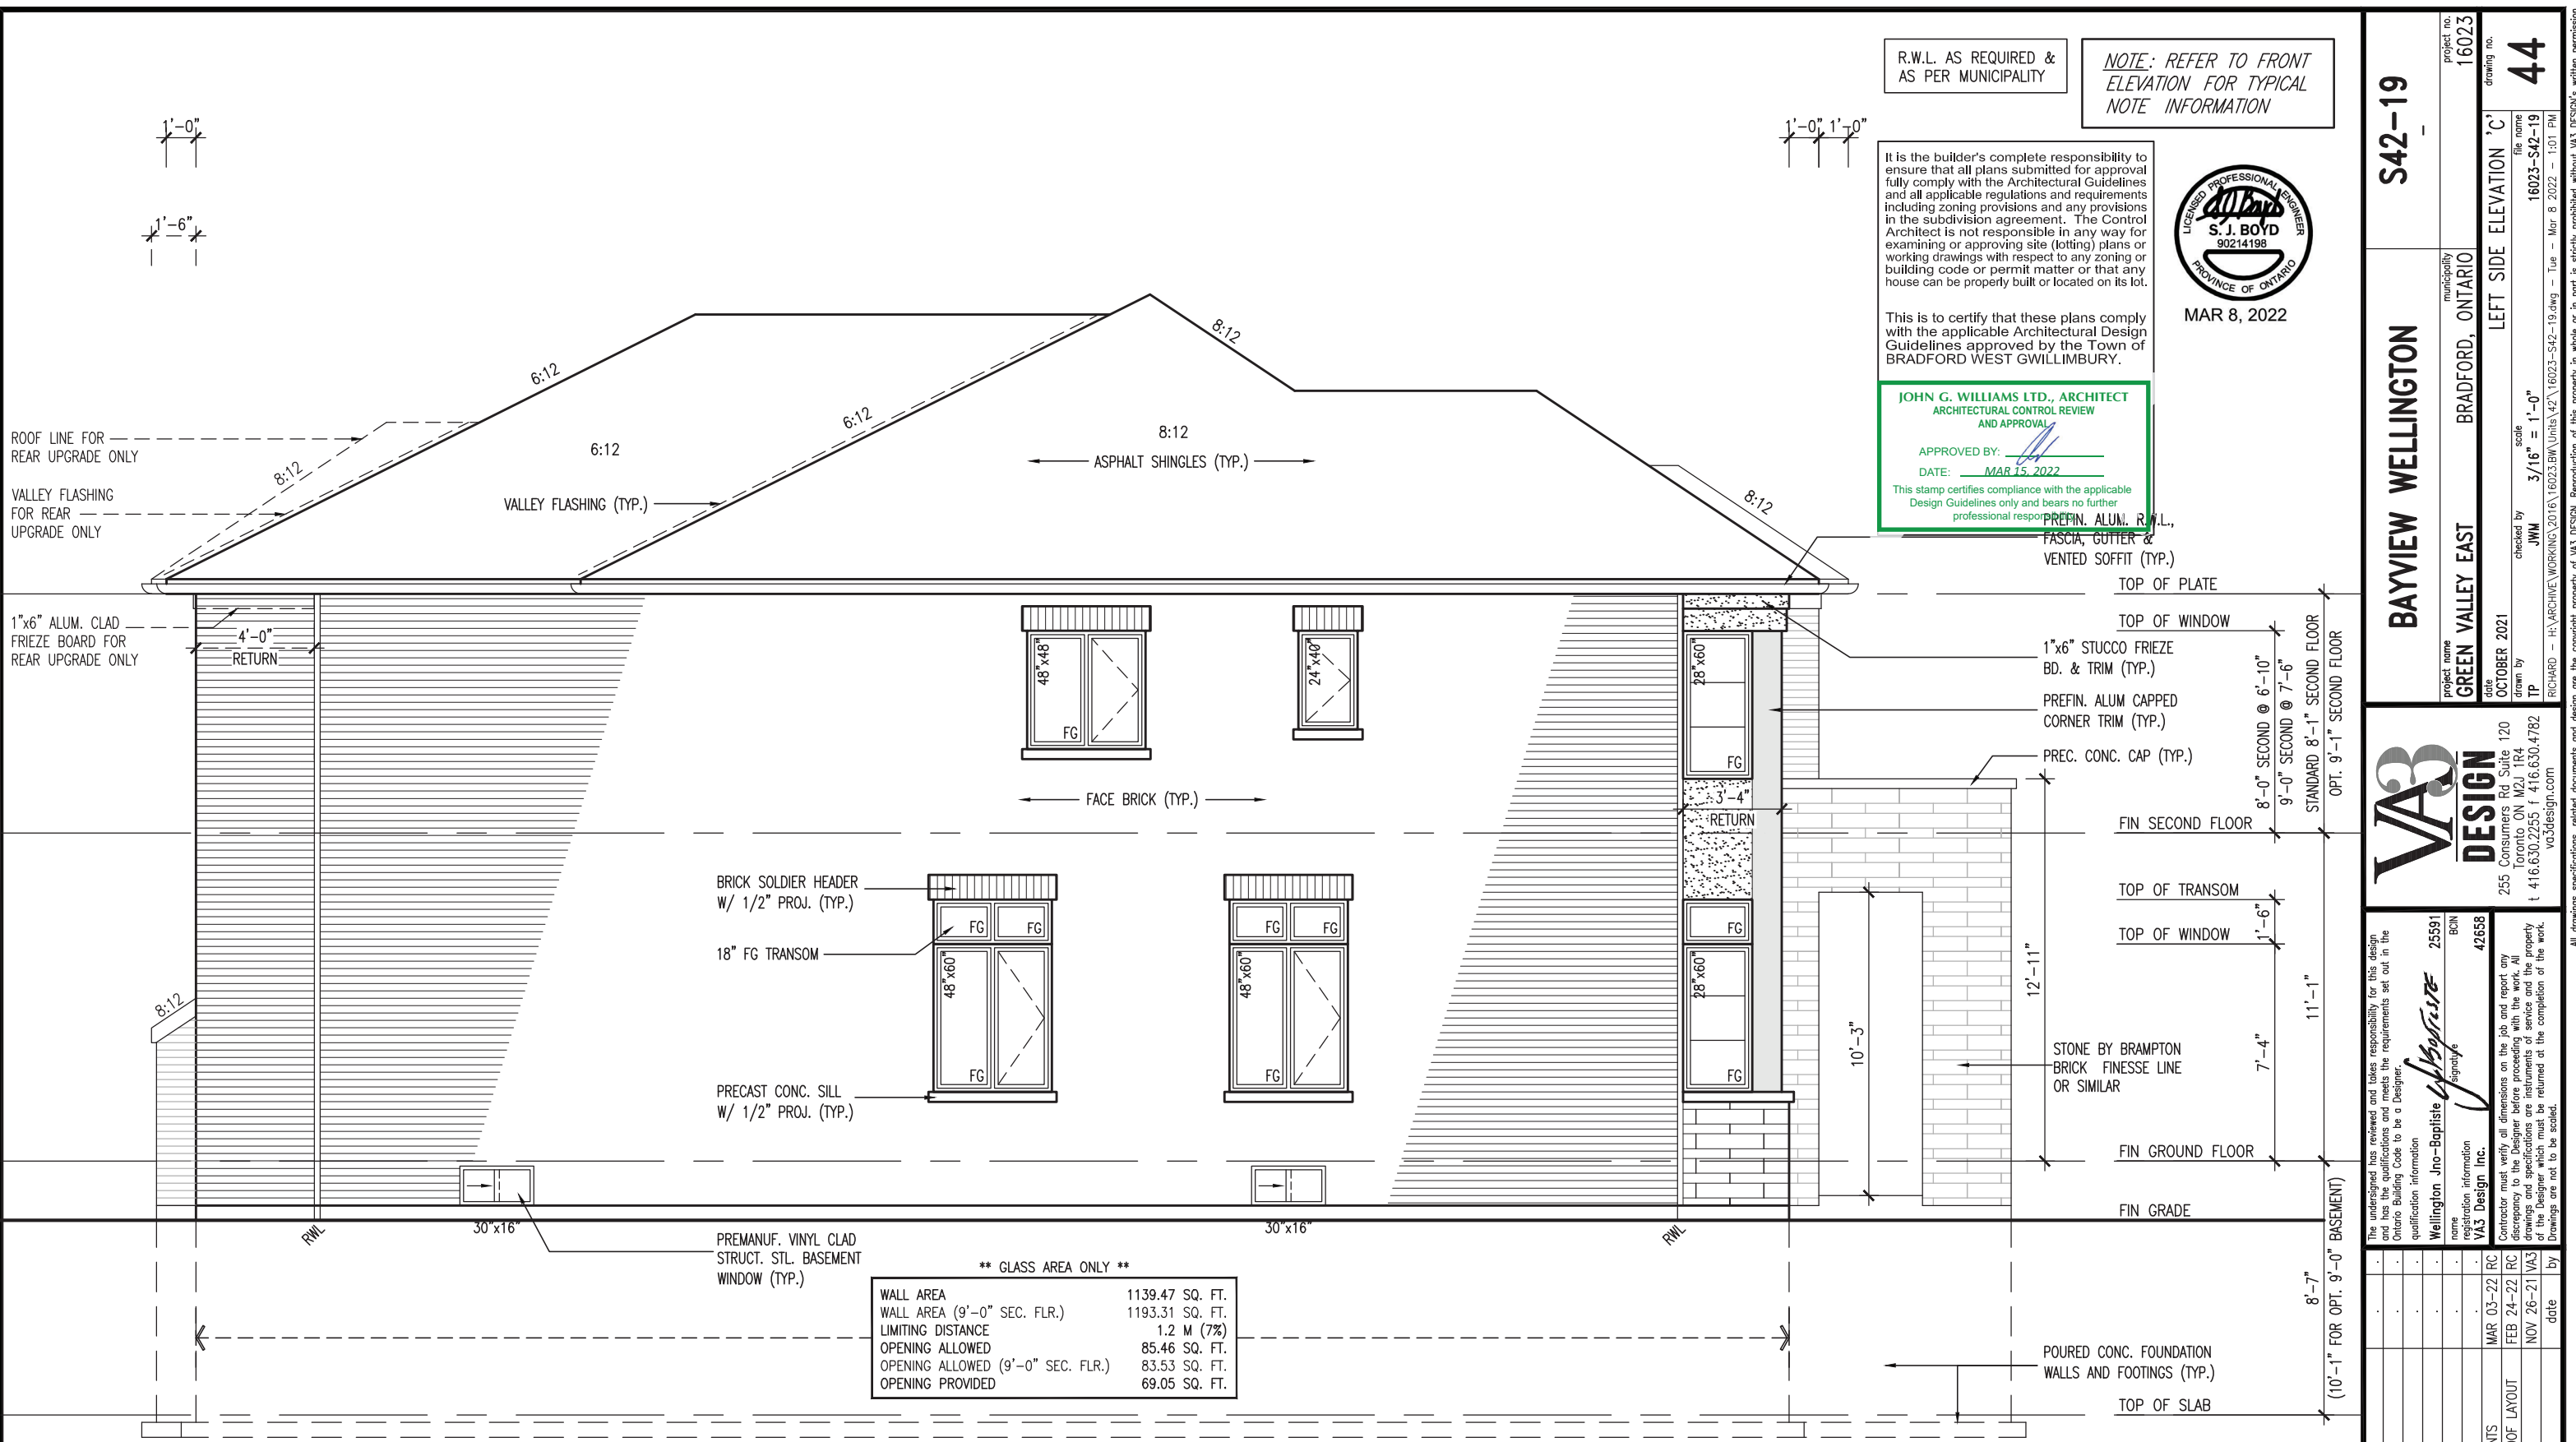

**** GLASS AREA ONLY ****

WALL AREA	1139.47 SQ. FT.
WALL AREA (9'-0" SEC. FLR.)	1193.31 SQ. FT.
LIMITING DISTANCE	1.2 M (7%)
OPENING ALLOWED	85.46 SQ. FT.
OPENING ALLOWED (9'-0" SEC. FLR.)	83.53 SQ. FT.
OPENING PROVIDED	69.05 SQ. FT.

LEFT SIDE ELEVATION 'C'

10' GROUND

project no.	16023
drawing no.	44
project name	BAYVIEW WELLINGTON
municipality	BRADFORD, ONTARIO
project name	GREEN VALLEY EAST
date	OCTOBER 2021
checked by	JWM
scale	3/16" = 1'-0"
drawn by	TP
file name	16023-S42-19
date	MAR 8, 2022
time	1:01 PM

9	ISSUED FOR CLIENT REVIEW	NOV 26-21	VA3
8	REVISED AS PER ENG COMMENTS	MAR 03-22	RC
7	REVISD AS PER FLOOR / ROOF LAYOUT	FEB 24-22	RC
6			
5			
4			
3			
2			
1			

name	Wellington Jno-Baptiste	BCIN	25591
registration information	VA3 Design Inc.	BCIN	42658

The undersigned has reviewed and takes responsibility for this design and has the qualifications and meets the requirements set out in the Ontario Building Code to be a Designer.

Contractor must verify all dimensions on the job and report any discrepancy to the Designer before proceeding with the work. All drawings and specifications are instruments of service and the property of the Designer which must be returned at the completion of the work. Drawings are not to be scaled.

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JOHN G. WILLIAMS LTD., ARCHITECT
ARCHITECTURAL CONTROL REVIEW AND APPROVAL

APPROVED BY: *[Signature]*
DATE: MAR 15, 2022


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BRICK VENEER CONSTRUCTION

(FOR WALLS LESS THAN 1.2M (3'-11") FROM THE LOT LINE)
45 MINUTE FIRE RATED WALL
PROVIDE A CONTINUOUS LAYER OF 12.7mm (1/2") TYPE 'X' GYPSUM BOARD (INTERIOR SIDE) INSTALLED SO THAT ALL EDGES ARE SUPPORTED, TAPED AND FILLED. SPACE BETWEEN WOOD STUDS TO BE FILLED WITH INSULATION CONFORMING TO CAN/ULC-S702, "MINERAL FIBRE THERMAL INSULATION FOR BUILDINGS" WITH A MASS OF NOT LESS THAN 1.22 Kg/SQ.M. AND MUST FILL AT LEAST 90% OF THE CAVITY THICKNESS. THE TYPE 'X' & INSULATION MUST BE RUN CONTINUOUSLY BEHIND ALL INTERSECTING PARTITIONS, MECHANICAL CHASES, BATHTUBS, SHOWERS, ETC. ENSURE INSULATION & TYPE 'X' IS INSTALLED IN GARAGE EXTERIOR WALLS. (REFER TO SECTION SB-2 OF OBC 2012-SUPPLEMENTARY STANDARDS)

R.W.L. AS REQUIRED & AS PER MUNICIPALITY

NOTE: REFER TO FRONT ELEVATION FOR TYPICAL NOTE INFORMATION

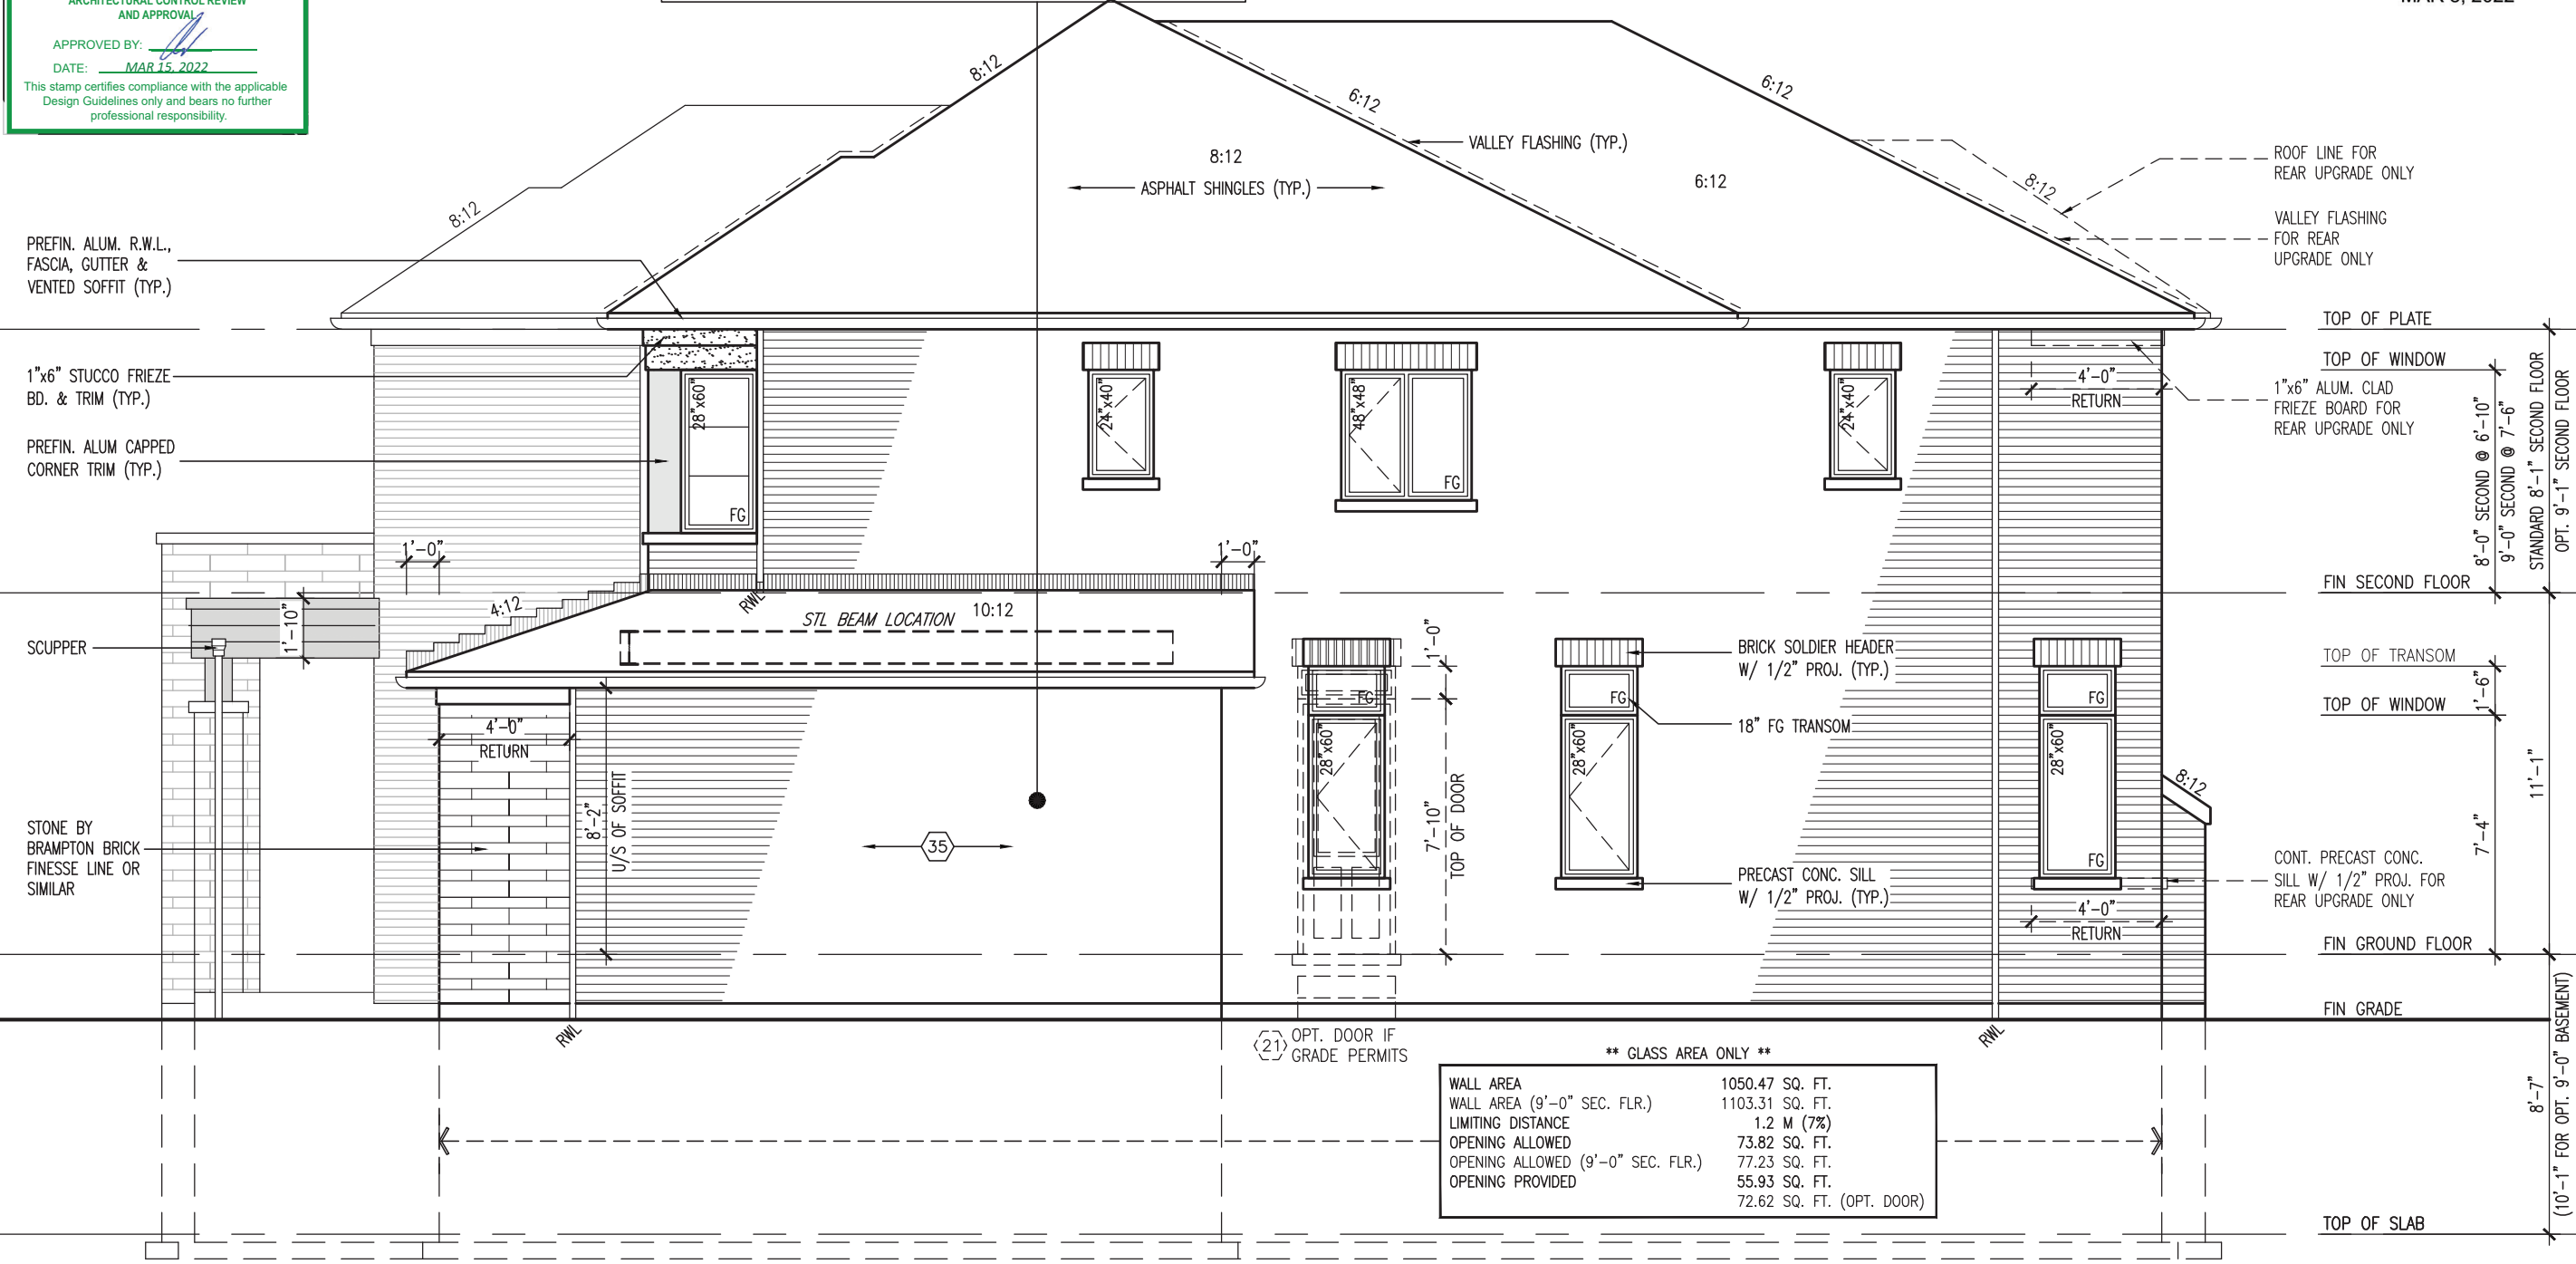

RIGHT SIDE ELEVATION 'C'

**** GLASS AREA ONLY ****

WALL AREA	1050.47 SQ. FT.
WALL AREA (9'-0" SEC. FLR.)	1103.31 SQ. FT.
LIMITING DISTANCE	1.2 M (7%)
OPENING ALLOWED	73.82 SQ. FT.
OPENING ALLOWED (9'-0" SEC. FLR.)	77.23 SQ. FT.
OPENING PROVIDED	55.93 SQ. FT.
	72.62 SQ. FT. (OPT. DOOR)

10' GROUND

BAYVIEW WELLINGTON **S42-19**

GREEN VALLEY EAST **BRADFORD, ONTARIO**

project name: GREEN VALLEY EAST
municipality: BRADFORD, ONTARIO
project no.: 16023
drawing no.: 45

checked by: JWM
scale: 3/16" = 1'-0"
date: OCTOBER 2021
drawn by: TP

VA3 DESIGN
255 Consumers Rd, Suite 120
Toronto, ON M2J 1R4
t 416.630.2255 f 416.630.4782
vo3design.com

name: Wellington Jno-Baptiste
signature: *[Signature]*
BCIN: 25591
BCIN: 42658

registration information: VAS Design Inc.

Contractor must verify all dimensions on the job and report any discrepancy to the Designer before proceeding with the work. All drawings and specifications are instruments of service and the property of the Designer which must be returned at the completion of the work. Drawings are not to be scaled.

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no. description

date by

NOV 26-21 VAS3
FEB 24-22 RC
MAR 03-22 RC

ISSUED FOR CLIENT REVIEW
REVISED AS PER FLOOR / ROOF LAYOUT
REVISED AS PER ENG COMMENTS

(10'-1" FOR OPT. 9'-0" BASEMENT)

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JOHN G. WILLIAMS LTD., ARCHITECT
 ARCHITECTURAL CONTROL REVIEW
 AND APPROVAL

APPROVED BY: 
 DATE: MAR 15, 2022

This stamp certifies compliance with the applicable Design Guidelines only and bears no further professional responsibility.

R.W.L. AS REQUIRED & AS PER MUNICIPALITY

NOTE: REFER TO FRONT ELEVATION FOR TYPICAL NOTE INFORMATION



DASHED LINE INDICATES ROOF LINE FOR ELEV. 'B' @ FRONT

DASHED LINE INDICATES ROOF LINE FOR ELEV. 'C'

PREFIN. ALUM. R.W.L., FASCIA, GUTTER & VENTED SOFFIT (TYP.)

FACE BRICK (TYP.)

BRICK SOLDIER HEADER W/ 1/2" PROJ. (TYP.)

18" FG TRANSOM

PREFIN. MTL. FLASHING, W/ CAULKING TO MATCH MASONRY COLOUR (TYP.)

PROVIDE 2"x4" P.T. WOOD HANDRAIL GUARD W/ 2"x2" P.T. WOOD PICKETS @ 4" MAX.

6"x6" P.T. WOOD POST C/W GALV. METAL CAP AND METAL SHOE SET INTO 12" DIA. SONO TUBES TO EXTEND 6" ABOVE GRADE AND 5'-0" BELOW GRADE.

POURED CONC. FOUNDATION WALLS AND FOOTINGS (TYP.)

TOP OF PLATE	
TOP OF WINDOW	
FIN SECOND FLOOR	8'-0" SECOND @ 6'-10"
	9'-0" SECOND @ 7'-6"
	STANDARD 8'-1" SECOND FLOOR
	OPT. 9'-1" SECOND FLOOR
TOP OF TRANSOM	
TOP OF WINDOW	1'-6"
FIN GROUND FLOOR	7'-4"
TOP OF WINDOW	11'-1"
FIN GRADE	8'-7"
TOP OF SLAB	(10'-1" FOR OPT. 9'-0" BASEMENT)

10' GROUND

REAR ELEVATION 'A'/'B'/'C' - W.O.D. CONDITION

BASEMENT WINDOW SIZES
 4R-8R USE 30"x24" VINYL CLAD STRUCTURAL STEEL FRAME BASEMENT WINDOWS

VAS DESIGN
 255 Consumers Rd, Suite 120
 Toronto, ON M2J 1R4
 t 416.630.2255 f 416.630.4782
 vasdesign.com

The undersigned has reviewed and takes responsibility for this design and has the qualifications and meets the requirements set out in the Ontario Building Code to be a Designer.

Wellington Jno-Baptiste
 name: Jno-Baptiste Wellington
 registration information: 25591 BCIN
 VAS Design Inc.
 name: VAS Design Inc.
 registration information: 42658 BCIN

Contractor must verify all dimensions on the job and report any discrepancy to the Designer before proceeding with the work. All drawings and specifications are instruments of service and the property of the Designer which must be returned at the completion of the work. Drawings are not to be scaled.

9		date	by
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4			
3	REVISED AS PER ENG COMMENTS	MAR 03-22	RC
2	REVISED AS PER FLOOR / ROOF LAYOUT	FEB 24-22	RC
1	ISSUED FOR CLIENT REVIEW	NOV 26-21	VAS
no.	description	date	by

S42-19

BAYVIEW WELLINGTON

GREEN VALLEY EAST

BRADFORD, ONTARIO

REAR ELEVATION 'A' - W.O.D. COND.

16023

46

project no. 16023 drawing no. 46
 municipality BRADFORD, ONTARIO
 file name 16023-S42-19
 checked by JMW scale 3/16" = 1'-0"
 date OCTOBER 2021
 drawn by TP
 RICHARD - H:\ARCHIVE\WORKING\2016\16023\Units\42\16023-S42-19.dwg - Tue - Mar 8 2022 - 1:01 PM

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JOHN G. WILLIAMS LTD., ARCHITECT
ARCHITECTURAL CONTROL REVIEW
AND APPROVAL

APPROVED BY: 
DATE: MAR 15, 2022

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R.W.L. AS REQUIRED & AS PER MUNICIPALITY

NOTE: REFER TO FRONT ELEVATION FOR TYPICAL NOTE INFORMATION



10' GROUND

REAR ELEVATION 'A'/'B'/'C' - W.O.B. CONDITION

DASHED LINE INDICATES ROOF LINE FOR ELEV. 'B' @ FRONT

DASHED LINE INDICATES ROOF LINE FOR ELEV. 'C'

PREFIN. ALUM. R.W.L., FASCIA, GUTTER & VENTED SOFFIT (TYP.)

FACE BRICK (TYP.)

BRICK SOLDIER HEADER W/ 1/2" PROJ. (TYP.)

PREFIN. MTL. FLASHING, W/ CAULKING TO MATCH MASONRY COLOUR (TYP.)

PROVIDE 2"x4" P.T. WOOD HANDRAIL GUARD W/ 2"x2" P.T. WOOD PICKETS @ 4" MAX.

2"x6" P.T. CROSS BRACING

6"x6" P.T. WOOD POST C/W GALV. METAL CAP AND METAL SHOE SET INTO 12" DIA. SONO TUBES TO EXTEND 6" ABOVE GRADE AND 5'-0" BELOW GRADE.

POURED CONC. FOUNDATION WALLS AND FOOTINGS (TYP.)

TOP OF PLATE	
TOP OF WINDOW	
FIN SECOND FLOOR	8'-0" SECOND @ 6'-10"
	9'-0" SECOND @ 7'-6"
	STANDARD 8'-1" SECOND FLOOR
	OPT. 9'-1" SECOND FLOOR
TOP OF TRANSOM	
TOP OF WINDOW	1'-6"
FIN GROUND FLOOR	7'-4"
TOP OF WINDOW	11'-1"
TOP OF SLAB	6'-10"
FIN GRADE	8'-7"
	(10'-1" FOR OPT. 9'-0" BASEMENT)



The undersigned has reviewed and takes responsibility for this design and has the qualifications and meets the requirements set out in the Ontario Building Code to be a Designer.

Wellington Jno-Baptiste 25591 BCIN
signature
VAS Design Inc. 42658

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3	REVISED AS PER ENG COMMENTS	MAR 03-22	RC		
2	REVISED AS PER FLOOR / ROOF LAYOUT	FEB 24-22	RC		
1	ISSUED FOR CLIENT REVIEW	NOV 26-21	VA3		
no.	description	date	by		

S42-19

BAYVIEW WELLINGTON

GREEN VALLEY EAST

Wellington Jno-Baptiste 25591 BCIN

VAS Design Inc. 42658

MAR 03-22 RC

FEB 24-22 RC

NOV 26-21 VA3

no. description

project no. 16023
drawing no. 47
municipality BRADFORD, ONTARIO
file name 16023-S42-19
scale 3/16" = 1'-0"
checked by JWM
date OCTOBER 2021
drawn by TP

project name GREEN VALLEY EAST
date OCTOBER 2021
drawn by TP
checked by JWM
scale 3/16" = 1'-0"

project name GREEN VALLEY EAST
date OCTOBER 2021
drawn by TP
checked by JWM
scale 3/16" = 1'-0"

project name GREEN VALLEY EAST
date OCTOBER 2021
drawn by TP
checked by JWM
scale 3/16" = 1'-0"

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date OCTOBER 2021
drawn by TP
checked by JWM
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project name GREEN VALLEY EAST
date OCTOBER 2021
drawn by TP
checked by JWM
scale 3/16" = 1'-0"

project name GREEN VALLEY EAST
date OCTOBER 2021
drawn by TP
checked by JWM
scale 3/16" = 1'-0"

project name GREEN VALLEY EAST
date OCTOBER 2021
drawn by TP
checked by JWM
scale 3/16" = 1'-0"

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JOHN G. WILLIAMS LTD., ARCHITECT
 ARCHITECTURAL CONTROL REVIEW
 AND APPROVAL


APPROVED BY:

DATE: MAR 15, 2022

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R.W.L. AS REQUIRED &
AS PER MUNICIPALITY

NOTE: REFER TO FRONT
ELEVATION FOR TYPICAL
NOTE INFORMATION

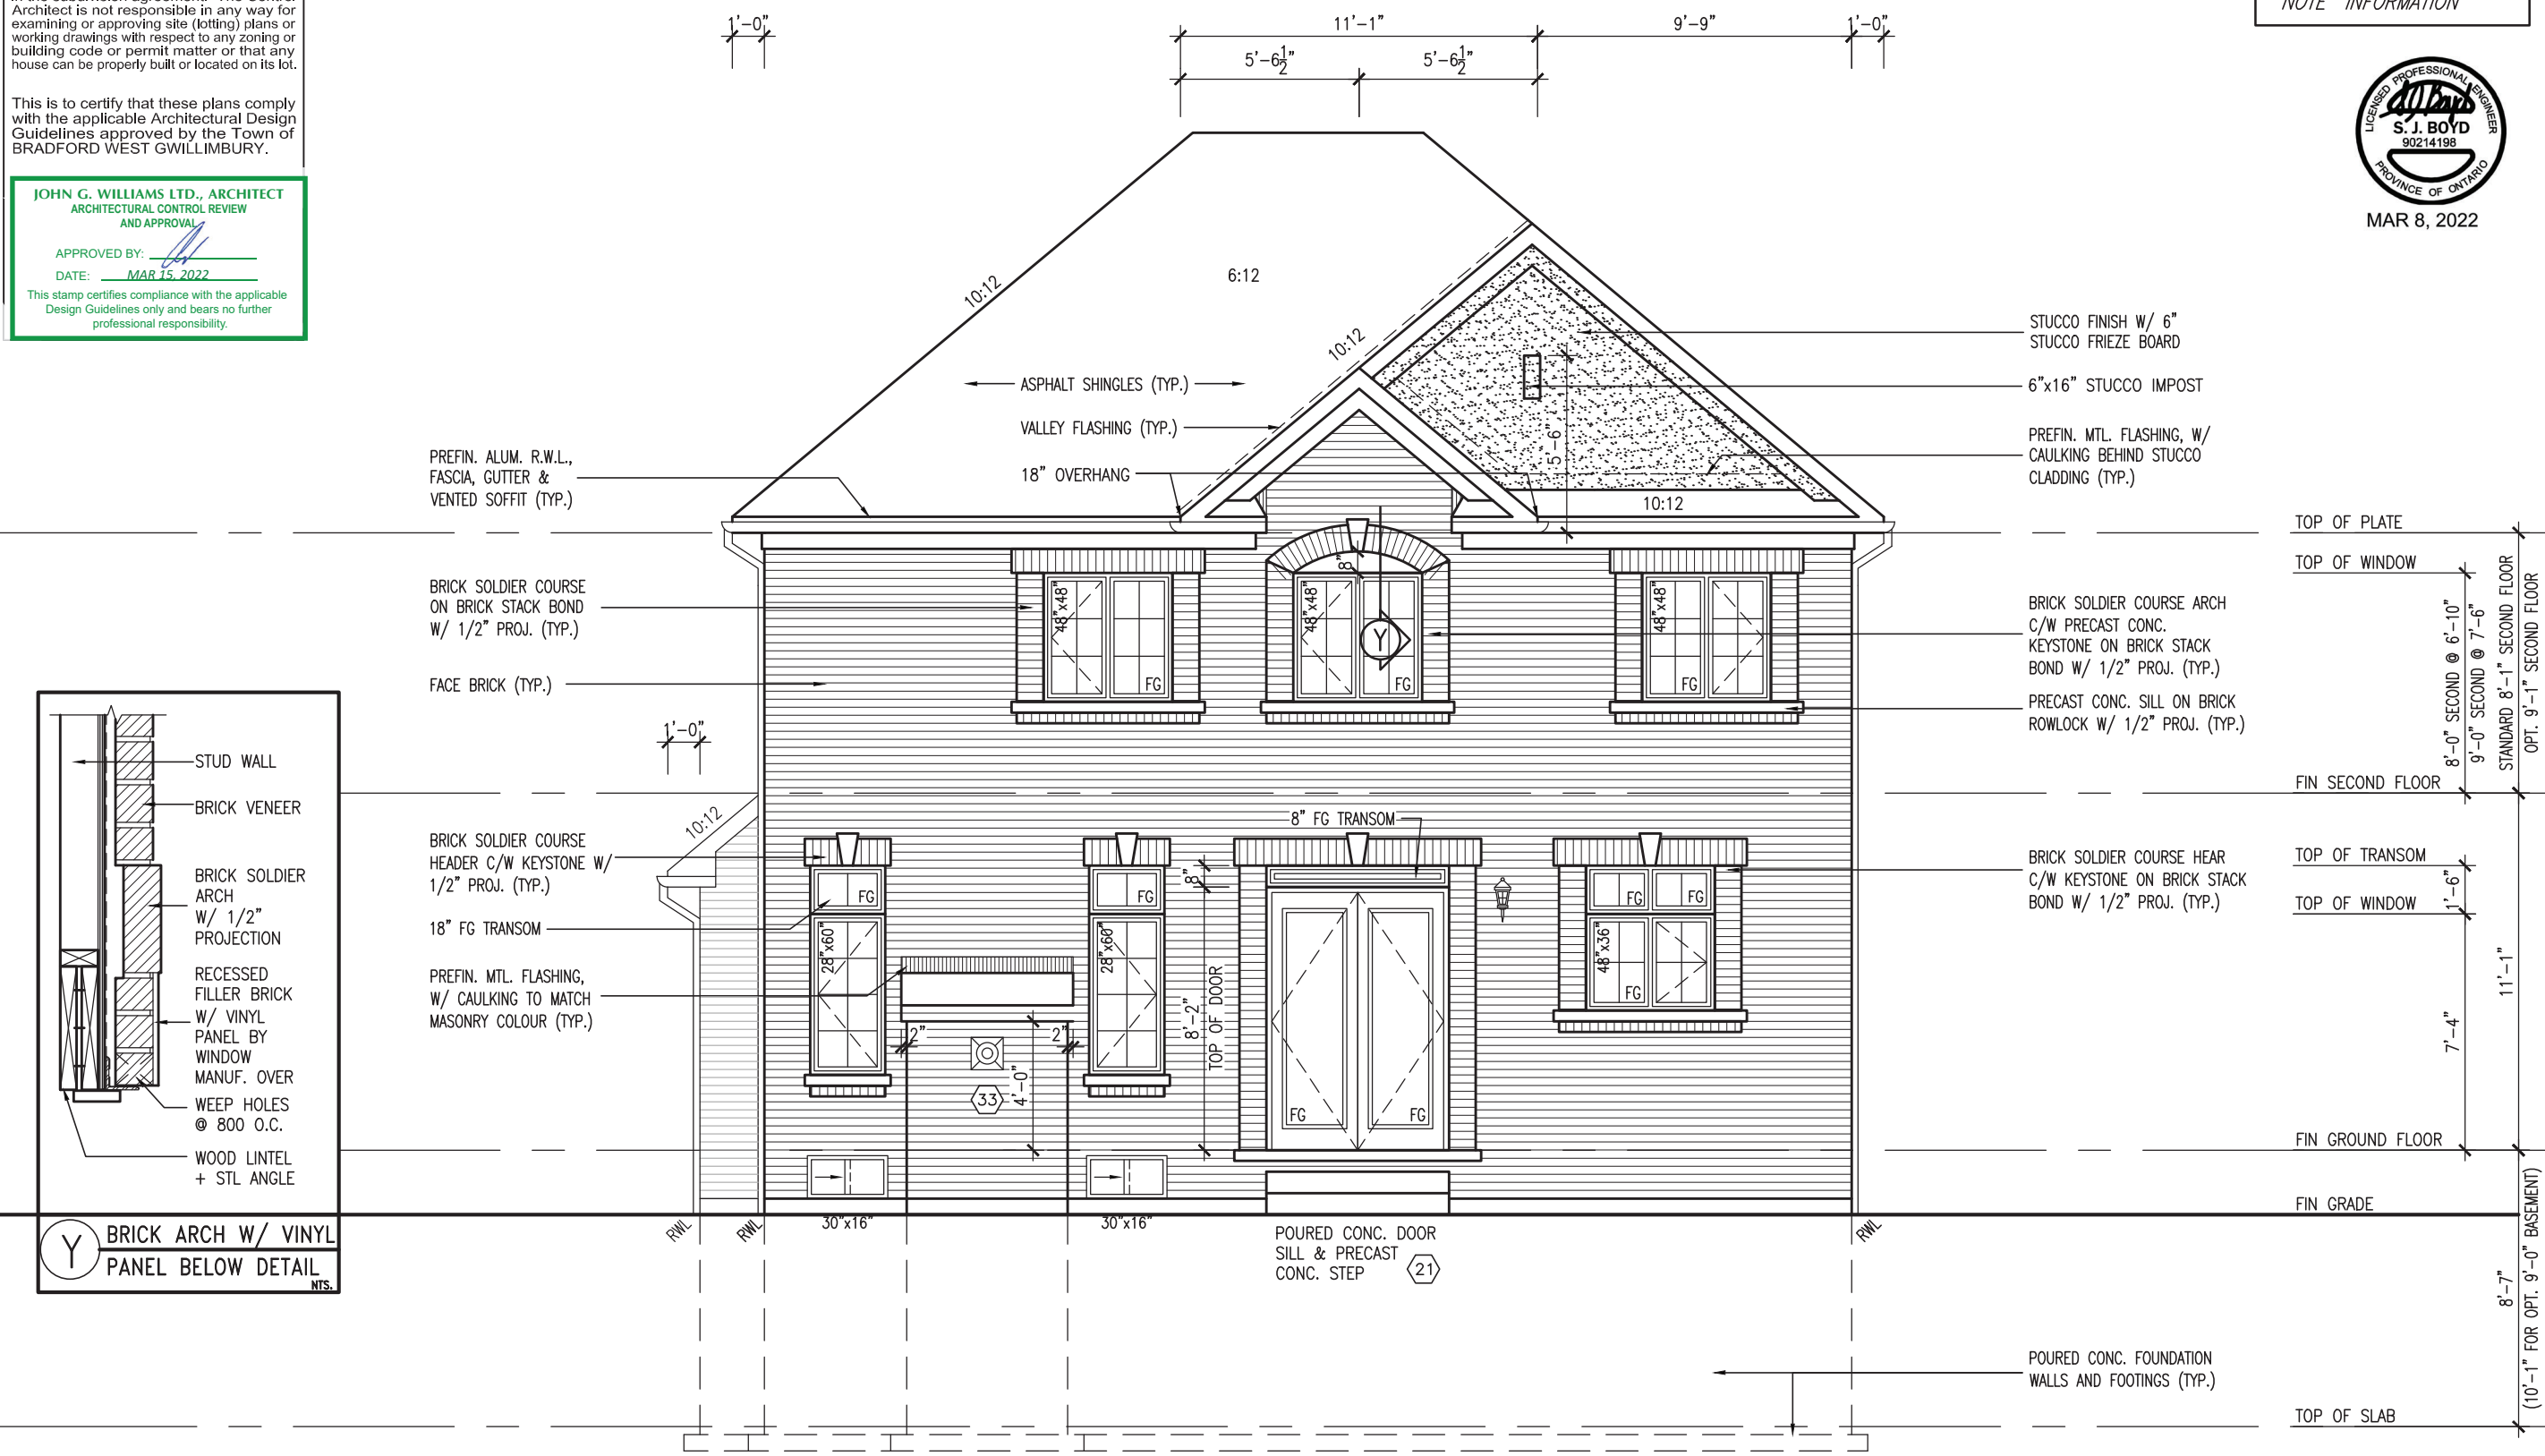

10' GROUND

REAR UPGRADE ELEVATION 'A'

- STUCCO FINISH W/ 6" STUCCO FRIEZE BOARD
- 6"x16" STUCCO IMPOST
- PREFIN. MTL. FLASHING, W/ CAULKING BEHIND STUCCO CLADDING (TYP.)
- TOP OF PLATE
- TOP OF WINDOW
- 8'-0" SECOND @ 6'-10"
- 9'-0" SECOND @ 7'-6"
- STANDARD 8'-1" SECOND FLOOR
- OPT. 9'-1" SECOND FLOOR
- FIN SECOND FLOOR
- BRICK SOLDIER COURSE ARCH C/W PRECAST CONC. KEYSTONE ON BRICK STACK BOND W/ 1/2" PROJ. (TYP.)
- PRECAST CONC. SILL ON BRICK ROWLOCK W/ 1/2" PROJ. (TYP.)
- FACE BRICK (TYP.)
- BRICK SOLDIER COURSE ON BRICK STACK BOND W/ 1/2" PROJ. (TYP.)
- PREFIN. ALUM. R.W.L., FASCIA, GUTTER & VENTED SOFFIT (TYP.)
- ASPHALT SHINGLES (TYP.)
- VALLEY FLASHING (TYP.)
- 18" OVERHANG
- 10:12
- 6:12
- 10:12
- 10:12
- 11'-1"
- 9'-9"
- 5'-6 1/2"
- 5'-6 1/2"
- 1'-0"
- 1'-0"
- 1'-0"
- 1'-0"
- 8" FG TRANSOM
- BRICK SOLDIER COURSE HEAR C/W KEYSTONE ON BRICK STACK BOND W/ 1/2" PROJ. (TYP.)
- TOP OF TRANSOM
- TOP OF WINDOW
- 1'-6"
- 7'-4"
- 11'-1"
- FIN GROUND FLOOR
- FIN GRADE
- POURED CONC. DOOR SILL & PRECAST CONC. STEP (21)
- POURED CONC. FOUNDATION WALLS AND FOOTINGS (TYP.)
- TOP OF SLAB
- 8'-7"
- (10'-1" FOR OPT. 9'-0" BASEMENT)

BAYVIEW WELLINGTON

GREEN VALLEY EAST

BRADFORD, ONTARIO

S42-19

project no. 16023

drawing no. 48

file name 16023-S42-19

checked by JMW 3/16" = 1'-0"

drawn by TP

date OCTOBER 2021

REAR UPGRADE ELEVATION 'A'

VAS DESIGN

255 Consumers Rd, Suite 120
 Toronto, ON M2J 1R4
 t 416.630.2255 f 416.630.4782
 vasdesign.com

Wellington Jno-Baptiste 25591 BCIN 42658

name Jno-Baptiste

registration information VAS Design Inc.

contractor must verify all dimensions on the job and report any discrepancy to the Designer before proceeding with the work. All drawings and specifications are instruments of service and the property of the Designer which must be returned at the completion of the work. Drawings are not to be scaled.

9					
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3	REVISED AS PER ENG COMMENTS	MAR 03-22	RC		
2	REVISED AS PER FLOOR / ROOF LAYOUT	FEB 24-22	RC		
1	ISSUED FOR CLIENT REVIEW	NOV 26-21	VAS		
no.	description	date	by		

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JOHN G. WILLIAMS LTD., ARCHITECT
 ARCHITECTURAL CONTROL REVIEW
 AND APPROVAL


APPROVED BY:

DATE: MAR 15, 2022


This stamp certifies compliance with the applicable Design Guidelines only and bears no further professional responsibility.

R.W.L. AS REQUIRED &
 AS PER MUNICIPALITY

NOTE: REFER TO FRONT
 ELEVATION FOR TYPICAL
 NOTE INFORMATION

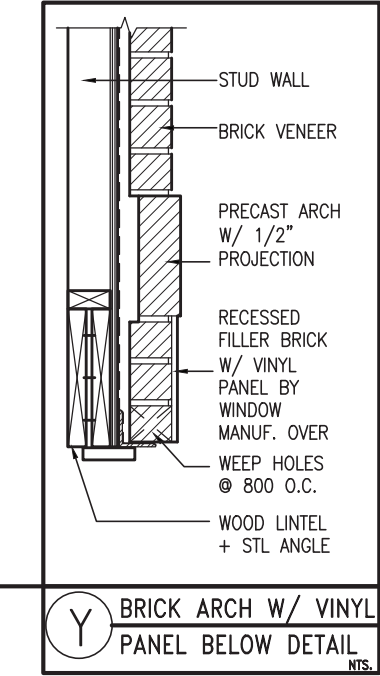

10' GROUND

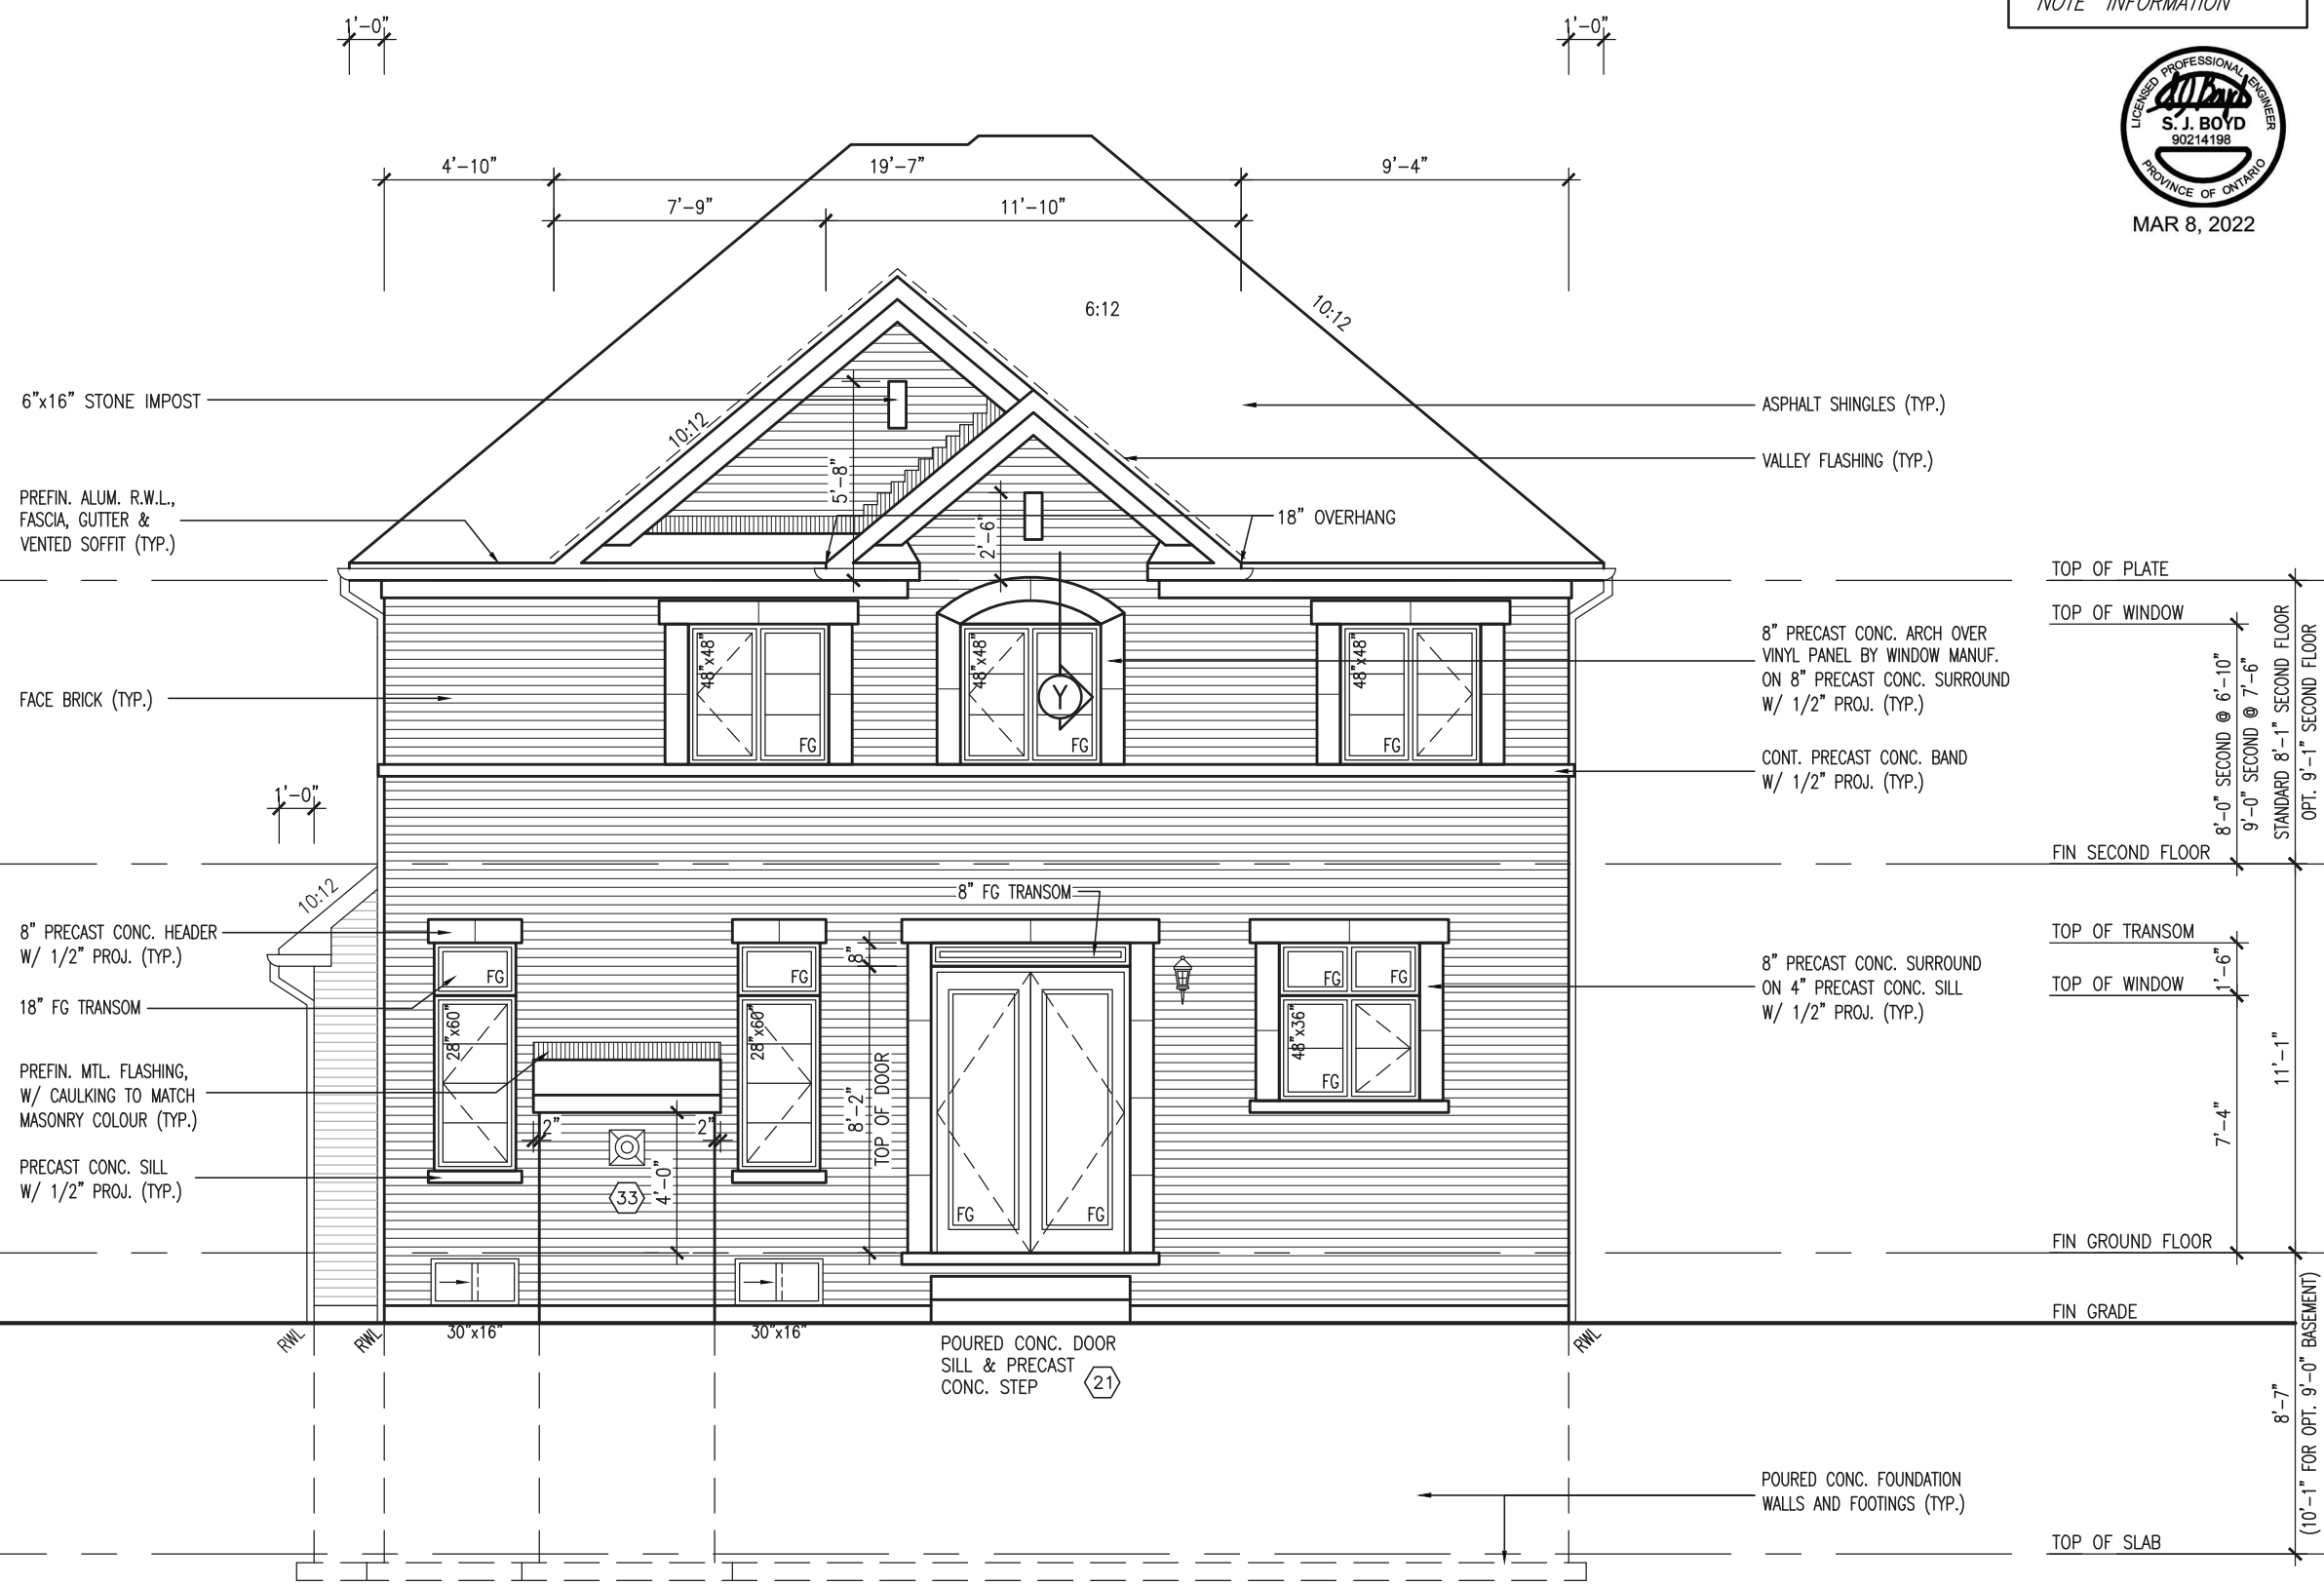

REAR UPGRADE ELEVATION 'B'

project no. 16023		drawing no. 49	
project name GREEN VALLEY EAST		municipality BRADFORD, ONTARIO	
date OCTOBER 2021		checked by JMW	
scale 3/16" = 1'-0"		drawn by TP	
project name BAYVIEW WELLINGTON		municipality BRADFORD, ONTARIO	
project no. S42-19		drawing no. 49	
project name GREEN VALLEY EAST		municipality BRADFORD, ONTARIO	
date OCTOBER 2021		checked by JMW	
scale 3/16" = 1'-0"		drawn by TP	
<p>VAS DESIGN 255 Consumers Rd. Suite 120 Toronto, ON M2J 1R4 t 416.630.2255 f 416.630.4782 vasdesign.com</p>			
The undersigned has reviewed and takes responsibility for this design and has the qualifications and meets the requirements set out in the Ontario Building Code to be a Designer.		Wellington Jno-Baptiste registration information VAS Design Inc. name VAS Design Inc. BIN 42658	
Contractor must verify all dimensions on the job and report any discrepancy to the Designer before proceeding with the work. All drawings and specifications are instruments of service and the property of the Designer which must be returned at the completion of the work. Drawings are not to be scaled.		MAR 03-22 RC FEB 24-22 RC NOV 26-21 VAS	
3 REVISED AS PER ENG COMMENTS 2 REVISED AS PER FLOOR / ROOF LAYOUT 1 ISSUED FOR CLIENT REVIEW		date by	
9 . 8 . 7 . 6 . 5 . 4 .		(10'-1" FOR OPT. 9'-0" BASEMENT) 8'-7" 11'-1" 7'-4" 1'-6" 8'-0" SECOND @ 6'-10" 9'-0" SECOND @ 7'-6" STANDARD 8'-1" SECOND FLOOR OPT. 9'-1" SECOND FLOOR TOP OF WINDOW TOP OF PLATE FIN SECOND FLOOR TOP OF TRANSOM TOP OF WINDOW FIN GROUND FLOOR FIN GRADE TOP OF SLAB	

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JOHN G. WILLIAMS LTD., ARCHITECT
ARCHITECTURAL CONTROL REVIEW
AND APPROVAL

APPROVED BY: 
DATE: MAR 15, 2022

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R.W.L. AS REQUIRED &
AS PER MUNICIPALITY

NOTE: REFER TO FRONT
ELEVATION FOR TYPICAL
NOTE INFORMATION



MAR 8, 2022



10' GROUND

REAR UPGRADE ELEVATION 'C'

PREFIN. ALUM. R.W.L.,
FASCIA, CUTTER &
VENTED SOFFIT (TYP.)

PRECAST CONC. SILL
W/ 1/2" PROJ. (TYP.)

STUCCO FINISH (TYP.)

POURED CONC. FOUNDATION
WALLS AND FOOTINGS (TYP.)

- TOP OF PLATE
- TOP OF WINDOW
- 8'-0" SECOND @ 6'-10"
- 9'-0" SECOND @ 7'-6"
- STANDARD 8'-1" SECOND FLOOR
- OPT. 9'-1" SECOND FLOOR
- FIN SECOND FLOOR
- TOP OF TRANSOM
- TOP OF WINDOW
- 7'-4"
- 11'-1"
- FIN GROUND FLOOR
- FIN GRADE
- 8'-7"
- (10'-1" FOR OPT. 9'-0" BASEMENT)
- TOP OF SLAB

project no.	16023
drawing no.	50
project name	GREEN VALLEY EAST
municipality	BRADFORD, ONTARIO
date	OCTOBER 2021
checked by	JWM
drawn by	TP
scale	3/16" = 1'-0"
file name	16023-S42-19
date	16023-S42-19.dwg - Tue - Mar 8 2022 - 1:01 PM
author	RICHARD - H. ARCHIVE WORKING \2016\16023-BW\Units\42\16023-S42-19.dwg - Tue - Mar 8 2022 - 1:01 PM

VAS DESIGN

255 Consumers Rd, Suite 120
Toronto, ON M2J 1R4
t 416.630.2255 f 416.630.4782
vasdesign.com

9	the undersigned has reviewed and takes responsibility for this design and has the qualifications and meets the requirements set out in the Ontario Building Code to be a Designer.	qualification information	25591	BCIN	42658
8	Wellington Jno-Baptiste	signature			
7	Wellington Jno-Baptiste	name			
6	VAS Design Inc.	registration information			
5		name			
4		registration information			
3	MAR 03-22 RC	date			
2	FEB 24-22 RC	date			
1	NOV 26-21 VAS	date			
		description			

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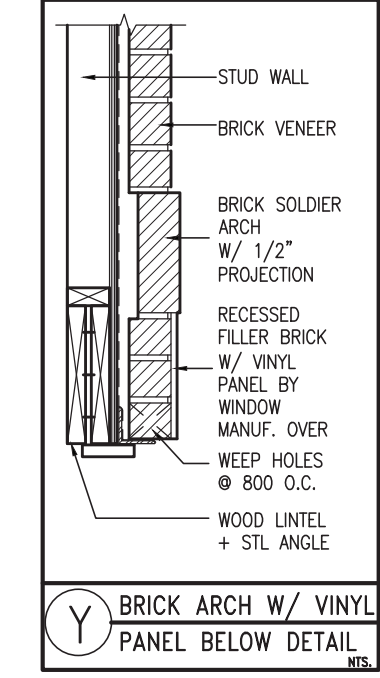
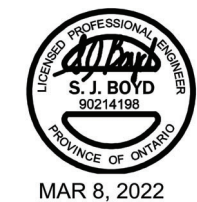
JOHN G. WILLIAMS LTD., ARCHITECT
 ARCHITECTURAL CONTROL REVIEW
 AND APPROVAL

APPROVED BY: 
 DATE: MAR 15, 2022

This stamp certifies compliance with the applicable Design Guidelines only and bears no further professional responsibility.

R.W.L. AS REQUIRED &
 AS PER MUNICIPALITY

*NOTE: REFER TO FRONT
 ELEVATION FOR TYPICAL
 NOTE INFORMATION*



10' GROUND



PREFIN. ALUM. R.W.L.,
 FASCIA, GUTTER &
 VENTED SOFFIT (TYP.)

BRICK SOLDIER COURSE
 ON BRICK STACK BOND
 W/ 1/2" PROJ. (TYP.)

FACE BRICK (TYP.)

BRICK SOLDIER COURSE
 HEADER C/W KEystone W/
 1/2" PROJ. (TYP.)

18" FG TRANSOM

PREFIN. MTL. FLASHING,
 W/ CAULKING TO MATCH
 MASONRY COLOUR (TYP.)

ASPHALT SHINGLES (TYP.)
 VALLEY FLASHING (TYP.)
 18" OVERHANG

STUCCO FINISH W/ 6"
 STUCCO FRIEZE BOARD

6"x16" STUCCO IMPOST

PREFIN. MTL. FLASHING, W/
 CAULKING BEHIND STUCCO
 CLADDING (TYP.)

BRICK SOLDIER COURSE ARCH
 C/W PRECAST CONC.
 KEystone ON BRICK STACK
 BOND W/ 1/2" PROJ. (TYP.)


PRECAST CONC. SILL ON BRICK
 ROWLOCK W/ 1/2" PROJ. (TYP.)

BRICK SOLDIER COURSE HEAR
 C/W KEystone ON BRICK STACK
 BOND W/ 1/2" PROJ. (TYP.)

PROVIDE 2"x4" P.T. WOOD
 HANDRAIL GUARD W/ 2"x2" P.T.
 WOOD PICKETS @ 4" MAX.

6"x6" P.T. WOOD POST C/W
 GALV. METAL CAP AND METAL
 SHOE SET INTO 12" DIA. SONO
 TUBES TO EXTEND 6" ABOVE
 GRADE AND 5'-0" BELOW GRADE.

POURED CONC. FOUNDATION
 WALLS AND FOOTINGS (TYP.)

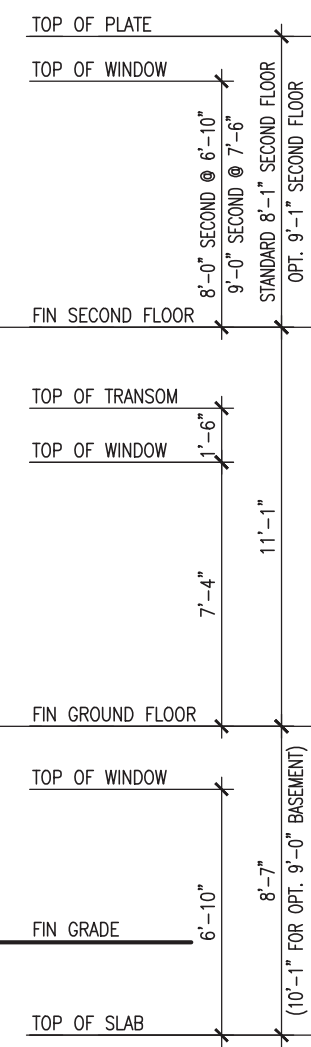

REAR UPGRADE ELEVATION 'A' - W.O.D. CONDITION

BAYVIEW WELLINGTON		S42-19	
project name	GREEN VALLEY EAST	municipality	BRADFORD, ONTARIO
project no.	16023	project no.	16023
date	OCTOBER 2021	drawing no.	51
checked by	JWM	file name	16023-S42-19
drawn by	TP	scale	3/16" = 1'-0"
<p>REAR UPGRADE ELEVATION 'A' - W.O.D. COND.</p> <p>RICHARD - H:\ARCHIVE\WORKING\2016\16023.BW\Units\42\16023-S42-19.dwg - Tue - Mar 8 2022 - 1:01 PM</p>			
<p>VAS3 DESIGN</p> <p>255 Consumers Rd, Suite 120 Toronto, ON M2J 1R4 t 416.630.2255 f 416.630.4782 vas3design.com</p>			
<p>the undersigned has reviewed and takes responsibility for this design and has the qualifications and meets the requirements set out in the Ontario Building Code to be a Designer.</p>		<p>Wellington Jno-Baptiste 25551 BCIN 42658</p>	
<p>3. REVISED AS PER ENG COMMENTS MAR 03-22 RC</p>		<p>date</p>	
<p>2. REVISED AS PER FLOOR / ROOF LAYOUT FEB 24-22 RC</p>		<p>by</p>	
<p>1. ISSUED FOR CLIENT REVIEW NOV 26-21 VAS3</p>		<p>description</p>	

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JOHN G. WILLIAMS LTD., ARCHITECT
ARCHITECTURAL CONTROL REVIEW
AND APPROVAL

APPROVED BY: _____
DATE: MAR 15, 2022

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R.W.L. AS REQUIRED &
AS PER MUNICIPALITY

*NOTE: REFER TO FRONT
ELEVATION FOR TYPICAL
NOTE INFORMATION*



MAR 8, 2022




6"x16" STONE IMPOST
PREFIN. ALUM. R.W.L.,
FASCIA, GUTTER &
VENTED SOFFIT (TYP.)

ASPHALT SHINGLES (TYP.)
VALLEY FLASHING (TYP.)

FACE BRICK (TYP.)

8" PRECAST CONC. ARCH OVER
VINYL PANEL BY WINDOW MANUF.
ON 8" PRECAST CONC. SURROUND
W/ 1/2" PROJ. (TYP.)

CONT. PRECAST CONC. BAND
W/ 1/2" PROJ. (TYP.)

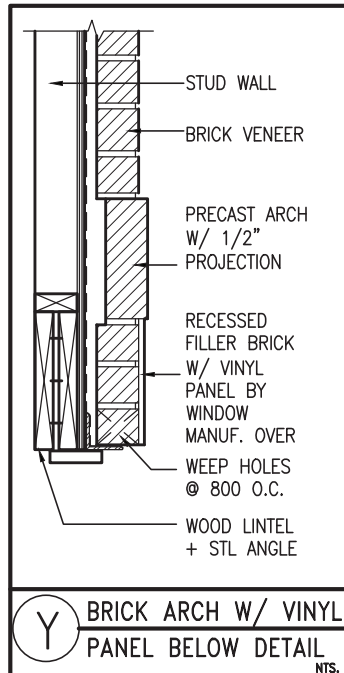

8" PRECAST CONC. HEADER
W/ 1/2" PROJ. (TYP.)
18" FG TRANSOM
PREFIN. MTL. FLASHING,
W/ CAULKING TO MATCH
MASONRY COLOUR (TYP.)
PRECAST CONC. SILL
W/ 1/2" PROJ. (TYP.)

8" PRECAST CONC. SURROUND
ON 4" PRECAST CONC. SILL
W/ 1/2" PROJ. (TYP.)

PROVIDE 2"x4" P.T. WOOD
HANDRAIL GUARD W/ 2"x2" P.T.
WOOD PICKETS @ 4" MAX.

Y BRICK ARCH W/ VINYL
PANEL BELOW DETAIL
NTS.

6"x6" P.T. WOOD POST C/W
GALV. METAL CAP AND METAL
SHOE SET INTO 12" DIA. SONO
TUBES TO EXTEND 6" ABOVE
GRADE AND 5'-0" BELOW GRADE.

POURED CONC. FOUNDATION
WALLS AND FOOTINGS (TYP.)

10' GROUND

REAR UPGRADE ELEVATION 'B' - W.O.D. CONDITION

project no. 16023		drawing no. 52	
project name BAYVIEW WELLINGTON		municipality BRADFORD, ONTARIO	
project name GREEN VALLEY EAST		date OCTOBER 2021	
project name REAR UPGRADE ELEVATION 'B' - W.O.D. COND.		checked by JWM	
scale 3/16" = 1'-0"		drawn by TP	
checked by JWM		drawn by TP	
file name 16023-S42-19		date MAR 8, 2022	
file name 16023-S42-19		time 1:01 PM	

255 Consumers Rd. Suite 120 Toronto, ON M2J 1R4 t 416.630.2255 f 416.630.4782 v3design.com	
The undersigned has reviewed and takes responsibility for this design and has the qualifications and meets the requirements set out in the Ontario Building Code to be a Designer.	
name Wellington Jno-Baptiste	BCIN 25591
registration information VAS Design Inc.	BCIN 42658
name MAR 03-22 RC	date MAR 03-22
description REVISED AS PER ENG COMMENTS	date FEB 24-22
name NOV 26-21 VAS3	date NOV 26-21
description ISSUED FOR CLIENT REVIEW	date NOV 26-21
name NOV 26-21 VAS3	date NOV 26-21
description REVISED AS PER ENG COMMENTS	date FEB 24-22
name MAR 03-22 RC	date MAR 03-22
description REVISED AS PER ENG COMMENTS	date FEB 24-22
name NOV 26-21 VAS3	date NOV 26-21
description ISSUED FOR CLIENT REVIEW	date NOV 26-21
name NOV 26-21 VAS3	date NOV 26-21
description REVISED AS PER ENG COMMENTS	date FEB 24-22
name MAR 03-22 RC	date MAR 03-22
description REVISED AS PER ENG COMMENTS	date FEB 24-22
name NOV 26-21 VAS3	date NOV 26-21
description ISSUED FOR CLIENT REVIEW	date NOV 26-21
name NOV 26-21 VAS3	date NOV 26-21
description REVISED AS PER ENG COMMENTS	date FEB 24-22
name MAR 03-22 RC	date MAR 03-22
description REVISED AS PER ENG COMMENTS	date FEB 24-22
name NOV 26-21 VAS3	date NOV 26-21
description ISSUED FOR CLIENT REVIEW	date NOV 26-21
name NOV 26-21 VAS3	date NOV 26-21

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JOHN G. WILLIAMS LTD., ARCHITECT
ARCHITECTURAL CONTROL REVIEW
AND APPROVAL

APPROVED BY:

DATE: MAR 15, 2022


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R.W.L. AS REQUIRED &
AS PER MUNICIPALITY

NOTE: REFER TO FRONT
ELEVATION FOR TYPICAL
NOTE INFORMATION



MAR 8, 2022

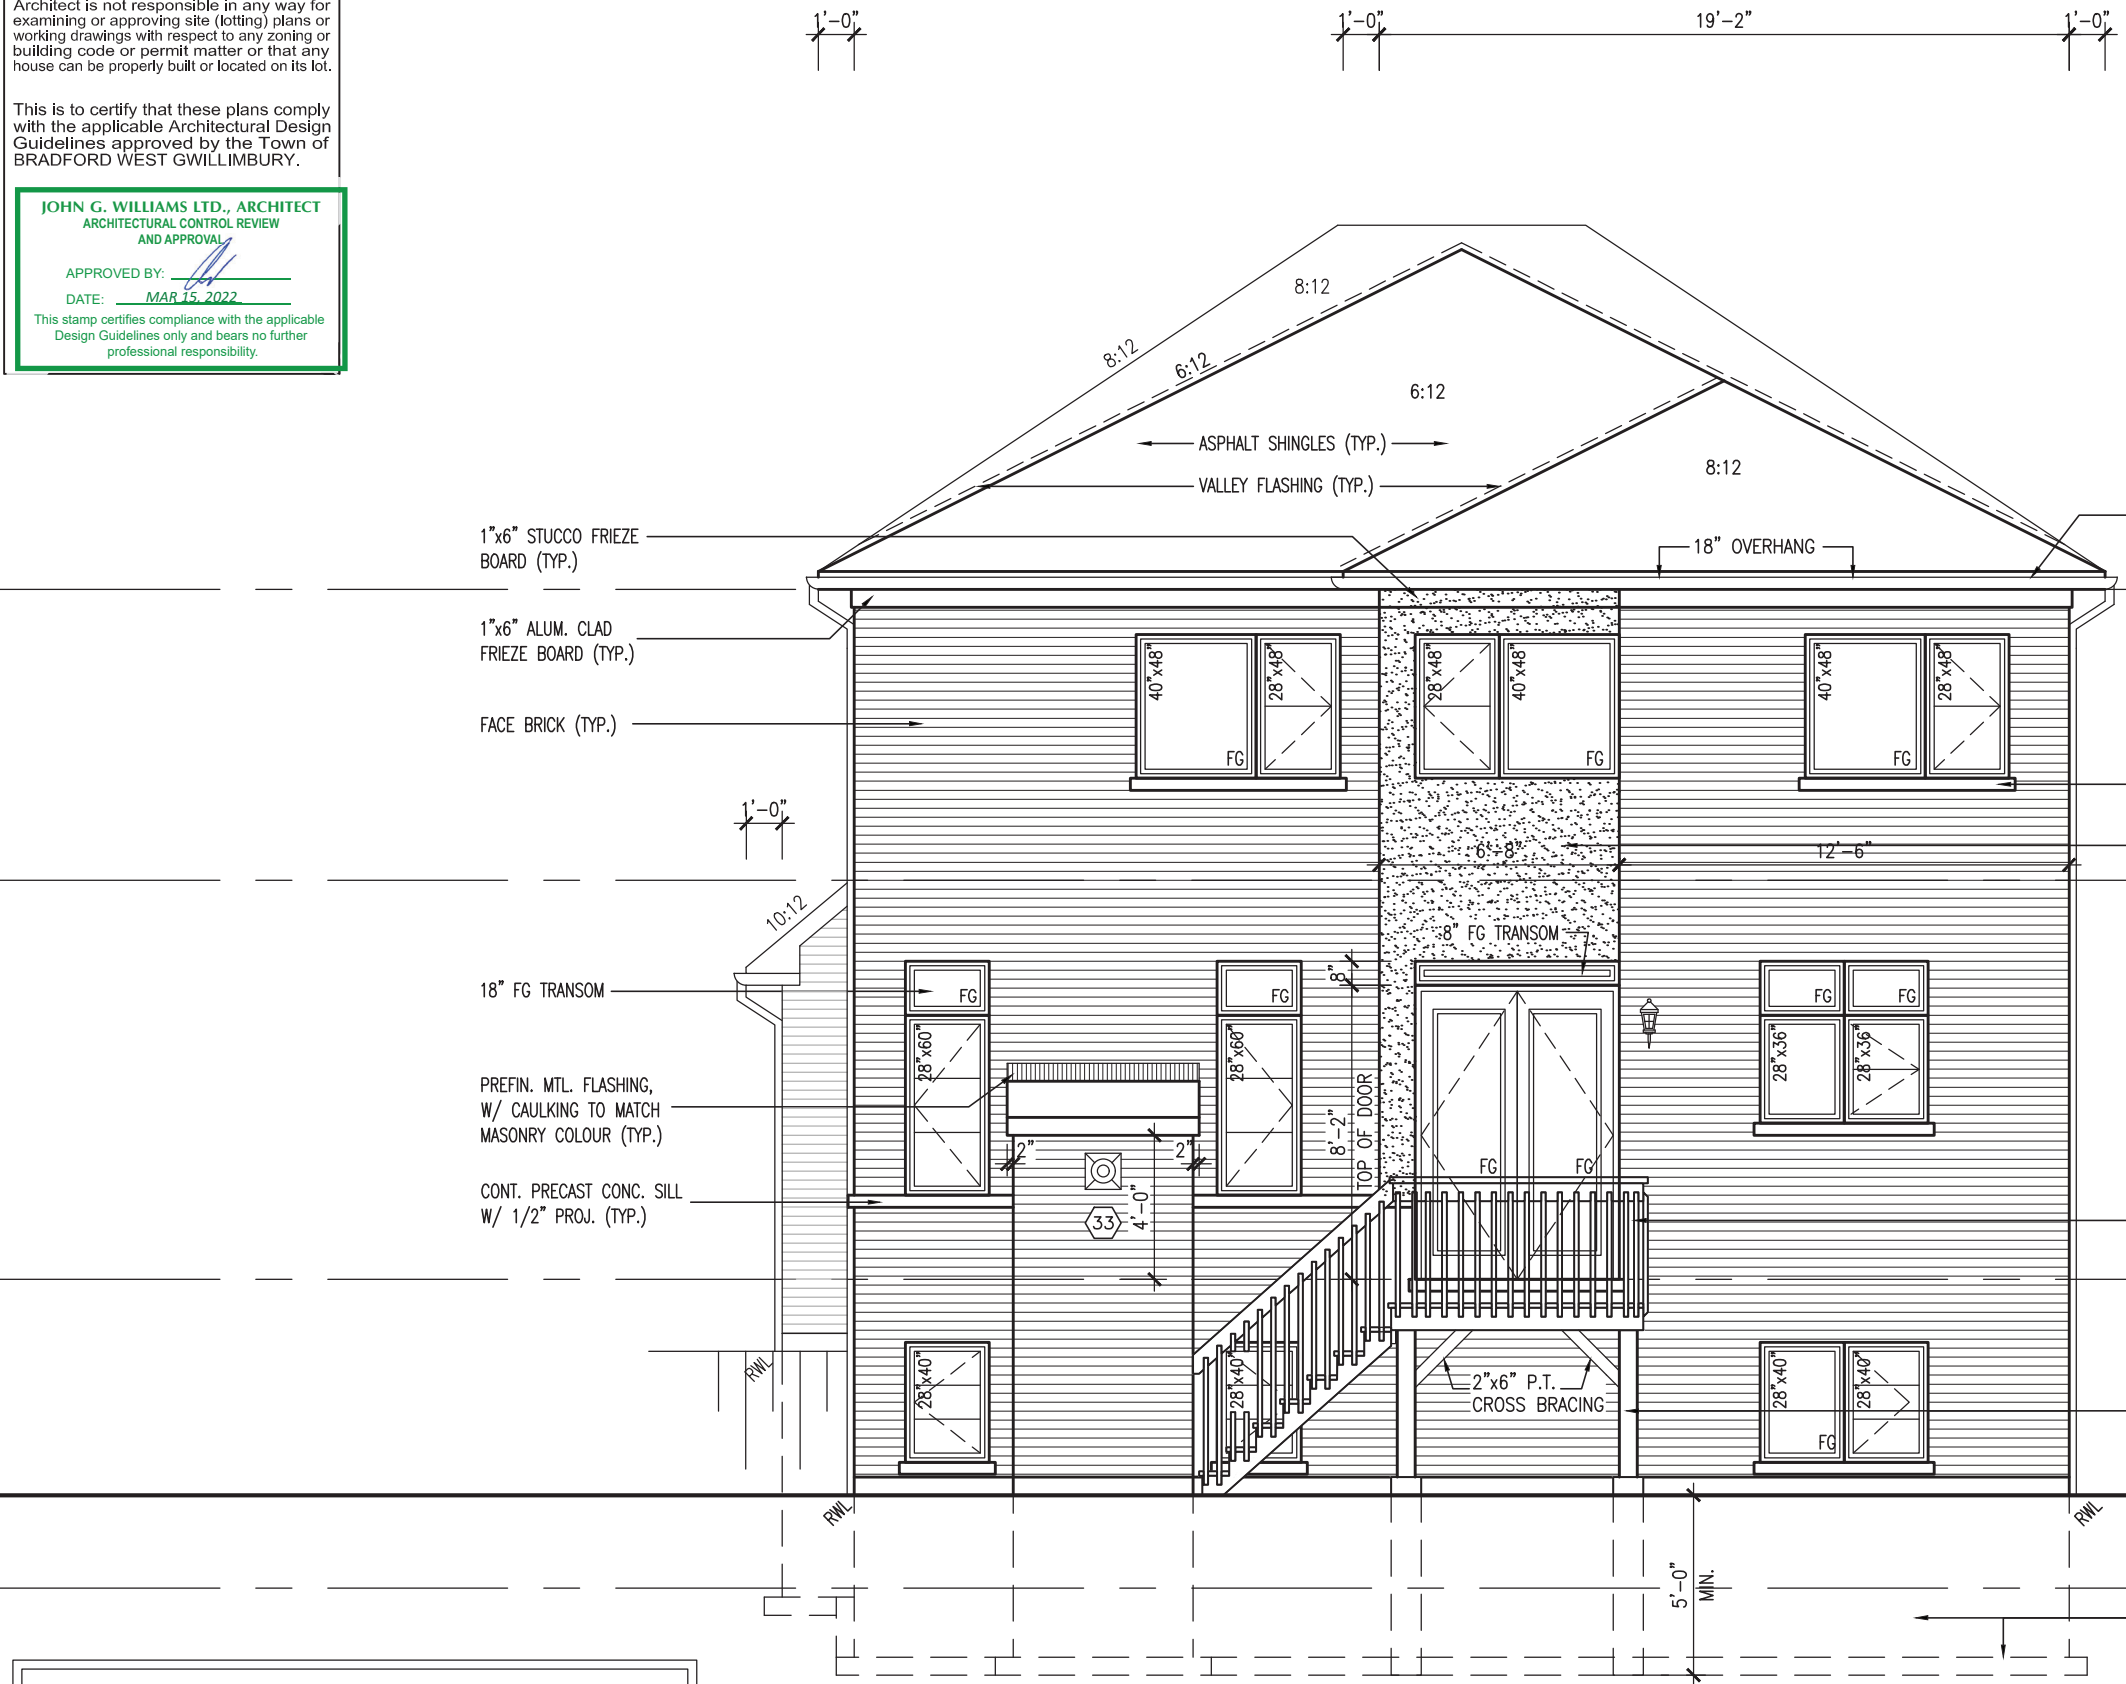

10' GROUND

REAR UPGRADE ELEVATION 'C' - W.O.D. CONDITION

PREFIN. ALUM. R.W.L.,
FASCIA, CUTTER &
VENTED SOFFIT (TYP.)

PRECAST CONC. SILL
W/ 1/2" PROJ. (TYP.)

PROVIDE 2"x4" P.T. WOOD
HANDRAIL GUARD W/ 2"x2" P.T.
WOOD PICKETS @ 4" MAX.

6"x6" P.T. WOOD POST C/W
GALV. METAL CAP AND METAL
SHOE SET INTO 12" DIA. SONO
TUBES TO EXTEND 6" ABOVE
GRADE AND 5'-0" BELOW GRADE.

POURED CONC. FOUNDATION
WALLS AND FOOTINGS (TYP.)

TOP OF PLATE	
TOP OF WINDOW	
FIN SECOND FLOOR	8'-0" SECOND @ 6'-10" 9'-0" SECOND @ 7'-6" STANDARD 8'-1" SECOND FLOOR OPT. 9'-1" SECOND FLOOR
TOP OF TRANSOM	
TOP OF WINDOW	1'-6"
FIN GROUND FLOOR	7'-4" 11'-1"
TOP OF WINDOW	
FIN GRADE	6'-10" 8'-7" (10'-1" FOR OPT. 9'-0" BASEMENT)
TOP OF SLAB	

BAYVIEW WELLINGTON		S42-19	
project name	GREEN VALLEY EAST	municipality	BRADFORD, ONTARIO
project no.	16023	project no.	16023
date	OCTOBER 2021	file name	16023-S42-19
checked by	JWM	scale	3/16" = 1'-0"
drawn by	TP	drawing no.	53
REAR UPGRADE ELEVATION 'C' - W.O.D. COND.			
255 Consumers Rd, Suite 120 Toronto, ON M2J 1R4 t 416.630.2255 f 416.630.4782 vasdesign.com			
name	Wellington Jno-Baptiste	BCIN	25591
registration information	VAS Design Inc.	BCIN	42658
no.	description	date	by
3	REVISED AS PER ENG COMMENTS	MAR 03-22	RC
2	REVISED AS PER FLOOR / ROOF LAYOUT	FEB 24-22	RC
1	ISSUED FOR CLIENT REVIEW	NOV 26-21	VA3

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JOHN G. WILLIAMS LTD., ARCHITECT
ARCHITECTURAL CONTROL REVIEW
AND APPROVAL

APPROVED BY:

DATE: MAR 15, 2022

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NOTE: REFER TO FRONT
ELEVATION FOR TYPICAL
NOTE INFORMATION




MAR 8, 2022

STUD WALL
BRICK VENEER
BRICK SOLDIER ARCH
W/ 1/2" PROJECTION
RECESSED FILLER BRICK
W/ VINYL
PANEL BY
WINDOW
MANUF. OVER
WEEP HOLES
@ 800 O.C.
WOOD LINTEL
+ STL ANGLE

Y BRICK ARCH W/ VINYL
PANEL BELOW DETAIL
NTS.

10' GROUND

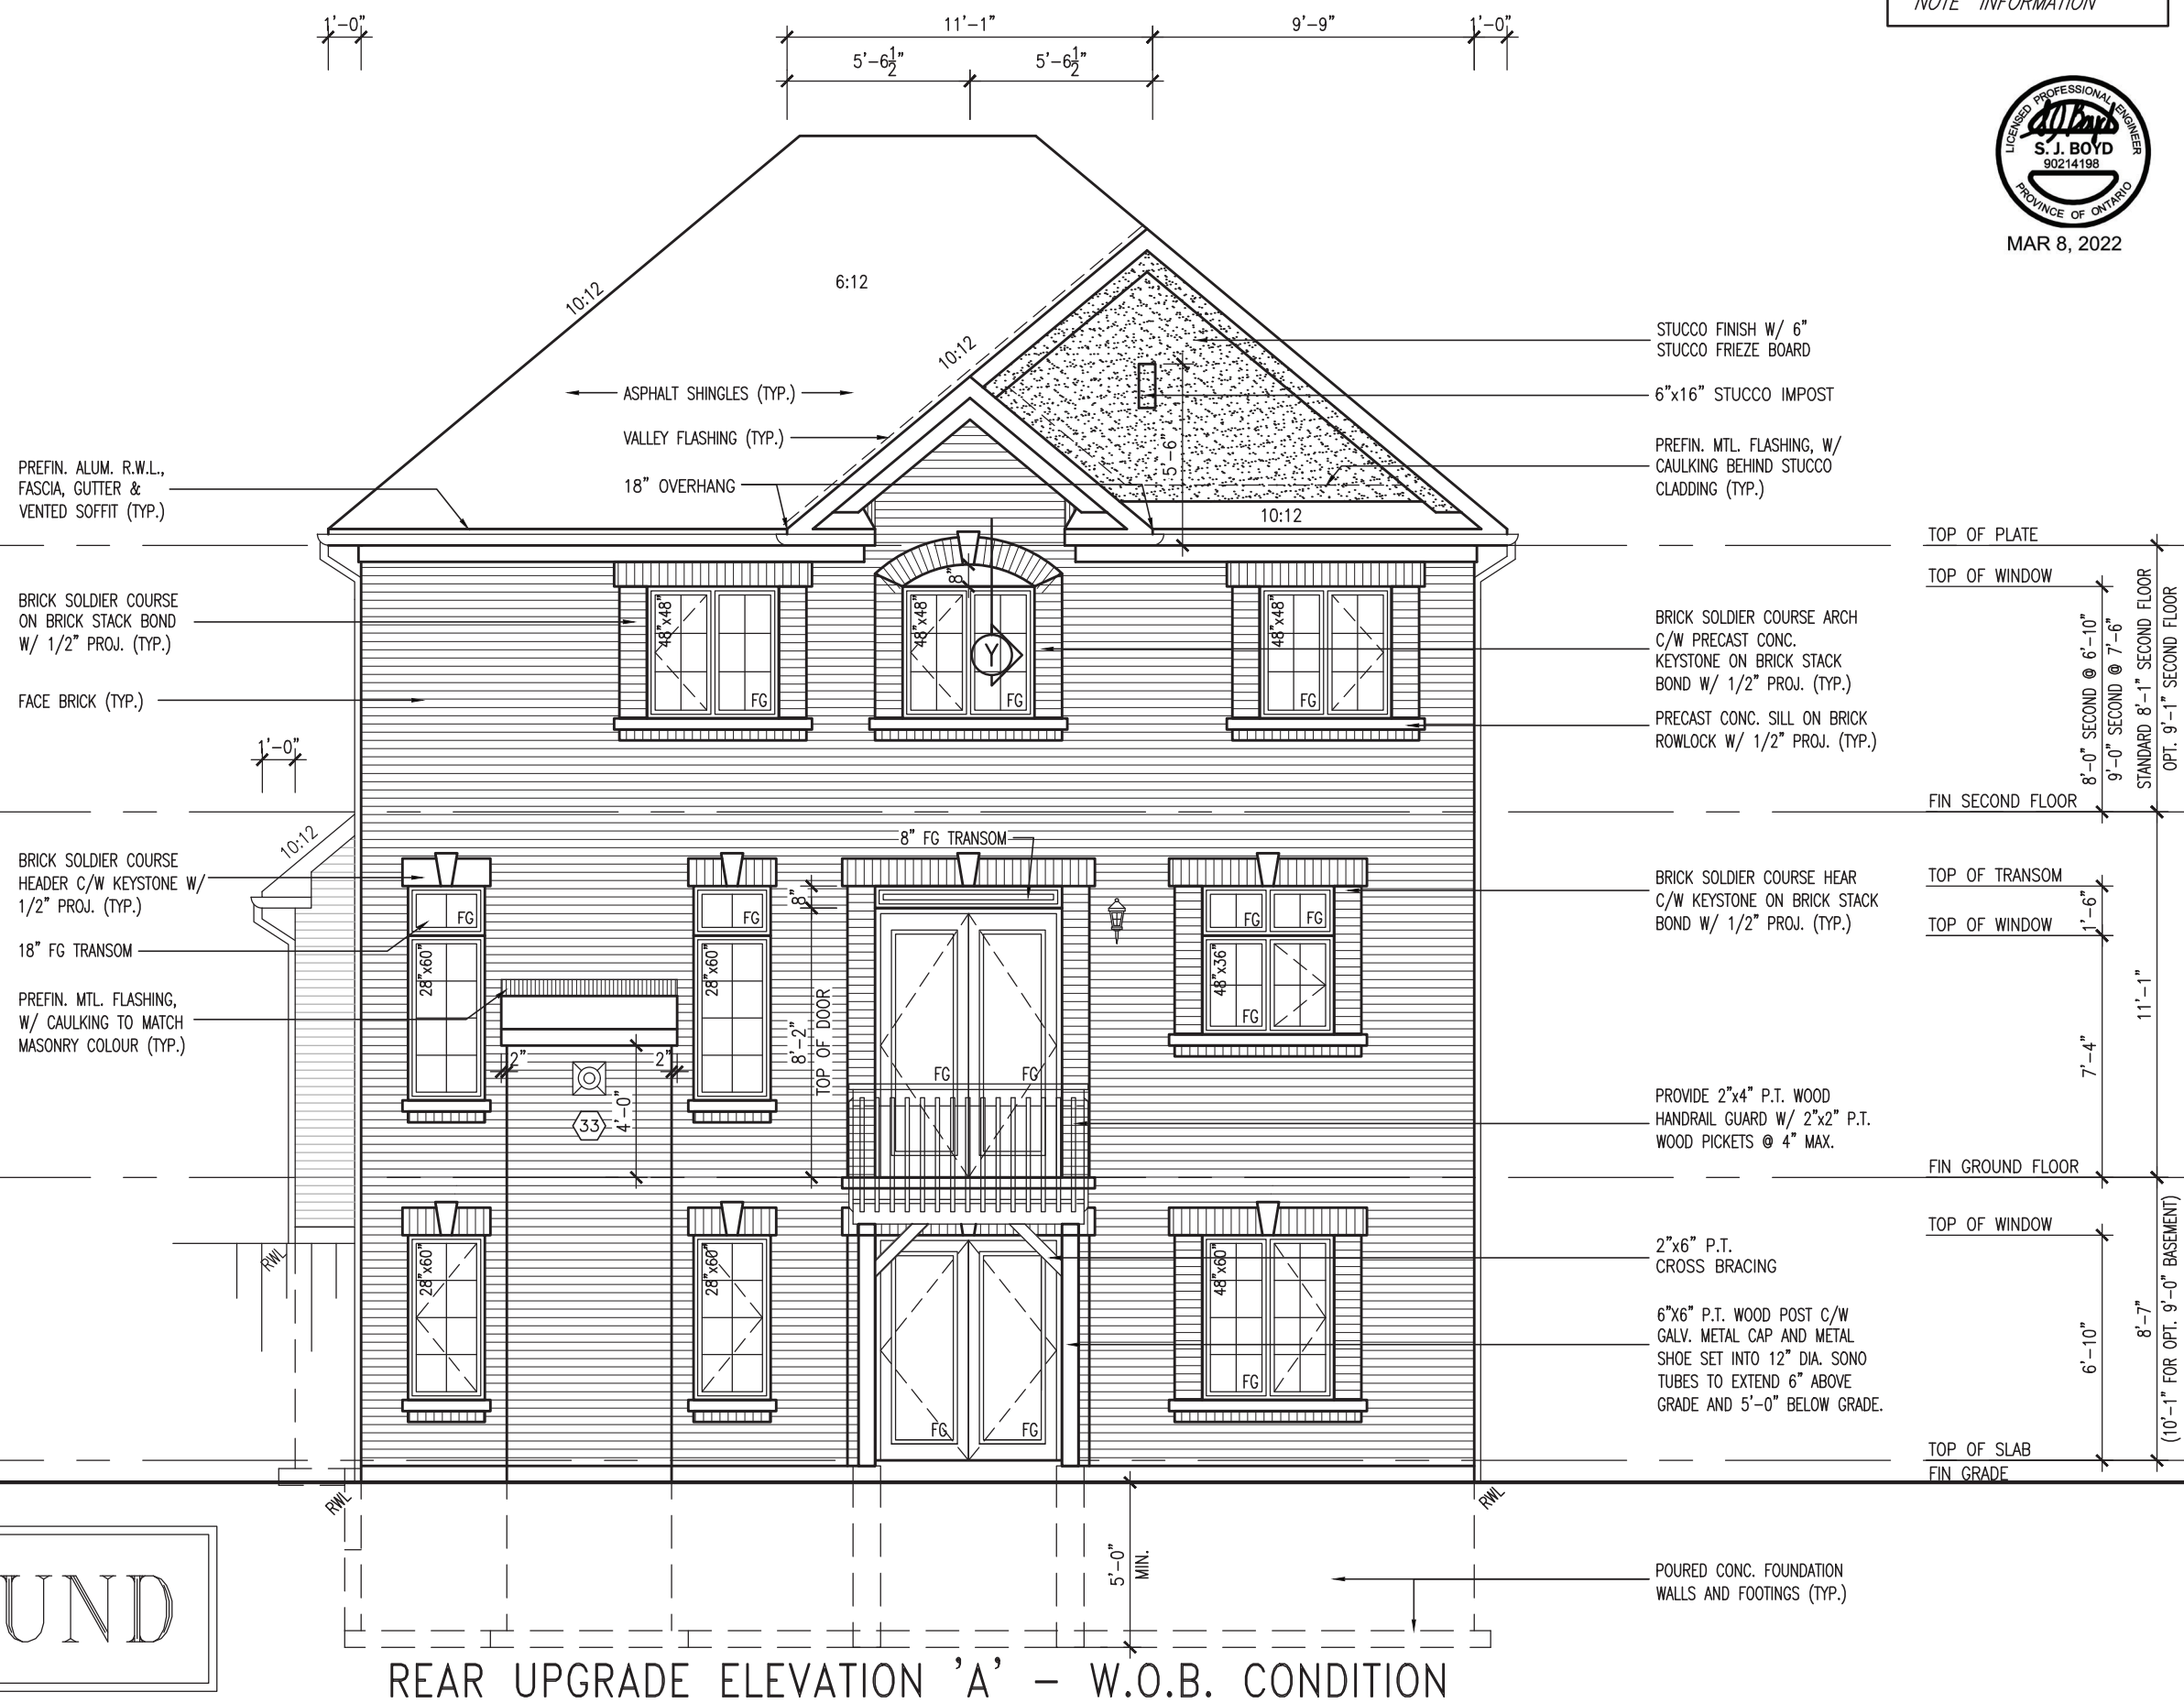

REAR UPGRADE ELEVATION 'A' - W.O.B. CONDITION



255 Consumers Rd. Suite 120
Toronto, ON M2J 1R4
t 416.630.2255 f 416.630.4782
va3design.com

Wellington Jno-Baptiste
BCIN 25591
42658

9	ISSUED FOR CLIENT REVIEW	NOV 26-21 VA3	date	by
8	REVISED AS PER ENG COMMENTS	MAR 03-22 RC		
7	REVISED AS PER FLOOR / ROOF LAYOUT	FEB 24-22 RC		
6				
5				
4				
3				
2				
1				

project name: **BAYVIEW WELLINGTON**
municipality: **BRADFORD, ONTARIO**
project no.: **16023**
drawing no.: **54**
file name: **16023-S42-19**
checked by: **JWM**
scale: **3/16" = 1'-0"**
date: **OCTOBER 2021**
drawn by: **TP**
project: **REAR UPGRADE ELEVATION 'A' - W.O.D. COND.**

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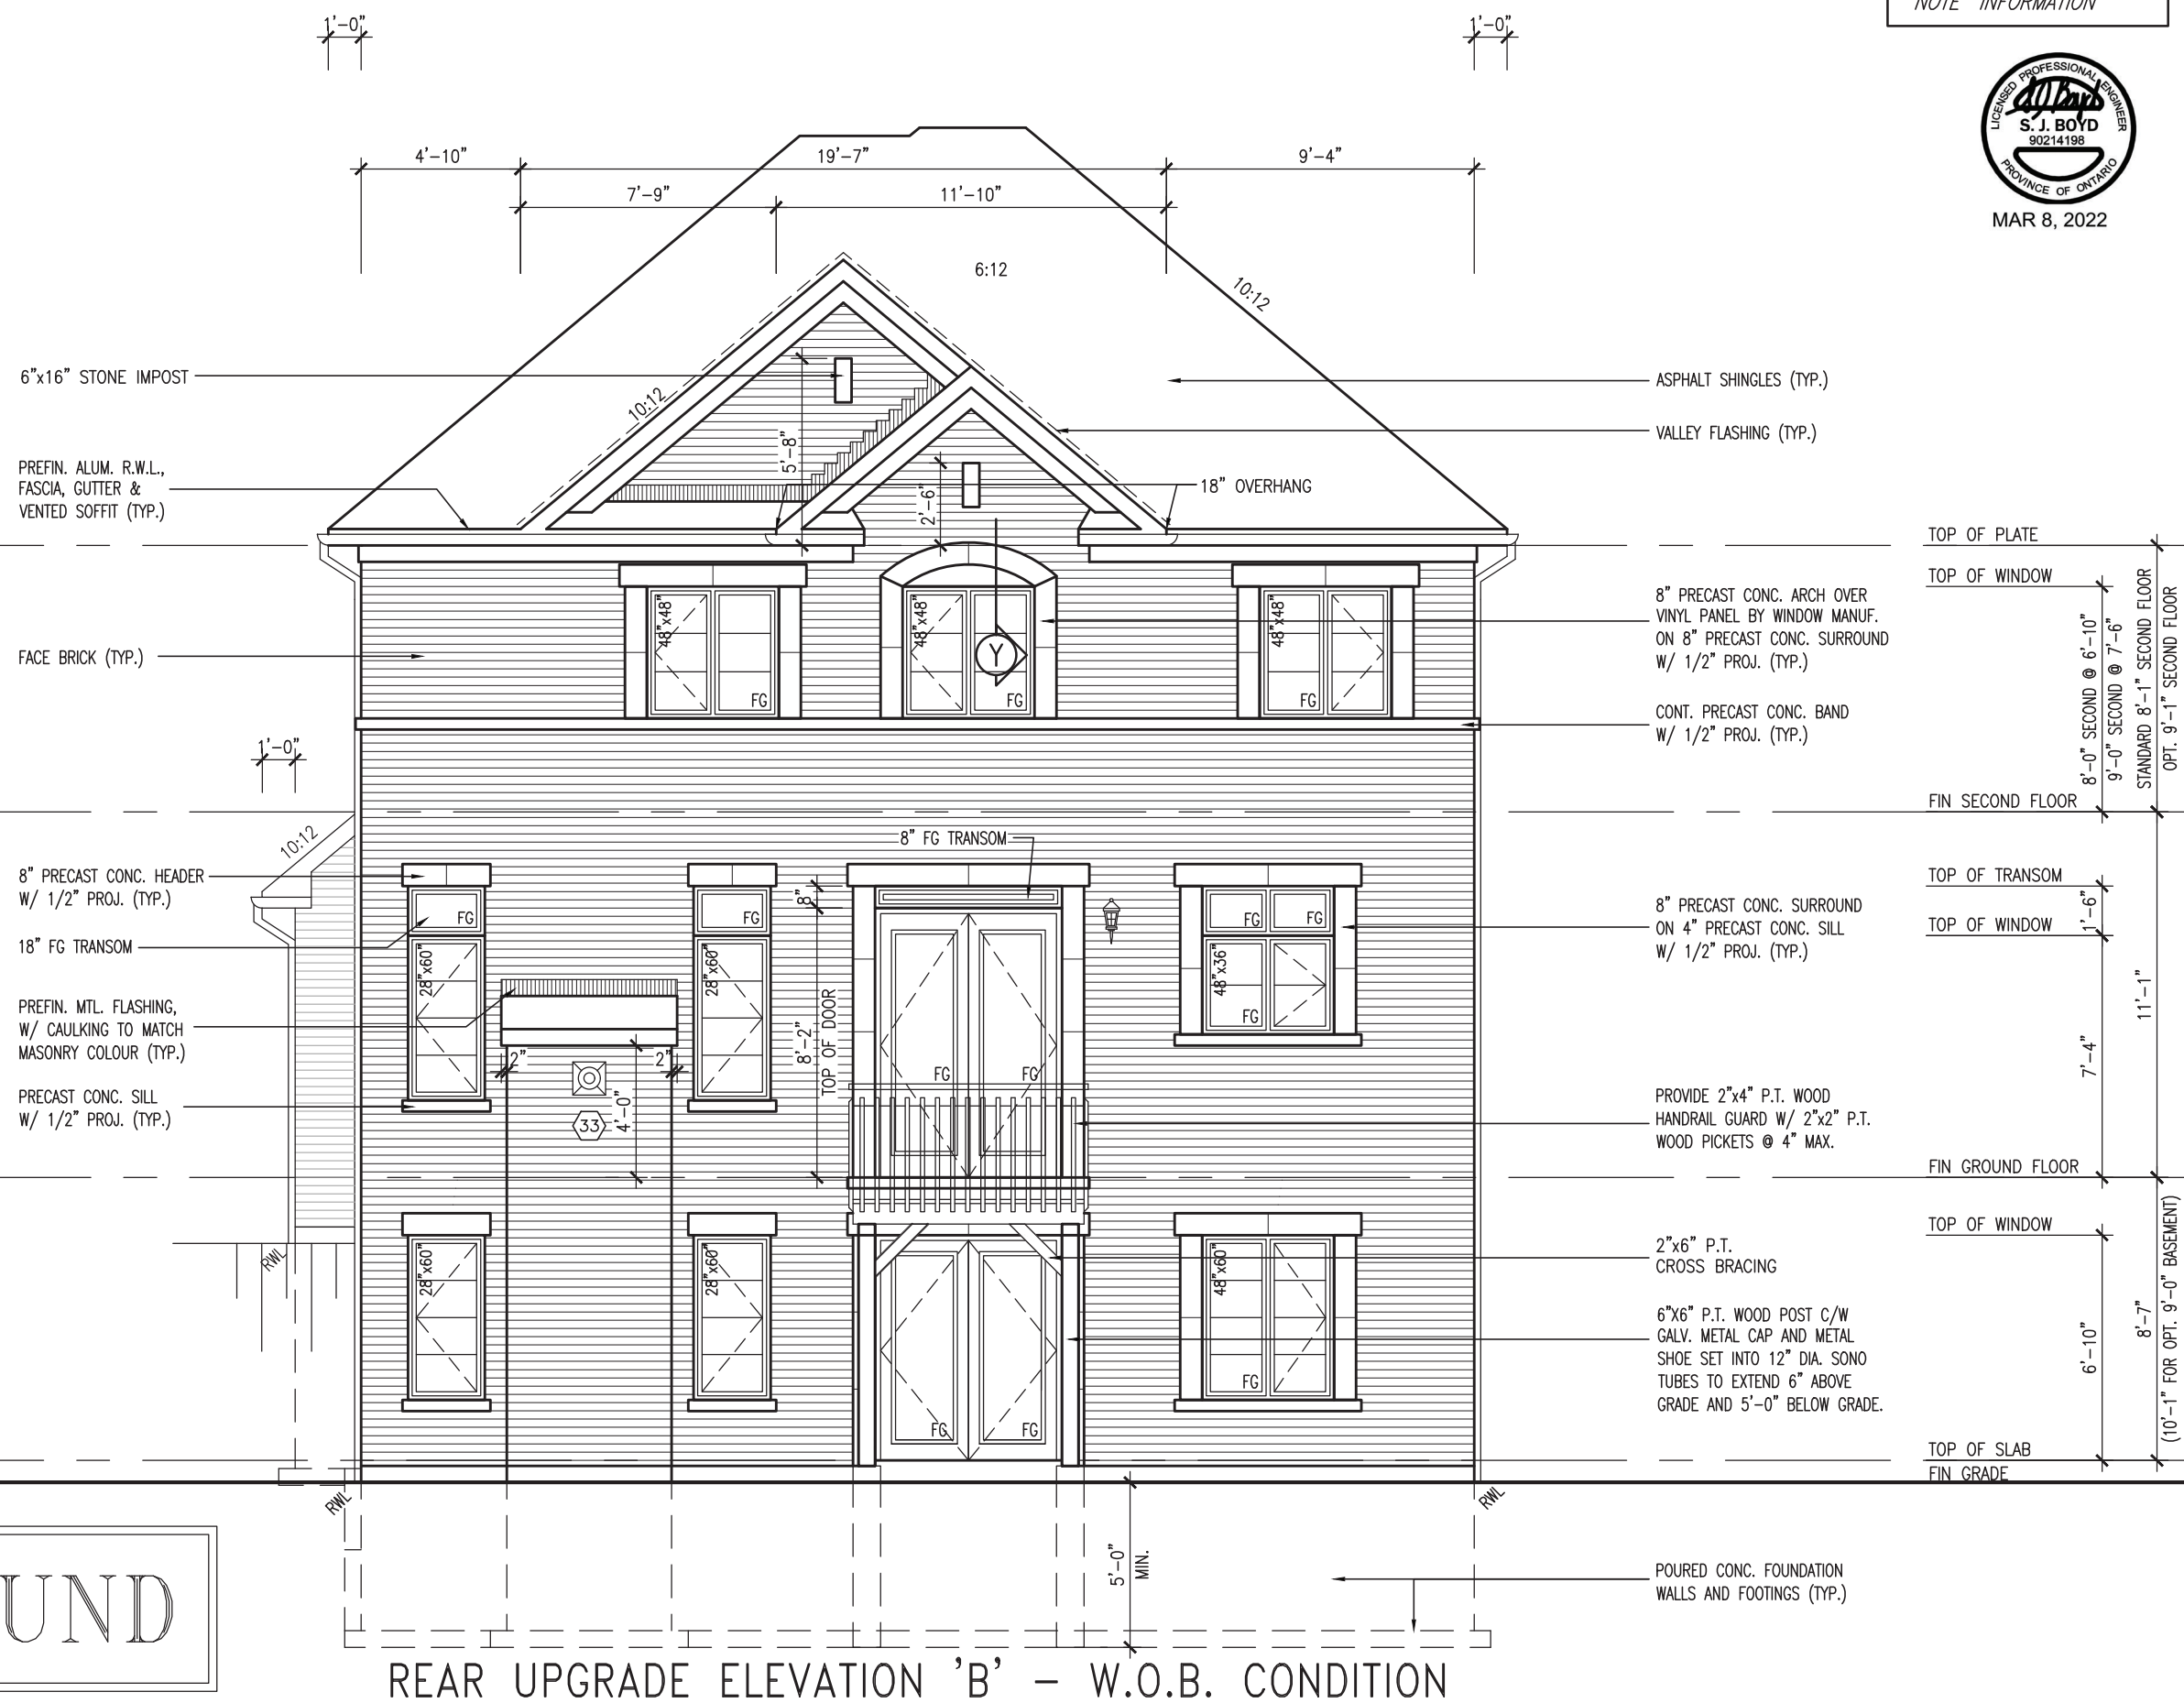
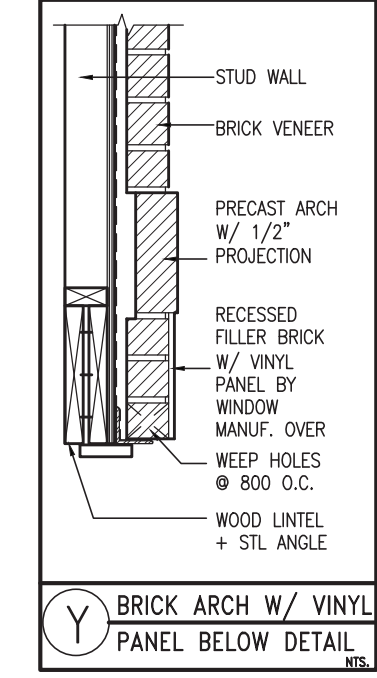
JOHN G. WILLIAMS LTD., ARCHITECT
 ARCHITECTURAL CONTROL REVIEW
 AND APPROVAL

APPROVED BY: *[Signature]*
 DATE: **MAR 15, 2022**

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NOTE: REFER TO FRONT ELEVATION FOR TYPICAL NOTE INFORMATION



10' GROUND

REAR UPGRADE ELEVATION 'B' - W.O.B. CONDITION

project name		BRADFORD, ONTARIO	
project no.		16023	
drawing no.		55	
municipality		BRADFORD, ONTARIO	
project name		GREEN VALLEY EAST	
date		OCTOBER 2021	
checked by		JWM	
drawn by		TP	
scale		3/16" = 1'-0"	
file name		16023-S42-19	
date		OCTOBER 2021	
checked by		JWM	
drawn by		TP	
scale		3/16" = 1'-0"	
file name		16023-S42-19	
date		OCTOBER 2021	
checked by		JWM	
drawn by		TP	
scale		3/16" = 1'-0"	
file name		16023-S42-19	
date		OCTOBER 2021	
checked by		JWM	
drawn by		TP	
scale		3/16" = 1'-0"	
file name		16023-S42-19	
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checked by		JWM	
drawn by		TP	
scale		3/16" = 1'-0"	
file name		16023-S42-19	
date		OCTOBER 2021	
checked by		JWM	
drawn by		TP	
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file name		16023-S42-19	
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drawn by		TP	
scale		3/16" = 1'-0"	
file name		16023-S42-19	
date		OCTOBER 2021	
checked by		JWM	
drawn by		TP	

It is the builder's complete responsibility to ensure that all plans submitted for approval fully comply with the Architectural Guidelines and all applicable regulations and requirements including zoning provisions and any provisions in the subdivision agreement. The Control Architect is not responsible in any way for examining or approving site (lotting) plans or working drawings with respect to any zoning or building code or permit matter or that any house can be properly built or located on its lot.

This is to certify that these plans comply with the applicable Architectural Design Guidelines approved by the Town of BRADFORD WEST GWILLIMBURY.

JOHN G. WILLIAMS LTD., ARCHITECT
ARCHITECTURAL CONTROL REVIEW
AND APPROVAL

APPROVED BY:

DATE: MAR 15, 2022

This stamp certifies compliance with the applicable Design Guidelines only and bears no further professional responsibility.

R.W.L. AS REQUIRED &
AS PER MUNICIPALITY

NOTE: REFER TO FRONT
ELEVATION FOR TYPICAL
NOTE INFORMATION



10' GROUND

REAR UPGRADE ELEVATION 'C' - W.O.B. CONDITION

TOP OF PLATE	
TOP OF WINDOW	
FIN SECOND FLOOR	8'-0" SECOND @ 6'-10"
TOP OF TRANSOM	9'-0" SECOND @ 7'-6"
TOP OF WINDOW	STANDARD 8'-1" SECOND FLOOR
FIN GROUND FLOOR	OPT. 9'-1" SECOND FLOOR
TOP OF WINDOW	
TOP OF SLAB	
FIN GRADE	

BAYVIEW WELLINGTON

GREEN VALLEY EAST

BRADFORD, ONTARIO

S42-19

project no. 16023

drawing no. 56

file name 16023-S42-19

checked by JMW

date OCTOBER 2021

scale 3/16" = 1'-0"

drawn by TP

REAR UPGRADE ELEVATION 'C' - W.O.D. COND.

VAS DESIGN

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Toronto, ON M2J 1R4
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name Wellington Jno-Baptiste

signature

BCIN 25591

42658

registration information VAS Design Inc.

contractor must verify all dimensions on the job and report any discrepancy to the Designer before proceeding with the work. All drawings and specifications are instruments of service and the property of the Designer which must be returned at the completion of the work. Drawings are not to be scaled.

9				
8				
7				
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4				
3	REVISED AS PER ENG COMMENTS	MAR 03-22	RC	
2	REVISED AS PER FLOOR / ROOF LAYOUT	FEB 24-22	RC	
1	ISSUED FOR CLIENT REVIEW	NOV 26-21	VAS	

no. description

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UNINSULATED OPENINGS (PER OBC. SB-12,3.1.1(7))				
STANDARD & REAR UPGRADE 10' GDN. FL.	S42-19 ELEVATION A	ENERGY EFFICIENCY - OBC SB12		
	ELEVATION	WALL AREA S.F.	OPENING S.F.	PERCENTAGE
	FRONT	714 S.F.	132.31 S.F.	18.53 %
	LEFT SIDE	1161 S.F.	81.33 S.F.	7.01 %
	RIGHT SIDE	1161 S.F.	74.83 S.F.	6.45 %
	REAR	714 S.F.	153.05 S.F.	21.44 %
* OPENINGS OMITTED AS PER SB-12 3.1.1.9(4) MAX 19.9 S.F. REFER TO ELEVATION FOR LOCATION		0.00 S.F.		
TOTAL SQ. FT.	3750.00 S.F.	441.52 S.F.	11.77 %	
TOTAL SQ. M.	348.38 S.M.	41.02 S.M.	11.77 %	
UNINSULATED OPENINGS (PER OBC. SB-12,3.1.1(7))				
STANDARD & REAR UPGRADE W/ SIDE DOOR 10' GDN. FL.	S42-19 ELEVATION A	ENERGY EFFICIENCY - OBC SB12		
	ELEVATION	WALL AREA S.F.	OPENING S.F.	PERCENTAGE
	FRONT	714 S.F.	132.31 S.F.	18.53 %
	LEFT SIDE	1161 S.F.	81.33 S.F.	7.01 %
	RIGHT SIDE	1161 S.F.	86.17 S.F.	7.42 %
	REAR	714 S.F.	153.05 S.F.	21.44 %
* OPENINGS OMITTED AS PER SB-12 3.1.1.9(4) MAX 19.9 S.F. REFER TO ELEVATION FOR LOCATION		0.00 S.F.		
TOTAL SQ. FT.	3750.00 S.F.	452.86 S.F.	12.08 %	
TOTAL SQ. M.	348.38 S.M.	42.07 S.M.	12.08 %	

UNINSULATED OPENINGS (PER OBC. SB-12,3.1.1(7))				
STANDARD & REAR UPGRADE 10' GDN. FL.	S42-19 ELEVATION A -W.O.D.	ENERGY EFFICIENCY - OBC SB12		
	ELEVATION	WALL AREA S.F.	OPENING S.F.	PERCENTAGE
	FRONT	714 S.F.	132.31 S.F.	18.53 %
	LEFT SIDE	1161 S.F.	81.33 S.F.	7.01 %
	RIGHT SIDE	1161 S.F.	74.83 S.F.	6.45 %
	REAR	849 S.F.	175.28 S.F.	20.65 %
* OPENINGS OMITTED AS PER SB-12 3.1.1.9(4) MAX 19.9 S.F. REFER TO ELEVATION FOR LOCATION		0.00 S.F.		
TOTAL SQ. FT.	3885.00 S.F.	463.75 S.F.	11.94 %	
TOTAL SQ. M.	360.93 S.M.	43.08 S.M.	11.94 %	
UNINSULATED OPENINGS (PER OBC. SB-12,3.1.1(7))				
STANDARD & REAR UPGRADE W/ SIDE DOOR 10' GDN. FL.	S42-19 ELEVATION A -W.O.D.	ENERGY EFFICIENCY - OBC SB12		
	ELEVATION	WALL AREA S.F.	OPENING S.F.	PERCENTAGE
	FRONT	714 S.F.	132.31 S.F.	18.53 %
	LEFT SIDE	1161 S.F.	81.33 S.F.	7.01 %
	RIGHT SIDE	1161 S.F.	86.17 S.F.	7.42 %
	REAR	849 S.F.	175.28 S.F.	20.65 %
* OPENINGS OMITTED AS PER SB-12 3.1.1.9(4) MAX 19.9 S.F. REFER TO ELEVATION FOR LOCATION		0.00 S.F.		
TOTAL SQ. FT.	3885.00 S.F.	475.09 S.F.	12.23 %	
TOTAL SQ. M.	360.93 S.M.	44.14 S.M.	12.23 %	

UNINSULATED OPENINGS (PER OBC. SB-12,3.1.1(7))				
STANDARD & REAR UPGRADE 10' GDN. FL.	S42-19 ELEVATION A -W.O.B.	ENERGY EFFICIENCY - OBC SB12		
	ELEVATION	WALL AREA S.F.	OPENING S.F.	PERCENTAGE
	FRONT	714 S.F.	132.31 S.F.	18.53 %
	LEFT SIDE	1161 S.F.	81.33 S.F.	7.01 %
	RIGHT SIDE	1161 S.F.	74.83 S.F.	6.45 %
	REAR	959 S.F.	228.44 S.F.	23.82 %
* OPENINGS OMITTED AS PER SB-12 3.1.1.9(4) MAX 19.9 S.F. REFER TO ELEVATION FOR LOCATION		0.00 S.F.		
TOTAL SQ. FT.	3995.00 S.F.	516.91 S.F.	12.94 %	
TOTAL SQ. M.	371.14 S.M.	48.02 S.M.	12.94 %	
UNINSULATED OPENINGS (PER OBC. SB-12,3.1.1(7))				
STANDARD & REAR UPGRADE W/ SIDE DOOR 10' GDN. FL.	S42-19 ELEVATION A -W.O.B.	ENERGY EFFICIENCY - OBC SB12		
	ELEVATION	WALL AREA S.F.	OPENING S.F.	PERCENTAGE
	FRONT	714 S.F.	132.31 S.F.	18.53 %
	LEFT SIDE	1161 S.F.	81.33 S.F.	7.01 %
	RIGHT SIDE	1161 S.F.	86.17 S.F.	7.42 %
	REAR	959 S.F.	228.44 S.F.	23.82 %
* OPENINGS OMITTED AS PER SB-12 3.1.1.9(4) MAX 19.9 S.F. REFER TO ELEVATION FOR LOCATION		0.00 S.F.		
TOTAL SQ. FT.	3995.00 S.F.	528.25 S.F.	13.22 %	
TOTAL SQ. M.	371.14 S.M.	49.08 S.M.	13.22 %	

UNINSULATED OPENINGS (PER OBC. SB-12,3.1.1(7))				
STANDARD & REAR UPGRADE 10' GDN. FL.	S42-19 ELEVATION B	ENERGY EFFICIENCY - OBC SB12		
	ELEVATION	WALL AREA S.F.	OPENING S.F.	PERCENTAGE
	FRONT	714 S.F.	124.31 S.F.	17.41 %
	LEFT SIDE	1161 S.F.	81.33 S.F.	7.01 %
	RIGHT SIDE	1161 S.F.	74.83 S.F.	6.45 %
	REAR	714 S.F.	153.05 S.F.	21.44 %
* OPENINGS OMITTED AS PER SB-12 3.1.1.9(4) MAX 19.9 S.F. REFER TO ELEVATION FOR LOCATION		0.00 S.F.		
TOTAL SQ. FT.	3750.00 S.F.	433.52 S.F.	11.56 %	
TOTAL SQ. M.	348.38 S.M.	40.27 S.M.	11.56 %	
UNINSULATED OPENINGS (PER OBC. SB-12,3.1.1(7))				
STANDARD & REAR UPGRADE W/ SIDE DOOR 10' GDN. FL.	S42-19 ELEVATION B	ENERGY EFFICIENCY - OBC SB12		
	ELEVATION	WALL AREA S.F.	OPENING S.F.	PERCENTAGE
	FRONT	714 S.F.	124.31 S.F.	17.41 %
	LEFT SIDE	1161 S.F.	81.33 S.F.	7.01 %
	RIGHT SIDE	1161 S.F.	86.17 S.F.	7.42 %
	REAR	714 S.F.	153.05 S.F.	21.44 %
* OPENINGS OMITTED AS PER SB-12 3.1.1.9(4) MAX 19.9 S.F. REFER TO ELEVATION FOR LOCATION		0.00 S.F.		
TOTAL SQ. FT.	3750.00 S.F.	444.86 S.F.	11.86 %	
TOTAL SQ. M.	348.38 S.M.	41.33 S.M.	11.86 %	

UNINSULATED OPENINGS (PER OBC. SB-12,3.1.1(7))				
STANDARD & REAR UPGRADE 10' GDN. FL.	S42-19 ELEVATION B -W.O.D.	ENERGY EFFICIENCY - OBC SB12		
	ELEVATION	WALL AREA S.F.	OPENING S.F.	PERCENTAGE
	FRONT	714 S.F.	124.31 S.F.	17.41 %
	LEFT SIDE	1161 S.F.	81.33 S.F.	7.01 %
	RIGHT SIDE	1161 S.F.	74.83 S.F.	6.45 %
	REAR	849 S.F.	175.28 S.F.	20.65 %
* OPENINGS OMITTED AS PER SB-12 3.1.1.9(4) MAX 19.9 S.F. REFER TO ELEVATION FOR LOCATION		0.00 S.F.		
TOTAL SQ. FT.	3885.00 S.F.	455.75 S.F.	11.73 %	
TOTAL SQ. M.	360.93 S.M.	42.34 S.M.	11.73 %	
UNINSULATED OPENINGS (PER OBC. SB-12,3.1.1(7))				
STANDARD & REAR UPGRADE W/ SIDE DOOR 10' GDN. FL.	S42-19 ELEVATION B -W.O.D.	ENERGY EFFICIENCY - OBC SB12		
	ELEVATION	WALL AREA S.F.	OPENING S.F.	PERCENTAGE
	FRONT	714 S.F.	124.31 S.F.	17.41 %
	LEFT SIDE	1161 S.F.	81.33 S.F.	7.01 %
	RIGHT SIDE	1161 S.F.	86.17 S.F.	7.42 %
	REAR	849 S.F.	175.28 S.F.	20.65 %
* OPENINGS OMITTED AS PER SB-12 3.1.1.9(4) MAX 19.9 S.F. REFER TO ELEVATION FOR LOCATION		0.00 S.F.		
TOTAL SQ. FT.	3885.00 S.F.	467.09 S.F.	12.02 %	
TOTAL SQ. M.	360.93 S.M.	43.39 S.M.	12.02 %	

UNINSULATED OPENINGS (PER OBC. SB-12,3.1.1(7))				
STANDARD & REAR UPGRADE 10' GDN. FL.	S42-19 ELEVATION B -W.O.B.	ENERGY EFFICIENCY - OBC SB12		
	ELEVATION	WALL AREA S.F.	OPENING S.F.	PERCENTAGE
	FRONT	714 S.F.	124.31 S.F.	17.41 %
	LEFT SIDE	1161 S.F.	81.33 S.F.	7.01 %
	RIGHT SIDE	1161 S.F.	74.83 S.F.	6.45 %
	REAR	959 S.F.	228.44 S.F.	23.82 %
* OPENINGS OMITTED AS PER SB-12 3.1.1.9(4) MAX 19.9 S.F. REFER TO ELEVATION FOR LOCATION		0.00 S.F.		
TOTAL SQ. FT.	3995.00 S.F.	508.91 S.F.	12.74 %	
TOTAL SQ. M.	371.14 S.M.	47.28 S.M.	12.74 %	
UNINSULATED OPENINGS (PER OBC. SB-12,3.1.1(7))				
STANDARD & REAR UPGRADE W/ SIDE DOOR 10' GDN. FL.	S42-19 ELEVATION B -W.O.B.	ENERGY EFFICIENCY - OBC SB12		
	ELEVATION	WALL AREA S.F.	OPENING S.F.	PERCENTAGE
	FRONT	714 S.F.	124.31 S.F.	17.41 %
	LEFT SIDE	1161 S.F.	81.33 S.F.	7.01 %
	RIGHT SIDE	1161 S.F.	86.17 S.F.	7.42 %
	REAR	959 S.F.	228.44 S.F.	23.82 %
* OPENINGS OMITTED AS PER SB-12 3.1.1.9(4) MAX 19.9 S.F. REFER TO ELEVATION FOR LOCATION		0.00 S.F.		
TOTAL SQ. FT.	3995.00 S.F.	520.25 S.F.	13.02 %	
TOTAL SQ. M.	371.14 S.M.	48.33 S.M.	13.02 %	

10' GROUND

9				
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7				
6				
5				
4				
3	REVISED AS PER ENG COMMENTS	MAR 03-22	RC	
2	REVISED AS PER FLOOR / ROOF LAYOUT	FEB 24-22	RC	
1	ISSUED FOR CLIENT REVIEW	NOV 26-21	VA3	
no.	description	date	by	

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BAYVIEW WELLINGTON
 GREEN VALLEY EAST
 BRADFORD, ONTARIO

project name: GREEN VALLEY EAST
 municipality: BRADFORD, ONTARIO
 project no.: 16023
 drawing no.: 57

checked by: JMW
 date: OCTOBER 2021
 scale: 3/16" = 1'-0"

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UNINSULATED OPENINGS (PER OBC. SB-12,3.1.1(7))				
STANDARD 10' GDN. FL.	S42-19 ELEVATION C	ENERGY EFFICIENCY - OBC SB12		
	ELEVATION	WALL AREA S.F.	OPENING S.F.	PERCENTAGE
	FRONT	714 S.F.	179.81 S.F.	25.18 %
	LEFT SIDE	1161 S.F.	108.17 S.F.	9.32 %
	RIGHT SIDE	1161 S.F.	86.50 S.F.	7.45 %
	REAR	714 S.F.	153.05 S.F.	21.44 %
* OPENINGS OMITTED AS PER SB-12 3.1.1.9(4) MAX 19.9 S.F. REFER TO ELEVATION FOR LOCATION		0.00 S.F.		
TOTAL SQ. FT.	3750.00 S.F.	527.53 S.F.	14.07 %	
TOTAL SQ. M.	348.38 S.M.	49.01 S.M.	14.07 %	
UNINSULATED OPENINGS (PER OBC. SB-12,3.1.1(7))				
STANDARD W/ SIDE DOOR 10' GDN. FL.	S42-19 ELEVATION C	ENERGY EFFICIENCY - OBC SB12		
	ELEVATION	WALL AREA S.F.	OPENING S.F.	PERCENTAGE
	FRONT	714 S.F.	179.81 S.F.	25.18 %
	LEFT SIDE	1161 S.F.	108.17 S.F.	9.32 %
	RIGHT SIDE	1161 S.F.	97.83 S.F.	8.43 %
	REAR	714 S.F.	153.05 S.F.	21.44 %
* OPENINGS OMITTED AS PER SB-12 3.1.1.9(4) MAX 19.9 S.F. REFER TO ELEVATION FOR LOCATION		0.00 S.F.		
TOTAL SQ. FT.	3750.00 S.F.	538.86 S.F.	14.37 %	
TOTAL SQ. M.	348.38 S.M.	50.06 S.M.	14.37 %	

UNINSULATED OPENINGS (PER OBC. SB-12,3.1.1(7))				
STANDARD 10' GDN. FL.	S42-19 ELEVATION C -W.O.D.	ENERGY EFFICIENCY - OBC SB12		
	ELEVATION	WALL AREA S.F.	OPENING S.F.	PERCENTAGE
	FRONT	714 S.F.	179.81 S.F.	25.18 %
	LEFT SIDE	1161 S.F.	108.17 S.F.	9.32 %
	RIGHT SIDE	1161 S.F.	86.50 S.F.	7.45 %
	REAR	849 S.F.	175.28 S.F.	20.65 %
* OPENINGS OMITTED AS PER SB-12 3.1.1.9(4) MAX 19.9 S.F. REFER TO ELEVATION FOR LOCATION		0.00 S.F.		
TOTAL SQ. FT.	3885.00 S.F.	549.76 S.F.	14.15 %	
TOTAL SQ. M.	360.93 S.M.	51.07 S.M.	14.15 %	
UNINSULATED OPENINGS (PER OBC. SB-12,3.1.1(7))				
STANDARD W/ SIDE DOOR 10' GDN. FL.	S42-19 ELEVATION C -W.O.D.	ENERGY EFFICIENCY - OBC SB12		
	ELEVATION	WALL AREA S.F.	OPENING S.F.	PERCENTAGE
	FRONT	714 S.F.	179.81 S.F.	25.18 %
	LEFT SIDE	1161 S.F.	108.17 S.F.	9.32 %
	RIGHT SIDE	1161 S.F.	97.83 S.F.	8.43 %
	REAR	849 S.F.	175.28 S.F.	20.65 %
* OPENINGS OMITTED AS PER SB-12 3.1.1.9(4) MAX 19.9 S.F. REFER TO ELEVATION FOR LOCATION		0.00 S.F.		
TOTAL SQ. FT.	3885.00 S.F.	561.09 S.F.	14.44 %	
TOTAL SQ. M.	360.93 S.M.	52.13 S.M.	14.44 %	

UNINSULATED OPENINGS (PER OBC. SB-12,3.1.1(7))				
STANDARD 10' GDN. FL.	S42-19 ELEVATION C -W.O.B.	ENERGY EFFICIENCY - OBC SB12		
	ELEVATION	WALL AREA S.F.	OPENING S.F.	PERCENTAGE
	FRONT	714 S.F.	179.81 S.F.	25.18 %
	LEFT SIDE	1161 S.F.	108.17 S.F.	9.32 %
	RIGHT SIDE	1161 S.F.	86.50 S.F.	7.45 %
	REAR	959 S.F.	228.44 S.F.	23.82 %
* OPENINGS OMITTED AS PER SB-12 3.1.1.9(4) MAX 19.9 S.F. REFER TO ELEVATION FOR LOCATION		0.00 S.F.		
TOTAL SQ. FT.	3995.00 S.F.	602.92 S.F.	15.09 %	
TOTAL SQ. M.	371.14 S.M.	56.01 S.M.	15.09 %	
UNINSULATED OPENINGS (PER OBC. SB-12,3.1.1(7))				
STANDARD W/ SIDE DOOR 10' GDN. FL.	S42-19 ELEVATION C -W.O.B.	ENERGY EFFICIENCY - OBC SB12		
	ELEVATION	WALL AREA S.F.	OPENING S.F.	PERCENTAGE
	FRONT	714 S.F.	179.81 S.F.	25.18 %
	LEFT SIDE	1161 S.F.	108.17 S.F.	9.32 %
	RIGHT SIDE	1161 S.F.	97.83 S.F.	8.43 %
	REAR	959 S.F.	228.44 S.F.	23.82 %
* OPENINGS OMITTED AS PER SB-12 3.1.1.9(4) MAX 19.9 S.F. REFER TO ELEVATION FOR LOCATION		0.00 S.F.		
TOTAL SQ. FT.	3995.00 S.F.	614.25 S.F.	15.38 %	
TOTAL SQ. M.	371.14 S.M.	57.07 S.M.	15.38 %	

UNINSULATED OPENINGS (PER OBC. SB-12,3.1.1(7))				
REAR UPGRADE 10' GDN. FL.	S42-19 ELEVATION C	ENERGY EFFICIENCY - OBC SB12		
	ELEVATION	WALL AREA S.F.	OPENING S.F.	PERCENTAGE
	FRONT	714 S.F.	179.81 S.F.	25.18 %
	LEFT SIDE	1161 S.F.	108.17 S.F.	9.32 %
	RIGHT SIDE	1161 S.F.	86.50 S.F.	7.45 %
	REAR	714 S.F.	176.05 S.F.	24.66 %
* OPENINGS OMITTED AS PER SB-12 3.1.1.9(4) MAX 19.9 S.F. REFER TO ELEVATION FOR LOCATION		0.00 S.F.		
TOTAL SQ. FT.	3750.00 S.F.	550.53 S.F.	14.68 %	
TOTAL SQ. M.	348.38 S.M.	51.15 S.M.	14.68 %	
UNINSULATED OPENINGS (PER OBC. SB-12,3.1.1(7))				
REAR UPGRADE W/ SIDE DOOR 10' GDN. FL.	S42-19 ELEVATION C	ENERGY EFFICIENCY - OBC SB12		
	ELEVATION	WALL AREA S.F.	OPENING S.F.	PERCENTAGE
	FRONT	714 S.F.	179.81 S.F.	25.18 %
	LEFT SIDE	1161 S.F.	108.17 S.F.	9.32 %
	RIGHT SIDE	1161 S.F.	97.83 S.F.	8.43 %
	REAR	714 S.F.	176.05 S.F.	24.66 %
* OPENINGS OMITTED AS PER SB-12 3.1.1.9(4) MAX 19.9 S.F. REFER TO ELEVATION FOR LOCATION		0.00 S.F.		
TOTAL SQ. FT.	3750.00 S.F.	561.86 S.F.	14.98 %	
TOTAL SQ. M.	348.38 S.M.	52.20 S.M.	14.98 %	

UNINSULATED OPENINGS (PER OBC. SB-12,3.1.1(7))				
REAR UPGRADE 10' GDN. FL.	S42-19 ELEVATION C -W.O.D.	ENERGY EFFICIENCY - OBC SB12		
	ELEVATION	WALL AREA S.F.	OPENING S.F.	PERCENTAGE
	FRONT	714 S.F.	179.81 S.F.	25.18 %
	LEFT SIDE	1161 S.F.	108.17 S.F.	9.32 %
	RIGHT SIDE	1161 S.F.	86.50 S.F.	7.45 %
	REAR	849 S.F.	200.50 S.F.	23.62 %
* OPENINGS OMITTED AS PER SB-12 3.1.1.9(4) MAX 19.9 S.F. REFER TO ELEVATION FOR LOCATION		0.00 S.F.		
TOTAL SQ. FT.	3885.00 S.F.	574.98 S.F.	14.80 %	
TOTAL SQ. M.	360.93 S.M.	53.42 S.M.	14.80 %	
UNINSULATED OPENINGS (PER OBC. SB-12,3.1.1(7))				
REAR UPGRADE W/ SIDE DOOR 10' GDN. FL.	S42-19 ELEVATION C -W.O.D.	ENERGY EFFICIENCY - OBC SB12		
	ELEVATION	WALL AREA S.F.	OPENING S.F.	PERCENTAGE
	FRONT	714 S.F.	179.81 S.F.	25.18 %
	LEFT SIDE	1161 S.F.	108.17 S.F.	9.32 %
	RIGHT SIDE	1161 S.F.	97.83 S.F.	8.43 %
	REAR	849 S.F.	200.50 S.F.	23.62 %
* OPENINGS OMITTED AS PER SB-12 3.1.1.9(4) MAX 19.9 S.F. REFER TO ELEVATION FOR LOCATION		0.00 S.F.		
TOTAL SQ. FT.	3885.00 S.F.	586.31 S.F.	15.09 %	
TOTAL SQ. M.	360.93 S.M.	54.47 S.M.	15.09 %	

UNINSULATED OPENINGS (PER OBC. SB-12,3.1.1(7))				
REAR UPGRADE 10' GDN. FL.	S42-19 ELEVATION C -W.O.B.	ENERGY EFFICIENCY - OBC SB12		
	ELEVATION	WALL AREA S.F.	OPENING S.F.	PERCENTAGE
	FRONT	714 S.F.	179.81 S.F.	25.18 %
	LEFT SIDE	1161 S.F.	108.17 S.F.	9.32 %
	RIGHT SIDE	1161 S.F.	86.50 S.F.	7.45 %
	REAR	959 S.F.	254.78 S.F.	26.57 %
* OPENINGS OMITTED AS PER SB-12 3.1.1.9(4) MAX 19.9 S.F. REFER TO ELEVATION FOR LOCATION		0.00 S.F.		
TOTAL SQ. FT.	3995.00 S.F.	629.26 S.F.	15.75 %	
TOTAL SQ. M.	371.14 S.M.	58.46 S.M.	15.75 %	
UNINSULATED OPENINGS (PER OBC. SB-12,3.1.1(7))				
REAR UPGRADE W/ SIDE DOOR 10' GDN. FL.	S42-19 ELEVATION C -W.O.B.	ENERGY EFFICIENCY - OBC SB12		
	ELEVATION	WALL AREA S.F.	OPENING S.F.	PERCENTAGE
	FRONT	714 S.F.	179.81 S.F.	25.18 %
	LEFT SIDE	1161 S.F.	108.17 S.F.	9.32 %
	RIGHT SIDE	1161 S.F.	97.83 S.F.	8.43 %
	REAR	959 S.F.	254.78 S.F.	26.57 %
* OPENINGS OMITTED AS PER SB-12 3.1.1.9(4) MAX 19.9 S.F. REFER TO ELEVATION FOR LOCATION		0.00 S.F.		
TOTAL SQ. FT.	3995.00 S.F.	640.59 S.F.	16.03 %	
TOTAL SQ. M.	371.14 S.M.	59.51 S.M.	16.03 %	

10' GROUND

9					
8					
7					
6					
5					
4					
3	REVISED AS PER ENG COMMENTS	MAR 03-22	RC		
2	REVISED AS PER FLOOR / ROOF LAYOUT	FEB 24-22	RC		
1	ISSUED FOR CLIENT REVIEW	NOV 26-21	VA3		
no.	description	date	by		

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BAYVIEW WELLINGTON
 GREEN VALLEY EAST
 BRADFORD, ONTARIO

project name: GREEN VALLEY EAST
 municipality: BRADFORD, ONTARIO
 project no.: 16023
 drawing no.: 58

checked by: JWM
 date: OCTOBER 2021
 scale: 3/16" = 1'-0"
 drawn by: TP

file name: 16023-S42-19
 drawing no.: 58

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UNINSULATED OPENINGS (PER OBC. SB-12,3.1.1(7))				
ELEVATION	ENERGY EFFICIENCY - OBC SB12			
	WALL AREA S.F.	OPENING S.F.	PERCENTAGE	
S42-19 ELEVATION A -W.O.B.				
FRONT	714 S.F.	132.31 S.F.	18.53 %	
LEFT SIDE	1161 S.F.	81.33 S.F.	7.01 %	
RIGHT SIDE	1161 S.F.	74.83 S.F.	6.45 %	
REAR	993 S.F.	228.44 S.F.	23.01 %	
* OPENINGS OMITTED AS PER SB-12 3.1.1.9(4) MAX 19.9 S.F. REFER TO ELEVATION FOR LOCATION		0.00 S.F.		
TOTAL SQ. FT.	4029.00 S.F.	516.91 S.F.	12.83 %	
TOTAL SQ. M.	374.30 S.M.	48.02 S.M.	12.83 %	
UNINSULATED OPENINGS (PER OBC. SB-12,3.1.1(7))				
ELEVATION	ENERGY EFFICIENCY - OBC SB12			
	WALL AREA S.F.	OPENING S.F.	PERCENTAGE	
S42-19 ELEVATION A -W.O.B.				
FRONT	714 S.F.	132.31 S.F.	18.53 %	
LEFT SIDE	1161 S.F.	81.33 S.F.	7.01 %	
RIGHT SIDE	1161 S.F.	86.17 S.F.	7.42 %	
REAR	993 S.F.	228.44 S.F.	23.01 %	
* OPENINGS OMITTED AS PER SB-12 3.1.1.9(4) MAX 19.9 S.F. REFER TO ELEVATION FOR LOCATION		0.00 S.F.		
TOTAL SQ. FT.	4029.00 S.F.	528.25 S.F.	13.11 %	
TOTAL SQ. M.	374.30 S.M.	49.08 S.M.	13.11 %	

UNINSULATED OPENINGS (PER OBC. SB-12,3.1.1(7))				
ELEVATION	ENERGY EFFICIENCY - OBC SB12			
	WALL AREA S.F.	OPENING S.F.	PERCENTAGE	
S42-19 ELEVATION B -W.O.B.				
FRONT	714 S.F.	124.31 S.F.	17.41 %	
LEFT SIDE	1161 S.F.	81.33 S.F.	7.01 %	
RIGHT SIDE	1161 S.F.	74.83 S.F.	6.45 %	
REAR	993 S.F.	228.44 S.F.	23.01 %	
* OPENINGS OMITTED AS PER SB-12 3.1.1.9(4) MAX 19.9 S.F. REFER TO ELEVATION FOR LOCATION		0.00 S.F.		
TOTAL SQ. FT.	4029.00 S.F.	508.91 S.F.	12.63 %	
TOTAL SQ. M.	374.30 S.M.	47.28 S.M.	12.63 %	
UNINSULATED OPENINGS (PER OBC. SB-12,3.1.1(7))				
ELEVATION	ENERGY EFFICIENCY - OBC SB12			
	WALL AREA S.F.	OPENING S.F.	PERCENTAGE	
S42-19 ELEVATION B -W.O.B.				
FRONT	714 S.F.	124.31 S.F.	17.41 %	
LEFT SIDE	1161 S.F.	81.33 S.F.	7.01 %	
RIGHT SIDE	1161 S.F.	86.17 S.F.	7.42 %	
REAR	993 S.F.	228.44 S.F.	23.01 %	
* OPENINGS OMITTED AS PER SB-12 3.1.1.9(4) MAX 19.9 S.F. REFER TO ELEVATION FOR LOCATION		0.00 S.F.		
TOTAL SQ. FT.	4029.00 S.F.	520.25 S.F.	12.91 %	
TOTAL SQ. M.	374.30 S.M.	48.33 S.M.	12.91 %	

UNINSULATED OPENINGS (PER OBC. SB-12,3.1.1(7))				
ELEVATION	ENERGY EFFICIENCY - OBC SB12			
	WALL AREA S.F.	OPENING S.F.	PERCENTAGE	
S42-19 ELEVATION C -W.O.B.				
FRONT	714 S.F.	179.81 S.F.	25.18 %	
LEFT SIDE	1161 S.F.	108.17 S.F.	9.32 %	
RIGHT SIDE	1161 S.F.	86.50 S.F.	7.45 %	
REAR	993 S.F.	228.44 S.F.	23.01 %	
* OPENINGS OMITTED AS PER SB-12 3.1.1.9(4) MAX 19.9 S.F. REFER TO ELEVATION FOR LOCATION		0.00 S.F.		
TOTAL SQ. FT.	4029.00 S.F.	602.92 S.F.	14.96 %	
TOTAL SQ. M.	374.30 S.M.	56.01 S.M.	14.96 %	
UNINSULATED OPENINGS (PER OBC. SB-12,3.1.1(7))				
ELEVATION	ENERGY EFFICIENCY - OBC SB12			
	WALL AREA S.F.	OPENING S.F.	PERCENTAGE	
S42-19 ELEVATION C -W.O.B.				
FRONT	714 S.F.	179.81 S.F.	25.18 %	
LEFT SIDE	1161 S.F.	108.17 S.F.	9.32 %	
RIGHT SIDE	1161 S.F.	97.83 S.F.	8.43 %	
REAR	993 S.F.	228.44 S.F.	23.01 %	
* OPENINGS OMITTED AS PER SB-12 3.1.1.9(4) MAX 19.9 S.F. REFER TO ELEVATION FOR LOCATION		0.00 S.F.		
TOTAL SQ. FT.	4029.00 S.F.	614.25 S.F.	15.25 %	
TOTAL SQ. M.	374.30 S.M.	57.07 S.M.	15.25 %	

UNINSULATED OPENINGS (PER OBC. SB-12,3.1.1(7))				
ELEVATION	ENERGY EFFICIENCY - OBC SB12			
	WALL AREA S.F.	OPENING S.F.	PERCENTAGE	
S42-19 ELEVATION C -W.O.B.				
FRONT	714 S.F.	179.81 S.F.	25.18 %	
LEFT SIDE	1161 S.F.	108.17 S.F.	9.32 %	
RIGHT SIDE	1161 S.F.	86.50 S.F.	7.45 %	
REAR	993 S.F.	254.78 S.F.	25.66 %	
* OPENINGS OMITTED AS PER SB-12 3.1.1.9(4) MAX 19.9 S.F. REFER TO ELEVATION FOR LOCATION		0.00 S.F.		
TOTAL SQ. FT.	4029.00 S.F.	629.26 S.F.	15.62 %	
TOTAL SQ. M.	374.30 S.M.	58.46 S.M.	15.62 %	
UNINSULATED OPENINGS (PER OBC. SB-12,3.1.1(7))				
ELEVATION	ENERGY EFFICIENCY - OBC SB12			
	WALL AREA S.F.	OPENING S.F.	PERCENTAGE	
S42-19 ELEVATION C -W.O.B.				
FRONT	714 S.F.	179.81 S.F.	25.18 %	
LEFT SIDE	1161 S.F.	108.17 S.F.	9.32 %	
RIGHT SIDE	1161 S.F.	97.83 S.F.	8.43 %	
REAR	993 S.F.	254.78 S.F.	25.66 %	
* OPENINGS OMITTED AS PER SB-12 3.1.1.9(4) MAX 19.9 S.F. REFER TO ELEVATION FOR LOCATION		0.00 S.F.		
TOTAL SQ. FT.	4029.00 S.F.	640.59 S.F.	15.90 %	
TOTAL SQ. M.	374.30 S.M.	59.51 S.M.	15.90 %	

10' GROUND, 9' BASEMENT

9				
8				
7				
6				
5				
4				
3	REVISED AS PER ENG COMMENTS	MAR 03-22	RC	
2	REVISED AS PER FLOOR / ROOF LAYOUT	FEB 24-22	RC	
1	ISSUED FOR CLIENT REVIEW	NOV 26-21	VA3	
no.	description	date	by	

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checked by: **JWM**
 date: **OCTOBER 2021**
 drawn by: **TP**
 scale: **3/16" = 1'-0"**

project name: **BAYVIEW WELLINGTON**
 municipality: **GREEN VALLEY EAST**
 project no.: **16023**
 drawing no.: **SB-12 CHARTS 59**
 file name: **16023-S42-19**

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UNINSULATED OPENINGS (PER OBC. SB-12,3.1.1(7))				
STANDARD & REAR UPGRADE 10' GDN. FL. & 9' SEC. FL.	S42-19 ELEVATION A	ENERGY EFFICIENCY - OBC SB12		
	ELEVATION	WALL AREA S.F.	OPENING S.F.	PERCENTAGE
	FRONT	748 S.F.	132.31 S.F.	17.69 %
	LEFT SIDE	1215 S.F.	81.33 S.F.	6.69 %
	RIGHT SIDE	1215 S.F.	74.83 S.F.	6.16 %
	REAR	748 S.F.	153.05 S.F.	20.46 %
* OPENINGS OMITTED AS PER SB-12 3.1.1.9(4) MAX 19.9 S.F. REFER TO ELEVATION FOR LOCATION			0.00 S.F.	
TOTAL SQ. FT.	3926.00 S.F.	441.52 S.F.	11.25 %	
TOTAL SQ. M.	364.73 S.M.	41.02 S.M.	11.25 %	
UNINSULATED OPENINGS (PER OBC. SB-12,3.1.1(7))				
STANDARD & REAR UPGRADE W/ SIDE DOOR 10' GDN. FL. & 9' SEC. FL.	S42-19 ELEVATION A	ENERGY EFFICIENCY - OBC SB12		
	ELEVATION	WALL AREA S.F.	OPENING S.F.	PERCENTAGE
	FRONT	748 S.F.	132.31 S.F.	17.69 %
	LEFT SIDE	1215 S.F.	81.33 S.F.	6.69 %
	RIGHT SIDE	1215 S.F.	86.17 S.F.	7.09 %
	REAR	748 S.F.	153.05 S.F.	20.46 %
* OPENINGS OMITTED AS PER SB-12 3.1.1.9(4) MAX 19.9 S.F. REFER TO ELEVATION FOR LOCATION			0.00 S.F.	
TOTAL SQ. FT.	3926.00 S.F.	452.86 S.F.	11.53 %	
TOTAL SQ. M.	364.73 S.M.	42.07 S.M.	11.53 %	

UNINSULATED OPENINGS (PER OBC. SB-12,3.1.1(7))				
STANDARD & REAR UPGRADE 10' GDN. FL. & 9' SEC. FL.	S42-19 ELEVATION A -W.O.D.	ENERGY EFFICIENCY - OBC SB12		
	ELEVATION	WALL AREA S.F.	OPENING S.F.	PERCENTAGE
	FRONT	748 S.F.	132.31 S.F.	17.69 %
	LEFT SIDE	1215 S.F.	81.33 S.F.	6.69 %
	RIGHT SIDE	1215 S.F.	74.83 S.F.	6.16 %
	REAR	883 S.F.	175.28 S.F.	19.85 %
* OPENINGS OMITTED AS PER SB-12 3.1.1.9(4) MAX 19.9 S.F. REFER TO ELEVATION FOR LOCATION			0.00 S.F.	
TOTAL SQ. FT.	4061.00 S.F.	463.75 S.F.	11.42 %	
TOTAL SQ. M.	377.28 S.M.	43.08 S.M.	11.42 %	
UNINSULATED OPENINGS (PER OBC. SB-12,3.1.1(7))				
STANDARD & REAR UPGRADE W/ SIDE DOOR 10' GDN. FL. & 9' SEC. FL.	S42-19 ELEVATION A -W.O.D.	ENERGY EFFICIENCY - OBC SB12		
	ELEVATION	WALL AREA S.F.	OPENING S.F.	PERCENTAGE
	FRONT	748 S.F.	132.31 S.F.	17.69 %
	LEFT SIDE	1215 S.F.	81.33 S.F.	6.69 %
	RIGHT SIDE	1215 S.F.	86.17 S.F.	7.09 %
	REAR	883 S.F.	175.28 S.F.	19.85 %
* OPENINGS OMITTED AS PER SB-12 3.1.1.9(4) MAX 19.9 S.F. REFER TO ELEVATION FOR LOCATION			0.00 S.F.	
TOTAL SQ. FT.	4061.00 S.F.	475.09 S.F.	11.70 %	
TOTAL SQ. M.	377.28 S.M.	44.14 S.M.	11.70 %	


UNINSULATED OPENINGS (PER OBC. SB-12,3.1.1(7))				
STANDARD & REAR UPGRADE 10' GDN. FL. & 9' SEC. FL.	S42-19 ELEVATION A -W.O.B.	ENERGY EFFICIENCY - OBC SB12		
	ELEVATION	WALL AREA S.F.	OPENING S.F.	PERCENTAGE
	FRONT	748 S.F.	132.31 S.F.	17.69 %
	LEFT SIDE	1215 S.F.	81.33 S.F.	6.69 %
	RIGHT SIDE	1215 S.F.	74.83 S.F.	6.16 %
	REAR	993 S.F.	228.44 S.F.	23.01 %
* OPENINGS OMITTED AS PER SB-12 3.1.1.9(4) MAX 19.9 S.F. REFER TO ELEVATION FOR LOCATION			0.00 S.F.	
TOTAL SQ. FT.	4171.00 S.F.	516.91 S.F.	12.39 %	
TOTAL SQ. M.	387.50 S.M.	48.02 S.M.	12.39 %	
UNINSULATED OPENINGS (PER OBC. SB-12,3.1.1(7))				
STANDARD & REAR UPGRADE W/ SIDE DOOR 10' GDN. FL. & 9' SEC. FL.	S42-19 ELEVATION A -W.O.B.	ENERGY EFFICIENCY - OBC SB12		
	ELEVATION	WALL AREA S.F.	OPENING S.F.	PERCENTAGE
	FRONT	748 S.F.	132.31 S.F.	17.69 %
	LEFT SIDE	1215 S.F.	81.33 S.F.	6.69 %
	RIGHT SIDE	1215 S.F.	86.17 S.F.	7.09 %
	REAR	993 S.F.	228.44 S.F.	23.01 %
* OPENINGS OMITTED AS PER SB-12 3.1.1.9(4) MAX 19.9 S.F. REFER TO ELEVATION FOR LOCATION			0.00 S.F.	
TOTAL SQ. FT.	4171.00 S.F.	528.25 S.F.	12.66 %	
TOTAL SQ. M.	387.50 S.M.	49.08 S.M.	12.66 %	

UNINSULATED OPENINGS (PER OBC. SB-12,3.1.1(7))				
STANDARD & REAR UPGRADE 10' GDN. FL. & 9' SEC. FL.	S42-19 ELEVATION B	ENERGY EFFICIENCY - OBC SB12		
	ELEVATION	WALL AREA S.F.	OPENING S.F.	PERCENTAGE
	FRONT	748 S.F.	124.31 S.F.	16.62 %
	LEFT SIDE	1215 S.F.	81.33 S.F.	6.69 %
	RIGHT SIDE	1215 S.F.	74.83 S.F.	6.16 %
	REAR	748 S.F.	153.05 S.F.	20.46 %
* OPENINGS OMITTED AS PER SB-12 3.1.1.9(4) MAX 19.9 S.F. REFER TO ELEVATION FOR LOCATION			0.00 S.F.	
TOTAL SQ. FT.	3926.00 S.F.	433.52 S.F.	11.04 %	
TOTAL SQ. M.	364.73 S.M.	40.27 S.M.	11.04 %	
UNINSULATED OPENINGS (PER OBC. SB-12,3.1.1(7))				
STANDARD & REAR UPGRADE W/ SIDE DOOR 10' GDN. FL. & 9' SEC. FL.	S42-19 ELEVATION B	ENERGY EFFICIENCY - OBC SB12		
	ELEVATION	WALL AREA S.F.	OPENING S.F.	PERCENTAGE
	FRONT	748 S.F.	124.31 S.F.	16.62 %
	LEFT SIDE	1215 S.F.	81.33 S.F.	6.69 %
	RIGHT SIDE	1215 S.F.	86.17 S.F.	7.09 %
	REAR	748 S.F.	153.05 S.F.	20.46 %
* OPENINGS OMITTED AS PER SB-12 3.1.1.9(4) MAX 19.9 S.F. REFER TO ELEVATION FOR LOCATION			0.00 S.F.	
TOTAL SQ. FT.	3926.00 S.F.	444.86 S.F.	11.33 %	
TOTAL SQ. M.	364.73 S.M.	41.33 S.M.	11.33 %	

UNINSULATED OPENINGS (PER OBC. SB-12,3.1.1(7))				
STANDARD & REAR UPGRADE 10' GDN. FL. & 9' SEC. FL.	S42-19 ELEVATION B -W.O.D.	ENERGY EFFICIENCY - OBC SB12		
	ELEVATION	WALL AREA S.F.	OPENING S.F.	PERCENTAGE
	FRONT	748 S.F.	124.31 S.F.	16.62 %
	LEFT SIDE	1215 S.F.	81.33 S.F.	6.69 %
	RIGHT SIDE	1215 S.F.	74.83 S.F.	6.16 %
	REAR	883 S.F.	175.28 S.F.	19.85 %
* OPENINGS OMITTED AS PER SB-12 3.1.1.9(4) MAX 19.9 S.F. REFER TO ELEVATION FOR LOCATION			0.00 S.F.	
TOTAL SQ. FT.	4061.00 S.F.	455.75 S.F.	11.22 %	
TOTAL SQ. M.	377.28 S.M.	42.34 S.M.	11.22 %	
UNINSULATED OPENINGS (PER OBC. SB-12,3.1.1(7))				
STANDARD & REAR UPGRADE W/ SIDE DOOR 10' GDN. FL. & 9' SEC. FL.	S42-19 ELEVATION B -W.O.D.	ENERGY EFFICIENCY - OBC SB12		
	ELEVATION	WALL AREA S.F.	OPENING S.F.	PERCENTAGE
	FRONT	748 S.F.	124.31 S.F.	16.62 %
	LEFT SIDE	1215 S.F.	81.33 S.F.	6.69 %
	RIGHT SIDE	1215 S.F.	86.17 S.F.	7.09 %
	REAR	883 S.F.	175.28 S.F.	19.85 %
* OPENINGS OMITTED AS PER SB-12 3.1.1.9(4) MAX 19.9 S.F. REFER TO ELEVATION FOR LOCATION			0.00 S.F.	
TOTAL SQ. FT.	4061.00 S.F.	467.09 S.F.	11.50 %	
TOTAL SQ. M.	377.28 S.M.	43.39 S.M.	11.50 %	

UNINSULATED OPENINGS (PER OBC. SB-12,3.1.1(7))				
STANDARD & REAR UPGRADE 10' GDN. FL. & 9' SEC. FL.	S42-19 ELEVATION B -W.O.B.	ENERGY EFFICIENCY - OBC SB12		
	ELEVATION	WALL AREA S.F.	OPENING S.F.	PERCENTAGE
	FRONT	748 S.F.	124.31 S.F.	16.62 %
	LEFT SIDE	1215 S.F.	81.33 S.F.	6.69 %
	RIGHT SIDE	1215 S.F.	74.83 S.F.	6.16 %
	REAR	993 S.F.	228.44 S.F.	23.01 %
* OPENINGS OMITTED AS PER SB-12 3.1.1.9(4) MAX 19.9 S.F. REFER TO ELEVATION FOR LOCATION			0.00 S.F.	
TOTAL SQ. FT.	4171.00 S.F.	508.91 S.F.	12.20 %	
TOTAL SQ. M.	387.50 S.M.	47.28 S.M.	12.20 %	
UNINSULATED OPENINGS (PER OBC. SB-12,3.1.1(7))				
STANDARD & REAR UPGRADE W/ SIDE DOOR 10' GDN. FL. & 9' SEC. FL.	S42-19 ELEVATION B -W.O.B.	ENERGY EFFICIENCY - OBC SB12		
	ELEVATION	WALL AREA S.F.	OPENING S.F.	PERCENTAGE
	FRONT	748 S.F.	124.31 S.F.	16.62 %
	LEFT SIDE	1215 S.F.	81.33 S.F.	6.69 %
	RIGHT SIDE	1215 S.F.	86.17 S.F.	7.09 %
	REAR	993 S.F.	228.44 S.F.	23.01 %
* OPENINGS OMITTED AS PER SB-12 3.1.1.9(4) MAX 19.9 S.F. REFER TO ELEVATION FOR LOCATION			0.00 S.F.	
TOTAL SQ. FT.	4171.00 S.F.	520.25 S.F.	12.47 %	
TOTAL SQ. M.	387.50 S.M.	48.33 S.M.	12.47 %	

10' GROUND, 9' SECOND

9	REVISIONS	DATE	BY	3. REVISED AS PER ENG COMMENTS 2. REVISED AS PER FLOOR / ROOF LAYOUT 1. ISSUED FOR CLIENT REVIEW
	8			
	7			
	6			
5	DESIGNER	DATE	BY	255 Consumers Rd, Suite 120 Toronto, ON M2J 1R4 t 416.630.2255 f 416.630.4782 v3design.com
4				
3				
2				
				
The undersigned has reviewed and takes responsibility for this design and has the qualifications and meets the requirements set out in the Ontario Building Code to be a Designer.				
Wellington Jno-Baptiste (signature) 25591 BCIN 42658 VAS Design Inc.				
project name: BAYVIEW WELLINGTON municipality: GREEN VALLEY EAST drawing no.: SB-12 CHARTS project no.: 16023 drawing no.: 60 checked by: JWM date: OCTOBER 2021 scale: 3/16" = 1'-0" drawn by: TP date: 3/16/2021 file name: 16023-S42-19				
project name: BAYVIEW WELLINGTON municipality: GREEN VALLEY EAST drawing no.: SB-12 CHARTS project no.: 16023 drawing no.: 60 checked by: JWM date: OCTOBER 2021 scale: 3/16" = 1'-0" drawn by: TP date: 3/16/2021 file name: 16023-S42-19				

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UNINSULATED OPENINGS (PER OBC. SB-12,3.1.1(7))				
STANDARD 10' GDN. FL. & 9' SEC. FL.	S42-19 ELEVATION C	ENERGY EFFICIENCY - OBC SB12		
	ELEVATION	WALL AREA S.F.	OPENING S.F.	PERCENTAGE
FRONT		748 S.F.	179.81 S.F.	24.04 %
LEFT SIDE		1215 S.F.	108.17 S.F.	8.90 %
RIGHT SIDE		1215 S.F.	86.50 S.F.	7.12 %
REAR		748 S.F.	153.05 S.F.	20.46 %
	* OPENINGS OMITTED AS PER SB-12 3.1.1.9(4) MAX 19.9 S.F. REFER TO ELEVATION FOR LOCATION		0.00 S.F.	
TOTAL SQ. FT.		3926.00 S.F.	527.53 S.F.	13.44 %
TOTAL SQ. M.		364.73 S.M.	49.01 S.M.	13.44 %
UNINSULATED OPENINGS (PER OBC. SB-12,3.1.1(7))				
STANDARD W/ SIDE DOOR 10' GDN. FL. & 9' SEC. FL.	S42-19 ELEVATION C	ENERGY EFFICIENCY - OBC SB12		
	ELEVATION	WALL AREA S.F.	OPENING S.F.	PERCENTAGE
FRONT		748 S.F.	179.81 S.F.	24.04 %
LEFT SIDE		1215 S.F.	108.17 S.F.	8.90 %
RIGHT SIDE		1215 S.F.	97.83 S.F.	8.05 %
REAR		748 S.F.	153.05 S.F.	20.46 %
	* OPENINGS OMITTED AS PER SB-12 3.1.1.9(4) MAX 19.9 S.F. REFER TO ELEVATION FOR LOCATION		0.00 S.F.	
TOTAL SQ. FT.		3926.00 S.F.	538.86 S.F.	13.73 %
TOTAL SQ. M.		364.73 S.M.	50.06 S.M.	13.73 %

UNINSULATED OPENINGS (PER OBC. SB-12,3.1.1(7))				
STANDARD 10' GDN. FL. & 9' SEC. FL.	S42-19 ELEVATION C -W.O.D.	ENERGY EFFICIENCY - OBC SB12		
	ELEVATION	WALL AREA S.F.	OPENING S.F.	PERCENTAGE
FRONT		748 S.F.	179.81 S.F.	24.04 %
LEFT SIDE		1215 S.F.	108.17 S.F.	8.90 %
RIGHT SIDE		1215 S.F.	86.50 S.F.	7.12 %
REAR		883 S.F.	175.28 S.F.	19.85 %
	* OPENINGS OMITTED AS PER SB-12 3.1.1.9(4) MAX 19.9 S.F. REFER TO ELEVATION FOR LOCATION		0.00 S.F.	
TOTAL SQ. FT.		4061.00 S.F.	549.76 S.F.	13.54 %
TOTAL SQ. M.		377.28 S.M.	51.07 S.M.	13.54 %
UNINSULATED OPENINGS (PER OBC. SB-12,3.1.1(7))				
STANDARD W/ SIDE DOOR 10' GDN. FL. & 9' SEC. FL.	S42-19 ELEVATION C -W.O.D.	ENERGY EFFICIENCY - OBC SB12		
	ELEVATION	WALL AREA S.F.	OPENING S.F.	PERCENTAGE
FRONT		748 S.F.	179.81 S.F.	24.04 %
LEFT SIDE		1215 S.F.	108.17 S.F.	8.90 %
RIGHT SIDE		1215 S.F.	97.83 S.F.	8.05 %
REAR		883 S.F.	175.28 S.F.	19.85 %
	* OPENINGS OMITTED AS PER SB-12 3.1.1.9(4) MAX 19.9 S.F. REFER TO ELEVATION FOR LOCATION		0.00 S.F.	
TOTAL SQ. FT.		4061.00 S.F.	561.09 S.F.	13.82 %
TOTAL SQ. M.		377.28 S.M.	52.13 S.M.	13.82 %

UNINSULATED OPENINGS (PER OBC. SB-12,3.1.1(7))				
STANDARD 10' GDN. FL. & 9' SEC. FL.	S42-19 ELEVATION C -W.O.B.	ENERGY EFFICIENCY - OBC SB12		
	ELEVATION	WALL AREA S.F.	OPENING S.F.	PERCENTAGE
FRONT		748 S.F.	179.81 S.F.	24.04 %
LEFT SIDE		1215 S.F.	108.17 S.F.	8.90 %
RIGHT SIDE		1215 S.F.	86.50 S.F.	7.12 %
REAR		993 S.F.	228.44 S.F.	23.01 %
	* OPENINGS OMITTED AS PER SB-12 3.1.1.9(4) MAX 19.9 S.F. REFER TO ELEVATION FOR LOCATION		0.00 S.F.	
TOTAL SQ. FT.		4171.00 S.F.	602.92 S.F.	14.46 %
TOTAL SQ. M.		387.50 S.M.	56.01 S.M.	14.46 %
UNINSULATED OPENINGS (PER OBC. SB-12,3.1.1(7))				
STANDARD W/ SIDE DOOR 10' GDN. FL. & 9' SEC. FL.	S42-19 ELEVATION C -W.O.B.	ENERGY EFFICIENCY - OBC SB12		
	ELEVATION	WALL AREA S.F.	OPENING S.F.	PERCENTAGE
FRONT		748 S.F.	179.81 S.F.	24.04 %
LEFT SIDE		1215 S.F.	108.17 S.F.	8.90 %
RIGHT SIDE		1215 S.F.	97.83 S.F.	8.05 %
REAR		993 S.F.	228.44 S.F.	23.01 %
	* OPENINGS OMITTED AS PER SB-12 3.1.1.9(4) MAX 19.9 S.F. REFER TO ELEVATION FOR LOCATION		0.00 S.F.	
TOTAL SQ. FT.		4171.00 S.F.	614.25 S.F.	14.73 %
TOTAL SQ. M.		387.50 S.M.	57.07 S.M.	14.73 %

UNINSULATED OPENINGS (PER OBC. SB-12,3.1.1(7))				
REAR UPGRADE 10' GDN. FL. & 9' SEC. FL.	S42-19 ELEVATION C	ENERGY EFFICIENCY - OBC SB12		
	ELEVATION	WALL AREA S.F.	OPENING S.F.	PERCENTAGE
FRONT		748 S.F.	179.81 S.F.	24.04 %
LEFT SIDE		1215 S.F.	108.17 S.F.	8.90 %
RIGHT SIDE		1215 S.F.	86.50 S.F.	7.12 %
REAR		748 S.F.	176.05 S.F.	23.54 %
	* OPENINGS OMITTED AS PER SB-12 3.1.1.9(4) MAX 19.9 S.F. REFER TO ELEVATION FOR LOCATION		0.00 S.F.	
TOTAL SQ. FT.		3926.00 S.F.	550.53 S.F.	14.02 %
TOTAL SQ. M.		364.73 S.M.	51.15 S.M.	14.02 %
UNINSULATED OPENINGS (PER OBC. SB-12,3.1.1(7))				
REAR UPGRADE 10' GDN. FL. & 9' SEC. FL.	S42-19 ELEVATION C	ENERGY EFFICIENCY - OBC SB12		
	ELEVATION	WALL AREA S.F.	OPENING S.F.	PERCENTAGE
FRONT		748 S.F.	179.81 S.F.	24.04 %
LEFT SIDE		1215 S.F.	108.17 S.F.	8.90 %
RIGHT SIDE		1215 S.F.	97.83 S.F.	8.05 %
REAR		748 S.F.	176.05 S.F.	23.54 %
	* OPENINGS OMITTED AS PER SB-12 3.1.1.9(4) MAX 19.9 S.F. REFER TO ELEVATION FOR LOCATION		0.00 S.F.	
TOTAL SQ. FT.		3926.00 S.F.	561.86 S.F.	14.31 %
TOTAL SQ. M.		364.73 S.M.	52.20 S.M.	14.31 %

UNINSULATED OPENINGS (PER OBC. SB-12,3.1.1(7))				
REAR UPGRADE 10' GDN. FL. & 9' SEC. FL.	S42-19 ELEVATION C -W.O.D.	ENERGY EFFICIENCY - OBC SB12		
	ELEVATION	WALL AREA S.F.	OPENING S.F.	PERCENTAGE
FRONT		748 S.F.	179.81 S.F.	24.04 %
LEFT SIDE		1215 S.F.	108.17 S.F.	8.90 %
RIGHT SIDE		1215 S.F.	86.50 S.F.	7.12 %
REAR		883 S.F.	200.50 S.F.	22.71 %
	* OPENINGS OMITTED AS PER SB-12 3.1.1.9(4) MAX 19.9 S.F. REFER TO ELEVATION FOR LOCATION		0.00 S.F.	
TOTAL SQ. FT.		4061.00 S.F.	574.98 S.F.	14.16 %
TOTAL SQ. M.		377.28 S.M.	53.42 S.M.	14.16 %
UNINSULATED OPENINGS (PER OBC. SB-12,3.1.1(7))				
REAR UPGRADE 10' GDN. FL. & 9' SEC. FL.	S42-19 ELEVATION C -W.O.D.	ENERGY EFFICIENCY - OBC SB12		
	ELEVATION	WALL AREA S.F.	OPENING S.F.	PERCENTAGE
FRONT		748 S.F.	179.81 S.F.	24.04 %
LEFT SIDE		1215 S.F.	108.17 S.F.	8.90 %
RIGHT SIDE		1215 S.F.	97.83 S.F.	8.05 %
REAR		883 S.F.	200.50 S.F.	22.71 %
	* OPENINGS OMITTED AS PER SB-12 3.1.1.9(4) MAX 19.9 S.F. REFER TO ELEVATION FOR LOCATION		0.00 S.F.	
TOTAL SQ. FT.		4061.00 S.F.	586.31 S.F.	14.44 %
TOTAL SQ. M.		377.28 S.M.	54.47 S.M.	14.44 %

UNINSULATED OPENINGS (PER OBC. SB-12,3.1.1(7))				
REAR UPGRADE 10' GDN. FL. & 9' SEC. FL.	S42-19 ELEVATION C -W.O.B.	ENERGY EFFICIENCY - OBC SB12		
	ELEVATION	WALL AREA S.F.	OPENING S.F.	PERCENTAGE
FRONT		748 S.F.	179.81 S.F.	24.04 %
LEFT SIDE		1215 S.F.	108.17 S.F.	8.90 %
RIGHT SIDE		1215 S.F.	86.50 S.F.	7.12 %
REAR		993 S.F.	254.78 S.F.	25.66 %
	* OPENINGS OMITTED AS PER SB-12 3.1.1.9(4) MAX 19.9 S.F. REFER TO ELEVATION FOR LOCATION		0.00 S.F.	
TOTAL SQ. FT.		4171.00 S.F.	629.26 S.F.	15.09 %
TOTAL SQ. M.		387.50 S.M.	58.46 S.M.	15.09 %
UNINSULATED OPENINGS (PER OBC. SB-12,3.1.1(7))				
REAR UPGRADE 10' GDN. FL. & 9' SEC. FL.	S42-19 ELEVATION C -W.O.B.	ENERGY EFFICIENCY - OBC SB12		
	ELEVATION	WALL AREA S.F.	OPENING S.F.	PERCENTAGE
FRONT		748 S.F.	179.81 S.F.	24.04 %
LEFT SIDE		1215 S.F.	108.17 S.F.	8.90 %
RIGHT SIDE		1215 S.F.	97.83 S.F.	8.05 %
REAR		993 S.F.	254.78 S.F.	25.66 %
	* OPENINGS OMITTED AS PER SB-12 3.1.1.9(4) MAX 19.9 S.F. REFER TO ELEVATION FOR LOCATION		0.00 S.F.	
TOTAL SQ. FT.		4171.00 S.F.	640.59 S.F.	15.36 %
TOTAL SQ. M.		387.50 S.M.	59.51 S.M.	15.36 %

10' GROUND, 9' SECOND

		BAYVIEW WELLINGTON S42-19	
project name GREEN VALLEY EAST		municipality BRADFORD, ONTARIO	
date OCTOBER 2021		drawing no. SB-12 CHARTS	
checked by JWM		project no. 16023	
drawn by TP		drawing no. 61	
scale 3/16" = 1'-0"		file name 16023-S42-19	
255 Consumers Rd, Suite 120 Toronto, ON M2J 1R4 t 416.630.2255 f 416.630.4782 vabdesign.com		RICHARD - H:\ARCHIVE\WORKING\2016\16023\WB\Units\42\16023-S42-19.dwg - Tue - Mar 8 2022 - 1:01 PM	

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UNINSULATED OPENINGS (PER OBC. SB-12,3.1.1(7))				
STANDARD & REAR UPGRADE 10' GDN. FL., 9' SEC. FL. & 9' BASEMENT	S42-19 ELEVATION A -W.O.B.	ENERGY EFFICIENCY - OBC SB12		
	ELEVATION	WALL AREA S.F.	OPENING S.F.	PERCENTAGE
FRONT	748 S.F.	132.31 S.F.	17.69 %	
LEFT SIDE	1215 S.F.	81.33 S.F.	6.69 %	
RIGHT SIDE	1215 S.F.	74.83 S.F.	6.16 %	
REAR	1026 S.F.	228.44 S.F.	22.27 %	
	* OPENINGS OMITTED AS PER SB-12 3.1.1.9(4) MAX 19.9 S.F. REFER TO ELEVATION FOR LOCATION		0.00 S.F.	
TOTAL SQ. FT.	4204.00 S.F.	516.91 S.F.	12.30 %	
TOTAL SQ. M.	390.56 S.M.	48.02 S.M.	12.30 %	
UNINSULATED OPENINGS (PER OBC. SB-12,3.1.1(7))				
STANDARD & REAR UPGRADE W/ SIDE DOOR 10' GDN. FL., 9' SEC. FL. & 9' BASEMENT	S42-19 ELEVATION A -W.O.B.	ENERGY EFFICIENCY - OBC SB12		
	ELEVATION	WALL AREA S.F.	OPENING S.F.	PERCENTAGE
FRONT	748 S.F.	132.31 S.F.	17.69 %	
LEFT SIDE	1215 S.F.	81.33 S.F.	6.69 %	
RIGHT SIDE	1215 S.F.	86.17 S.F.	7.09 %	
REAR	1026 S.F.	228.44 S.F.	22.27 %	
	* OPENINGS OMITTED AS PER SB-12 3.1.1.9(4) MAX 19.9 S.F. REFER TO ELEVATION FOR LOCATION		0.00 S.F.	
TOTAL SQ. FT.	4204.00 S.F.	528.25 S.F.	12.57 %	
TOTAL SQ. M.	390.56 S.M.	49.08 S.M.	12.57 %	

UNINSULATED OPENINGS (PER OBC. SB-12,3.1.1(7))				
STANDARD & REAR UPGRADE 10' GDN. FL., 9' SEC. FL. & 9' BASEMENT	S42-19 ELEVATION B -W.O.B.	ENERGY EFFICIENCY - OBC SB12		
	ELEVATION	WALL AREA S.F.	OPENING S.F.	PERCENTAGE
FRONT	748 S.F.	124.31 S.F.	16.62 %	
LEFT SIDE	1215 S.F.	81.33 S.F.	6.69 %	
RIGHT SIDE	1215 S.F.	74.83 S.F.	6.16 %	
REAR	1026 S.F.	228.44 S.F.	22.27 %	
	* OPENINGS OMITTED AS PER SB-12 3.1.1.9(4) MAX 19.9 S.F. REFER TO ELEVATION FOR LOCATION		0.00 S.F.	
TOTAL SQ. FT.	4204.00 S.F.	508.91 S.F.	12.11 %	
TOTAL SQ. M.	390.56 S.M.	47.28 S.M.	12.11 %	
UNINSULATED OPENINGS (PER OBC. SB-12,3.1.1(7))				
STANDARD & REAR UPGRADE W/ SIDE DOOR 10' GDN. FL., 9' SEC. FL. & 9' BASEMENT	S42-19 ELEVATION B -W.O.B.	ENERGY EFFICIENCY - OBC SB12		
	ELEVATION	WALL AREA S.F.	OPENING S.F.	PERCENTAGE
FRONT	748 S.F.	124.31 S.F.	16.62 %	
LEFT SIDE	1215 S.F.	81.33 S.F.	6.69 %	
RIGHT SIDE	1215 S.F.	86.17 S.F.	7.09 %	
REAR	1026 S.F.	228.44 S.F.	22.27 %	
	* OPENINGS OMITTED AS PER SB-12 3.1.1.9(4) MAX 19.9 S.F. REFER TO ELEVATION FOR LOCATION		0.00 S.F.	
TOTAL SQ. FT.	4204.00 S.F.	520.25 S.F.	12.38 %	
TOTAL SQ. M.	390.56 S.M.	48.33 S.M.	12.38 %	

UNINSULATED OPENINGS (PER OBC. SB-12,3.1.1(7))				
STANDARD 10' GDN. FL., 9' SEC. FL. & 9' BASEMENT	S42-19 ELEVATION C -W.O.B.	ENERGY EFFICIENCY - OBC SB12		
	ELEVATION	WALL AREA S.F.	OPENING S.F.	PERCENTAGE
FRONT	748 S.F.	179.81 S.F.	24.04 %	
LEFT SIDE	1215 S.F.	108.17 S.F.	8.90 %	
RIGHT SIDE	1215 S.F.	86.50 S.F.	7.12 %	
REAR	1026 S.F.	228.44 S.F.	22.27 %	
	* OPENINGS OMITTED AS PER SB-12 3.1.1.9(4) MAX 19.9 S.F. REFER TO ELEVATION FOR LOCATION		0.00 S.F.	
TOTAL SQ. FT.	4204.00 S.F.	602.92 S.F.	14.34 %	
TOTAL SQ. M.	390.56 S.M.	56.01 S.M.	14.34 %	
UNINSULATED OPENINGS (PER OBC. SB-12,3.1.1(7))				
STANDARD W/ SIDE DOOR 10' GDN. FL., 9' SEC. FL. & 9' BASEMENT	S42-19 ELEVATION C -W.O.B.	ENERGY EFFICIENCY - OBC SB12		
	ELEVATION	WALL AREA S.F.	OPENING S.F.	PERCENTAGE
FRONT	748 S.F.	179.81 S.F.	24.04 %	
LEFT SIDE	1215 S.F.	108.17 S.F.	8.90 %	
RIGHT SIDE	1215 S.F.	97.83 S.F.	8.05 %	
REAR	1026 S.F.	228.44 S.F.	22.27 %	
	* OPENINGS OMITTED AS PER SB-12 3.1.1.9(4) MAX 19.9 S.F. REFER TO ELEVATION FOR LOCATION		0.00 S.F.	
TOTAL SQ. FT.	4204.00 S.F.	614.25 S.F.	14.61 %	
TOTAL SQ. M.	390.56 S.M.	57.07 S.M.	14.61 %	

UNINSULATED OPENINGS (PER OBC. SB-12,3.1.1(7))				
REAR UPGRADE 10' GDN. FL., 9' SEC. FL. & 9' BASEMENT	S42-19 ELEVATION C -W.O.B.	ENERGY EFFICIENCY - OBC SB12		
	ELEVATION	WALL AREA S.F.	OPENING S.F.	PERCENTAGE
FRONT	748 S.F.	179.81 S.F.	24.04 %	
LEFT SIDE	1215 S.F.	108.17 S.F.	8.90 %	
RIGHT SIDE	1215 S.F.	86.50 S.F.	7.12 %	
REAR	1026 S.F.	254.78 S.F.	24.83 %	
	* OPENINGS OMITTED AS PER SB-12 3.1.1.9(4) MAX 19.9 S.F. REFER TO ELEVATION FOR LOCATION		0.00 S.F.	
TOTAL SQ. FT.	4204.00 S.F.	629.26 S.F.	14.97 %	
TOTAL SQ. M.	390.56 S.M.	58.46 S.M.	14.97 %	
UNINSULATED OPENINGS (PER OBC. SB-12,3.1.1(7))				
REAR UPGRADE W/ SIDE DOOR 10' GDN. FL., 9' SEC. FL. & 9' BASEMENT	S42-19 ELEVATION C -W.O.B.	ENERGY EFFICIENCY - OBC SB12		
	ELEVATION	WALL AREA S.F.	OPENING S.F.	PERCENTAGE
FRONT	748 S.F.	179.81 S.F.	24.04 %	
LEFT SIDE	1215 S.F.	108.17 S.F.	8.90 %	
RIGHT SIDE	1215 S.F.	97.83 S.F.	8.05 %	
REAR	1026 S.F.	254.78 S.F.	24.83 %	
	* OPENINGS OMITTED AS PER SB-12 3.1.1.9(4) MAX 19.9 S.F. REFER TO ELEVATION FOR LOCATION		0.00 S.F.	
TOTAL SQ. FT.	4204.00 S.F.	640.59 S.F.	15.24 %	
TOTAL SQ. M.	390.56 S.M.	59.51 S.M.	15.24 %	

10' GROUND, 9' SECOND, 9' BASEMENT


9				
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5				
4				
3	REVISED AS PER ENG COMMENTS	MAR 03-22	RC	
2	REVISED AS PER FLOOR / ROOF LAYOUT	FEB 24-22	RC	
1	ISSUED FOR CLIENT REVIEW	NOV 26-21	VA3	
no.	description	date	by	

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 vasdesign.com

BAYVIEW WELLINGTON
 GREEN VALLEY EAST
 BRADFORD, ONTARIO

S42-19
 project no. 16023
 drawing no. 62
 checked by JWM
 date OCTOBER 2021
 scale 3/16" = 1'-0"

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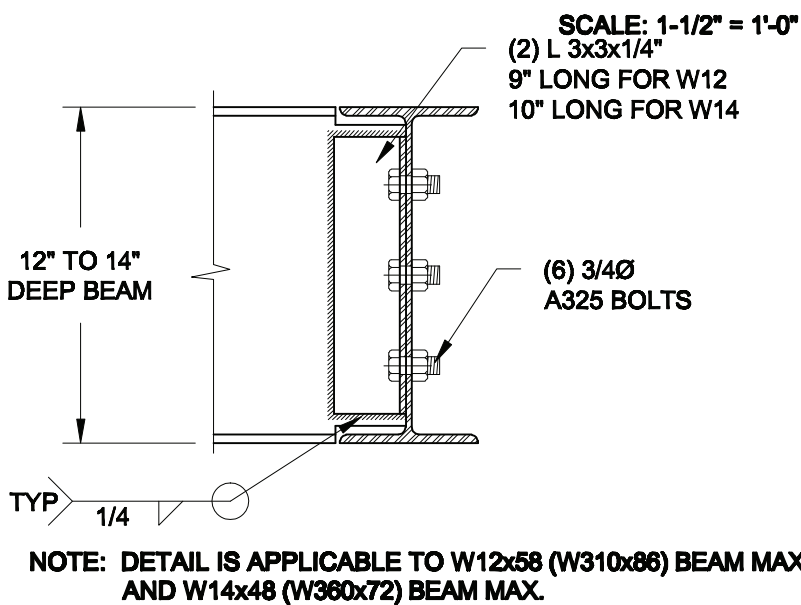
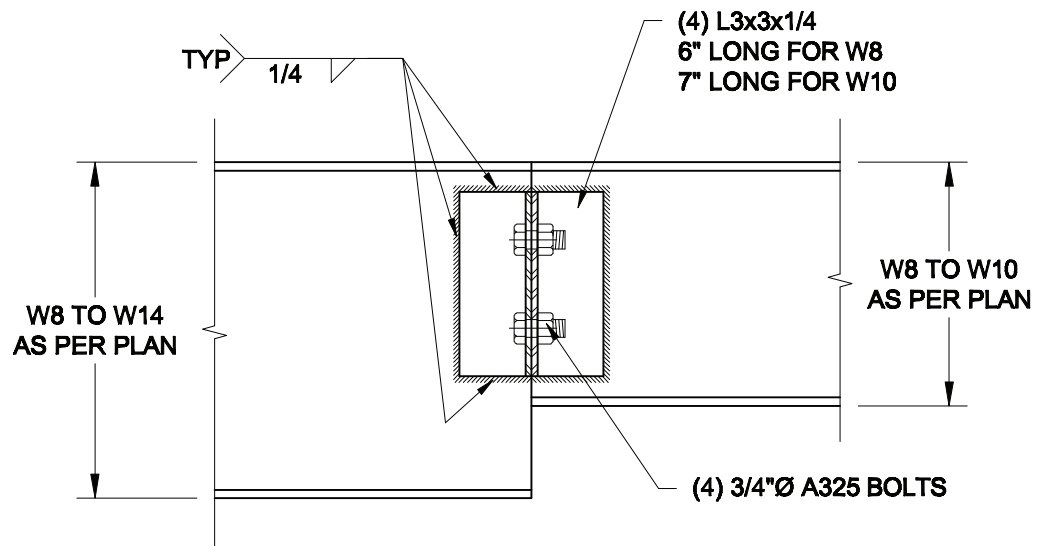
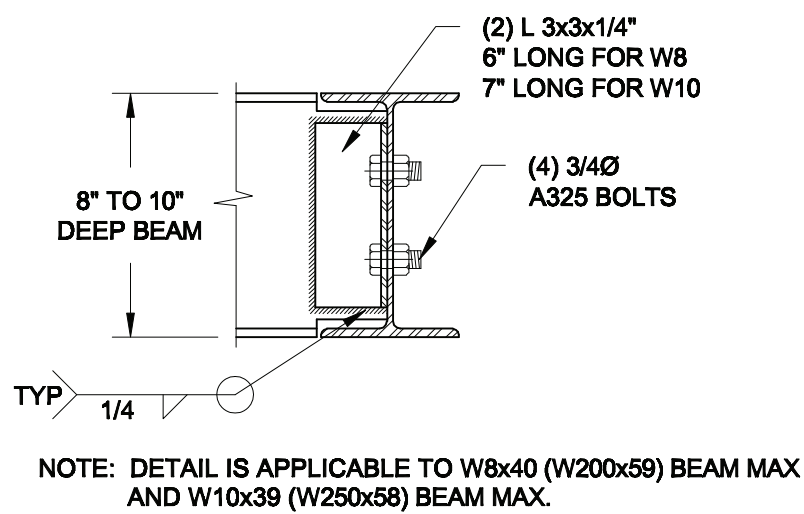


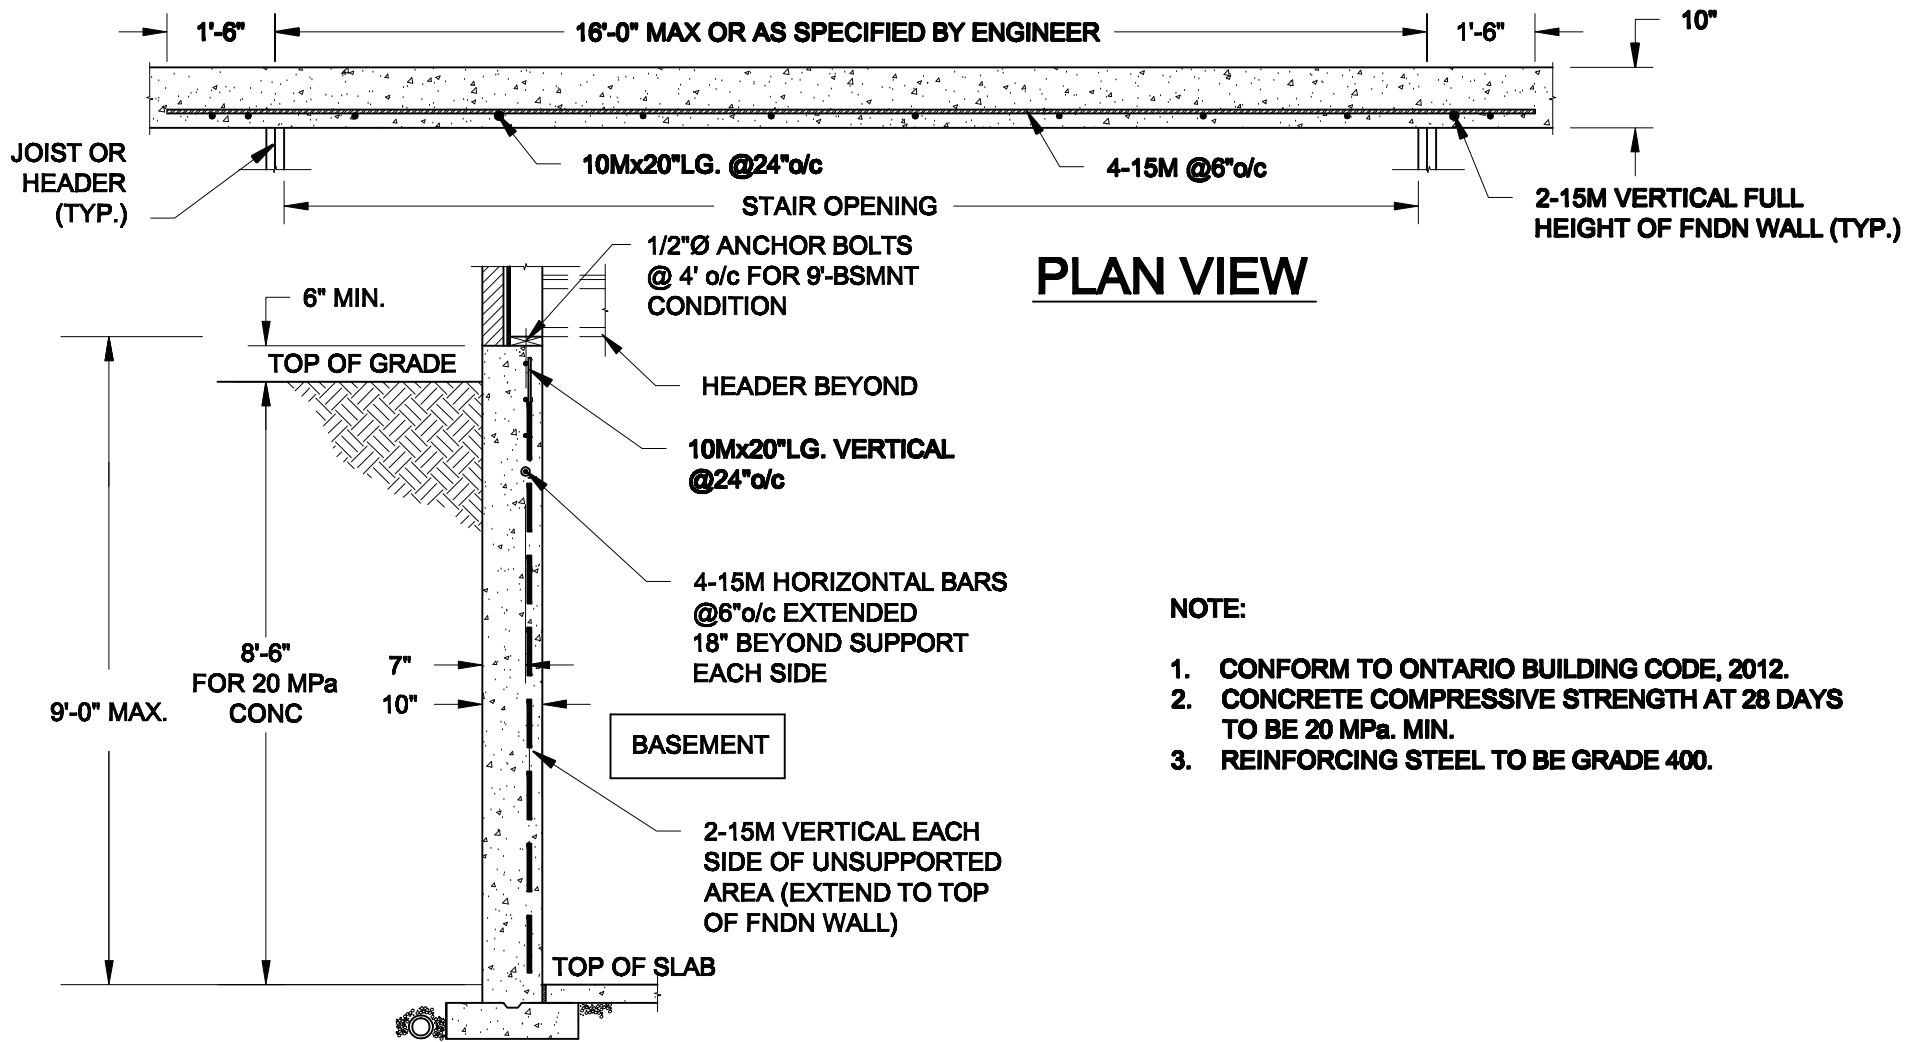PLAN VIEW

NOTE:

1. CONFORM TO ONTARIO BUILDING CODE, 2012.
2. CONCRETE COMPRESSIVE STRENGTH AT 28 DAYS TO BE 20 MPa. MIN.
3. REINFORCING STEEL TO BE GRADE 400.

1 **LATERALLY UNSUPPORTED WALL**
S1 SCALE: 3/8" = 1'-0"



2 **STEEL BEAM CONNECTION DETAILS**
S1

Scale: AS NOTED	
Date: FEB-17-2022	
Drawn: SC	Checked: SJB

QUAILE ENGINEERING LTD.



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Engineer's Seal



Project:

BAYVIEW WELLINGTON HOMES - GREEN VALLEY ESTATES - SINGLES BRADFORD, ONTARIO

TYPICAL STRUCTURAL DETAILS


Project No.:

21-038


Drawing No.:

S1

FOR 9 1/2" JOIST DEPTH

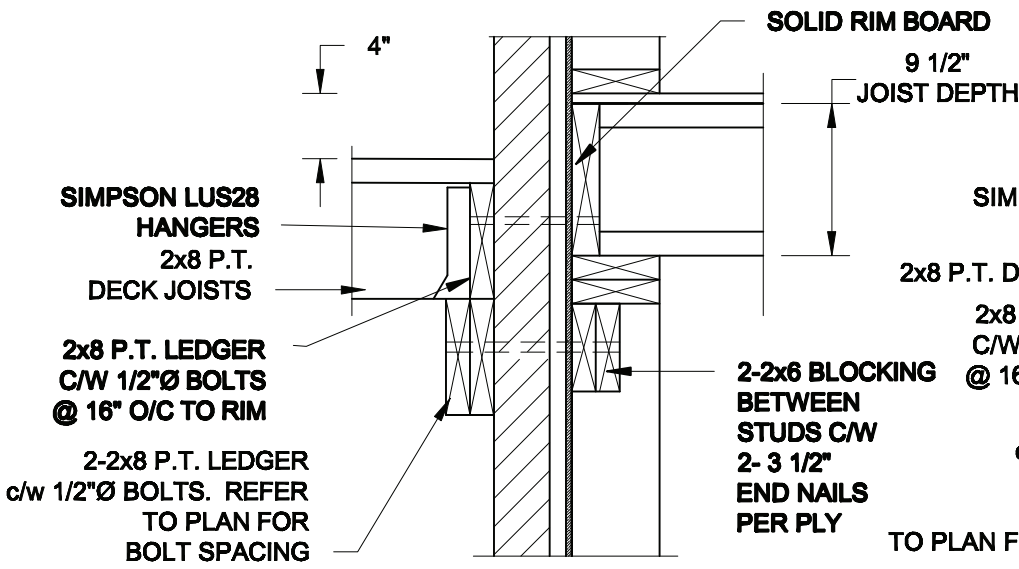


1A DECK FASTENING DETAIL
S2 SCALE: 1" = 1'-0"

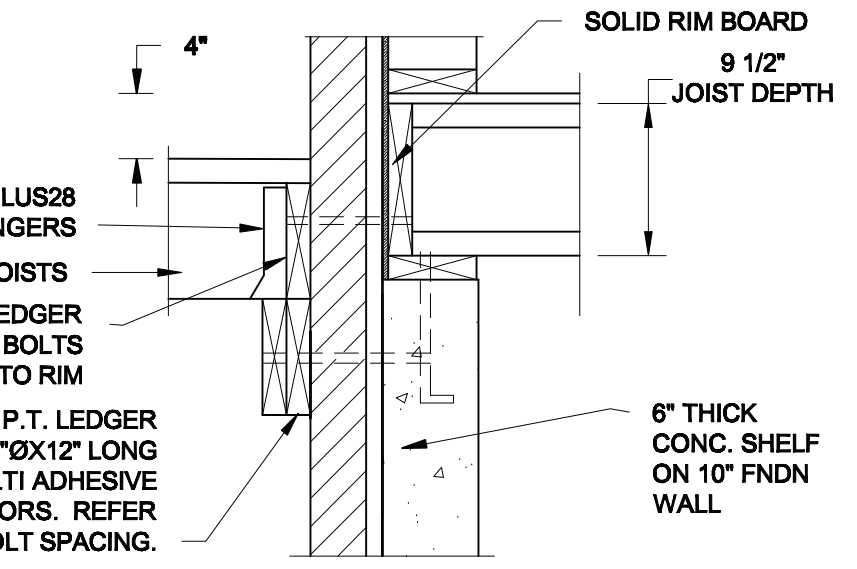


1B DECK FASTENING DETAIL
S2 SCALE: 1" = 1'-0"

FOR 11 7/8" JOIST DEPTH

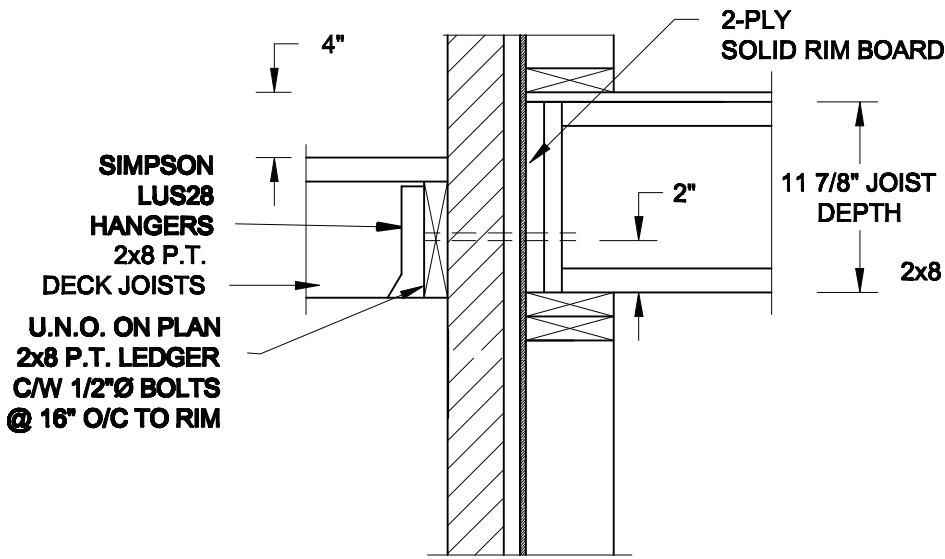


1C DECK FASTENING DETAIL
S2 SCALE: 1" = 1'-0"

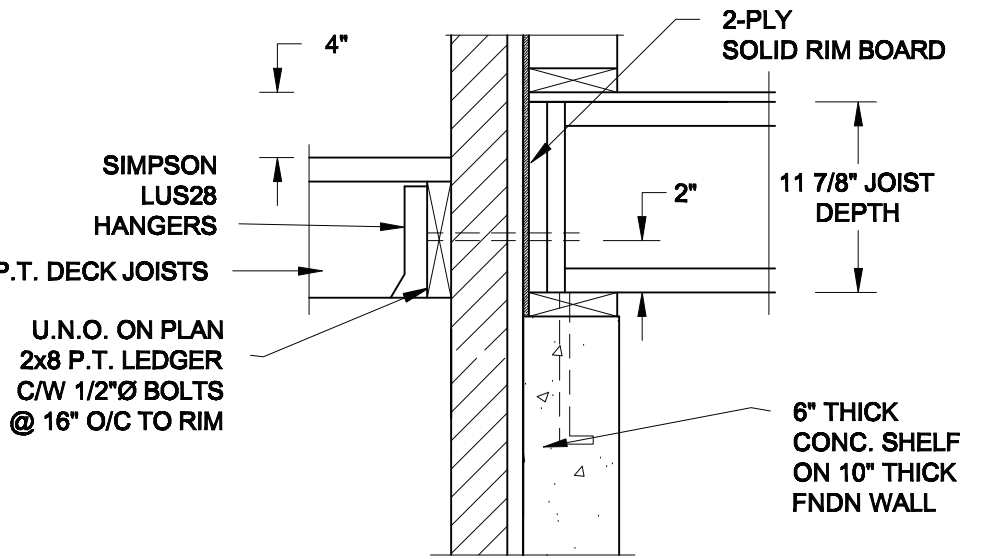

1D DECK FASTENING DETAIL
S2 SCALE: 1" = 1'-0"


- NOTE: 1. WHERE BACKFILL HEIGHT < 4'-7", PROVIDE 2x6 @ 16" o/c KNEEWALL ON 10" THICK CONC FNDN WALL
2. WHERE BACKFILL HEIGHT > 4'-7", PROVIDE 6" CONC SHELF FOR BRICK VENEER ON 10" THICK CONC FNDN WALL
3. FOOTING TO BE 22"x6" THICK UNLESS NOTED OTHERWISE ON PLAN.

FOR 9 1/2" JOIST DEPTH

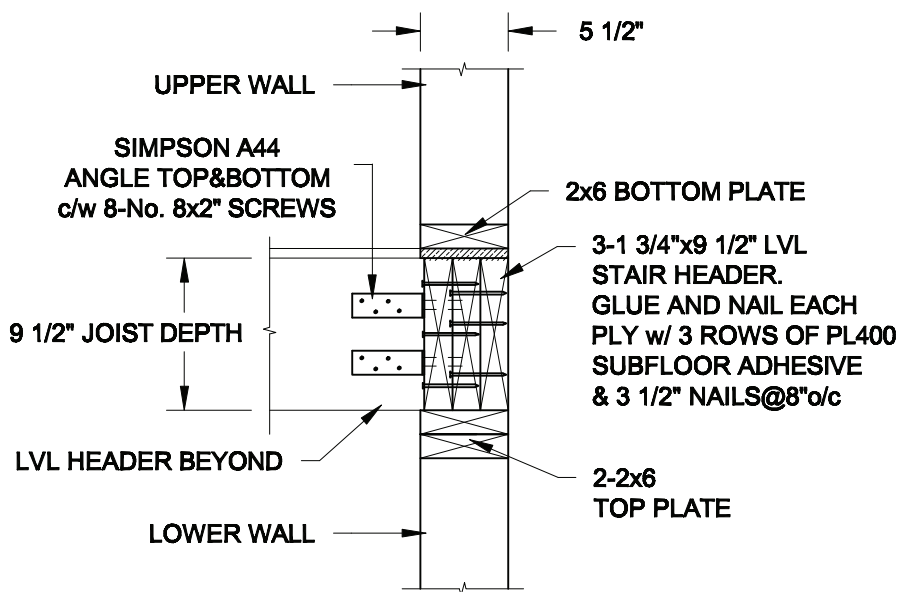

2A STAIR HEADER
S2 SCALE: 1" = 1'-0"

FOR 11 7/8" JOIST DEPTH

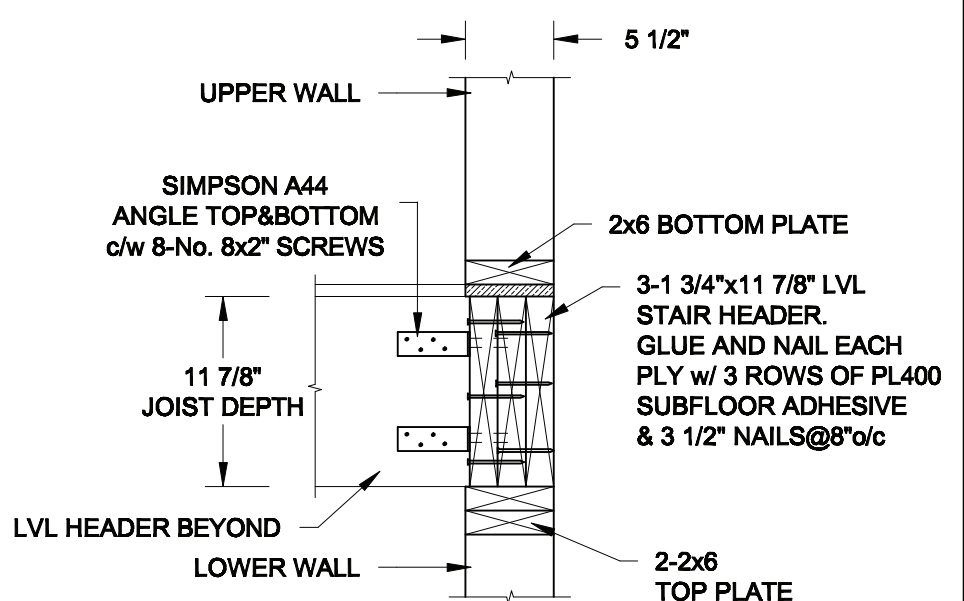

2B STAIR HEADER
S2 SCALE: 1" = 1'-0"

Scale: AS NOTED	
Date: MAR-16-2021	
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Project:

**BAYVIEW WELLINGTON HOMES - GREEN VALLEY ESTATES - SINGLES
BRADFORD, ONTARIO**


TYPICAL STRUCTURAL DETAILS

Project No.:


21-038

Drawing No.:


S2

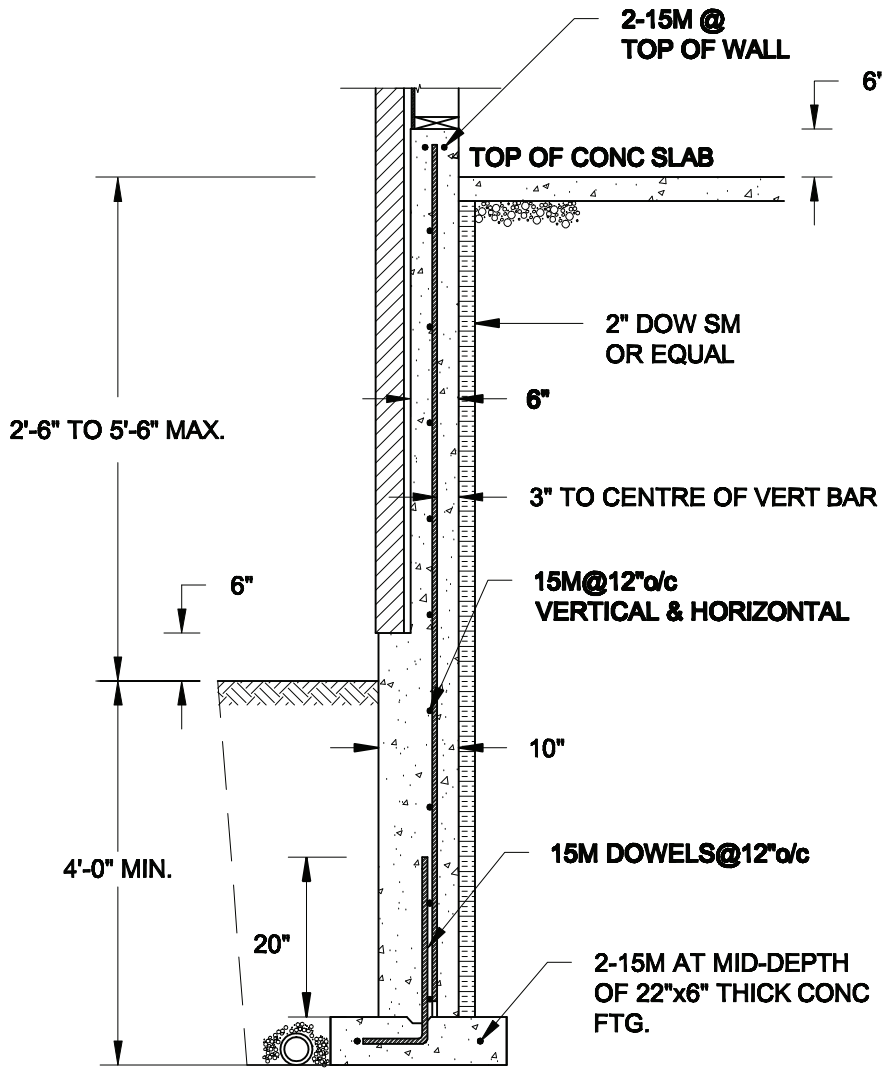

1A REINFORCED BRICKSHELF
S3 SCALE: 1/2" = 1' - 0"

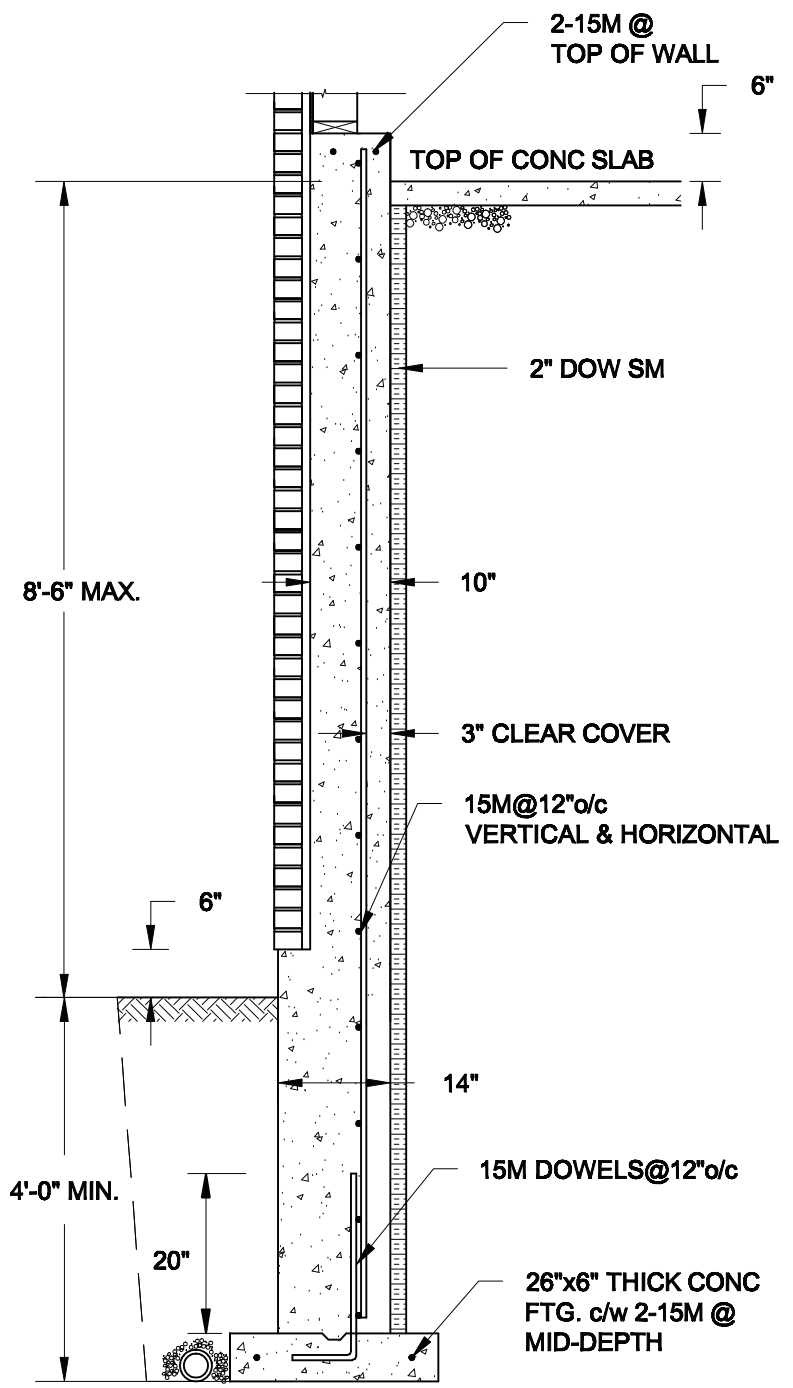


1B REINFORCED BRICKSHELF
S3 SCALE: 1/2" = 1' - 0"

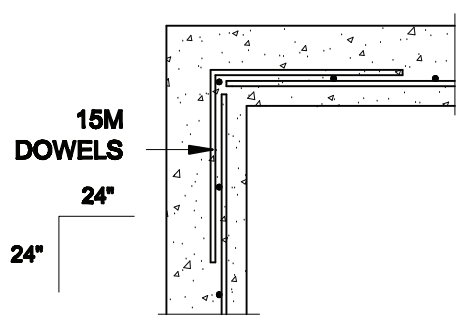

1C PLAN VIEW AT CORNER
S3 SCALE: 1/2" = 1' - 0"

NOTES:


1. CONFORM TO THE ONTARIO BUILDING CODE, 2012.
2. CONCRETE TO HAVE A 28-DAY COMPRESSIVE STRENGTH OF 20 MPa.
3. REINFORCING STEEL TO BE GRADE 400.
4. LAP REINFORCING STEEL 24" AT SPLICES. PROVIDE 24"x24" L-SHAPE BARS AT ALL CORNERS - SEE DETAIL 1C/S3.
5. PROVIDE 3" COVER TO SOIL MINIMUM.
6. BACKFILL ASSUMED TO BE FREE-DRAINING MATERIAL AS PER PART 9 OF THE OBC.

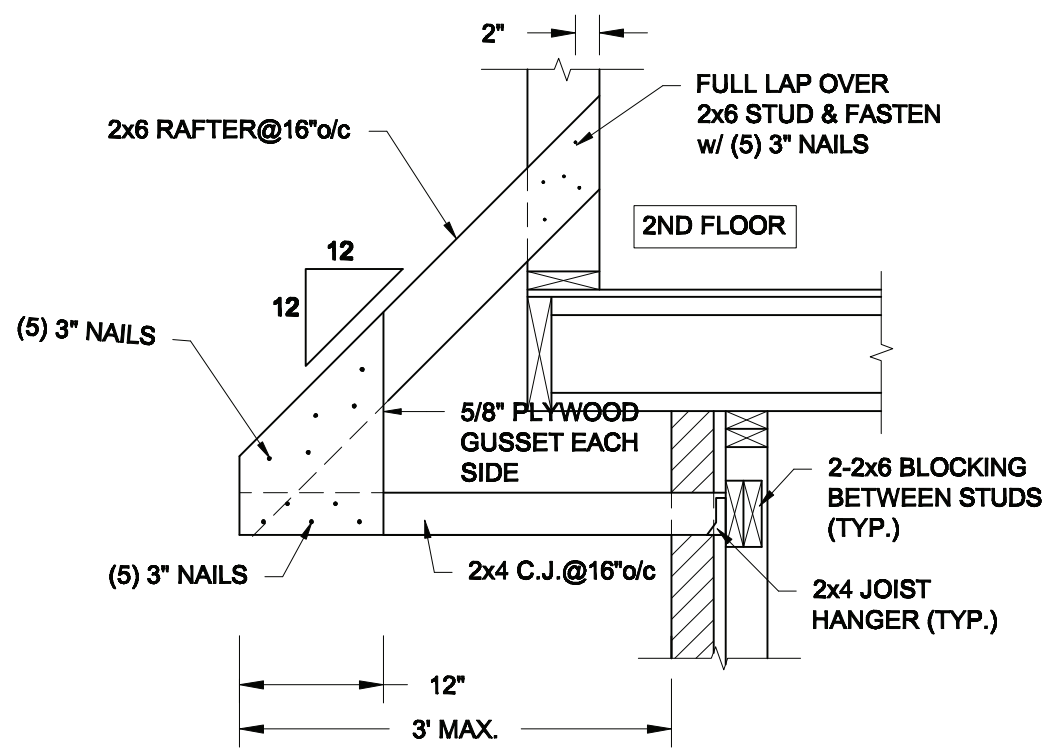

2 CANOPY ROOF OVER GARAGE
S3 SCALE: 3/4" = 1' - 0"

Scale: AS NOTED	
Date: FEB-24-2022	
Drawn: SC	Checked: SJB

QUAILE ENGINEERING LTD.




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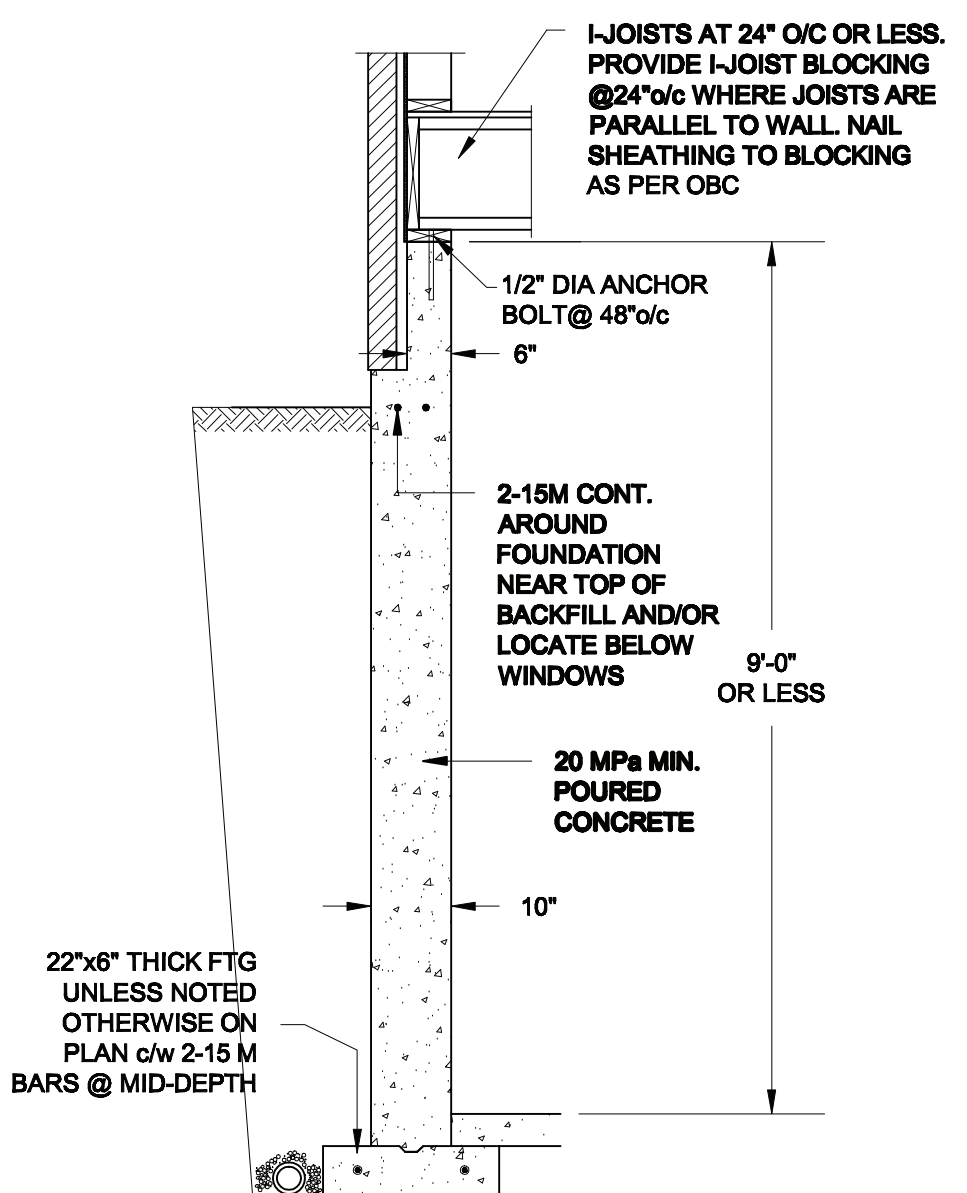


S. J. BOYD
 90214198
 PROVINCE OF ONTARIO
 FEB 24, 2022


Project: BAYVIEW WELLINGTON HOMES - GREEN VALLEY ESTATES - SINGLES BRADFORD, ONTARIO	
TYPICAL STRUCTURAL DETAILS	
Project No.: 21-038	Drawing No.: S3



1A
S4 **FOUNDATION WALL**
SCALE: 1/2" = 1'-0"

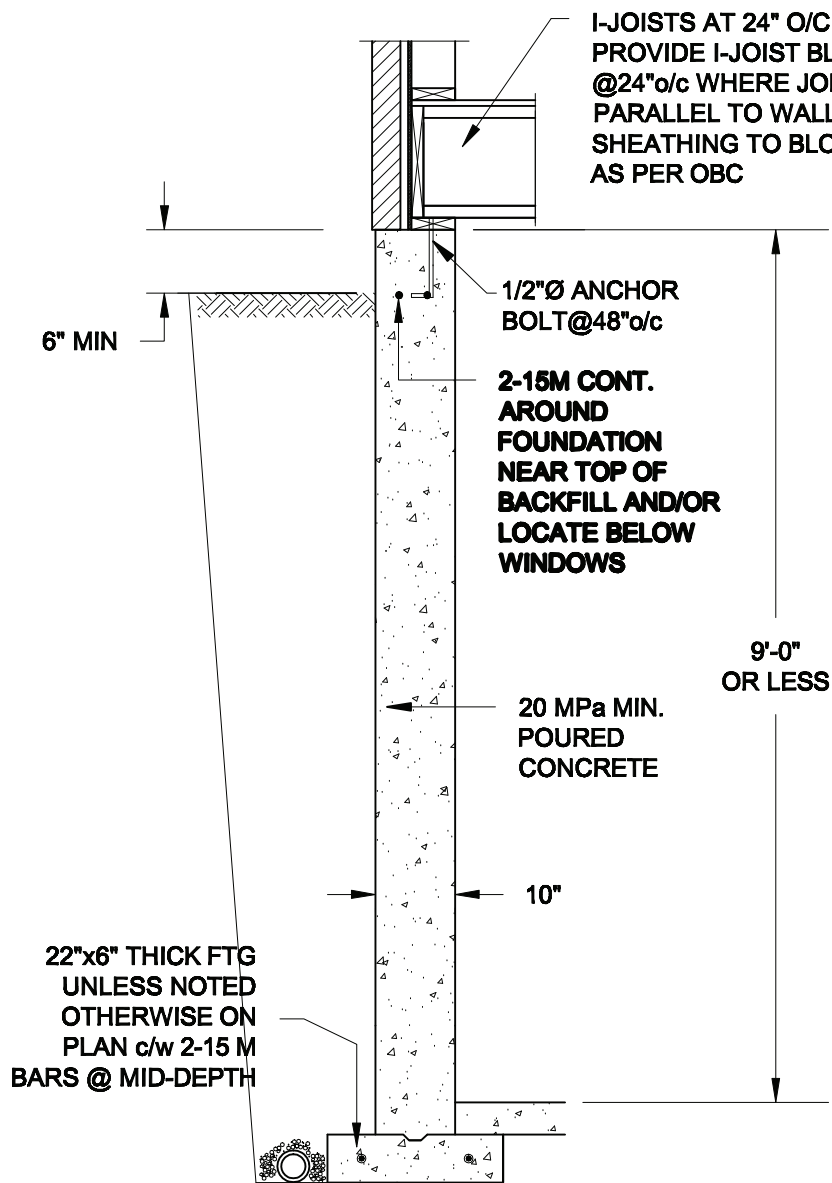

1B
S4 **DROPPED VENEER**
SCALE: 1/2" = 1'-0"

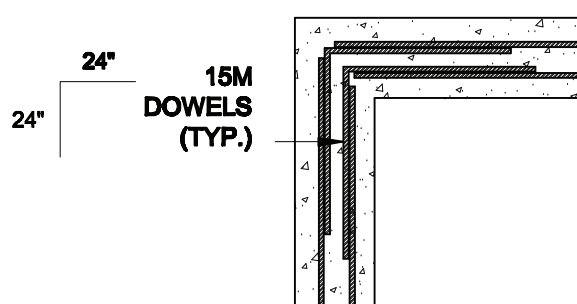

1C
S4 **TYP. PLAN VIEW AT CORNER**
SCALE: 1/2" = 1'-0"

NOTE:
AT ALL WINDOW OPENINGS,
PROVIDE 2-15M VERTICALLY
AT EACH SIDE + 2-15M
HORIZONTALLY 2" BELOW &
EXTEND 24" BEYOND OPENING

NOTES:

1. CONFORM TO THE ONTARIO BUILDING CODE, 2012.
2. CONCRETE TO HAVE A 28 DAY COMPRESSIVE STRENGTH OF 20 MPa.
3. REINFORCING STEEL TO BE GRADE 400.
4. LAP REINFORCING STEEL 24" AT SPLICES. PROVIDE 24"x24" L-SHAPE BARS AT ALL CORNERS - SEE DETAIL 1C/S4.
5. BACKFILL ASSUMED TO BE FREE-DRAINING MATERIAL AS PER PART 9 OF THE OBC.
6. FOUNDATION IS FOR A PART 9 RESIDENTIAL BUILDING.
7. DETAIL IS APPLICABLE TO SITE CLASSES A TO D ONLY AS GIVEN IN TABLE 4.1.8.4.A OF THE OBC (TO BE CONFIRMED BY GEOTECHNICAL ENGINEER).

Scale: AS NOTED	
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Project:

**BAYVIEW WELLINGTON HOMES - GREEN VALLEY ESTATES - SINGLES
BRADFORD, ONTARIO**

TYPICAL STRUCTURAL DETAILS

Project No.:

21-038

Drawing No.:

S4

CONSTRUCTION NOTES (Unless otherwise noted)

ALL CONSTRUCTION TO ADHERE TO THESE PLANS AND SPEC'S AND TO CONFORM TO THE ONTARIO BUILDING CODE AND ALL OTHER APPLICABLE CODES AND AUTHORITIES HAVING JURISDICTION. THESE REQUIREMENTS ARE TO BE TAKEN AS MINIMUM SPECIFICATIONS. ONT. REG. 332/12-2012 OBC

1. ROOF CONSTRUCTION
NO.210 (10.25kg/m2) ASPHALT SHINGLES, 10mm (3/8") PLYWOOD SHEATHING WITH "H" CLIPS. APPROVED WOOD TRUSSES @ 600mm (24") O.C. MAX. APPROVED EAVES PROTECTION TO EXTEND 900mm (3'-0") FROM EDGE OF ROOF AND MIN. 300mm (12") BEYOND INNER FACE OF EXTERIOR WALL. (EAVES PROTECTION NOT REQ'D FOR ROOF SLOPES 8:12 OR GREATER) 38x89 (2"x4") TRUSS BRACING @ 1830mm (6'-0") O.C. AT BOTTOM CHORD. PREFIN. ALUM. EAVESTROUGH, FASCIA, RVL & VENTED SOFFIT. PROVIDE ICE & WATER SHIELD TO ALL ROOF/WALL SURFACES SUSCEPTIBLE TO ICE DAMMING. ROOF SHEATHING TO BE FASTENED 150 (6") c/c ALONG EDGES & INTERMEDIATE SUPPORTS WHEN TRUSSES SPACED GREATER THAN 406 (16"). ATTIC VENTILATION 1:300 OF INSULATED CEILING AREA WITH MIN. 25% AT EAVES & MIN. 25% AT RIDGE (OBC 9.19.1.2.). ENSURE ALL OVERLAPPING ROOF SPACES ARE OPEN TO MAIN ROOF ATTIC SPACE FOR VENTING PURPOSES.

2. FRAME WALL CONSTRUCTION (2"x6") (SB-12-TABLE 3.1.1.2.A) SIDING AS PER ELEV., 19x38 (1"x2") VERTICAL WOOD FURRING, CONTIN. SHEATHING MEMBRANE, 9.5mm (3/8") EXT. TYPE SHEATHING, 38x140 (2"x6") STUDS @ 400mm (16") O.C. (MAX. HEIGHT 3000mm (9'-10")) WITH APPR. DIAGONAL WALL BRACING. SIDING TO BE MIN. 200mm (8") ABOVE FINISH GRADE.

2A. RESERVED

2B. FRAME WALL CONSTRUCTION (2"x4")- GARAGE WALLS SIDING AS PER ELEV., 19x38 (1"x2") VERTICAL WOOD FURRING, CONTIN. SHEATHING MEMBRANE, 9.5mm (3/8") EXT. TYPE SHEATHING, 38x89 (2"x4") STUDS @ 400mm (16") O.C. (MAX. HEIGHT 3000mm (9'-10")) WITH APPR. DIAGONAL WALL BRACING. SIDING TO BE MIN. 200mm (8") ABOVE FINISH GRADE.

2C. RESERVED

2D. STUCCO WALL CONSTRUCTION (2"x4")-GARAGE WALLS STUCCO CLADDING SYSTEM CONFORMING TO O.B.C. 9.27.1.1.(2) & 9.28 THAT EMPLOY A MINIMUM 10mm AIR SPACE BEHIND THE CLADDING WITH POSITIVE DRAINAGE TO THE EXTERIOR AND APPLIED PER MANUFACTURERS SPECIFICATIONS OVER 25mm (1") MIN. EXPANDED OR EXTRUDED RIGID POLYSTYRENE ON APPROVED AIR/MOISTURE BARRIER ON 13mm (1/2") EXT. TYPE SHEATHING ON 38x89 (2"x4") STUDS @ 400 (16") O.C. STUCCO TO BE MIN. 200 (8") ABOVE FINISH GRADE.

2E. WALLS ADJACENT TO ATTIC SPACE - NO CLADDING 9.5mm (3/8") EXT. TYPE SHEATHING, 38x140 (2"x6") STUDS @ 400mm (16") O.C., RSI 3.87 (R22) INSULATION AND APPR. VAPOUR BARRIER AND APPR. CONTIN. AIR BARRIER, 13mm (1/2") INTERIOR DRYWALL FINISH. MID-HEIGHT BLOCKING REQ'D. IF NO SHEATHING APPLIED. REFER TO OBC SB-12, CHAPTER 3 FOR ADDITIONAL THERMAL INSULATION REQUIREMENTS.

3. MASONRY VENEER CONSTRUCTION (2"x6") (SB-12-TABLE 3.1.1.2.A) 90mm (4") MASONRY, 25mm (1") AIR SPACE, 22x180x0.75mm (7/8"x0.03") GALV. METAL TIES @ 400mm (16") O.C. HORIZONTAL 600mm (24") O.C. VERTICAL. APPROVED SHEATHING PAPER, 9.5mm (3/8") EXT. TYPE SHEATHING, 38x140 (2"x6") STUDS @ 400mm (16") O.C., RSI 3.87 (R22) INSULATION & APPR. VAPOUR BARRIER WITH APPR. CONTIN. AIR BARRIER, 13mm (1/2") INTERIOR DRYWALL FINISH. PROVIDE WEEP HOLES @ 800mm (32") O.C. BOTTOM COURSE AND OVER OPENINGS. PROVIDE BASE FLASHING UP MIN. 150mm (6") BEHIND BUILDING PAPER. REFER TO OBC SB-12, CHAPTER 3 FOR ADDITIONAL THERMAL INSULATION REQUIREMENTS.

3A. RESERVED

3B. MASONRY VENEER CONSTRUCTION (2"x4")- GARAGE WALLS 90mm (4") MASONRY, 25mm (1") AIR SPACE, 22x180x0.75mm (7/8"x0.03") GALV. METAL TIES @ 400mm (16") O.C. HORIZONTAL 600mm (24") O.C. VERTICAL. APPR. SHEATHING PAPER, 9.5mm (3/8") EXT. TYPE SHEATHING, 38x89 (2"x4") STUDS @ 400mm (16") O.C. (MAX. HEIGHT 3000mm (9'-10")) WITH APPR. DIAGONAL WALL BRACING. PROVIDE WEEP HOLES @ 800mm (32") O.C. BOTTOM COURSE AND OVER OPENINGS. PROVIDE BASE FLASHING UP MIN. 150mm (6") BEHIND BUILDING PAPER.

3C. STUCCO WALL CONSTRUCTION (2"x6") (SB-12-TABLE 3.1.1.2.A) STUCCO CLADDING SYSTEM CONFORMING TO O.B.C. 9.27.1.1.(2) & 9.28 THAT EMPLOY A MINIMUM 10mm AIR SPACE BEHIND THE CLADDING WITH POSITIVE DRAINAGE TO THE EXTERIOR AND APPLIED PER MANUFACTURERS SPECIFICATIONS OVER 25mm (1") MIN. EXTRUDED OR EXPANDED RIGID POLYSTYRENE ON APPR. CONTIN. AIR/MOISTURE BARRIER ON 13mm (1/2") EXT. TYPE SHEATHING ON 38x140 (2"x6") STUDS @ 400mm (16") O.C., RSI 3.87 (R22) INSULATION, APPROVED VAPOUR BARRIER, 13mm (1/2") GYPSUM WALLBOARD INTERIOR FINISH. REFER TO OBC SB-12, CHAPTER 3 FOR ADDITIONAL THERMAL INSULATION REQUIREMENTS. STUCCO TO BE MIN. 200 (8") ABOVE FINISH GRADE.

4. INTERIOR STUD PARTITIONS FOR BEARING PARTITIONS 38x89 (2"x4") @ 400mm (16") O.C. FOR 2 STOREYS AND 300mm (12") O.C. FOR 3 STOREYS, NON-BEARING PARTITIONS 38x89 (2"x4") @ 600mm (24") O.C. PROVIDE 38x89 (2"x4") BOTTOM PLATE AND 2/38x89 (2/2"x4") TOP PLATE, 13mm (1/2") INT. DRYWALL BOTH SIDES OF STUDS, PROVIDE 38x140 (2"x6") STUDS/PLATES WHERE NOTED.

5. FOUNDATION WALL/FOOTINGS 250mm (10") POURED CONC. FDTN. WALL 20MPa (2900psi) WITH BITUMENOUS DAMPROOFING AND DRAINAGE LAYER. DRAINAGE LAYER REQ'D. WHEN BASEMENT INSUL. EXTENDS 900 (2'-11") BELOW FIN. GRADE. DRAINAGE LAYER IS NOT REQ'D. WHEN FDTN. WALL IS WATERPROOFED. MAXIMUM POUR HEIGHT 2820 (9'-3") ON 560x155 (22"x6") CONTINUOUS KEYS CONC. FTG. BRACE FDTN. WALL PRIOR TO BACKFILLING. ALL FOOTINGS SHALL REST ON NATURAL UNDISTURBED SOIL OR COMPACTED ENGINEERED FILL, WITH MIN. BEARING CAPACITY OF 150kPa OR GREATER. IF SOIL BEARING DOES NOT MEET MINIMUM CAPACITY, ENGINEERED FOOTINGS ARE REQUIRED. STOREYS SUPPORTED | W/ MASONRY VENEER | W/ SIDING ONLY

Table with 3 columns: Storey, Width, Depth. 1: 18" wide x 6" deep, 2: 22" wide x 6" deep, 3: 28" wide x 9" deep.

-SEE OBC 9.15.3. -MAXIMUM FLOOR LIVE LOAD OF 2.4kPa. (50psf.) PER FLOOR, AND MAX. LENGTH OF SUPPORTED FLOOR JOISTS IS 4.9m (16'-1"). -REFER TO SOILS REPORT FOR SOIL CONDITIONS AND BEARING CAPACITY.

STRIP FOOTING SUPPORTING EXTERIOR WALLS (FOR W.O.B.) -ASSUMING MASONRY VENEER CONSTRUCTION, MAX. FLOOR LIVE LOAD OF 2.4kPa. (50psf.) PER FLOOR, AND MAX. LENGTH OF SUPPORTED FLOOR JOISTS IS 4.9m (16'-1"). THE STRIP FOOTING SIZE IS AS FOLLOWS:

Table with 2 columns: Storey, Size. 2 STOREY WITH WALK-OUT BASEMENT: 545x175 (22"x7")

6. FOUNDATION DRAINAGE OBC. 9.14.2. & 9.14.3. 100mm (4") DIA. FOUNDATION DRAINAGE TILE 150mm (6") CRUSHED STONE OVER AND AROUND DRAINAGE TILES.

7. BASEMENT SLAB OBC. 9.3.1.6.(1)(b), 9.16.4.5.(1), 9.25.3.3.(15) 80mm (3") MIN. 25MPa (3600psi) CONC. SLAB ON 100mm (4") COARSE GRANULAR FILL. OR 20MPa. (3000psi) CONC. WITH DAMPROOFING BELOW SLAB. UNDER SLAB INSULATION PER SB-12. ALL SLAB JOINTS & PENETRATIONS TO BE CAULKED.

8. EXPOSED FLOOR TO EXTERIOR (SB-12-TABLE 3.1.1.2.A) PROVIDE RSI 5.46 (R31) INSULATION, APPROVED VAPOUR BARRIER AND CONTINUOUS AIR BARRIER, FINISHED SOFFIT.

9. ATTIC INSULATION (SB-12-TABLE 3.1.1.2.A) (SB-12-3.1.1.8) RSI 10.56 (R60) BLOWN IN ROOF INSULATION AND APPROVED VAPOUR BARRIER, 16mm (5/8") INT. DRYWALL FINISH OR APPROVED EQUAL. RSI 3.52 (R20) MIN. ABOVE INNER SURFACE OF EXTERIOR WALL

10. ALL STAIRS/ EXTERIOR STAIRS -OBC. 9.8.- (PRIVATE STAIRS) 5mm (1/4") MAX BETWEEN ADJACENT TREADS OR LANDINGS -10mm (3/8") MAX BETWEEN TALLEST & SHORTEST RISE IN FLIGHT

Table with 2 columns: Parameter, Value. MAX. RISE = 200 (7-7/8"), MIN. RUN = 255 (10") (NOSING TO NOSING), MAX. TREAD = RUN + 25 (1"), MAX. NOSING = 25 (1"), MIN. HEADROOM = 1950 (6'-5"), RAIL @ LANDING = 900 (2'-11"), RAIL @ STAIR = 865 (2'-10") TO 1070 (3'-6"), MIN. STAIR WIDTH = 860 (2'-10")

FOR CURVED STAIRS (TAPERED TREADS) MIN. RUN AT INNER RADIUS = 150 (6") MIN. RUN AT 300 (12") = 255 (10")

HANDRAILS -OBC. 9.8.7.- FINISHED RAILING ON PICKETS SPACED MAXIMUM 100mm (4") BETWEEN PICKETS. CLEARANCE BETWEEN HANDRAIL AND SURFACE BEHIND IT TO BE 50 (2") MIN. HANDRAILS TO BE CONTINUOUS EXCEPT FOR NEWEL POST AT CHANGES OF DIRECTION.

INTERIOR GUARDS -OBC. 9.8.8.- INTERIOR GUARDS: 900mm (2'-11") MIN. HIGH EXTERIOR GUARDS - OBC. 9.8.8. 900mm (36") HIGH GUARD WHERE DISTANCE FROM PORCH TO FIN. GRADE IS LESS THAN 1800mm (71"). 1070mm (42") HIGH GUARD IS REQUIRED WHERE DISTANCE EXCEEDS 1800mm (71").

SILL PLATE - OBC. 9.23.7. 38x89 (2"x4") SILL PLATE WITH 13mm (1/2") DIA. ANCHOR BOLTS 200mm (8") LONG, EMBEDDED MIN. 100mm (4") INTO CONC. @ 2400mm (7'-10") O.C., CAULKING OR 25 (1") MIN. MINERAL WOOL BETWEEN PLATE AND TOP OF FDTN. WALL. USE NON-SHRINK GROUT TO LEVEL SILL PLATE WHEN REQUIRED.

BASEMENT INSULATION (SB-12-3.1.1.7), 9.25.2.3, 9.13.2.6) FOUNDATION WALLS ENCLOSING HEATED SPACE SHALL BE INSULATED FROM THE UNDERSIDE OF THE SUBFLOOR TO NOT MORE THAN 200mm (8") ABOVE THE FINISHED FLOOR & NO CLOSER THAN 50mm (2") OF THE BASEMENT SLAB. RSI3.52ci (R20ci) BLANKET INSULATION TO HAVE APPROVED VAPOUR BARRIER. RECOMMEND DAMPROOF WITH BUILDING PAPER BETWEEN THE FOUNDATION WALL AND INSULATION UP TO GRADE LEVEL. NOTE: FULL HEIGHT INSULATION AT COLD CELLAR WALLS. AIR BARRIER TO BE SEALED TO FOUNDATION WALL WITH CAULKING. CONTINUOUS INSULATION (ci) IS NOT TO BE INTERRUPTED BY FRAMING.

BEARING STUD PARTITION 38x89 (2"x4") STUDS @ 400mm (16") O.C. 38x89 (2"x4") SILL PLATE ON DAMPROOFING MATERIAL, 13mm (1/2") DIA. ANCHOR BOLTS 200mm (8") LONG, EMBEDDED MIN. 100mm (4") INTO CONC. @ 2400mm (7'-10") O.C. 100mm (4") HIGH CONC. CURB ON 350x155 (14"x6") CONC. FOOTING. ADD HORIZ. BLOCKING AT MID-HEIGHT IF WALL IS UNFINISHED.

STEEL BASEMENT COLUMN (SEE O.B.C. 9.15.3.3) 89mm (3-1/2") DIA x 3.0mm (0.118) SINGLE WALL TUBE TYPE 2 ADJUSTABLE STL. COL. W/ MIN. CAPACITY OF 71.2kN (16,000lbs.) AT A MAX. EXTENSION OF 2318mm (7'-7 1/2") CONFORMING TO CAN/CGSB-7.2.94, AND WITH 150x150x9.5 (6"x6"x3/8") STL. PLATE TOP & BOTTOM. 870x870x410 (34"x34"x16") CONC. FOOTING ON UNDISTURBED SOIL OR ENGINEERED FILL CAPABLE OF SUSTAINING A PRESSURE OF 150 Kpa. MINIMUM AND AS PER SOILS REPORT.

STEEL BASEMENT COLUMN (SEE O.B.C. 9.15.3.3) 89mm (3-1/2") DIA x 4.78mm (1.88) FIXED STL. COL. WITH 150x150x9.5 (6"x6"x3/8") STL. TOP & BOTTOM PLATE ON 1070x1070x460 (42"x42"x18") CONC. FOOTING ON UNDISTURBED SOIL OR ENGINEERED FILL CAPABLE OF SUSTAINING A PRESSURE OF 150 Kpa. MIN. AND AS PER SOILS REPORT.

STEEL COLUMN 90mm (3-1/2") DIA x 4.78mm (1.88) NON-ADJUSTABLE STL. COL. TO BE ON 150x150x9.5 (6"x6"x3/8") STL. TOP & BOTTOM PLATE, & BOTTOM PLATE. BASE PLATE 120x250x12.5 (4 1/2"x210"x1/2") WITH 2-12mm DIA. x 300mm LONG x50mm HOOK ANCHORS (2-1/2"x12"x2") FIELD WELD COL. TO BASE PLATE.

BEAM POCKET OR 300x150 (12"x6") POURED CONC. NIB WALLS. MIN. BEARING 90mm (3-1/2")

19x64 (1"x3") CONTINUOUS WOOD STRAPPING BOTH SIDES OF STEEL BEAM.

GARAGE SLAB 100mm (4") 32MPa (4640psi) CONC. SLAB WITH 5-8% AIR ENTRAINMENT ON OPT. 100 (4") COARSE GRANULAR FILL WITH COMPACTED SUB-BASE OR COMPACTED NATIVE FILL. SLOPE TO FRONT.

GARAGE CEILING/INTERIOR WALLS 13mm (1/2") GYPSUM BOARD ON WALL AND CEILING BETWEEN HOUSE AND GARAGE. TAPE AND SEAL ALL JOINTS AIRTIGHT PER O.B.C. 9.10.9.1.6. WALLS (R22), CEILINGS (R31). REFER TO SB-12, TABLE 3.1.1.2.A. FOR REQUIRED THERMAL INSULATION.

DOOR AND FRAME GASPROOFED. DOOR EQUIPPED WITH SELF CLOSING DEVICE AND WEATHERSTRIPPING PER OBC 9.10.13.15.

EXTERIOR STEP PRECAST CONCRETE STEP OR WOOD STEP WHERE NOT EXPOSED TO WEATHER. MAX. RISE 200mm (7-7/8") MIN. TREAD 250mm (9-1/2"). SEE OBC. 9.8.9.2., 9.8.9.3. & 9.8.10.

DRYER EXHAUST (OBC-6.2.3.8.(7) & 6.2.4.1.1.) CAPPED DRYER EXHAUST VENTED TO EXTERIOR. (USE 100mm (4") DIA. SMOOTH WALL VENT PIPE)

INSULATED ATTIC ACCESS (OBC-9.19.2.1. & SB12-3.1.1.8) ATTIC ACCESS HATCH WITH MIN. DIMENSION OF 545x610mm (21 1/2"x24") & A MIN. AREA OF 0.32 SQ.M. (3.44 SQ.FT.) WITH WEATHERSTRIPPING. RSI 3.52 (R20) RIGID INSUL. BACKING.

FIREPLACE CHIMNEYS OBC. 9.2.1. TOP OF FIREPLACE CHIMNEY SHALL BE 915mm (3'-0") ABOVE THE HIGHEST POINT AT WHICH IT COMES IN CONTACT WITH THE ROOF AND 610mm (2'-0") ABOVE THE ROOF SURFACE WITH A HORIZ. DISTANCE OF 3050mm (10'-0") FROM THE CHIMNEY.

LINEN CLOSET, 4 SHELVES MIN. 350mm (14") DEEP.

MECHANICAL EXHAUST FAN, VENTED TO EXTERIOR AS REQUIRED BY OBC. 9.32.3.5. & 9.32.3.10.

STEEL BEARING PLATE FOR MASONRY WALLS 280x280x16 (11"x11"x5/8") STL. PLATE FOR STL BEAMS AND 280x280x12 (11"x11"x1/2") STL. PLATE FOR WOOD BEAMS BEARING ON CONC. BLOCK PARTYWALL, ANCHORED WITH 2-19mm (3/4") x 200mm (8") LONG GALV. ANCHORS WITHIN SOLID BLOCK COURSE. LEVEL WITH NON-SHRINK GROUT.

SOLID WOOD BEARING FOR WOOD STUD WALLS SOLID BEARING TO BE AT LEAST AS WIDE AS THE SUPPORTED MEMBER. SOLID WOOD BEARING COMPRISED OF BUILT-UP WOOD STUDS TO BE CONSTRUCTED IN ACCORDANCE WITH OBC 9.17.4.2(2).

RESERVED

BEARING WOOD POST (BASEMENT) (OBC 9.17.4.) 3-38x140 (3-2"x6") BUILT-UP-POST ON METAL BASE SHOE ANCHORED TO CONC. WITH 12.7 DIA. BOLT, 610x610x300 (24"x24"x12") CONC. FOOTING.

STEPPED FOOTINGS OBC 9.15.3.9. MIN. HORIZ. STEP = 600mm (24"). MAX. VERT. STEP = 600mm (24").

SLAB ON GRADE MIN. 100mm (4") CONCRETE SLAB ON GRADE ON 100mm (4") COARSE GRANULAR FILL. REINFORCED WITH 4x6-W2x9x2 MESH PLACED NEAR MID-DEPTH OF SLAB. CONC. STRENGTH 32 MPa (4640 psi) WITH 5-8% AIR ENTRAINMENT ON COMPACTED SUB-GRADE. WHERE REQUIRED, REFER TO OBC SB-12, TABLE 3.1.1.2.A. FOR REQUIRED MINIMUM INSULATION UNDER SLAB.

DIRECT VENTING GAS FURNACE/ H.W.T VENT DIRECT VENT FURNACE TERMINAL MIN. 900mm (36") FROM A NATURAL GAS REGULATOR, MIN. 300mm (12") ABOVE FIN. GRADE. FROM ALL OPENINGS, EXHAUST AND INTAKE VENTS, HRV INTAKE TO BE A MIN. OF 1830mm (6'-0") FROM ALL EXHAUST TERMINALS. REFER TO GAS UTILIZATION CODE. ALL AIR INTAKES SHALL BE LOCATED SO THAT THEY ARE SEPARATED FROM KITCHEN EXHAUST BY 3.0M IN COMPLIANCE WITH O.B.C. DIV.-B TABLE 6.2.3.12..

DIRECT VENTING GAS FIREPLACE DIRECT VENT GAS FIREPLACE. VENT TO BE A MINIMUM 300mm (12") FROM ANY OPENING AND ABOVE FIN. GRADE. REFER TO GAS UTILIZATION CODE.

SUBFLOOR, JOIST STRAPPING AND BRIDGING 16mm (5/8") T & G SUBFLOOR ON WOOD FLOOR JOISTS. FOR CERAMIC TILE APPLICATION (* SEE OBC 9.30.6. *) 6mm (1/4") PANEL TYPE UNDERLAY UNDER RESILIENT & PARQUET FLOORING. (* SEE OBC 9.30.2. *) FLOOR JOISTS WITH SPANS OVER 2100mm (6'-11") TO BE BRIDGED WITH 38x38 (2"x2") CROSS BRACING OR SOLID BLOCKING @ 2100mm (6'-11") O.C. MAX. AND WHERE SPECIFIED BY JOIST TABLES A-1 OR A-2 STRAPPING SHALL BE 19x64 (1"x3") @ 2100mm (6'-11") O.C. UNLESS A PANEL TYPE CEILING FINISH IS APPLIED. (* SEE OBC 9.23.9.4. *)

EXPOSED BUILDING FACE OBC. 9.10.15. & SB-2-2.3.5.(2) EXTERIOR WALLS TO HAVE A FIRE RESISTANCE RATING OF NOT LESS THAN 45 min. WHERE LIMITING DISTANCE (LD) IS LESS THAN 1.2M (3'-11"). WHERE THE LD IS LESS THAN 600mm (1'-11") THE EXPOSING FACE SHALL BE CLAD IN NON-COMBUSTIBLE MATERIAL. SEE ELEVATIONS FOR ADDITIONAL NOTES. OFFENDING GARAGE WALLS INCLUDED.

COLD CELLAR PORCH SLAB (OBC. 9.3.9.) FOR MAX. 2500mm (8'-2") PORCH DEPTH (SHORTEST DIM.), 125mm (5") 32MPa (4640psi) CONC. SLAB WITH 5-8% AIR ENTRAINMENT. REINF. WITH 10M BARS @ 200mm (7/8") O.C. EACH WAY IN BOTTOM THIRD OF SLAB. MIN. 30mm (1 1/4") COVER. 600x600 (23 5/8"x23 5/8") 10M DOWELS @ 600mm (23 5/8") O.C., ANCHORED IN PERIMETER FDTN. WALLS. SLOPE SLAB MIN. 1.0% FROM HOUSE WALL. SLAB TO HAVE MIN. 75mm (3") BEARING ON FDTN. WALLS. PROVIDE (L7) LINTEL OVER CELLAR DOOR WITH 100mm (4") END BEARING.

THE FDTN. WALL SHALL NOT BE REDUCED TO LESS THAN 90mm (3-1/2") THICK TO A MAX. DEPTH OF 600mm (24") AND SHALL BE TIED TO THE FACING MATERIAL WITH METAL TIES SPACED 200mm (8") O.C. VERTICALLY AND 900mm (36") O.C. HORIZONTALLY. FILL SPACE BETWEEN WALL AND FACING SILL WITH MORTAR.

CONVENTIONAL ROOF FRAMING (2.0Kpp. SNOW LOAD) 38x140 (2"x6") RAFTERS @ 400mm (16") O.C. FOR MAX 11-7" SPAN, 38x184 (2"x8") RIDGE BOARD, 38x89 (2"x4") COLLAR TIES AT MIDSPANS. CEILING JOISTS TO BE 38x89 (2"x4") @ 400mm (16") O.C. FOR MAX. 2830mm (9'-3") SPAN & 38x140 (2"x6") @ 400 (16") O.C. FOR MAX. 4450mm (14'-7") SPAN. RAFTERS FOR BUILT-UP ROOF TO BE 38x89 (2"x4") @ 600mm (24") O.C. WITH A 38x89 (2"x4") CENTRE POST TO THE TRUSS BELOW, LATERALLY BRACED @ 1800mm (6'-0") O.C. VERTICALLY.

GENERAL NOTES 1) MECHANICAL VENTILATION IS REQUIRED TO COMPLY WITH OBC-DIV. B. 6.2.2. SEE MECHANICAL DRAWINGS. 2) ALL DOWNSPOUTS TO DRAIN AWAY FROM THE BUILDING AS PER OBC 9.26.18.2. & 5.6.2.2.(3) AND MUNICIPAL STANDARDS. 3) ALL WINDOW WELLS TO DRAIN TO FOOTING LEVEL PER OBC 9.14.6.3. CHECK WITH THE LOCAL AUTHORITY. 4) STUD WALL REINFORCEMENT FOR FUTURE GRAB BARS IN MAIN BATHROOM REINFORCEMENT OF STUD WALLS SHALL BE INSTALLED ADJACENT TO WATER CLOSETS AND SHOWER OR BATHTUB IN MAIN BATHROOM. REFER TO OBC. DIV.-B. 9.5.2.3 & DETAIL PROVIDED.

5) ALL EXTERIOR DOORS TO COMPLY WITH THERMAL RESISTANCE AS STATED IN O.B.C. SB-12-3.1.1.9. 6) ALL AIR BARRIER SYSTEMS ARE REQUIRED TO COMPLY WITH O.B.C. DIV.-B 9.25.3. 7) ALL OUTDOOR AIR INTAKES SHALL BE LOCATED SO THAT THEY ARE SEPARATED FROM SOURCES OF CONTAMINATION (EXHAUST VENTS) IN COMPLIANCE WITH O.B.C. DIV.-B 6.2.3.12. AND TABLE 6.2.3.12.


LUMBER: 1) ALL LUMBER SHALL BE SPRUCE NO.2 GRADE, UNLESS NOTED OTHERWISE. 2) STUDS SHALL BE STUD GRADE SPRUCE, UNLESS NOTED OTHERWISE. 3) LUMBER EXPOSED TO THE EXTERIOR TO BE SPRUCE NO.2 GRADE PRESSURE TREATED OR CEDAR, UNLESS NOTED OTHERWISE. 4) ALL LAMINATED VENEER LUMBER (L.V.L.) BEAMS, GIRDER TRUSSES, AND METAL HANGER CONNECTIONS SUPPORTING ROOF FRAMING TO BE DESIGNED & CERTIFIED BY TRUSS MANUFACTURER.

5) LVL BEAMS SHALL BE 2.0E -2950Fb MIN., NAIL EACH PLY OF LVL WITH 89mm (3 1/2") LONG COMMON WIRE NAILS @ 300mm (12") O.C. STAGGERED IN 2 ROWS FOR 184, 240 & 300mm (7 1/4" 9 1/2" 11 7/8") DEPTHS AND STAGGERED IN 3 ROWS FOR GREATER DEPTHS AND FOR 4 PLY MEMBERS ADD 13mm (1/2") DIA. GALVANIZED BOLTS BOLTED AT MID-DEPTH OF BEAM @ 915mm (3'-0") O.C. 6) PROVIDE FACE MOUNT BEAM HANGERS TYPE "SCL" MANUFACTURED BY SIMPSON STRONG-TIE OR EQUAL FOR ALL LVL BEAM TO BEAM CONNECTIONS UNLESS OTHERWISE NOTED. REFER TO ENG. FLOOR LAYOUTS. 7) JOIST HANGERS: PROVIDE METAL HANGERS FOR ALL JOISTS AND BUILT-UP WOOD MEMBERS INTERSECTING FLUSH BUILT-UP WOOD MEMBERS. 8) WOOD FRAMING NOT TREATED WITH A WOOD PRESERVATIVE, IN CONTACT WITH CONCRETE, SHALL BE SEPARATED FROM THE CONCRETE BY AT LEAST 2mm. POLYETHYLENE FILM, No. 50 (45lbs.) ROLL ROOFING OR OTHER DAMPROOFING MATERIAL, EXCEPT WHERE THE WOOD MEMBER IS AT LEAST 150mm (6") ABOVE THE GROUND.

STEEL: 1) STRUCTURAL STEEL SHALL CONFORM TO CAN/CSA-G40-21 GRADE 350W, HOLLOW STRUCTURAL SECTIONS SHALL CONFORM TO CSA-G40-21 GRADE 350W CLASS "H" "STRUCTURAL QUALITY STEEL". OBC. B-9.23.4.3. 2) REINFORCING STEEL SHALL CONFORM TO CSA-G30-18M GRADE 400R.

STUCCO: 1) ALL STUCCO WALLS TO HAVE A MINIMUM 10mm AIR SPACE BEHIND THE CLADDING WITH POSITIVE DRAINAGE TO THE EXTERIOR. THE EXTERIOR SHEATHING MUST NOT BE GYPSUM BASED. ALL STUCCO TO BE INSTALLED AS PER MANUFACTURERS SPECIFICATIONS.

LEGEND

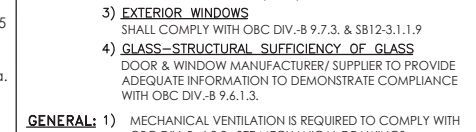

SMOKE ALARM (REFER TO OBC 9.10.19)

PROVIDE 1 PER FLOOR, IN EACH THE STAIRS CONNECTING THE FLOOR LEVEL AND ALSO 1 IN NEAR EACH BEDROOM NEAR HALL DOOR. ALARMS TO BE CONNECTED TO AN ELECTRICAL CIRCUIT AND INTERCONNECTED TO ACTIVATE ALL ALARMS IF 1 SOUNDS. BATTERY BACK-UP REQUIRED. SMOKE ALARMS TO INCORPORATE VISUAL SIGNALLING COMPONENT (9.10.19.3.(3)).

CARBON MONOXIDE ALARMS (OBC 9.33.4.)

WHERE A FUEL-BURNING APPLIANCE IS INSTALLED IN A DWELLING UNIT, A CARBON MONOXIDE ALARM CONFORMING TO CAN/CSA-6.19 OR UL2034 SHALL BE INSTALLED ADJACENT TO EACH SLEEPING AREA. CARBON MONOXIDE DETECTOR(S) SHALL BE PERMANENTLY WIRED SO THAT ITS ACTIVATION WILL ACTIVATE ALL CARBON MONOXIDE DETECTORS AND BE EQUIPPED WITH AN ALARM THAT IS AUDIBLE WITHIN BEDROOMS WHEN THE INTERVENING DOORS ARE CLOSED. REFER TO MANUFACTURER FOR ADDITIONAL REQUIREMENTS.

SOIL GAS/ RADON CONTROL (OBC 9.1.1.7. & 9.13.4.)

PROVIDE CONSTRUCTION TO PREVENT LEAKAGE OF SOIL GAS INTO THE BUILDING IF REQUIRED.

CONTRACTOR MUST VERIFY ALL DIMENSIONS ON THE JOB AND REPORT ANY DISCREPANCY TO VA3 DESIGN BEFORE PROCEEDING WITH THE WORK. ALL DRAWINGS AND SPECIFICATIONS ARE INSTRUMENTS OF SERVICE AND THE PROPERTY OF VA3 DESIGN WHICH IF REQUESTED, MUST BE RETURNED AT THE COMPLETION OF THE WORK. ALL DRAWINGS TO BE USED FOR CONSTRUCTION ONLY AFTER BUILDING PERMIT HAS BEEN ISSUED.

TWO STOREY VOLUME SPACES -FOR A MAXIMUM 5490 mm (18'-0") HEIGHT AND MAXIMUM SUPPORTED ROOF TRUSS LENGTH OF 6.0m, PROVIDE 2-38x140 (2-2"x6") SPR.#2 CONTIN. STUDS @ 300mm (12") O.C. (TRIPLE UP AT EVERY THIRD DOUBLE STUD FOR BRICK WALLS) C/W 9.6 (3/8") THICK EXT. POLYWOOD SHEATHING. PROVIDE SOLID WOOD BLOCKING BETWEEN WOOD STUDS @ 1220 mm (4'-0") O.C. VERTICALLY. -FOR WALLS WITH HORIZ. DISTANCES NOT EXCEEDING 2900 mm (9'-6"). PROVIDE 38x140 (2"x6") STUDS @ 400 (16") O.C. WITH CONTINUOUS 2-38x140 (2-2"x6") TOP PLATES + 1-38x140 (1-2"x6") BOTTOM PLATE & MINIMUM OF 3-38x184 (3-2"x8") CONT. HEADER AT GRND. CEILING LEVEL TOE-NAILED & GLUED AT TOP, BOTTOM PLATES AND HEADERS.

TYPICAL 1 HOUR RATED PARTY WALL. REFER TO DETAILS FOR TYPE AND SPECIFICATIONS.

FOUNDATION WALL (W.O.D./W.O.B.) - WHERE GRADE TO T/O BASEMENT SLAB EXCEEDS 1200mm (3'-11") A 250mm (10") WIDE FOUNDATION WALL IS REQUIRED.

EXTERIOR WALLS FOR WALK-OUT CONDITIONS THE EXTERIOR BASEMENT STUD WALL TO BE 38x140 (2"x6") STUDS @ 400mm (16") o.c. OR 38x89 (2"x4") STUDS @ 300mm (12") o.c.

DRAIN WATER HEAT RECOVERY UNIT (DWHR)

PER SB12-3.1.1.12., A DRAIN WATER HEAT RECOVERY (DWHR) UNIT SHALL BE INSTALLED IN EACH DWELLING UNIT TO RECEIVE DRAIN WATER FROM ALL SHOWERS OR FROM AT LEAST TWO SHOWERS WHERE THERE ARE TWO OR MORE SHOWERS IN THE DWELLING UNIT. DOES NOT APPLY IF THERE ARE NO SHOWERS OR NO STOREY BENEATH ANY OF THE SHOWERS.


UPDATED ONT. REG. 332/12-2012 OBC Amendment O. Reg. 88/19 Includes amendments effective Jan. 1, 2022

WOOD LINTELS AND BUILT-UP WOOD BEAMS

Table with 2 columns: Label, Dimensions. L1: 2/38 x 184 (2/2" x 8") SPR.#2, B1: 3/38 x 184 (3/2" x 8") SPR.#2, B2: 4/38 x 184 (4/2" x 8") SPR.#2, B7: 5/38 x 184 (5/2" x 8") SPR.#2, L3: 2/38 x 235 (2/2" x 10") SPR.#2, B3: 3/38 x 235 (3/2" x 10") SPR.#2, B4: 4/38 x 235 (4/2" x 10") SPR.#2, L5: 2/38 x 286 (2/2" x 12") SPR.#2, B5: 3/38 x 286 (3/2" x 12") SPR.#2, B6: 4/38 x 286 (4/2" x 12") SPR.#2

LOOSE STEEL LINTELS

Table with 2 columns: Label, Dimensions. L7: 89 x 89 x 6.4L (3-1/2" x 3-1/2" x 1/4"L), L8: 89 x 89 x 7.9L (3-1/2" x 3-1/2" x 5/16"L), L9: 102 x 89 x 7.9L (4" x 3-1/2" x 5/16"L), L10: 127 x 89 x 7.9L (5" x 3-1/2" x 5/16"L), L11: 152 x 89 x 10.0L (6" x 3-1/2" x 3/8"L), L12: 152 x 102 x 1

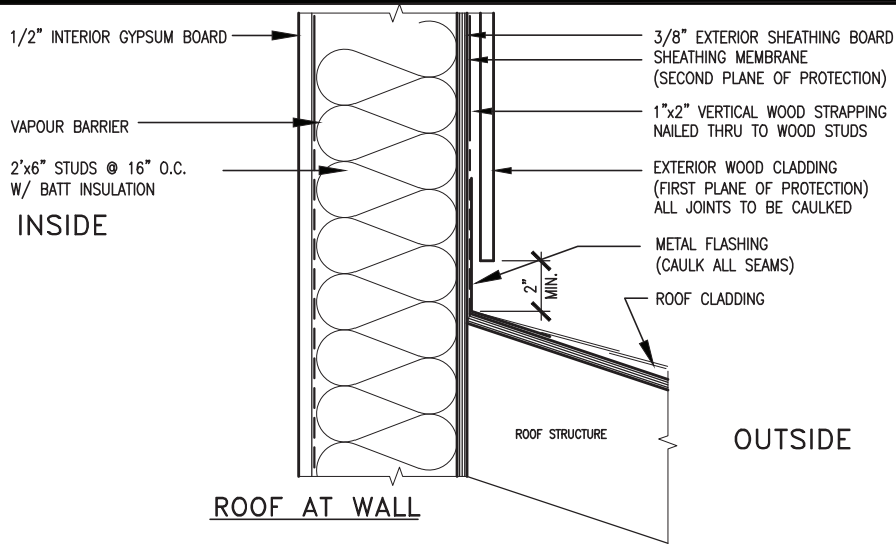

MAX. HEIGHT FOR 2"x4" GARAGE WALL IS AS FOLLOW:

- 2"x4" @ 16" O.C. - 9'-10"
- 2"x4" @ 12" O.C. - 10'-9"
- 3"x4" @ 16" O.C. - 11'-2"
- 3"x4" @ 12" O.C. - 12'-4"

NOTES:

- FOR ROOF DESIGN SNOW LOAD OF UP TO 2.5 KPa. SUPPORTED ROOF TRUSS LENGTH OF 6.0m AND FLOOR JOIST LENGTH OF 2.5m OF ONE FLOOR.
- PROVIDE HORIZONTAL SOLID BLOCKING @ 1200 O.C. (4'-0")
- PROVIDE A MINIMUM OF 9.5mm (3/8") PLYWOOD OR OSB EXTERIOR SHEATHING ON THE EXTERIOR FACE.
- FOR A 1/50 YEAR REFERENCE WIND PRESSURE OF 0.6 KPa.
- STUDS GREATER THAN 9'-10" HIGH TO BE No. 2 SPF.
- STUD SPECIFICATION IS SUITABLE FOR BRICK VENEER OR SIDING.


** MAX. HEIGHT FOR 2"x6" EXTERIOR WALL IS AS FOLLOW:

- 2"x6" @ 16" O.C. - 12'-6"
- 2"x6" @ 12" O.C. - 13'-10"
- 2"x6" @ 16" O.C. - 15'-0"
- 2"x6" @ 12" O.C. - 17'-4"

NOTES:

- FOR ROOF DESIGN SNOW LOAD OF UP TO 2.5 KPa SUPPORTED ROOF TRUSS LENGTH OF 6.0m ONLY.
- PROVIDE HORIZONTAL SOLID BLOCKING @ 1200 O.C. (4'-0")
- PROVIDE A MINIMUM OF 9.5mm (3/8") PLYWOOD OR OSB EXTERIOR SHEATHING ON THE EXTERIOR FACE AND 12.5mm (1/2") GYPSUM BOARD ON THE INTERIOR FACE.
- WALL FRAMING SHALL CONFORM TO OBC 9.23.10.1.(2)
- FOR A 1/50 YEAR REFERENCE WIND PRESSURE OF 0.6 KPa
- STUDS GREATER THAN 9'-10" HIGH TO BE No. 2 SPF.
- STUD SPECIFICATION IS SUITABLE FOR BRICK VENEER OR SIDING.



** STUD INFORMATION TAKEN FROM OBC TABLE A-30

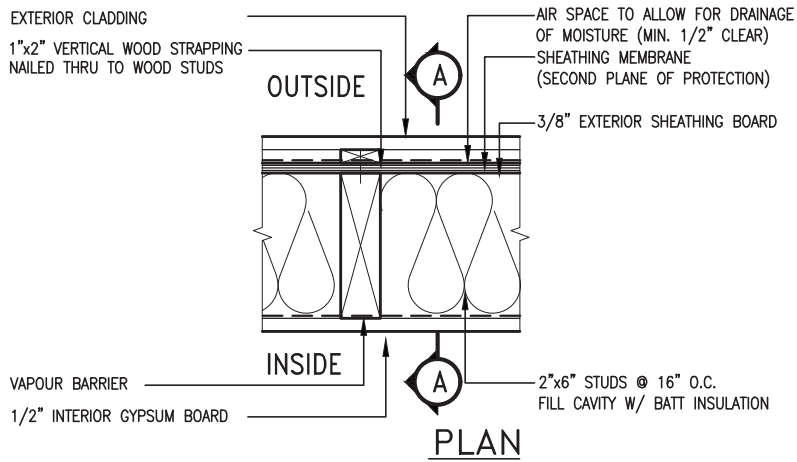

EXTERIOR WOOD CLADDING WALL ASSEMBLY

STUD WALL REINFORCEMENT FOR FUTURE GRAB BARS IN MAIN BATHROOM

REINFORCEMENT OF WOOD STUD WALLS SHALL BE INSTALLED ADJACENT TO WATER CLOSETS AND SHOWER OR BATHTUB IN MAIN BATHROOM PER OBC. DIV. B-9.5.2.3. FUTURE GRAB BARS TO BE MOUNTED TO RESIST HORIZ. AND VERT. LOADS OF 1.3 KN (300 lb) REFER TO OBC. DIV. B- WATER CLOSET 3.8.3.8.(3)(a) & 3.8.3.8.(3)(c). SHOWER 3.8.3.13.(2)(g). & BATHTUB 3.8.3.13.(4)(e). AND DETAILS PROVIDED BELOW.

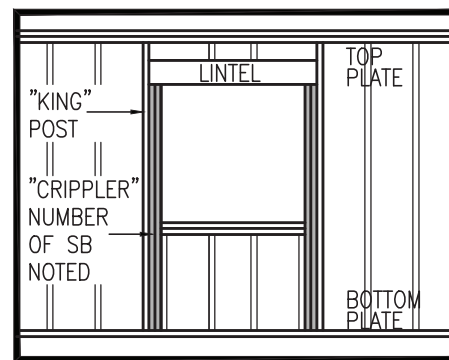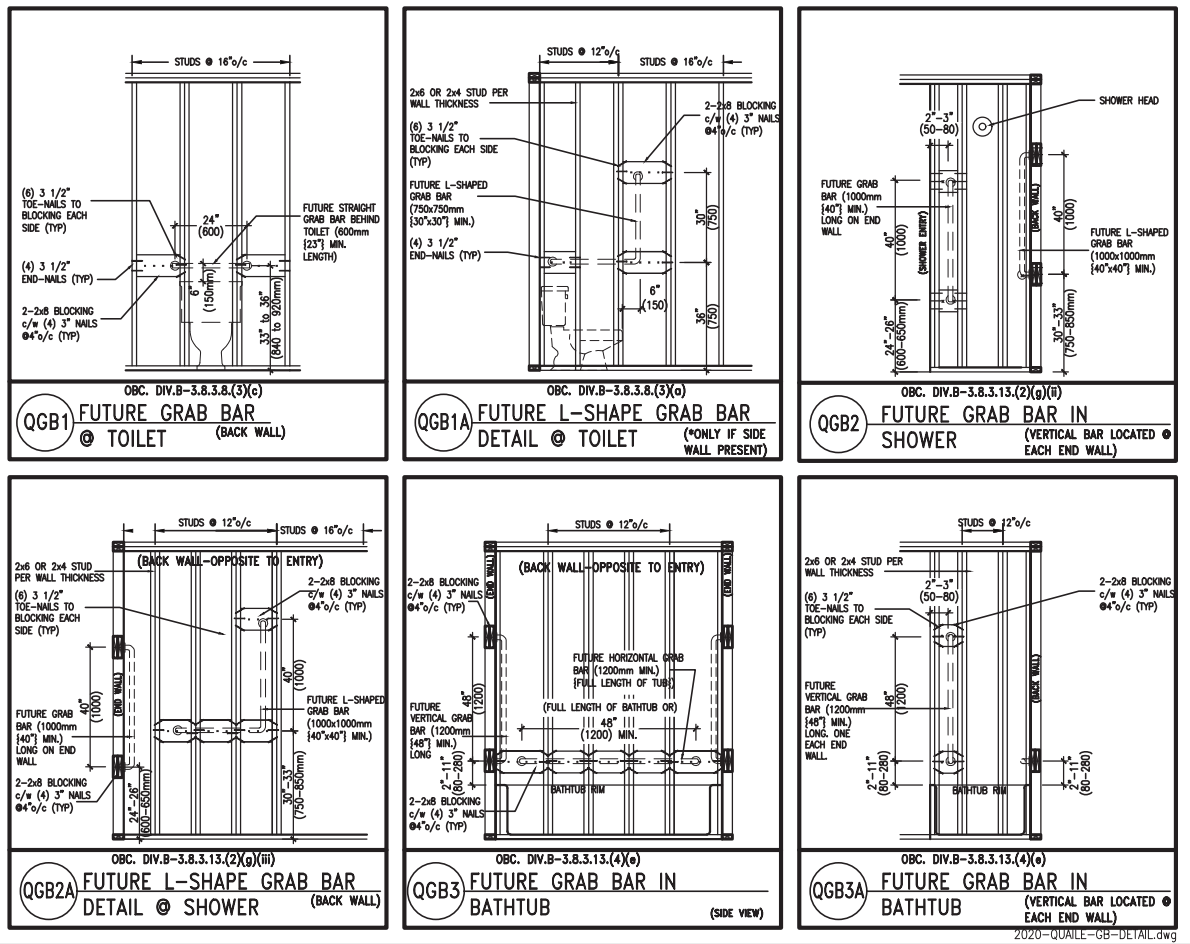

"CRIPPLE" DETAIL



9			
8			
7			
6			
5			
4	UPDATE TO 2022	JAN 11-22	RC
3	UPDATE TO 2020	FEB 24-20	RC
2	UPDATE TO 2018	JAN 11-18	RC
1	ISSUE FOR CLIENT REVIEW	AUG 04-17	RC
no.	description	date	by

The undersigned has reviewed and takes responsibility for this design and has the qualifications and meets the requirements set out in the Ontario Building Code to be a Designer.

Wellington Jno-Baptiste 25591
name BCIN
VA3 Design Inc. 42658
registration information

Contractor must verify all dimensions on the job and report any discrepancy to the Designer before proceeding with the work. All drawings and specifications are instruments of service and the property of the Designer which must be returned at the completion of the work. Drawings are not to be scaled.

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va3design.com

BAYVIEW WELLINGTON

project name: GREEN VALLEY EAST
municipality: BRADFORD

date: MAY 2016
drawn by: RC
checked by: scale: 3/16" = 1'-0"


CONSTRUCTION NOTES
16023-CN-2022-A1

CONST NOTE

project no. 16023


drawing no. CN2

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1 WINDOW HEADER
 CN3 SCALE: 3"=1'-0"

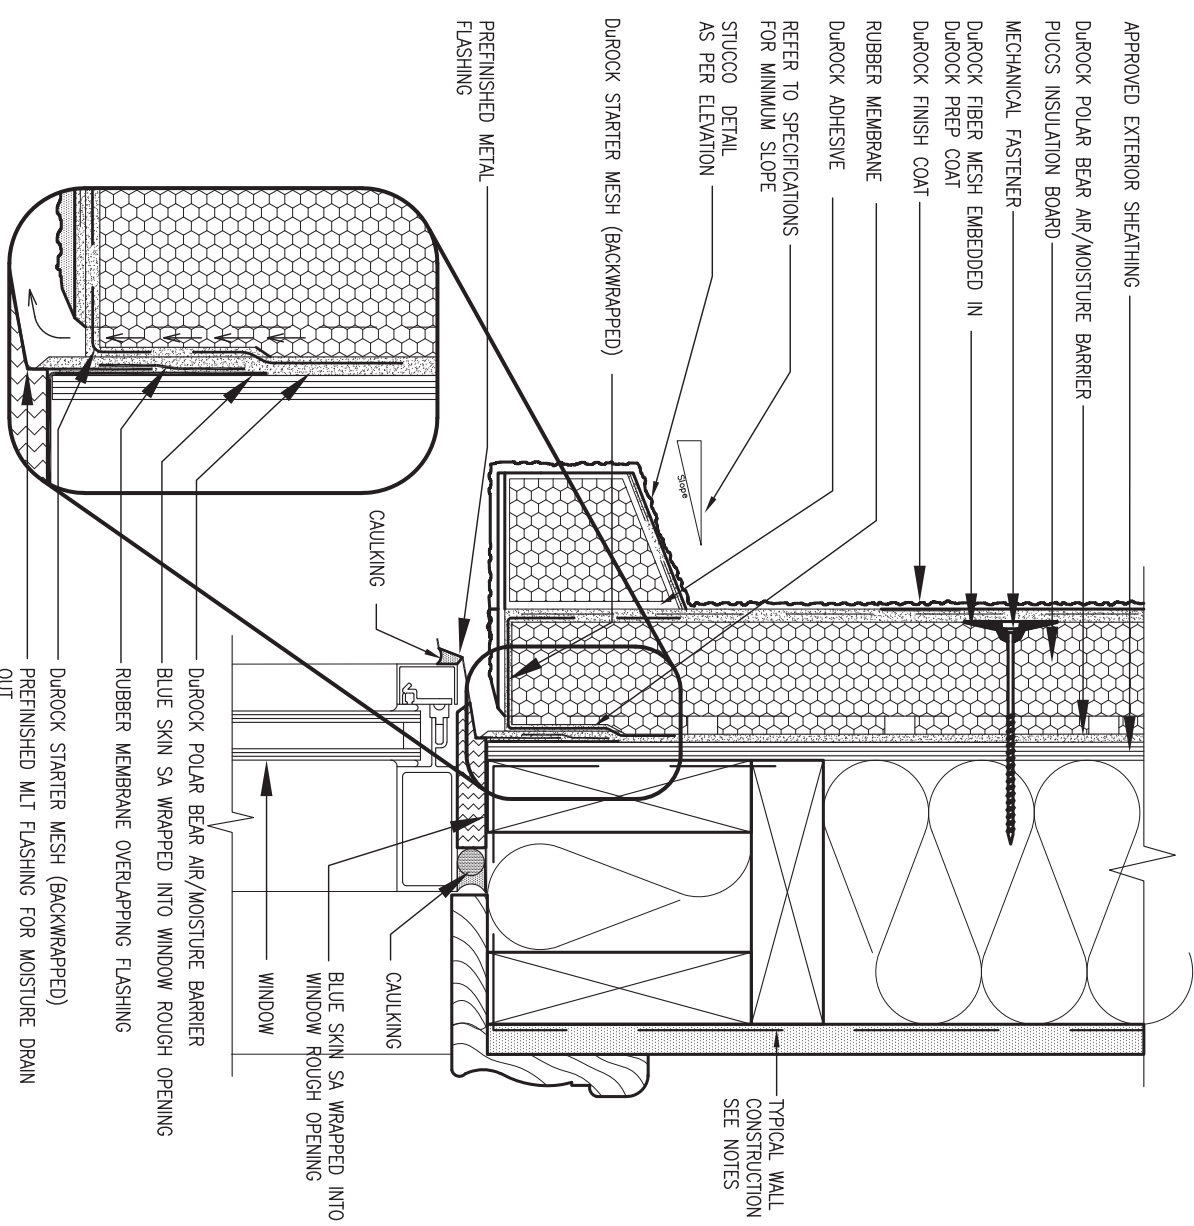ALL STUCCO WALLS TO HAVE A MINIMUM 10mm AIR SPACE BEHIND THE CLADDING WITH POSITIVE DRAINAGE TO THE EXTERIOR. THE EXTERIOR SHEATHING MUST NOT BE GYPSUM BASED. ALL STUCCO TO BE INSTALLED AS PER MANUFACTURERS SPECIFICATIONS. DETAILS ARE BASED ON DUROCK PUCCS SYSTEM



2 WINDOW SILL
 CN3 SCALE: 3"=1'-0"

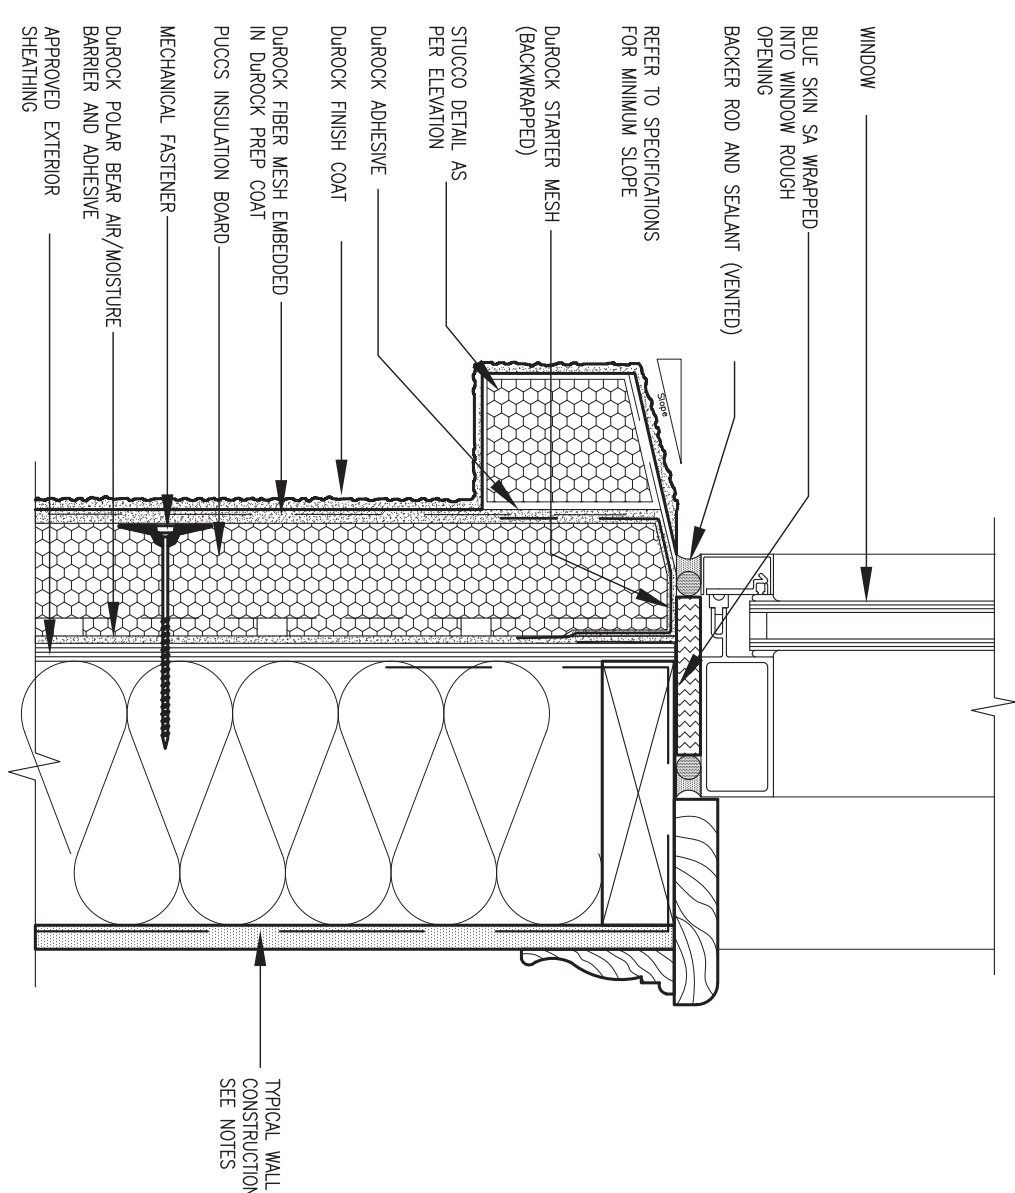9	.	.	.	The undersigned has reviewed and takes responsibility for this design and has the qualifications and meets the requirements set out in the Ontario Building Code to be a Designer.
8	.	.	.	qualification information
7	.	.	.	Wellington Jno-Baptiste 25591
6	.	.	.	signature BCIN
5	.	.	.	42658
4	UPDATE TO 2022	JAN 11-22	RC	name registration information
3	UPDATE TO 2020	FEB 24-20	RC	VA3 Design Inc.
2	UPDATE TO 2018	JAN 11-18	RC	Contractor must verify all dimensions on the job and report any discrepancy to the Designer before proceeding with the work. All drawings and specifications are instruments of service and the property of the Designer which must be returned at the completion of the work. Drawings are not to be scaled.
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no.	description	date	by	



BAYVIEW WELLINGTON

project name: GREEN VALLEY EAST
 date: MAY 2016
 drawn by: RC
 checked by: -
 scale: 3/16" = 1'-0"


municipality: BRADFORD
 project no.: 16023

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CONSTRUCTION NOTES
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 drawing no.: CN3


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5 CORNER DETAIL
CNS SCALE: 3"=1'-0"

ALL STUCCO WALLS TO HAVE A MINIMUM 10mm AIR SPACE BEHIND THE CLADDING WITH POSITIVE DRAINAGE TO THE EXTERIOR. THE EXTERIOR SHEATHING MUST NOT BE GYPSUM BASED. ALL STUCCO TO BE INSTALLED AS PER MANUFACTURERS SPECIFICATIONS. DETAILS ARE BASED ON DUROCK PUCCS SYSTEM

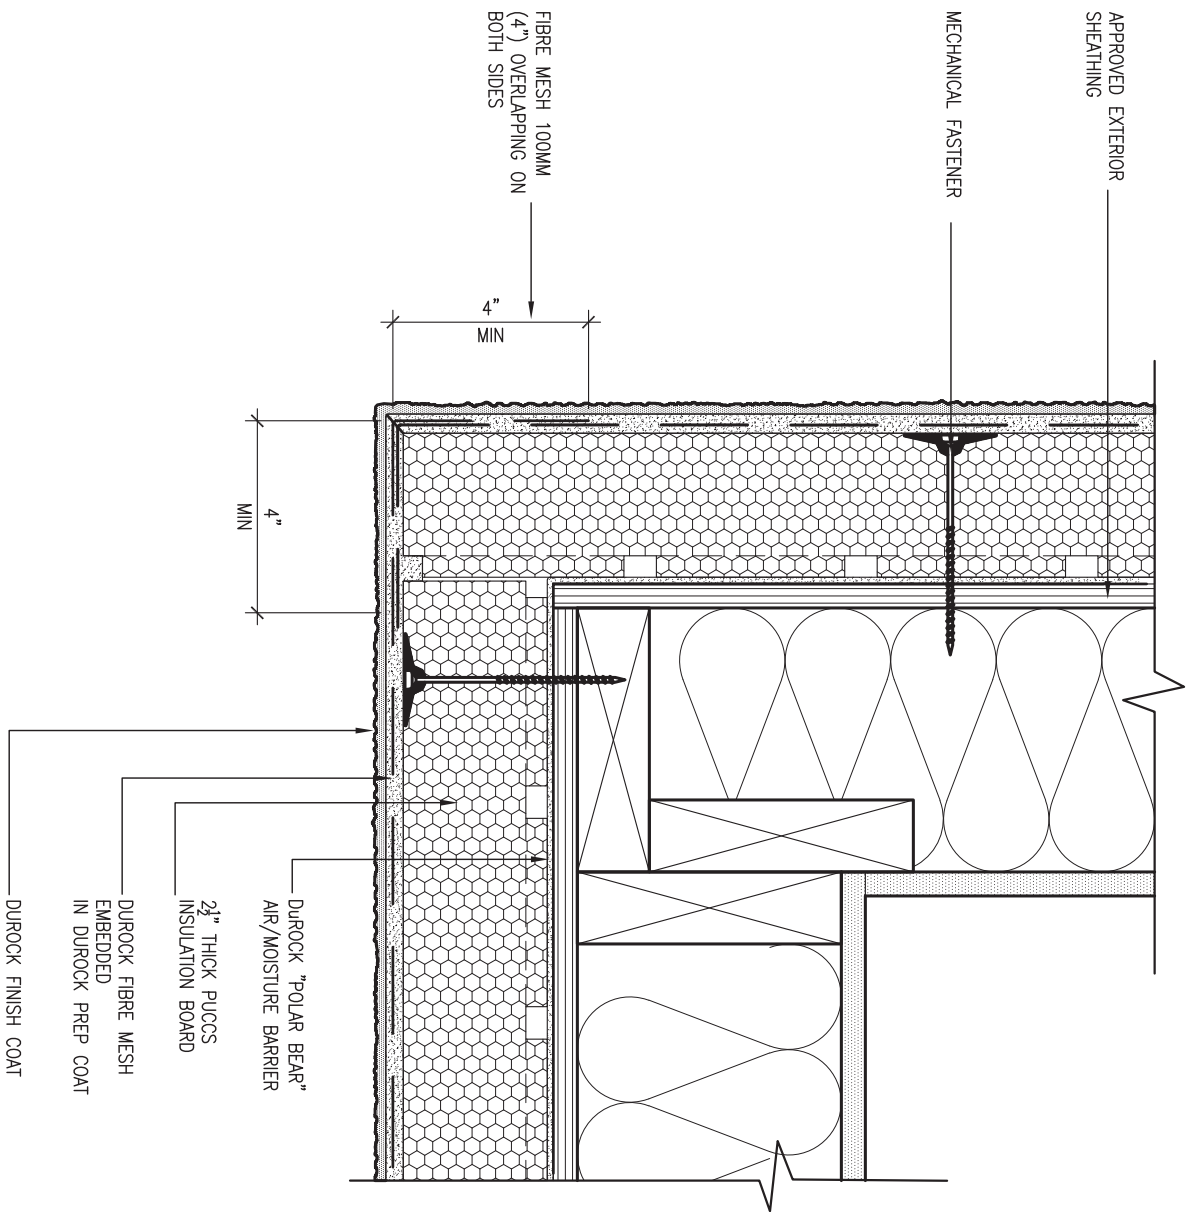

6 STUCCO / MASONRY PLINTH CONNECTION
CNS SCALE: 3"=1'-0"

9	.	.	.
8	.	.	.
7	.	.	.
6	.	.	.
5	.	.	.
4	UPDATE TO 2022	JAN 11-22	RC
3	UPDATE TO 2020	FEB 24-20	RC
2	UPDATE TO 2018	JAN 11-18	RC
1	ISSUE FOR CLIENT REVIEW	AUG 04-17	RC
no.	description	date	by

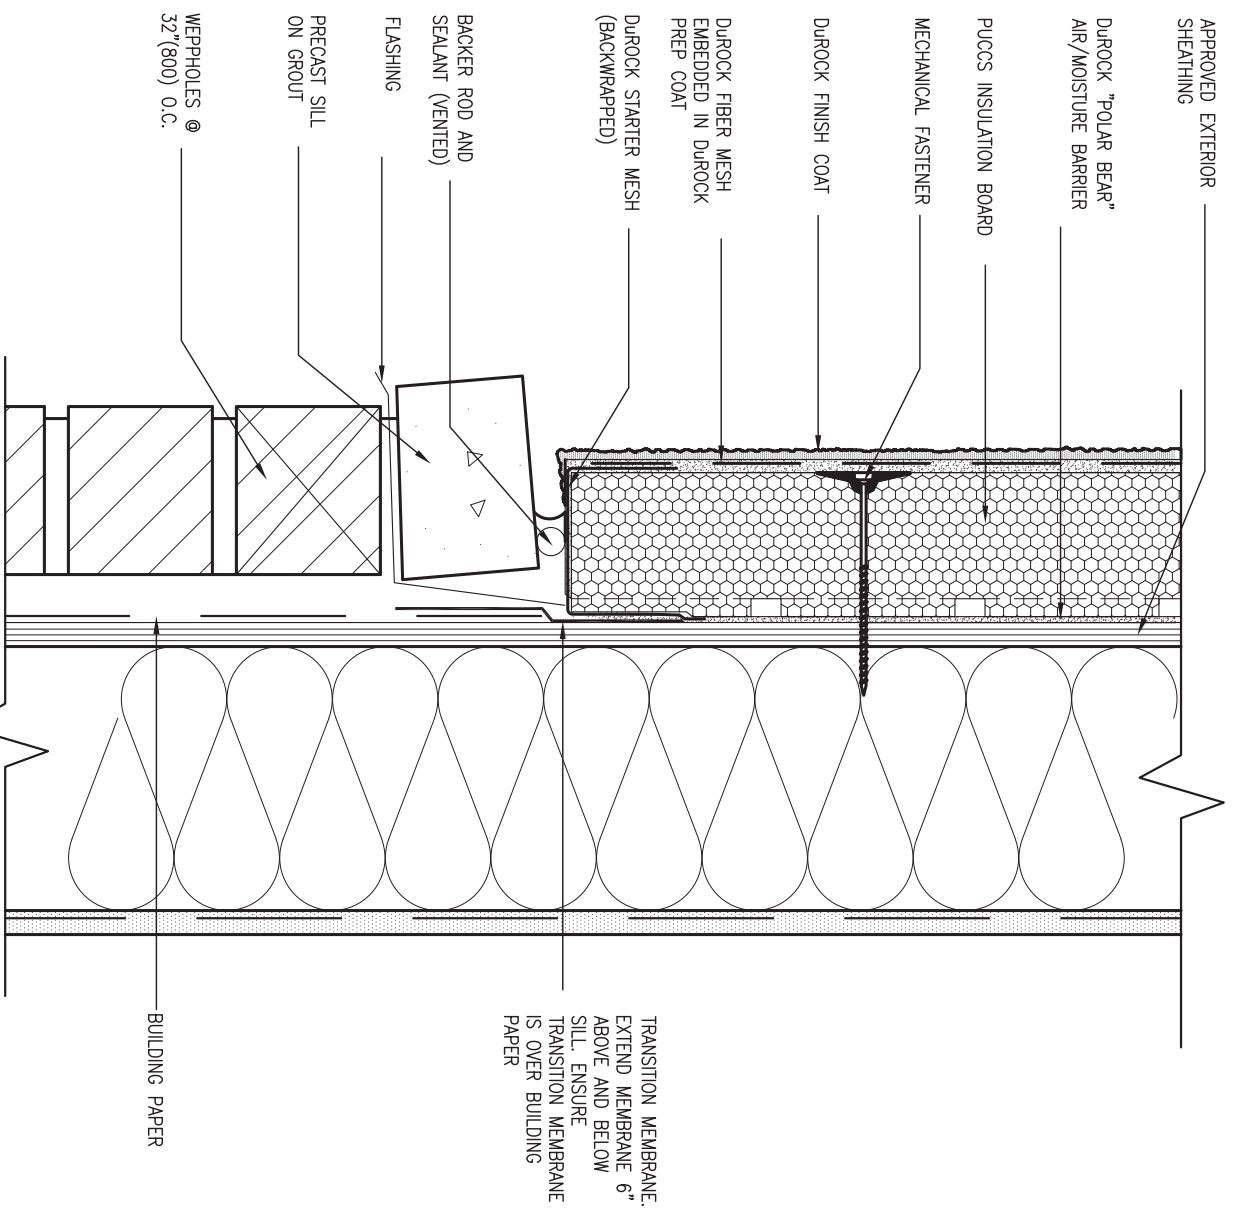The undersigned has reviewed and takes responsibility for this design and has the qualifications and meets the requirements set out in the Ontario Building Code to be a Designer.

Wellington Jno-Baptiste 25591
 name registration information BCIN
 VA3 Design Inc. 42658

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BAYVIEW WELLINGTON project name
GREEN VALLEY EAST municipality
 BRADFORD

project no. 16023


date MAY 2016
 drawn by RC
 checked by - scale 3/16" = 1'-0"
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CONST NOTE

CONSTRUCTION NOTES file name
 16023-CN-2022-A1

CNS drawing no.

SB12-COMPLIANCE PACKAGE 'A1'

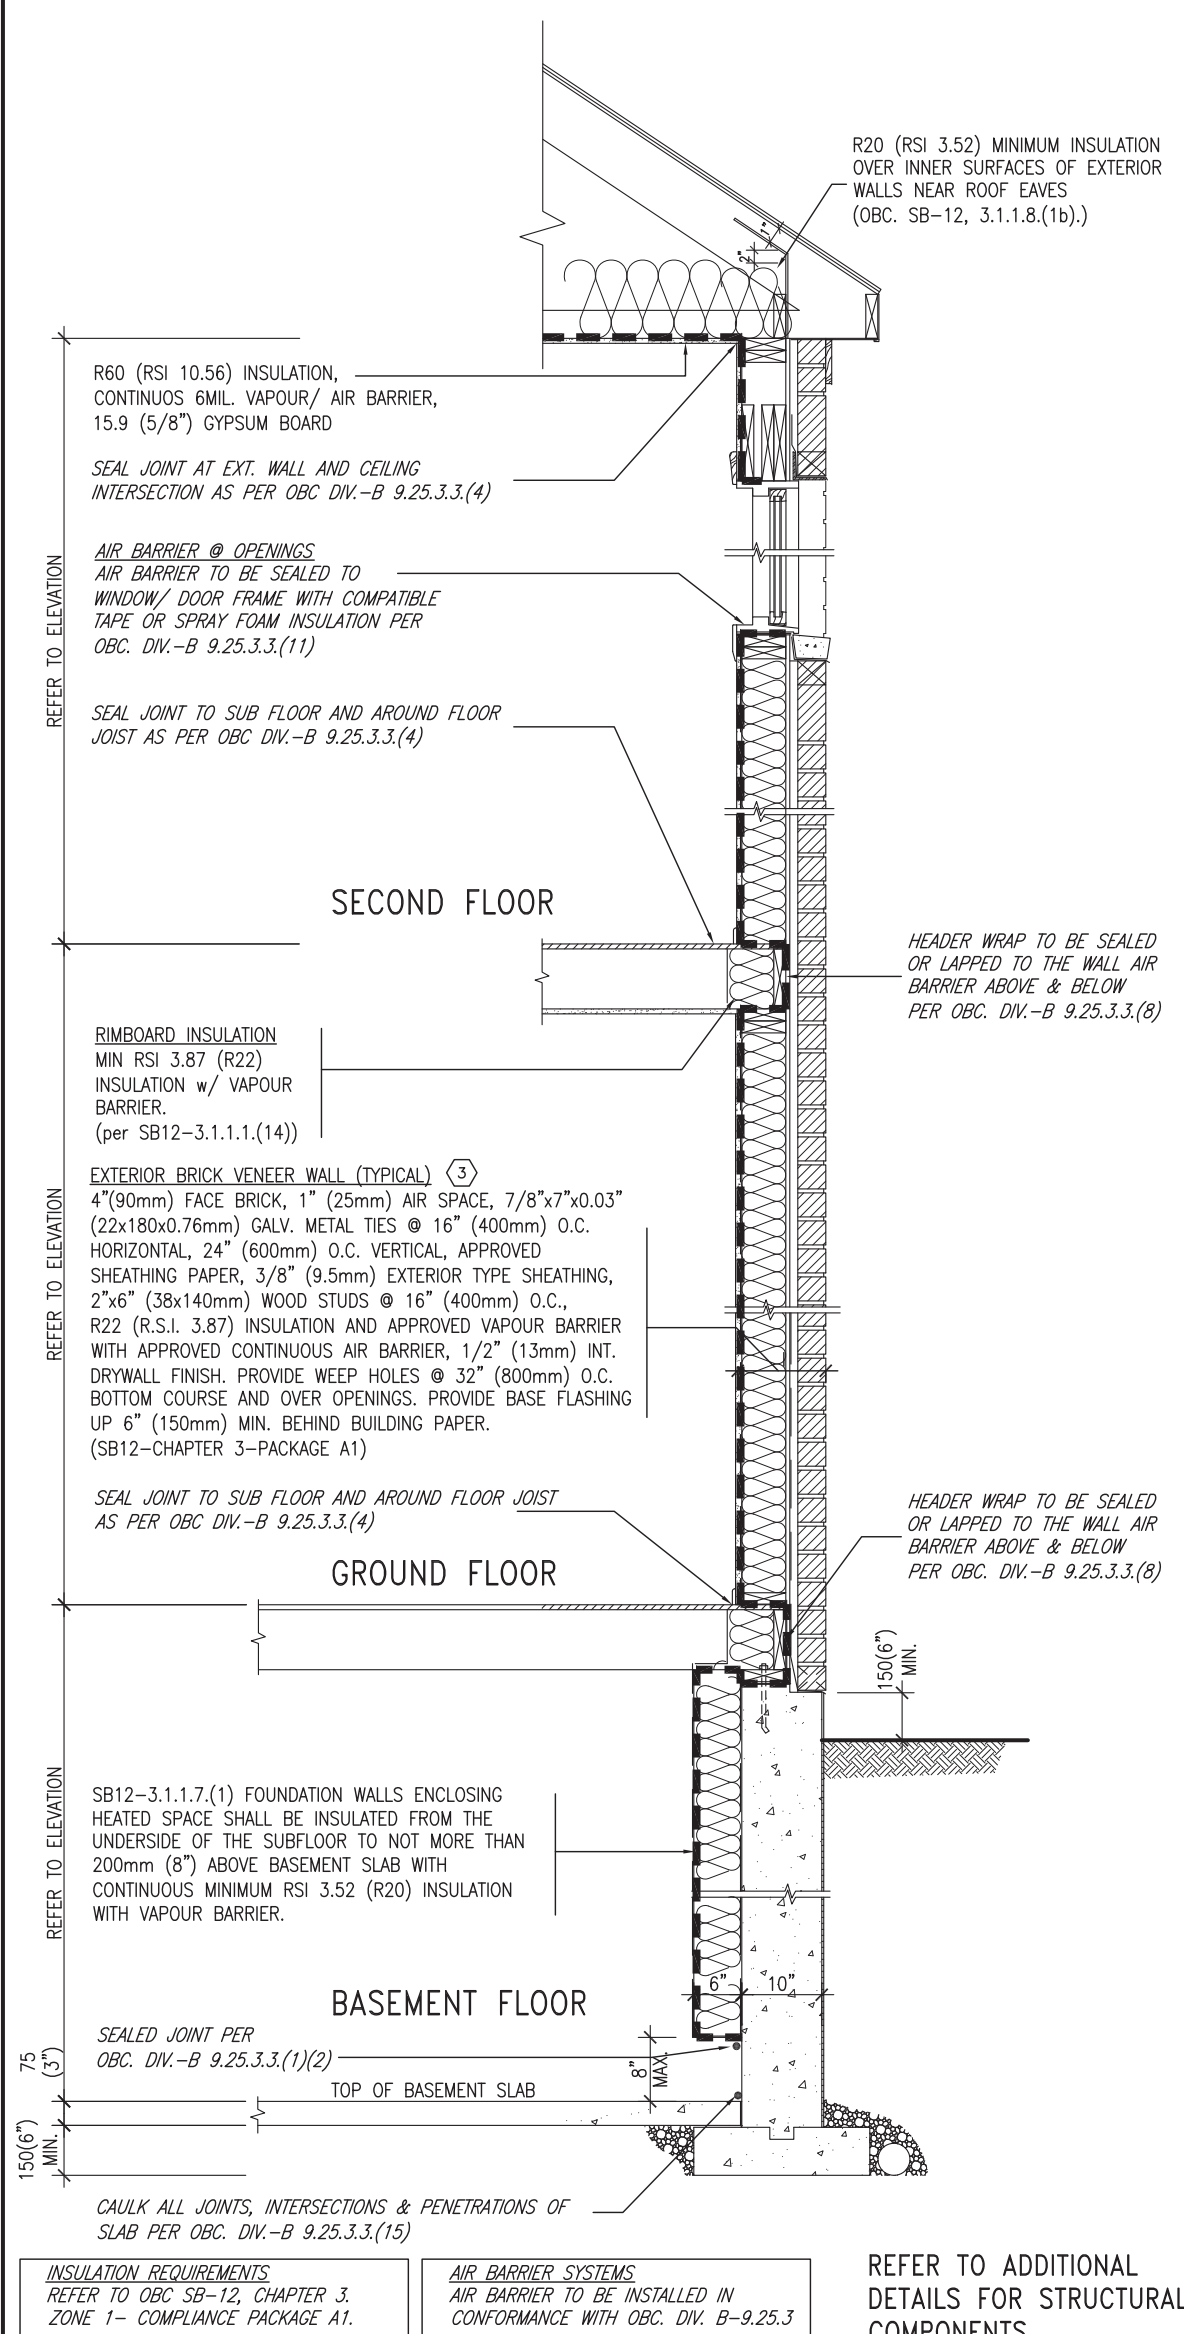


EW TYPICAL EXT. WALL AIR BARRIER CONTINUITY SECTION w/ BRICK VENEER (PACKAGE A1)
10" FOUNDATION WALL SCALE: N.T.S.

THE MINIMAL THERMAL PERFORMANCE OF BUILDING ENVELOPE AND EQUIPMENT SHALL CONFORM TO THE FOLLOWING SB-12 COMPLIANCE PACKAGE AS PER OBC SUPPLEMENTARY STANDARD SB-12, SECTION 3.1.1.1.

USE SB-12 COMPLIANCE PACKAGE (A1):		
COMPONENT	A1	Notes:
Ceiling with Attic Space	10.56 (R60)	R20 at inner face of exterior walls
Ceiling without Attic Space	5.46 (R31)	BATT or SPRAY
Exposed Floor	5.46 (R31)	BATT or SPRAY
Walls Above Grade	3.87 (R22)	6" R22 BATT
Basement Walls	3.52ci (R20ci)	OPTION TO USE R12+R10ci.
Edge of Below Grade Slab ≤600mm below grade	1.76 (R10)	RIGID INSUL
Windows & Sliding glass Doors	1.6	
Skylights	2.8U	
Space Heating Equipment	96% Min.	NATURAL GAS
Hot Water Heater	0.8	NATURAL GAS
HRV	75%	-
Drain Water Heat Recovery Unit (DWHR)	Minimum 1 OR Maximum 2 Required. Dependent on number of showers installed. Refer to SB12-3.1.1.12 for information.	

ci- Denotes Continuous Insulation without framing interruption.

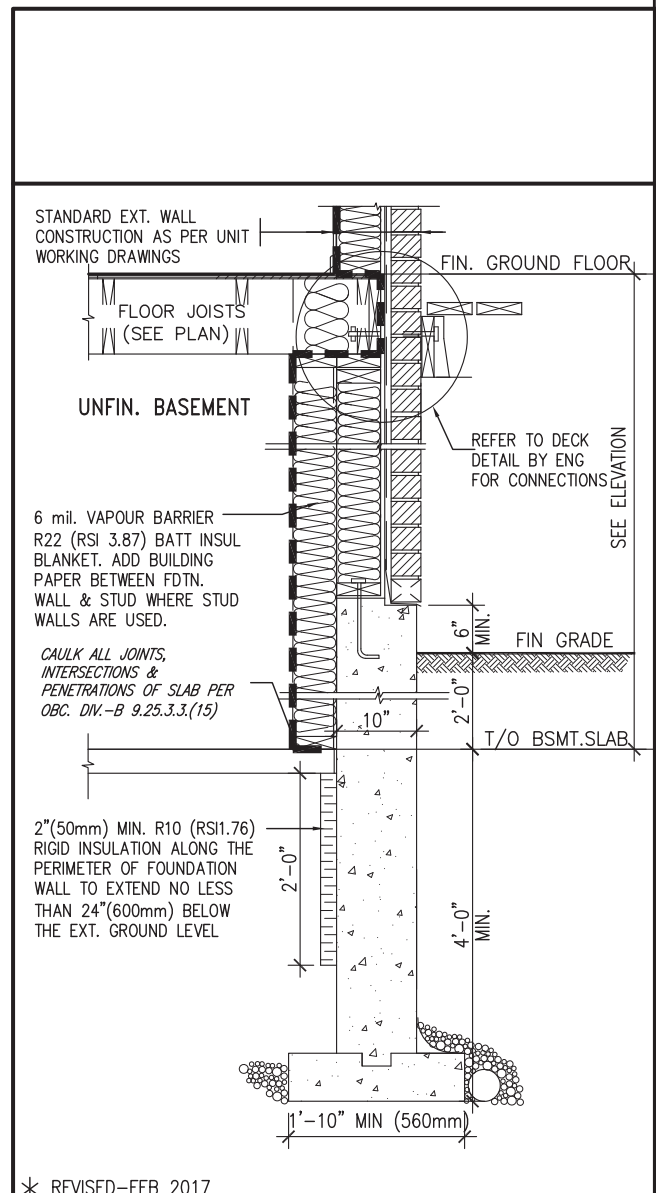

SECTION AT W.O.D/W.O.B.
* REVISED-FEB 2017

no.	description	date	by
9			
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4	UPDATE TO 2022	JAN 11-22	RC
3	UPDATE TO 2020	FEB 24-20	RC
2	UPDATE TO 2018	JAN 11-18	RC
1	ISSUE FOR CLIENT REVIEW	AUG 04-17	RC

The undersigned has reviewed and takes responsibility for this design and has the qualifications and meets the requirements set out in the Ontario Building Code to be a Designer.


qualification information
Wellington Jno-Baptiste 25591
 name
 signature
 BCIN
 registration information
VA3 Design Inc. 42658

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BAYVIEW WELLINGTON		CONST NOTE	
project name GREEN VALLEY EAST	municipality BRADFORD	project no. 16023	
date MAY 2016	checked by RC	scale 3/16" = 1'-0"	drawing no. CN6
CONSTRUCTION NOTES		16023-CN-2022-A1	
RICHARD - H:\ARCHIVE\WORKING\2016\16023.BW\Units\CN NOTES\16023-CN-2022-A1.dwg - Wed - Jan 26 2022 - 12:08 PM			

SB12-COMPLIANCE PACKAGE 'A1'



INSULATION REQUIREMENTS
REFER TO OBC SB-12, CHAPTER 3,
ZONE 1- COMPLIANCE PACKAGE A1.

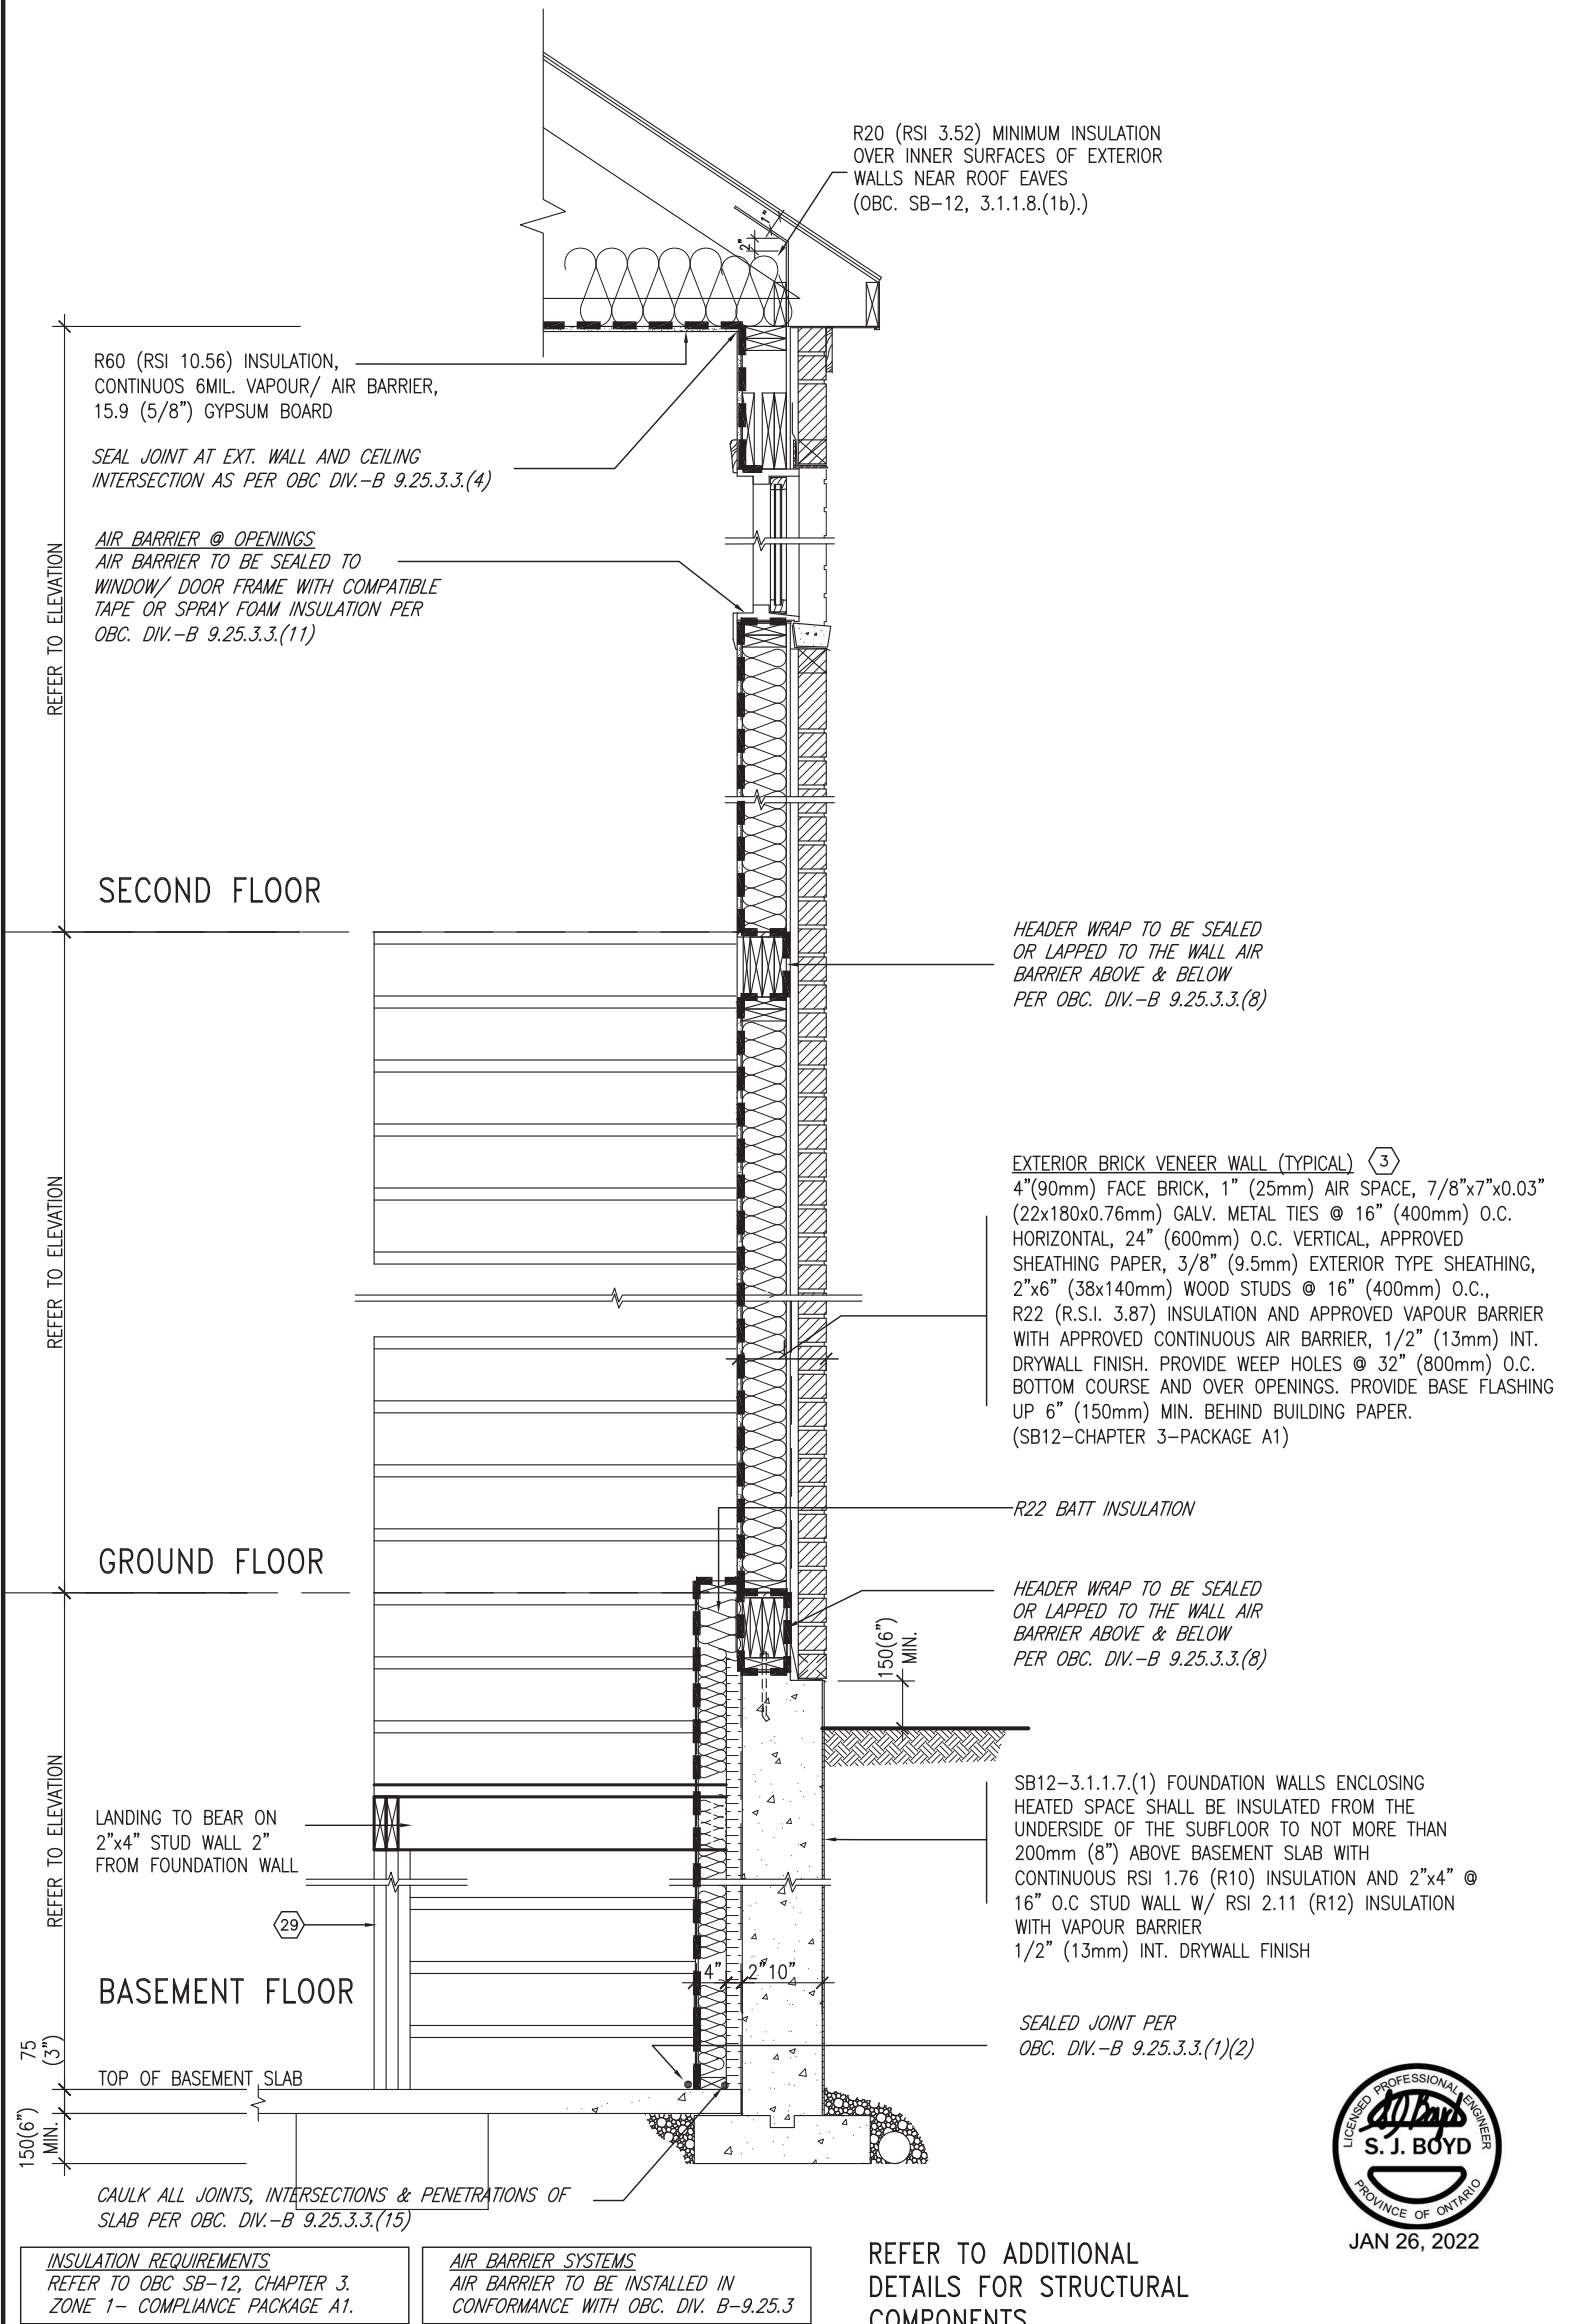AIR BARRIER SYSTEMS
AIR BARRIER TO BE INSTALLED IN
CONFORMANCE WITH OBC. DIV. B-9.25.3

REFER TO ADDITIONAL
DETAILS FOR STRUCTURAL
COMPONENTS




EW STR TYPICAL EXT. WALL AIR BARRIER CONTINUITY SECTION w/
BRICK VENEER AT STAIR AND SUNKEN COND (PACKAGE A1)
10\"/>


9	.	.	.	The undersigned has reviewed and takes responsibility for this design and has the qualifications and meets the requirements set out in the Ontario Building Code to be a Designer.		BAYVIEW WELLINGTON project name GREEN VALLEY EAST date MAY 2016 drawn by RC checked by - scale 3/16" = 1'-0" RICHARD - H:\ARCHIVE\WORKING\2016\16023.BW\Units\CN NOTES\16023-CN-2022-A1.dwg - Wed - Jan 26 2022 - 12:09 PM	CONST NOTE project no. 16023 municipality BRADFORD CONSTRUCTION NOTES file name 16023-CN-2022-A1 CN7
8	.	.	qualification information				
7	.	.	Wellington Jno-Baptiste 25591 name signature BCIN				
6	.	.	VA3 Design Inc. 42658 registration information	255 Consumers Rd Suite 120 Toronto ON M2J 1R4 t 416.630.2255 f 416.630.4782 va3design.com			
5	.	.	.	Contractor must verify all dimensions on the job and report any discrepancy to the Designer before proceeding with the work. All drawings and specifications are instruments of service and the property of the Designer which must be returned at the completion of the work. Drawings are not to be scaled.			
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no.	description	date	by				

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COMPLIANCE TO OBC SB-12 2.1.1.1(11)

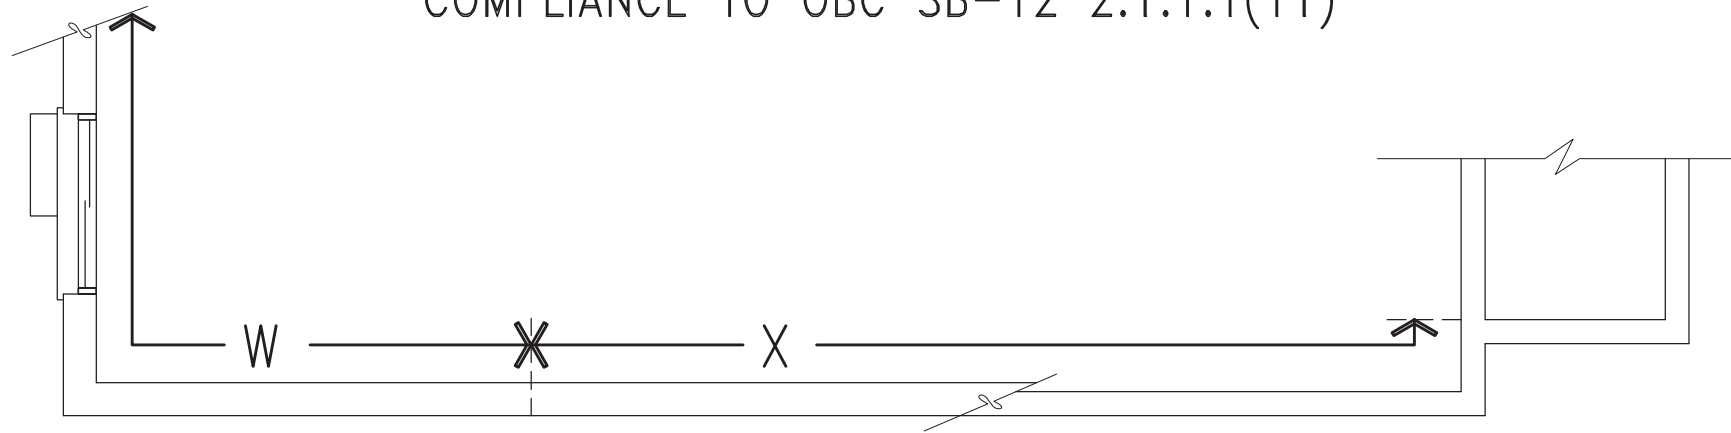

WOB PLAN

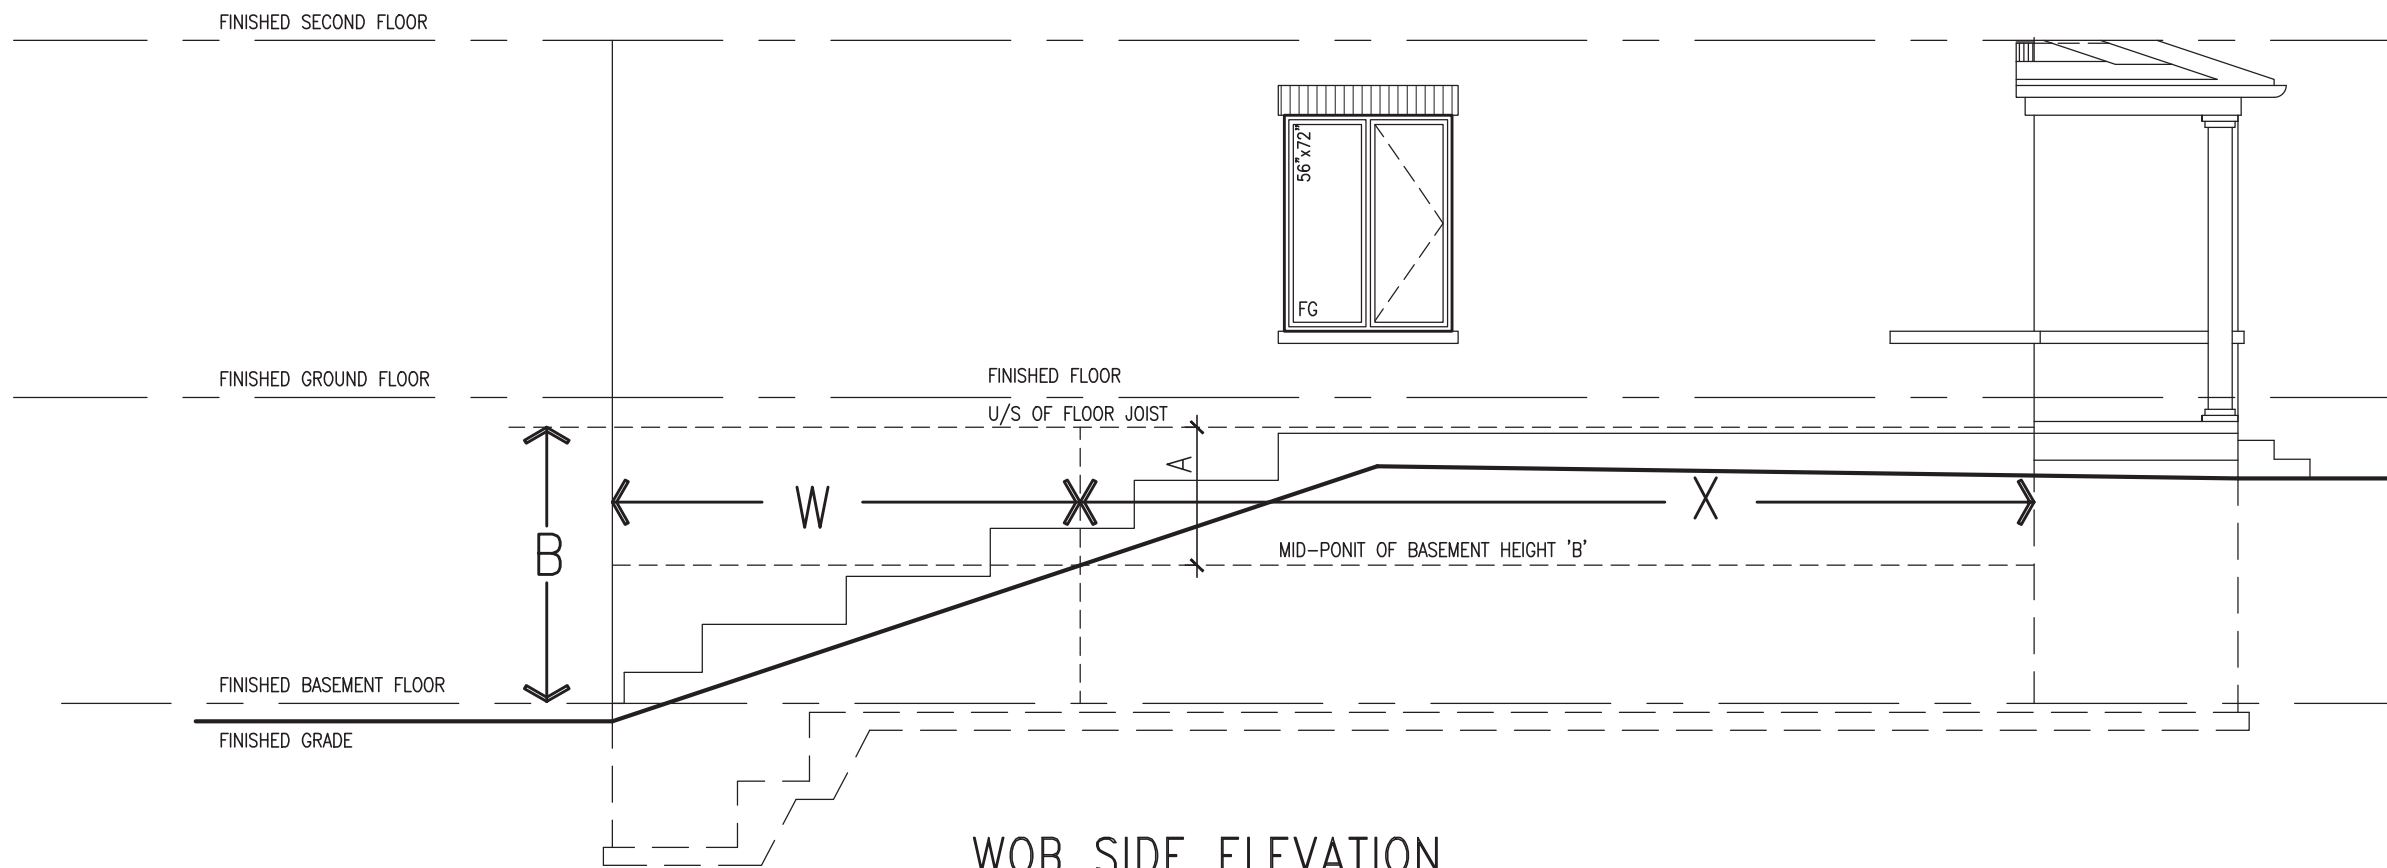

WOB SIDE ELEVATION


WHEN EXPOSED WALL "A" IS GREATER THAN 50% OF BASEMENT WALL HEIGHT "B" INSULATION VALUE FOR WALL IN SECTION "W" IS NOT LESS THAN IS REQUIRED FOR ABOVE GRADE WALL AS REQUIRED BY TABLE 2.1.1.2A

WHEN EXPOSED WALL "A" IS LESS THAN 50% OF BASEMENT WALL HEIGHT "B" INSULATION VALUE FOR WALL IN SECTION "X" IS NOT LESS THAN BASEMENT WALL AS REQUIRED BY TABLE 2.1.1.2A




<p>VA3 DESIGN 255 Consumers Rd, Suite 120 Toronto, ON M2J 1R4 t 416.630.2255 f 416.630.4782 v3design.com</p>		<p>BAYVIEW WELLINGTON</p>	<p>CONST NOTE</p>
<p>project name: GREEN VALLEY EAST municipality: BRADFORD</p>		<p>project no.: 16023 drawing no.: CN8</p>	
<p>date: MAY 2016 drawn by: RC</p>		<p>checked by: - scale: 3/16" = 1'-0"</p>	
<p>name: Wellington Jno-Baptiste registration information: VA3 Design Inc. BCIN: 25591 42658</p>		<p>CONSTRUCTION NOTES</p>	
<p>The undersigned has reviewed and takes responsibility for this design and has the qualifications and meets the requirements set out in the Ontario Building Code to be a Designer.</p>		<p>16023-CN-2022-A1 16023-CN-2022-A1 Jun 26 2022 - 12:06 PM</p>	
<p>Contractor must verify all dimensions on the job and report any discrepancy to the Designer before proceeding with the work. All drawings and specifications are instruments of service and the property of the Designer which must be returned at the completion of the work. Drawings are not to be scaled.</p>		<p>no. description</p>	
9	.	date	by
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4	UPDATE TO 2022	JAN 11-22	RC
3	UPDATE TO 2020	FEB 24-20	RC
2	UPDATE TO 2018	JAN 11-18	RC
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X1 SECTION AT PORCH FOR 4-7R CONDITION
SCALE: N.T.S.

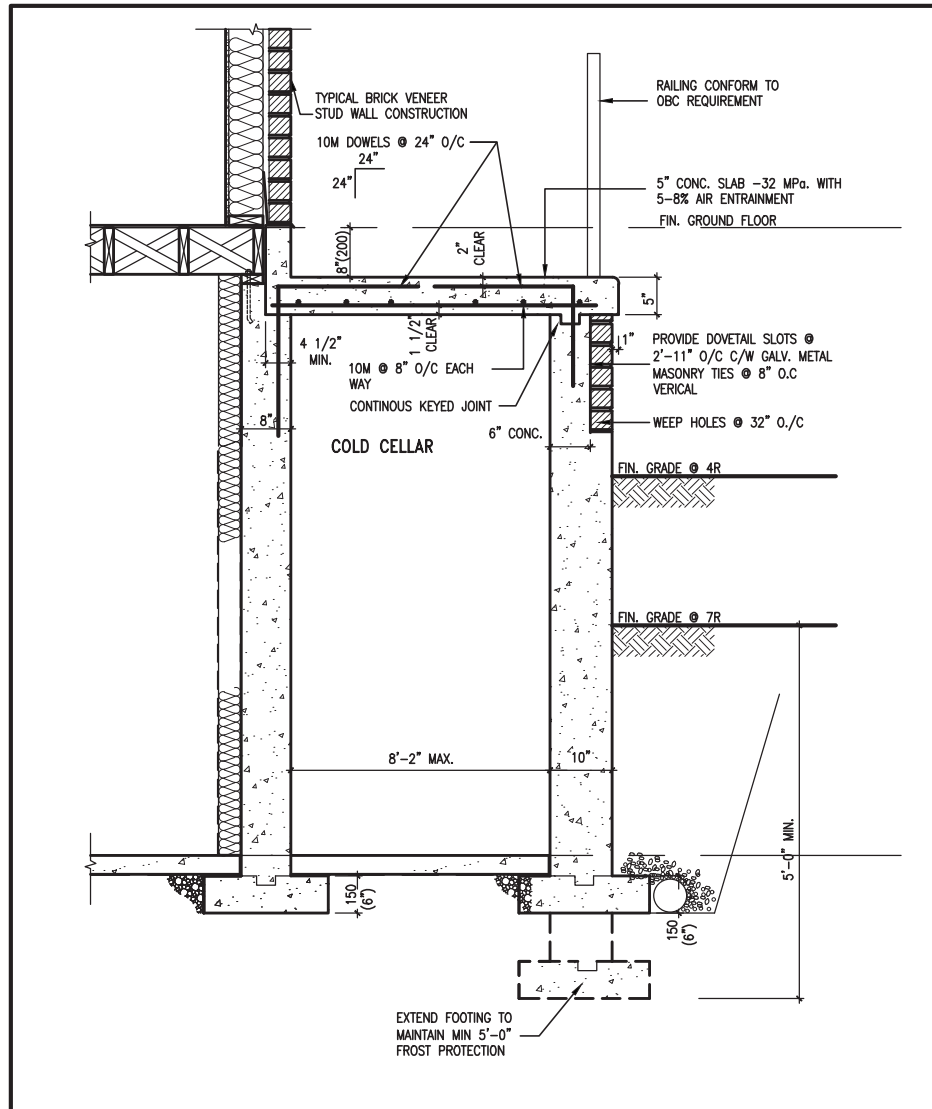

X2 EXTERIOR CONC. STAIR DETAIL (6 RISERS/ 7 RISERS SIMILAR)
SCALE: N.T.S.

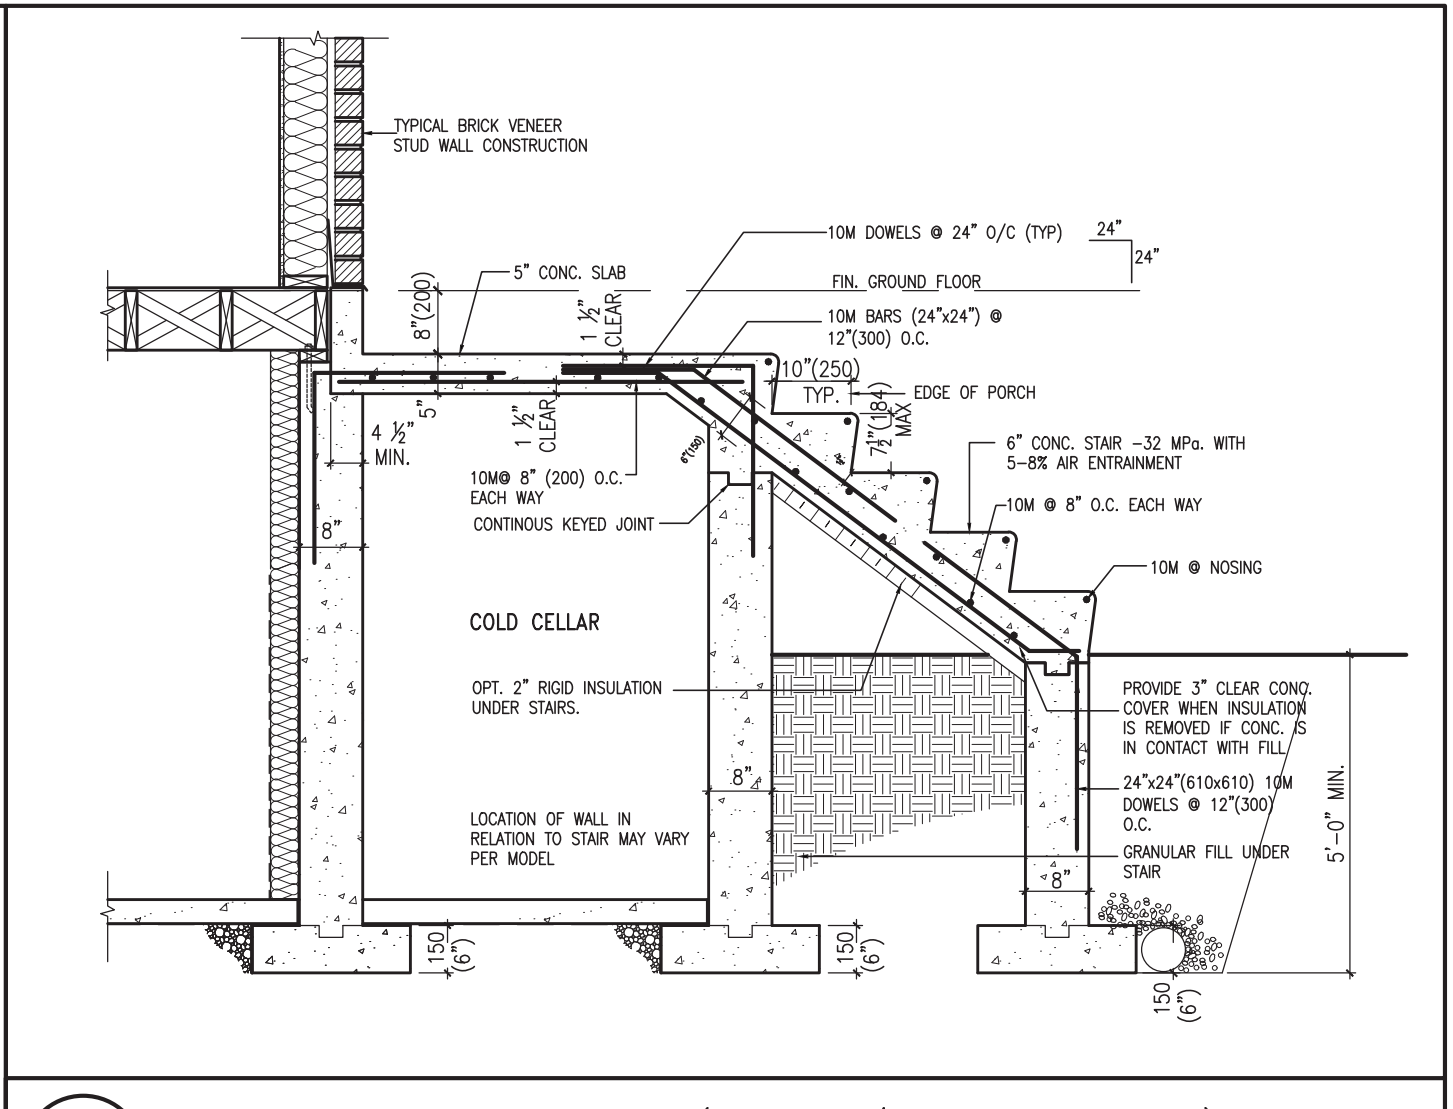

BAYVIEW WELLINGTON




The undersigned has reviewed and takes responsibility for this design and has the qualifications and meets the requirements set out in the Ontario Building Code to be a Designer.
 qualification information
 Wellington Jno-Baptiste 25591 BCIN
 name
 registration information
 VAS Design Inc. 42658
 Contractor must verify all dimensions on the job and report any discrepancy to the Designer before proceeding with the work. All drawings and specifications are instruments of service and the property of the Designer which must be returned at the completion of the work. Drawings are not to be scaled.

no.	description	date	by
9			
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4	UPDATE TO 2022	JAN 11-22	RC
3	UPDATE TO 2020	FEB 24-20	RC
2	UPDATE TO 2018	JAN 11-18	RC
1	ISSUE FOR CLIENT REVIEW	AUG 04-17	RC

CONST NOTE


project no. 16023
 municipality BRADFORD
 project name GREEN VALLEY EAST
 date MAY 2016
 checked by RC
 scale 3/16" = 1'-0"
 drawing no. CN9
 construction notes 16023-CN-2022-A1
 drawn by RC
 date JUN 26 2022 - 12:06 PM
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WALK-OUT DECK WALL INTERSECTION-ELEVATION


NOT TO SCALE

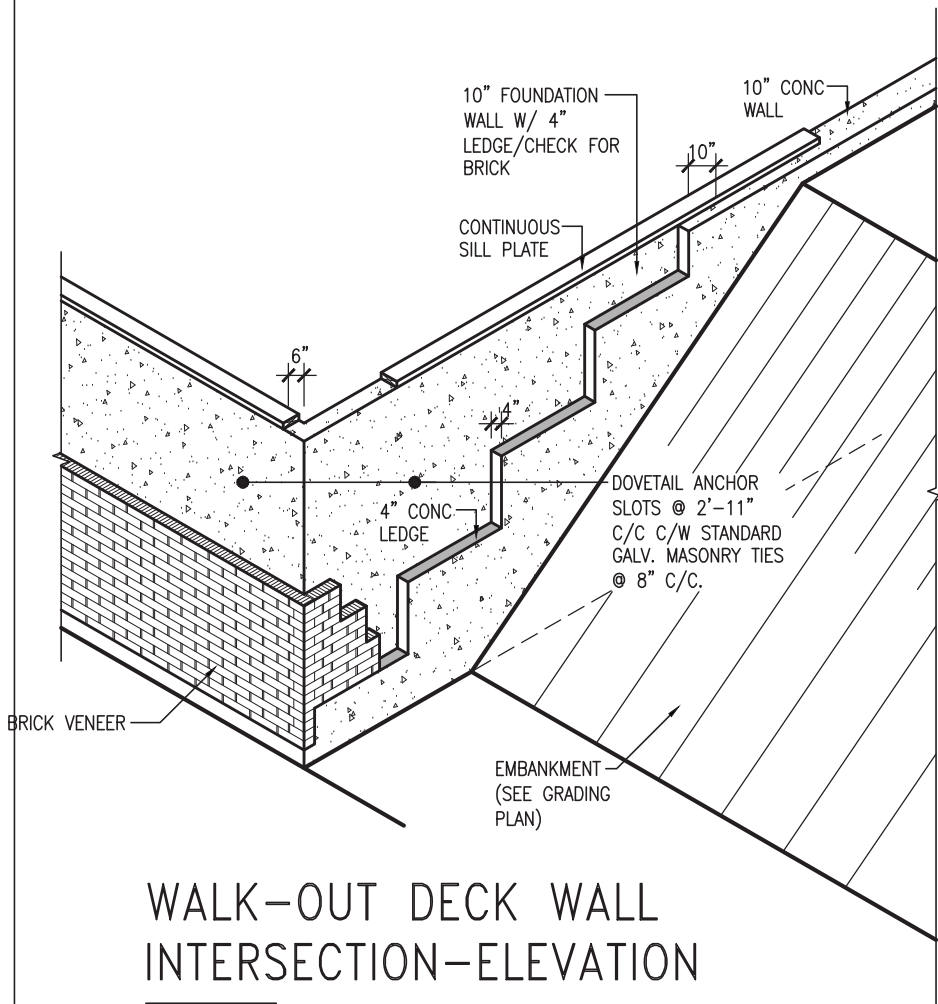

WALK-OUT DECK WALL INTERSECTION-PLAN


NOT TO SCALE

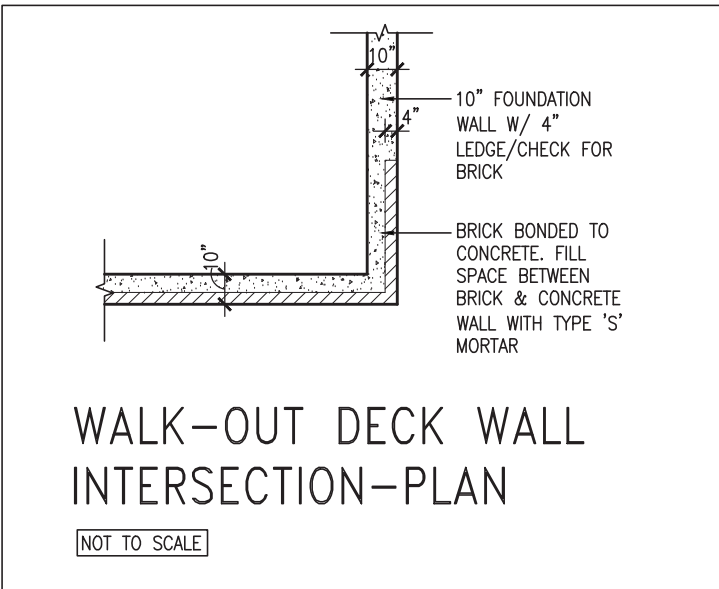(10" FOUNDATION WALL)

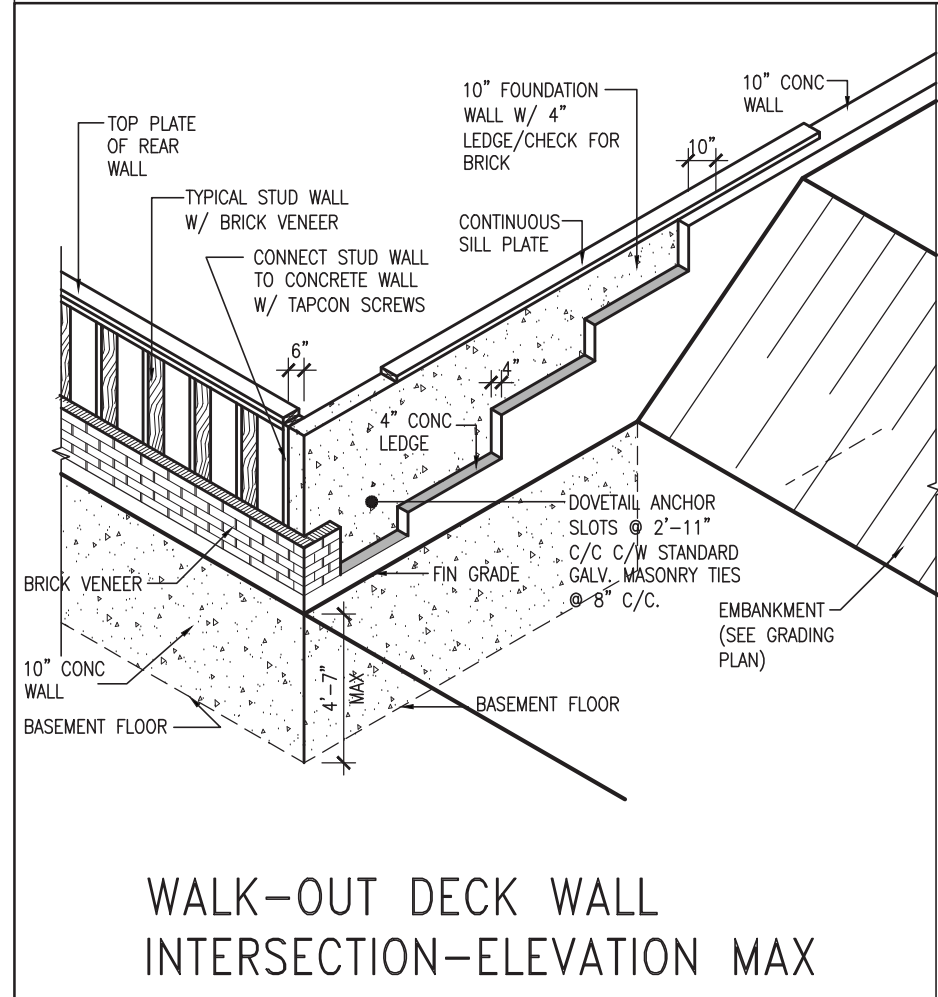

WALK-OUT DECK WALL INTERSECTION-ELEVATION MAX 4'-7" BACKFILL

NOT TO SCALE

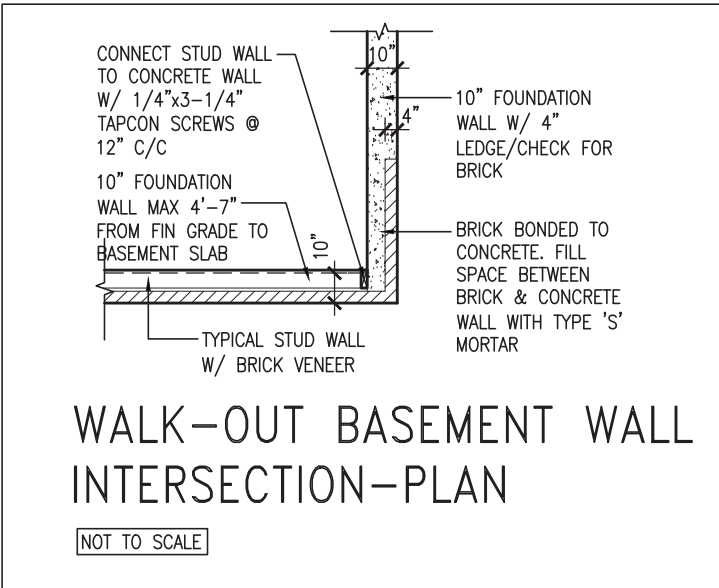

WALK-OUT BASEMENT WALL INTERSECTION-PLAN

NOT TO SCALE

(10" FOUNDATION WALL)



JAN 26, 2022

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4	UPDATE TO 2022	JAN 11-22	RC
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1	ISSUE FOR CLIENT REVIEW	AUG 04-17	RC
no.	description	date	by

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 name registration information BCIN
 VA3 Design Inc. 42658

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 va3design.com

BAYVIEW WELLINGTON

project name GREEN VALLEY EAST municipality BRADFORD


date MAY 2016
 drawn by RC checked by scale 3/16" = 1'-0"

CONST NOTE

project no. 16023


CONSTRUCTION NOTES
 file name 16023-CN-2022-A1
 drawing no. **CN10**

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WALK-OUT BASEMENT WALL INTERSECTION-ELEVATION

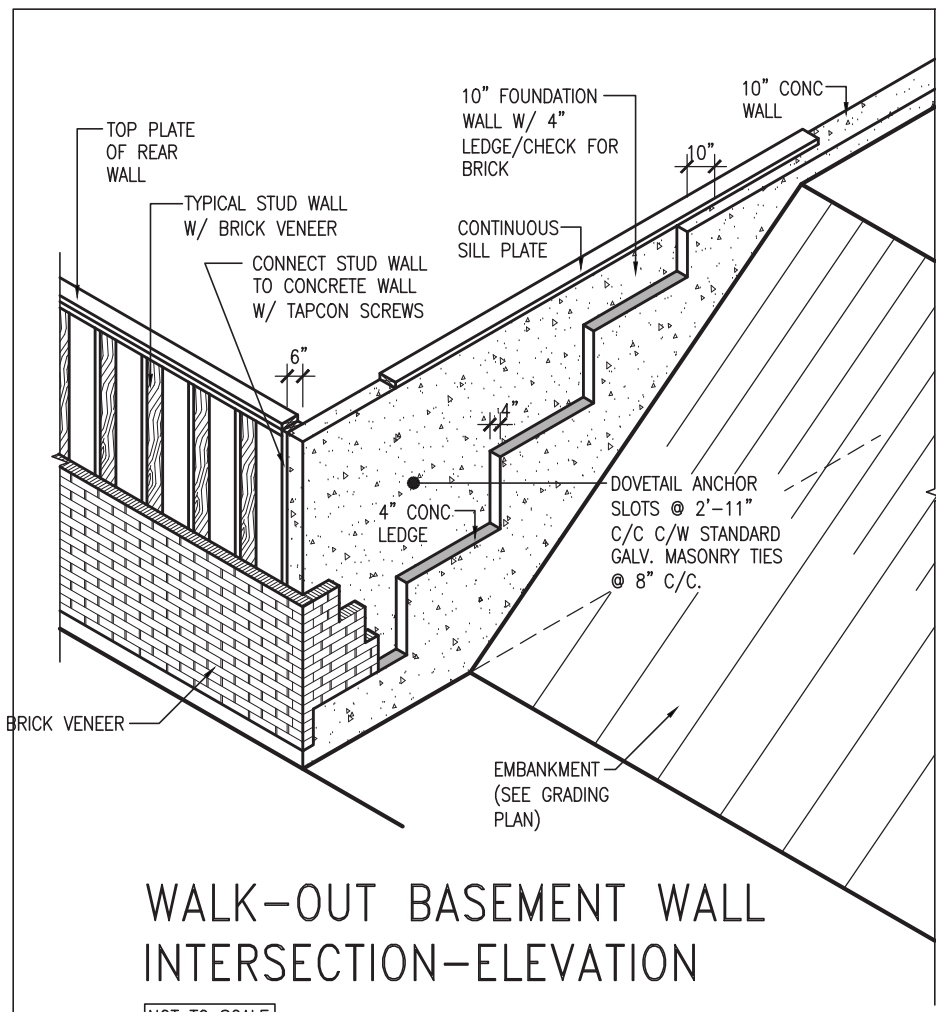
NOT TO SCALE



WALK-OUT BASEMENT WALL INTERSECTION-PLAN

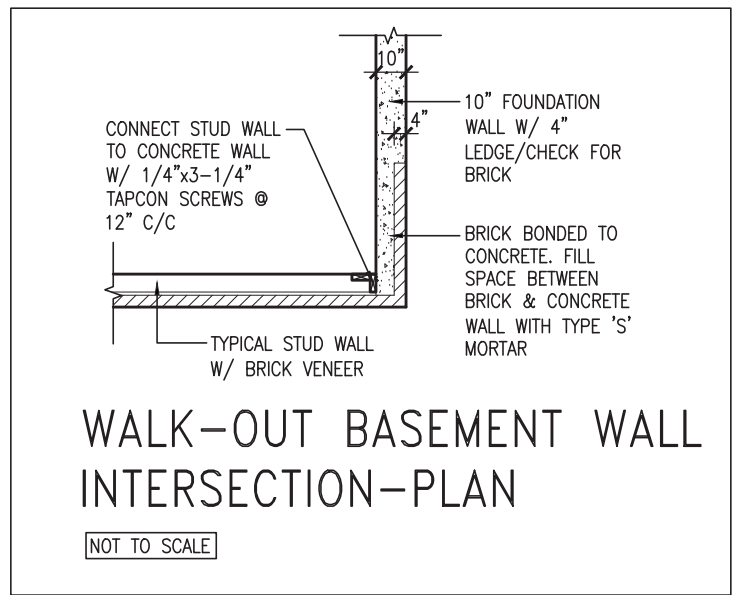
NOT TO SCALE

(10" FOUNDATION WALL)

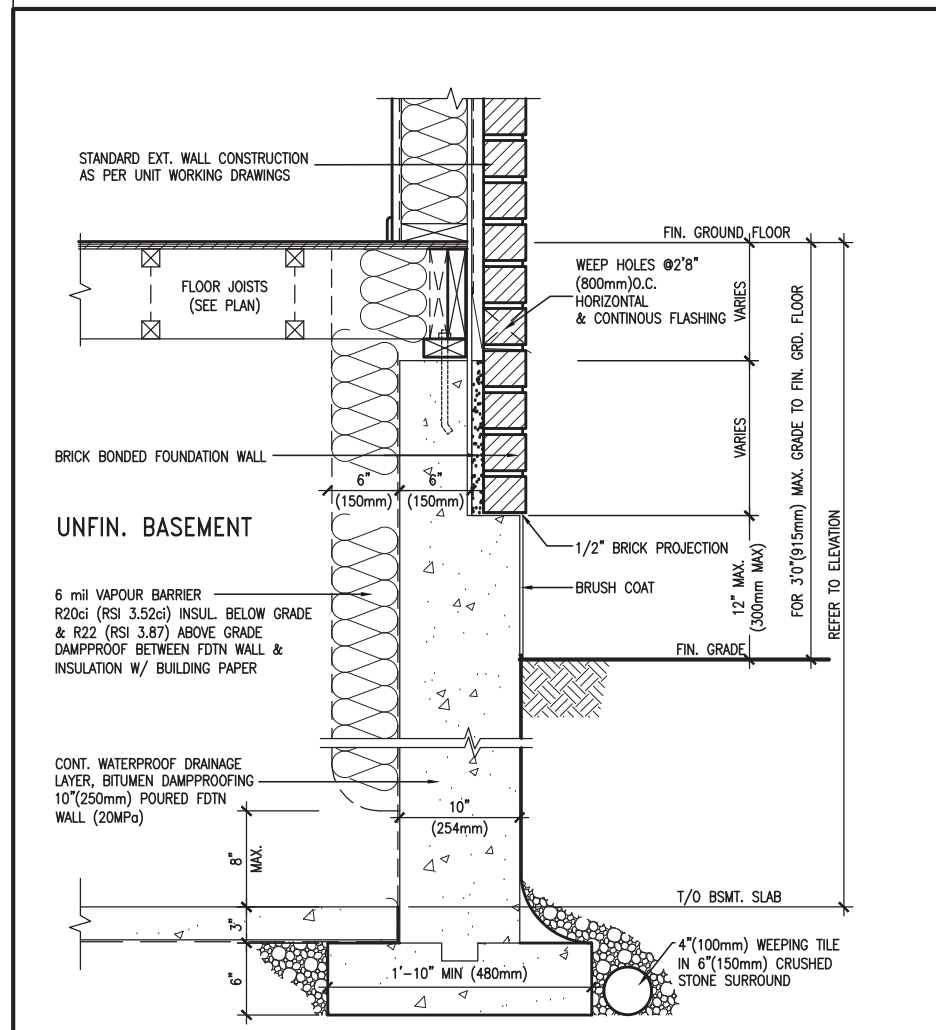

WALL SECTION FOR GRADE TO FIN. FLOOR MORE THAN 4'7" (1400mm) HEIGHT DIFFERENCE

SCALE: N.T.S.

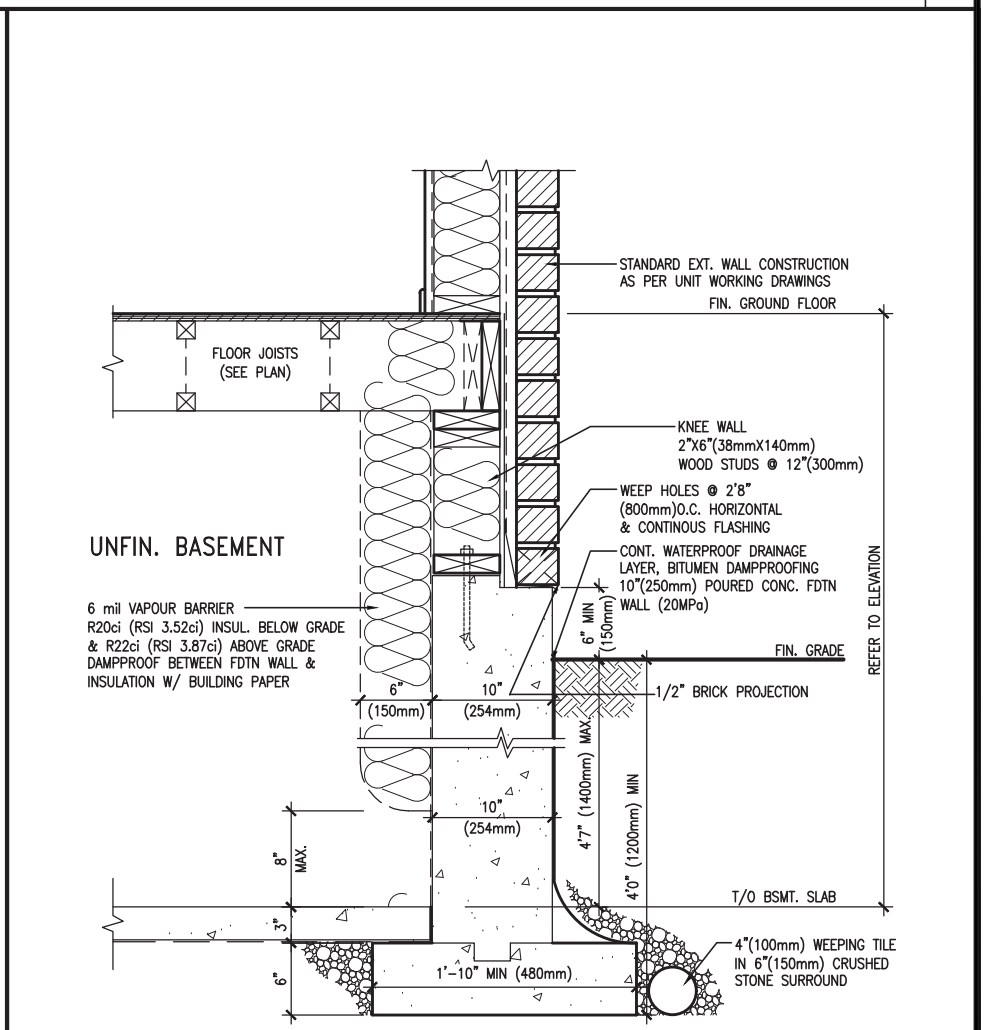

WALL SECTION FOR GRADE TO BASEMENT SLAB 4'7" (1400mm) MAX. HEIGHT DIFFERENCE

SCALE: N.T.S.



JAN 26, 2022

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4	UPDATE TO 2022	JAN 11-22	RC
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 va3design.com

BAYVIEW WELLINGTON

project name GREEN VALLEY EAST municipality BRADFORD


date MAY 2016
 drawn by RC checked by scale 3/16" = 1'-0"

CONST NOTE

project no. 16023

CONSTRUCTION NOTES
 file name 16023-CN-2022-A1
 drawing no. CN11

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CN12

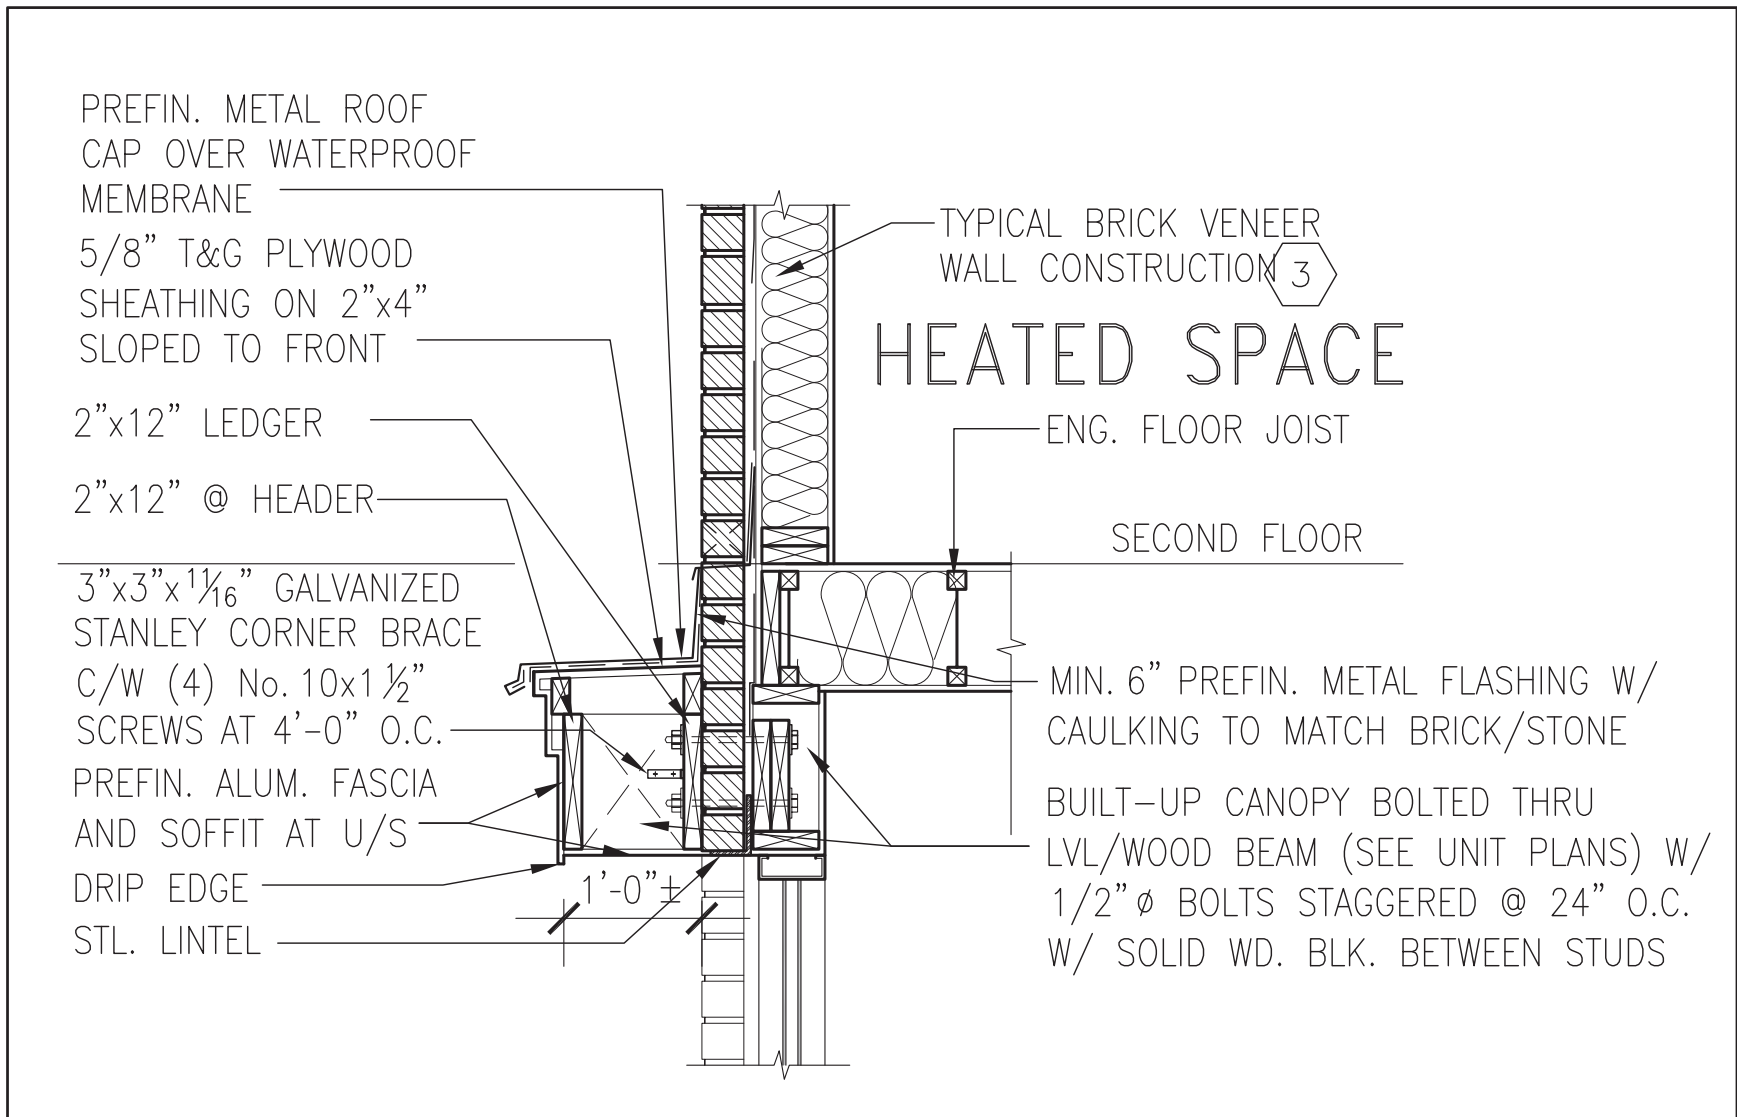SECTION THROUGH CANOPY

SCALE 1/2" = 1'-0"



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4	UPDATE TO 2022	JAN 11-22	RC
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no.	description	date	by

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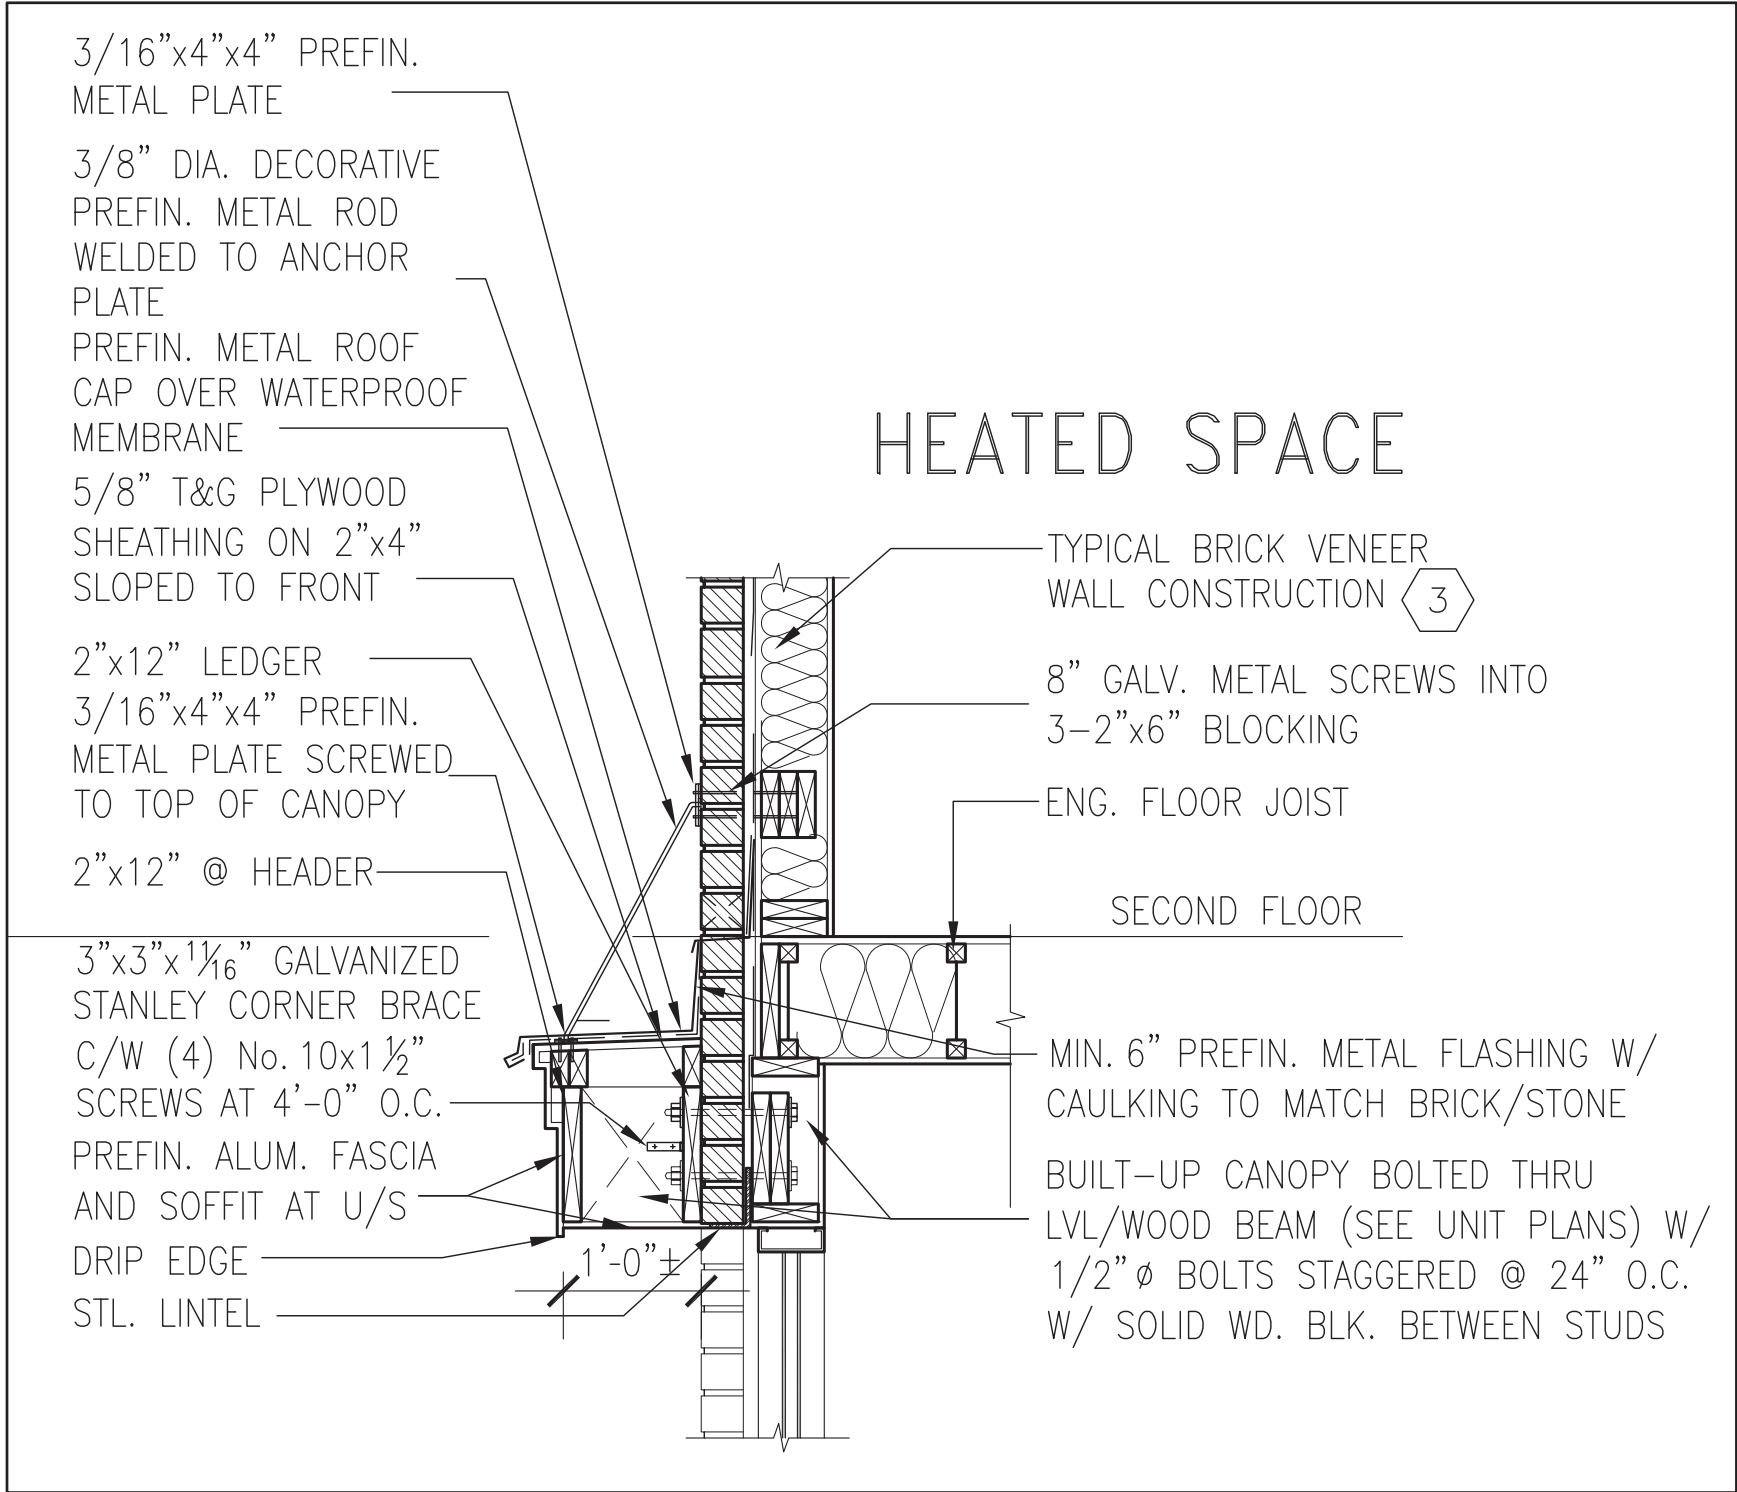
qualification information
Wellington Jno-Baptiste 25591
 name registration information BCIN
VA3 Design Inc. 42658

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BAYVIEW WELLINGTON		CONST NOTE	
project name GREEN VALLEY EAST	municipality BRADFORD	project no. 16023	
date MAY 2016	checked by RC	scale 3/16" = 1'-0"	file name 16023-CN-2022-A1
CONSTRUCTION NOTES			CN12
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CN13

SECTION THROUGH CANOPY

W/ DECORATIVE ROD

SCALE 1/2" = 1'-0"



9	.	.	.	The undersigned has reviewed and takes responsibility for this design and has the qualifications and meets the requirements set out in the Ontario Building Code to be a Designer.		BAYVIEW WELLINGTON	CONST NOTE
8	.	.	.	qualification information Wellington Jno-Baptiste 25591 name registration information VA3 Design Inc. 42658			
7	.	.	.	Contractor must verify all dimensions on the job and report any discrepancy to the Designer before proceeding with the work. All drawings and specifications are instruments of service and the property of the Designer which must be returned at the completion of the work. Drawings are not to be scaled.	255 Consumers Rd Suite 120 Toronto ON M2J 1R4 t 416.630.2255 f 416.630.4782 va3design.com	date MAY 2016	municipality BRADFORD
6	.	.	.			drawn by RC	checked by -
5	.	.	.				drawing no. CN13
4	UPDATE TO 2022	JAN 11-22	RC				
3	UPDATE TO 2020	FEB 24-20	RC				
2	UPDATE TO 2018	JAN 11-18	RC				
1	ISSUE FOR CLIENT REVIEW	AUG 04-17	RC				
no.	description	date	by				

3/16"x4"x4" PREFIN.
METAL PLATE

3/8" DIA. DECORATIVE
PREFIN. METAL ROD
WELDED TO ANCHOR
PLATE

PREFIN. METAL ROOF
CAP OVER WATERPROOF
MEMBRANE

5/8" T&G PLYWOOD
SHEATHING ON 2"x4"
SLOPED TO FRONT

2"x12" LEDGER

3/16"x4"x4" PREFIN.
METAL PLATE SCREWED
TO TOP OF CANOPY

2"x12" @ HEADER

3"x3"x1/16" GALVANIZED
STANLEY CORNER BRACE

C/W (4) No. 10x1 1/2"
SCREWS AT 4'-0" O.C.

PREFIN. ALUM. FASCIA
AND SOFFIT AT U/S

DRIP EDGE

STL. LINTEL

8" GALV. METAL SCREWS INTO
3-2"x6" BLOCKING

PREFINISHED METAL FLASHING
OVER WATERPROOF MEMBRANE

2"x6" @ 12" O.C. NAILED TO
2"x8" JOIST BELOW

CANT STRIP

ROOF NOTE R1


SINGLE PLY ROOF MEMBRANE
W/5/8" EXTERIOR GRADE

SHEATHING W/ 2"x4" @ 12"
O.C. DIAGONALLY CUT CROSS

PURLINS 2"x8" @ 16" O.C. W/

MIN. 6" PREFIN. METAL FLASHING W/
CAULKING TO MATCH BRICK/STONE

BUILT-UP CANOPY BOLTED THRU
LVL/WOOD BEAM (SEE UNIT PLANS) W/
1/2" Ø BOLTS STAGGERED @ 24" O.C.
W/ SOLID WD. BLK. BETWEEN STUDS

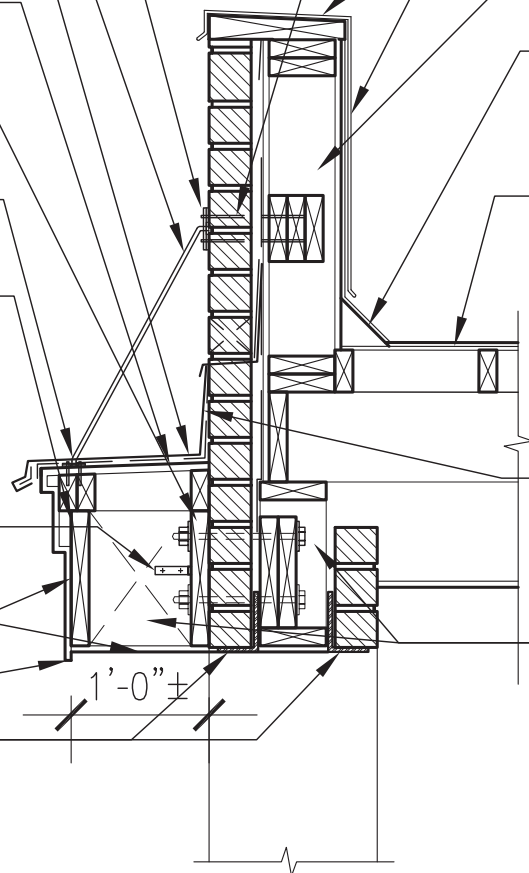

1

CN14

SECTION THROUGH CANOPY

W/ DECORATIVE ROD

SCALE 1/2" = 1'-0"



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4	UPDATE TO 2022	JAN 11-22	RC
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qualification information
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 name registration information BCIN
VA3 Design Inc. 42658

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 Toronto ON M2J 1R4
 t 416.630.2255 f 416.630.4782
 va3design.com

BAYVIEW WELLINGTON		CONST NOTE	
project name GREEN VALLEY EAST	municipality BRADFORD	project no. 16023	
date MAY 2016	checked by RC	scale 3/16" = 1'-0"	file name 16023-CN-2022-A1
CONSTRUCTION NOTES			CN14

CONST NOTE	
project no. 16023	drawing no. CN14