




Town of Innisfii Certified Model 2023-05-02 3:58:38 PM jpenfold

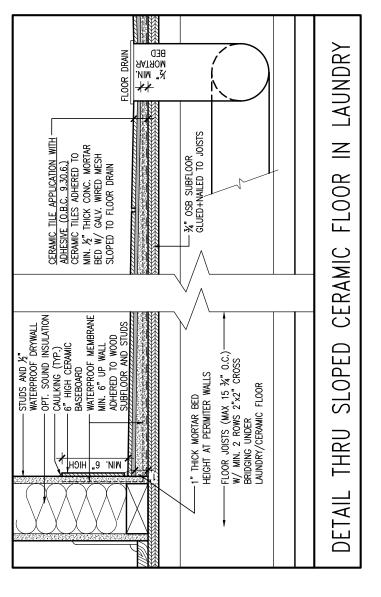


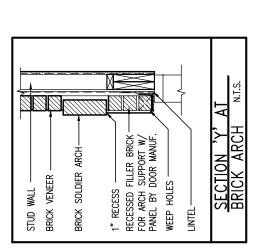

		B'BM/NNII2/1H/1-0BC 5053 CNEKEENI/13048-1H-2'9M ³ − .	BICHARD - H:\ARCHIVE\WORKING\2013/13049	moɔ.npisəbζαν	t the Designer which must be returned at the completion of the work. rawings are not to be scaled.		date	no. description
I K	3-HT-64051	2/10" = 1'-0"		1 416.630.2255 f 416.630.4782	fundad ain nun sautae la eulaunnelli ain eulappallisade nun efiliant	N. ■ W.	DEC: 30-17	1 ISSUED FOR CLIENT REVIEW
	emon elit	scale	quamu ph cuecked by DECEMBER 2017		ontractor must verity all dimensions on the job and report any iscrepancy to the besigner before proceeding with the work. All the work. All	NT b	81\81 YAM	2 REVISED AS PER ROOF TRUSS COMMENTS.
drawing no.	DETAILS		DECEMBER 2017			TW	81\22 YAM	
6₽0C I		INNISFIL, ON.	ALCONA SHORES	DEZICN	85 Design Incomposition of a part of	3 85	181-22 NUL	4 REVISED AS PER ENG'S COMMENTS
project no.		Windioipulm	project name	TA TA	orne signature BCIN	⊔ SN	MAR 21/23	5 UPDATED TO 2023 OBC
	CKANE 5				16275 STELL JOCAL atzitae8-onl notpnille	١.	,	. 9
1		WELLINGTON	BALNIEM	>-7/\	ualification information		•	· L
1	G-HT	MOTOMILIAM	DAVVIEW		nd has the qualifications and meets the requirements set out in the ntario Building Code to be a Designer.		,	. 8
) U. L.	he undersigned has reviewed and takes responsibility for this design	Ι.	•	· 6



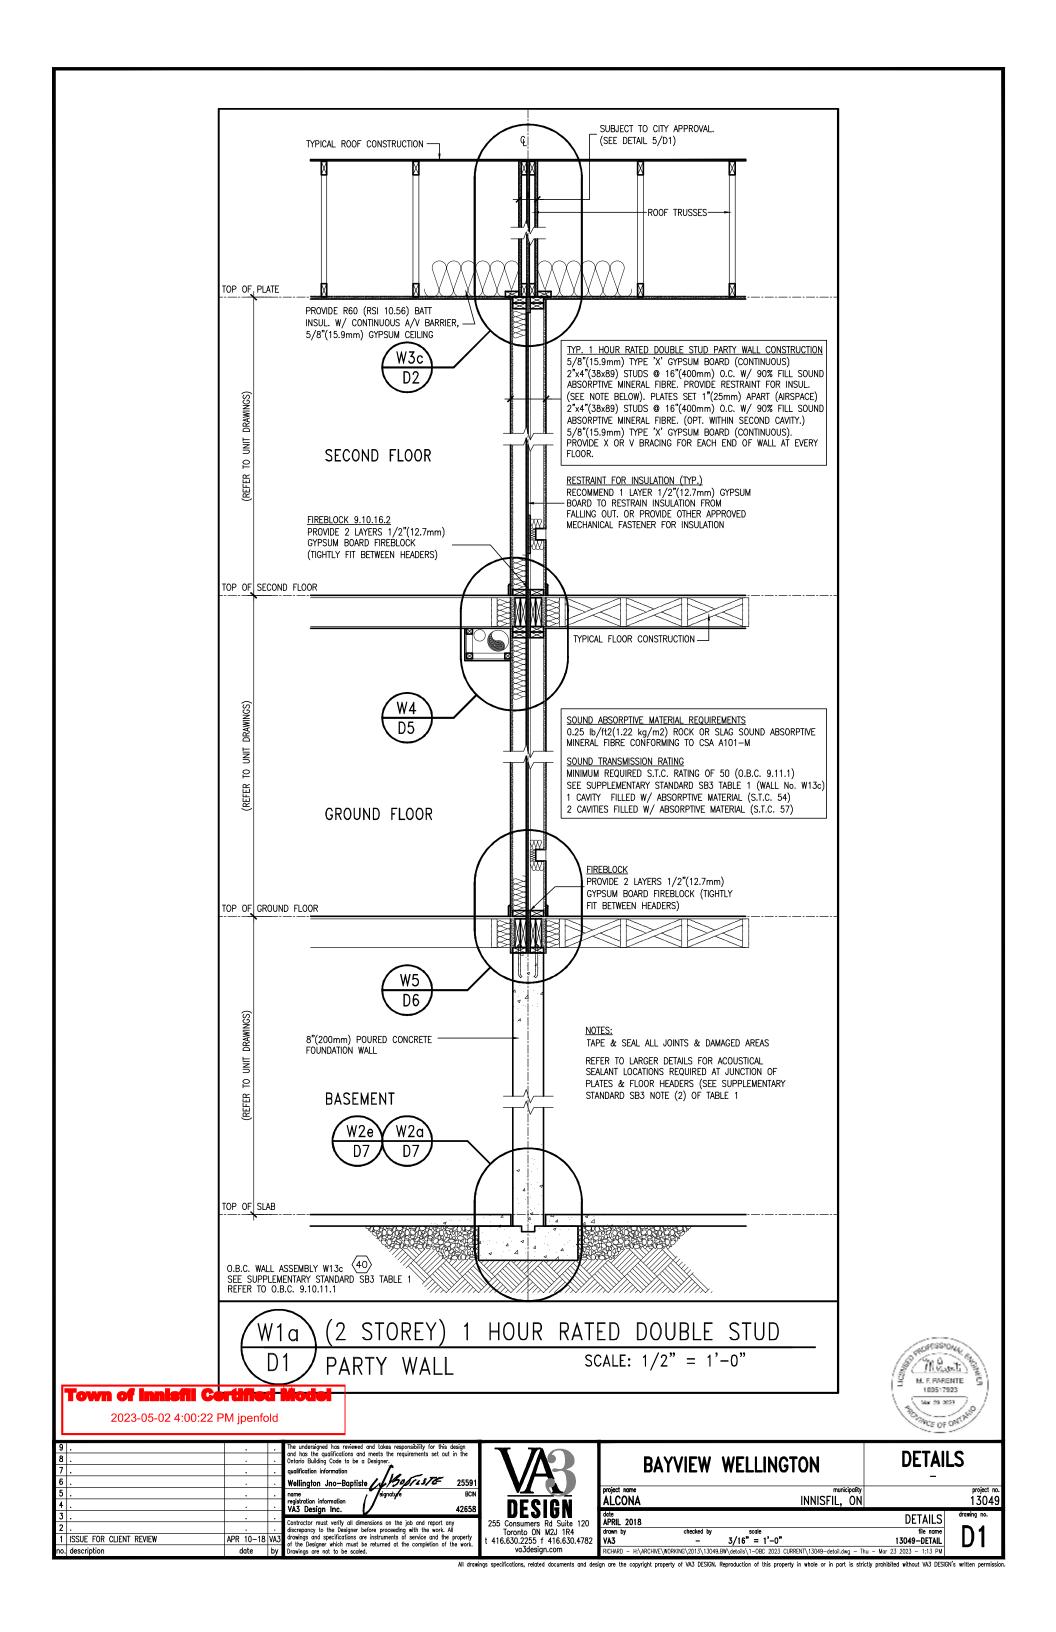

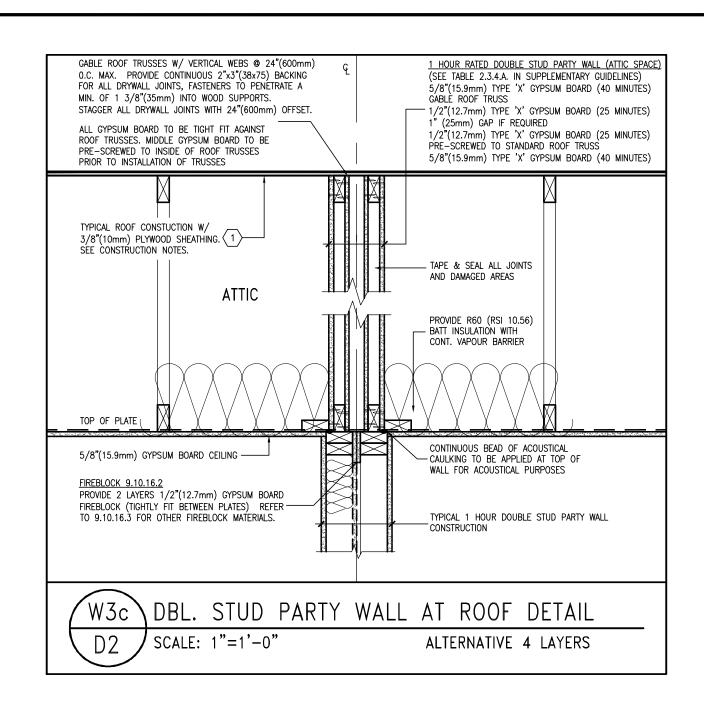




_				
9	•			The undersigned has reviewed and takes responsibility for this design
8				and has the qualifications and meets the requirements set out in the Ontario Building Code to be a Designer.
7				qualification information
6				Wellington Jno-Baptiste Whofist 25591
5	•			name , //signaty/e BCIN
4				registration information VA3 Design Inc. 42658
3				
2				Contractor must verify all dimensions on the job and report any discrepancy to the Designer before proceeding with the work. All
1	ISSUE FOR CLIENT REVIEW	APR 10-18	VA3	
	1 11	1.1	In	of the pesigner which must be returned at the completion of the work.



			1000	
BAY	VIEW	WELLINGTON	DETAI -	LS
project name ALCONA		municipality INNISFIL, ON		project no. 13049
date APRIL 2018			DETAILS	drawing no.
drawn by VA3	checked by	3/16" = 1'-0"	file name 13049—DETAIL	D2

M. E. PARENTE

Mar. 23, 2023

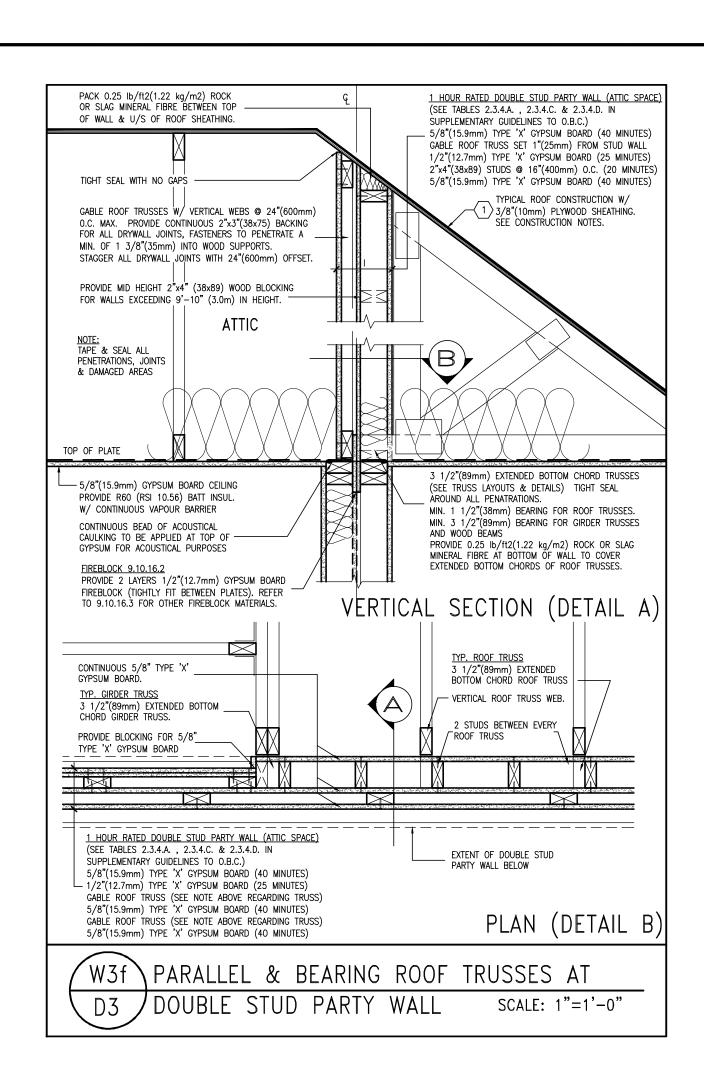

2023-05-02 4:00:34 PM jpenfold

•				
9				The undersigned has reviewed and takes responsibility for this design
8				and has the qualifications and meets the requirements set out in the Ontario Building Code to be a Designer.
7	•			qualification information
6				Wellington Jno-Baptiste Wellington Jno-Baptiste
5	•			name , //signature BCIN
4				registration information VA3 Design Inc. 42658
3	•			
2				Contractor must verify all dimensions on the job and report any discrepancy to the Designer before proceeding with the work. All
1	ISSUE FOR CLIENT REVIEW	APR 10-18	VA3	drawings and specifications are instruments of service and the property of the Designer which must be returned at the completion of the work.
nΛ	description	date	hv	Drawings are not to be coaled



	BAYVIEW	WELLINGTON	
ject name		municipality	
LCONA		INNISFIL, ON	
•	•		


 date APRIL 2018
 DETAILS

 drown by VA3
 - 3/16" = 1'-0"
 file name 13049-DETAIL

M. F. PARENTE 100517923

WCE OF ON

DETAILS

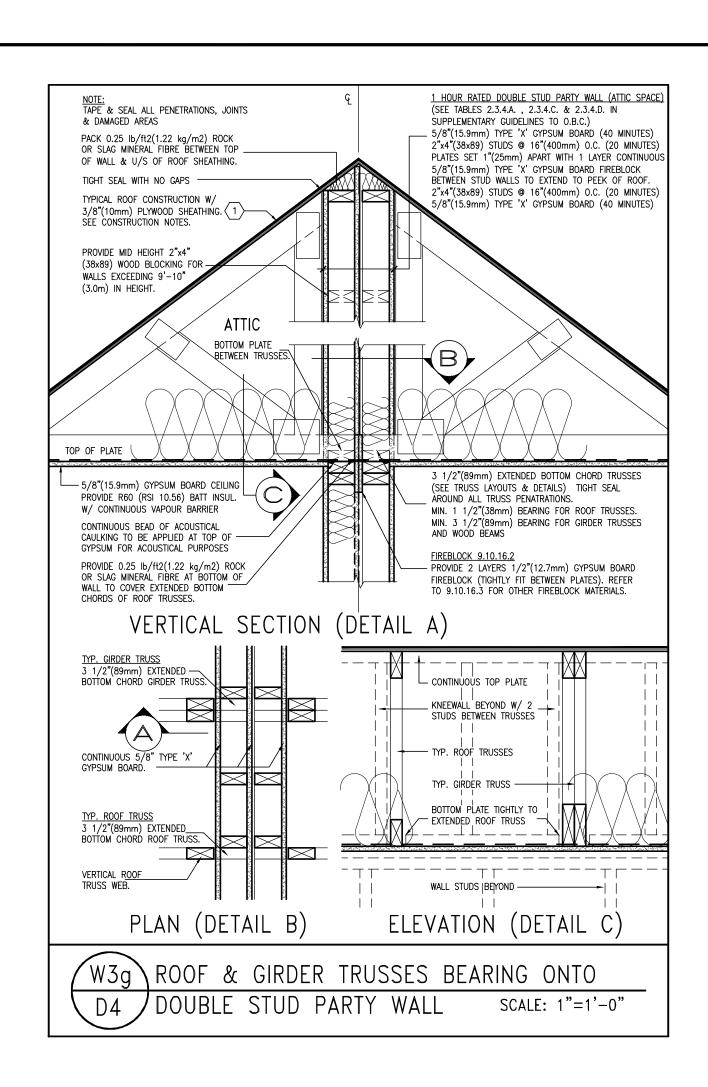

2023-05-02 4:00:34 PM jpenfold

-				
9				The undersigned has reviewed and takes responsibility for this design
8				and has the qualifications and meets the requirements set out in the Ontario Building Code to be a Designer.
7				qualification information
6				Wellington Jno-Baptiste Wysofics76 25591
5				name , signaty/e BCIN
9 8 7 6 5 4 3				registration information VA3 Design Inc. 42658
3	•			ottag
2				Contractor must verify all dimensions on the job and report any discrepancy to the Designer before proceeding with the work. All
1	ISSUE FOR CLIENT REVIEW	APR 10-18	VA3	
	description	data	hu	Describes are set to be seeled





		BAYVIEW	WELLINGTON	
ect	name			


DETAILS

M. F. PARENTE

Mar. 23, 2023

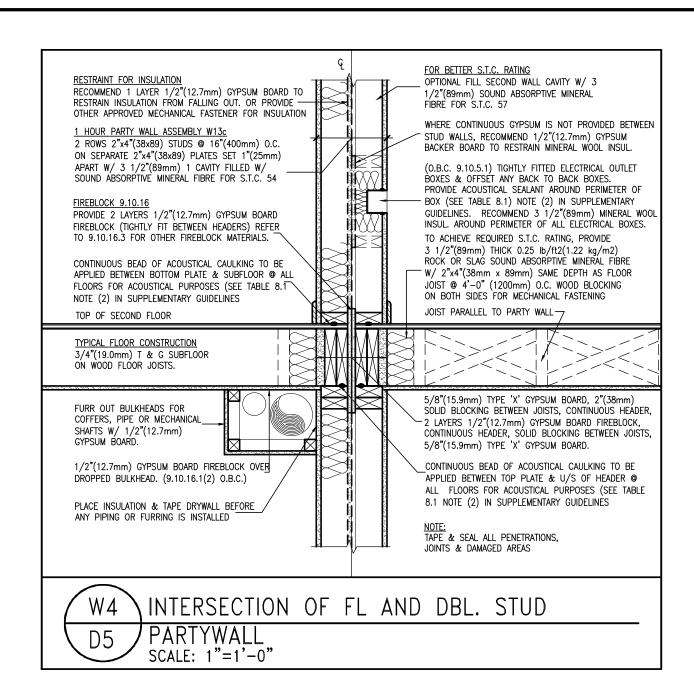

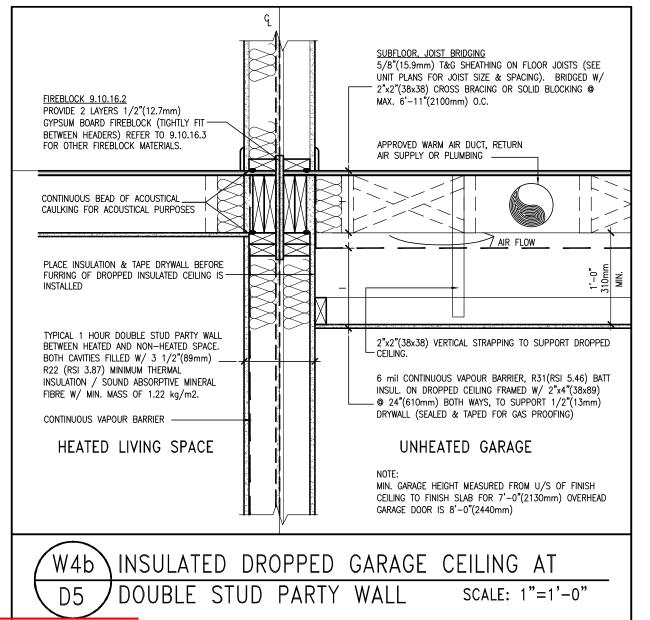

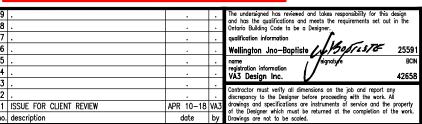



va3design.com

BAYVIEW WELLINGTON

DETAILS


POFESSION


Marente


100517923 Mar. 23, 2023

VICE OF CRUTE

ALCONA INNISFIL, ON 13049 APRIL 2018 **DETAILS D5** 3/16" = 1'-0" 13049-DETAIL

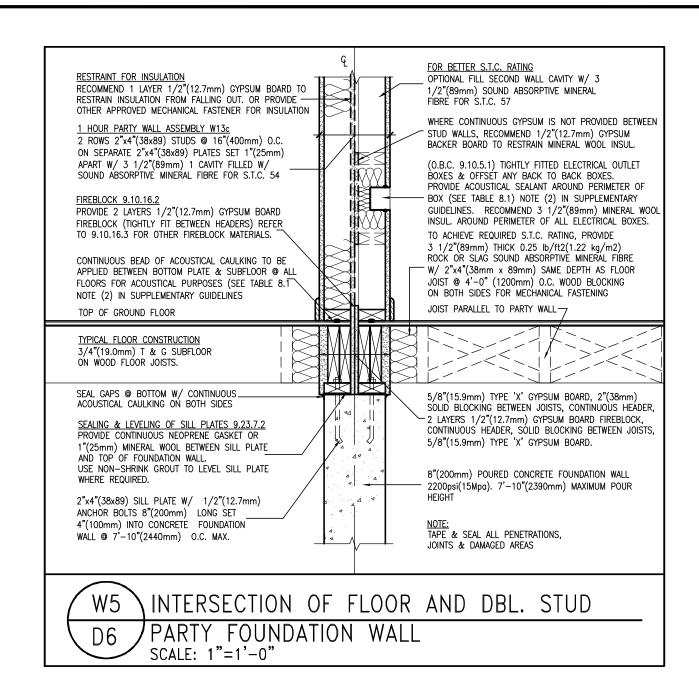

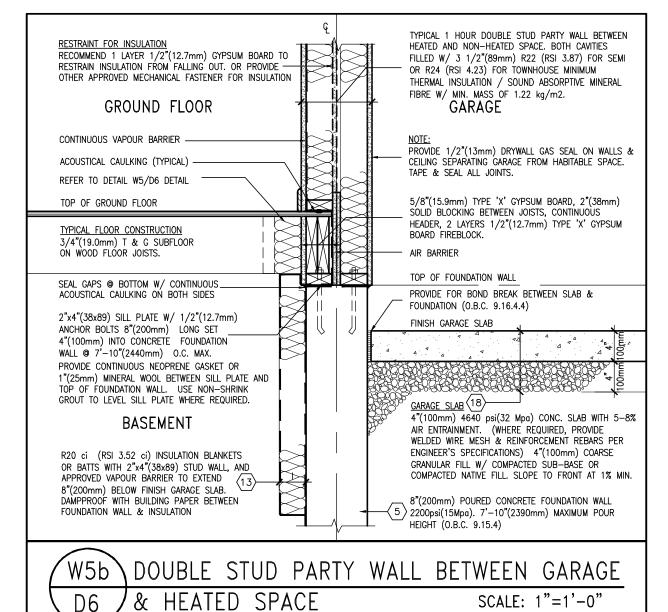

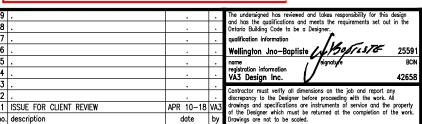



BAYVIEW WELLINGTON

DETAILS


ROFESSION


Marente

M. F. PARENTE 100517923

VCE OF CHI

ALCONA INNISFIL, ON 13049 date APRIL 2018 **DETAILS** 3/16" = 1'-0" **D6** 13049-DETAIL

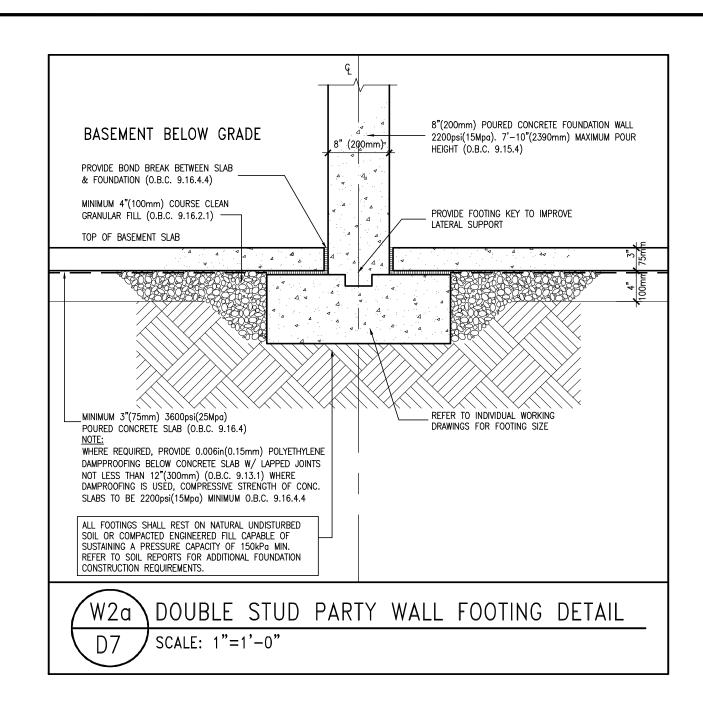

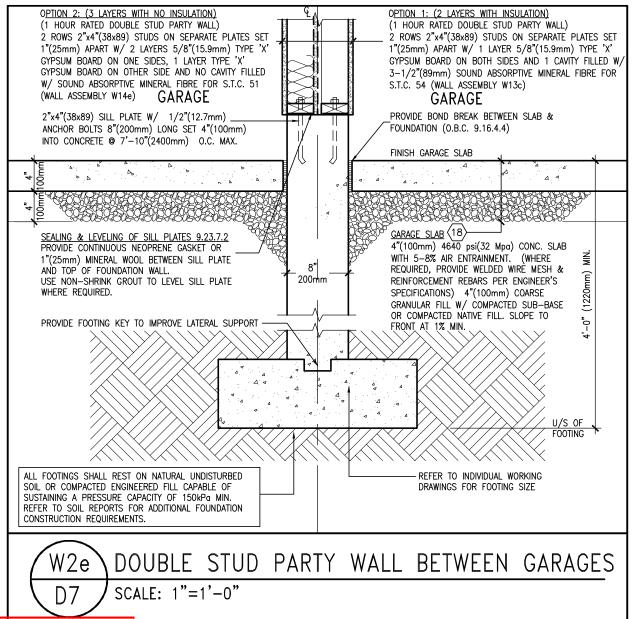

Town of Innisfii Certified Model

2023-05-02 4:00:35 PM jpenfold

9	•			The undersigned has reviewed and takes responsibility for this design
8				and has the qualifications and meets the requirements set out in the Ontario Building Code to be a Designer.
7				qualification information
6			٠	Wellington Jno-Baptiste Whofist 25591
5	•			name , //signaty/e BCIN
4				registration information VA3 Design Inc. 42658
3			•	ctag
2				Contractor must verify all dimensions on the job and report any discrepancy to the Designer before proceeding with the work. All
1	ISSUE FOR CLIENT REVIEW	APR 10-18	VA3	
	description	data	hu	Describes are set to be seeded




	BAYVIEW	WELLINGTON
name		n
		ILLU UOFII


DETAILS

13049

POFESSION

M. F. PARENTE 100517923 Mar. 23, 2023

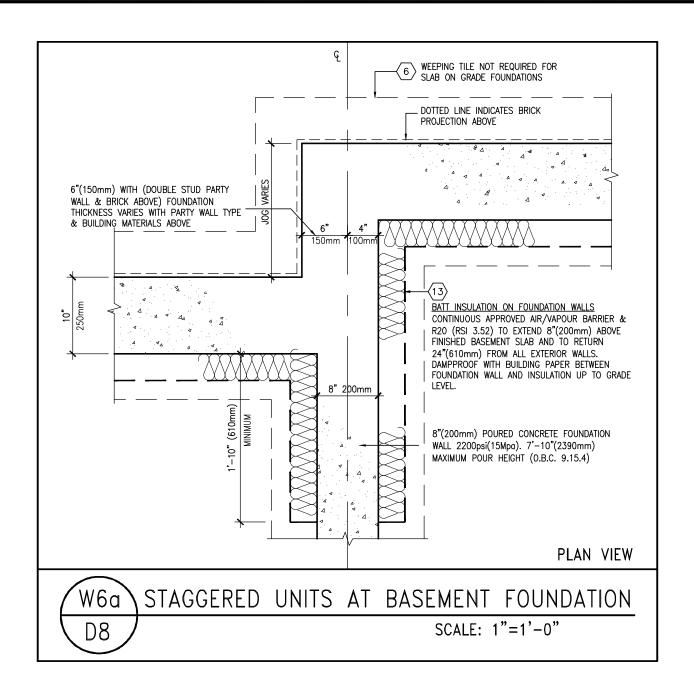

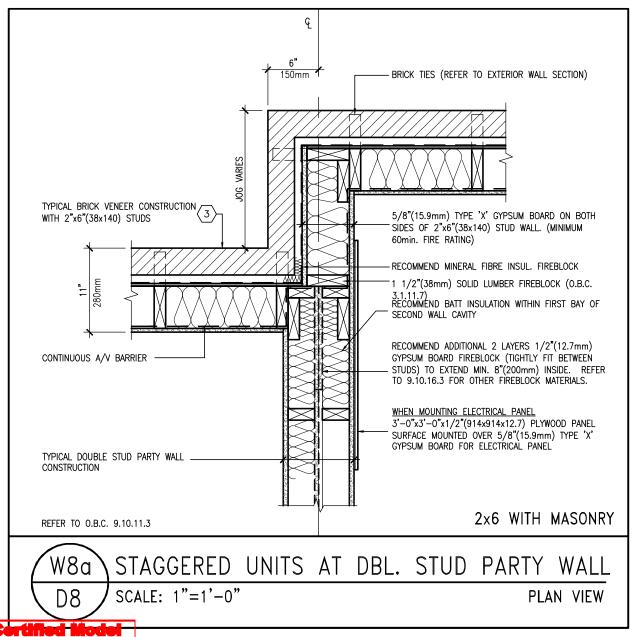

1 ISSUE FOR CLIENT REVIEW

registration information VA3 Design Inc.

APR 10-18 VA3

by

The undersigned has reviewed and takes responsibility for this design and has the qualifications and meets the requirements set out in the Ontario Building Code to be a Designer. 42658 Contractor must verify all dimensions on the job and report any discrepancy to the Designer before proceeding with the work. All drawings and specifications are instruments of service and the property of the Designer which must be returned at the completion of the work. Drawings are not to be scaled.



BAYVIEW WELLINGTON

DETAILS


POFESSION4


Marente 100517923 Mar. 23, 2023

VCE OF ON

ALCONA INNISFIL, ON 13049

date APRIL 2018 drawn by VA3 **DETAILS** 3/16" = 1'-0" **D8** 13049-DETAIL

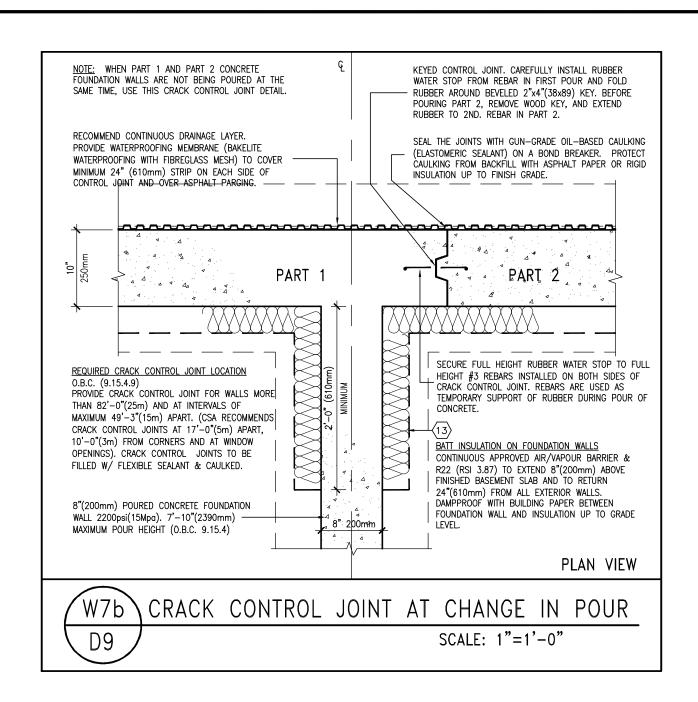

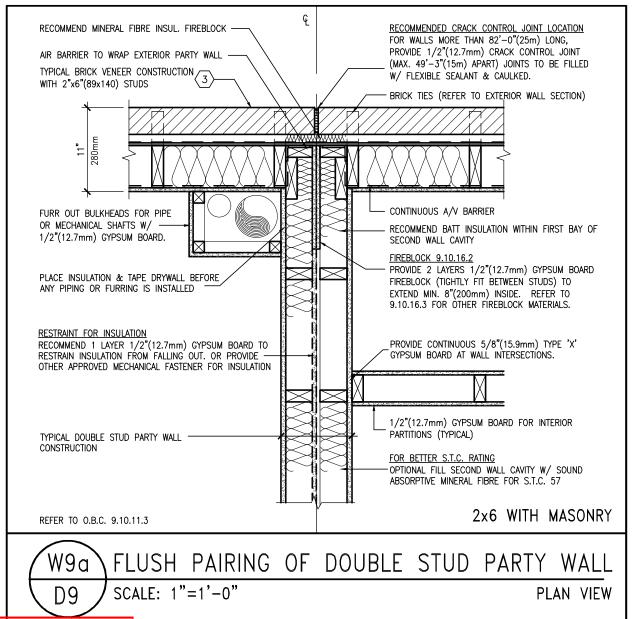

2023-05-02 4:00:35 PM jpenfold

-					
9				The undersigned has reviewed and takes responsibility for this design	ſ
8				and has the qualifications and meets the requirements set out in the Ontario Building Code to be a Designer.	l
7				qualification information	l
6				Wellington Jno-Baptiste Whofis 25591	ı
5				name , //signaty/e BCIN	ı
4				registration information VA3 Design Inc. 42658	ı
3			•		ı
2				Contractor must verify all dimensions on the job and report any discrepancy to the Designer before proceeding with the work. All	l
1	ISSUE FOR CLIENT REVIEW	APR 10-18	VA3	drawings and specifications are instruments of service and the property of the Designer which must be returned at the completion of the work.	ĺ
n۸	description	date	hv	Drawings are not to be esaled	ı



DETAILS


13049


D9

POFESSION


M. F. PARENTE 100517923

VCE OF CH

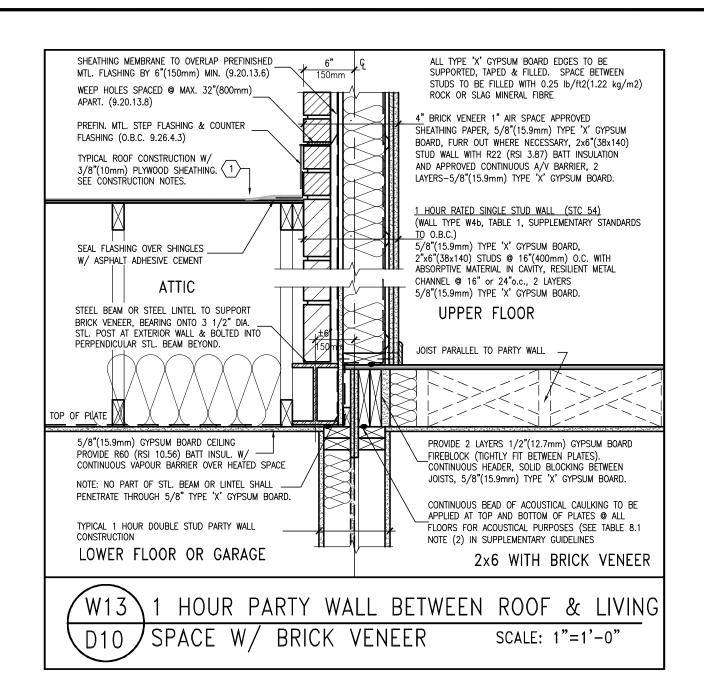

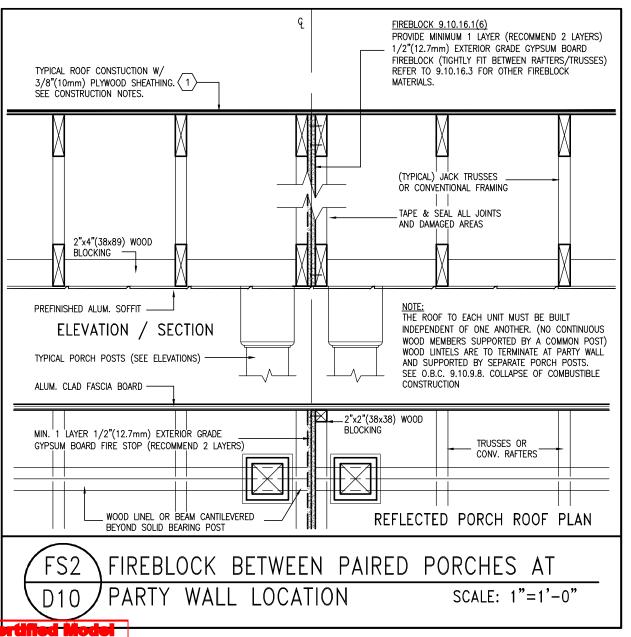



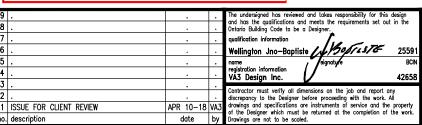




BAYVIEW WELLINGTON


DETAILS

ROFESSION


M. F. PARENTE 100517923

WCE OF CHI

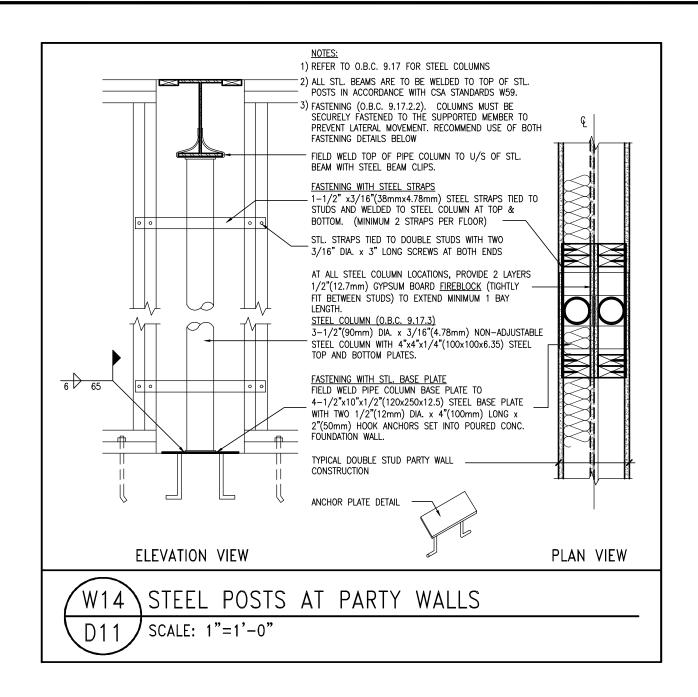

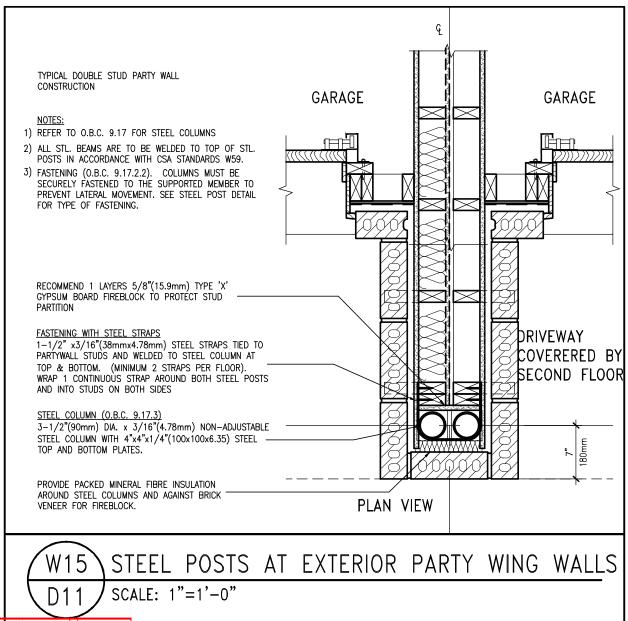

Town of Inniefii Certified Model2023-05-02 4:00:35 PM jpenfold

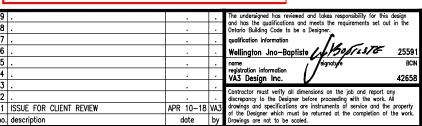





	BAYVIEW	D	LS			
project name ALCONA			municipality INNISFIL, ON			,
date APRIL 2018				Di	ETAILS	drawi
drawn by VA3	checked by	3/16" = 1'-0"		1304	file name 9-DETAIL	\mathbf{D}


POFESSION

M. F. PARENTE 100517923 Mar. 23, 2023

VCE OF CHIL

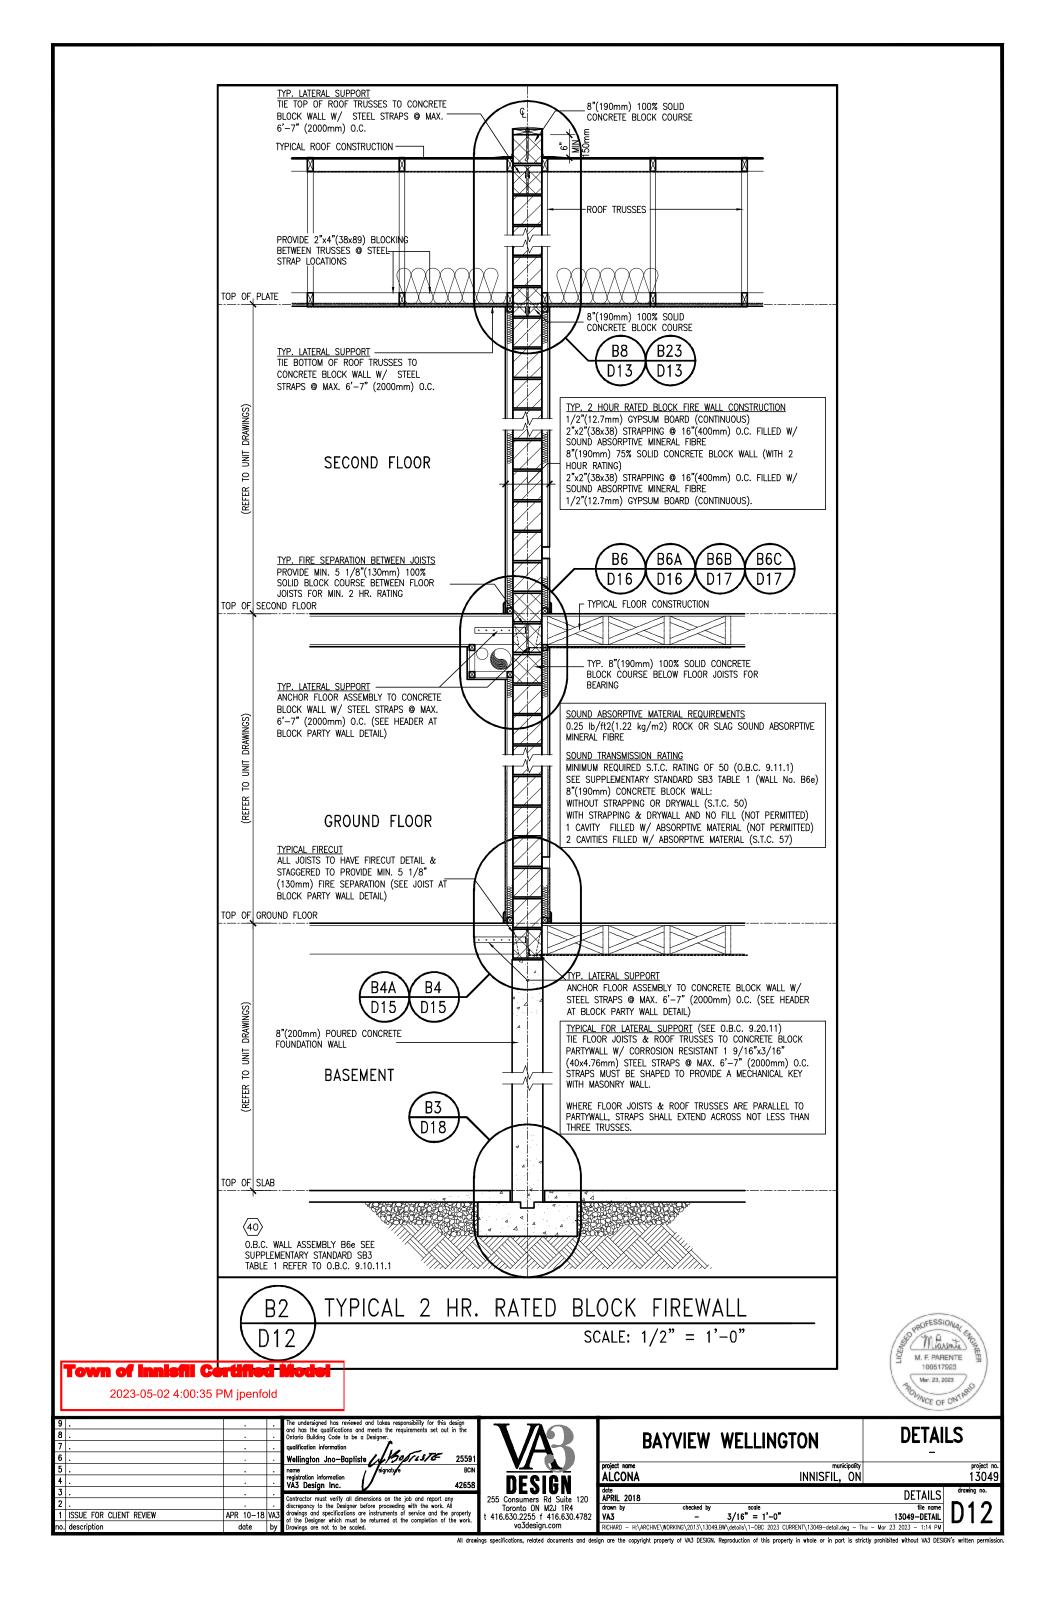

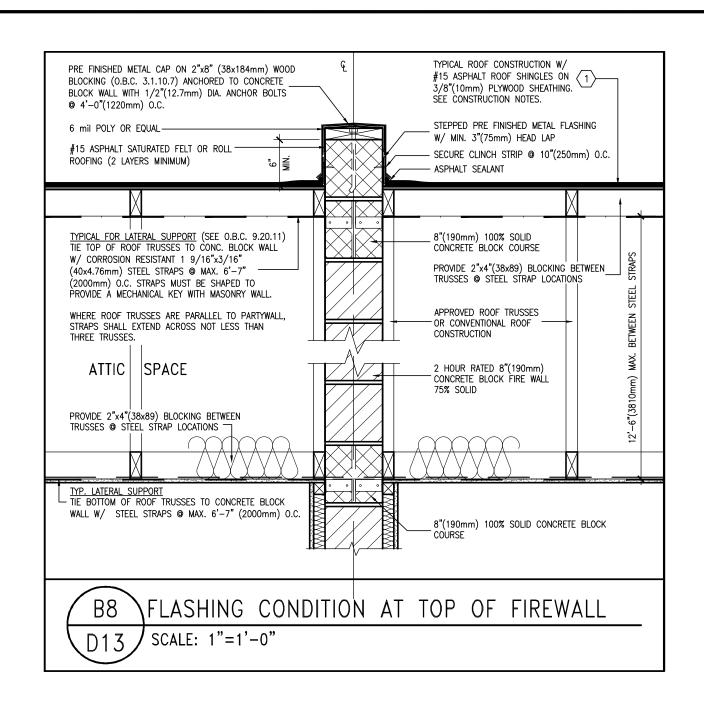

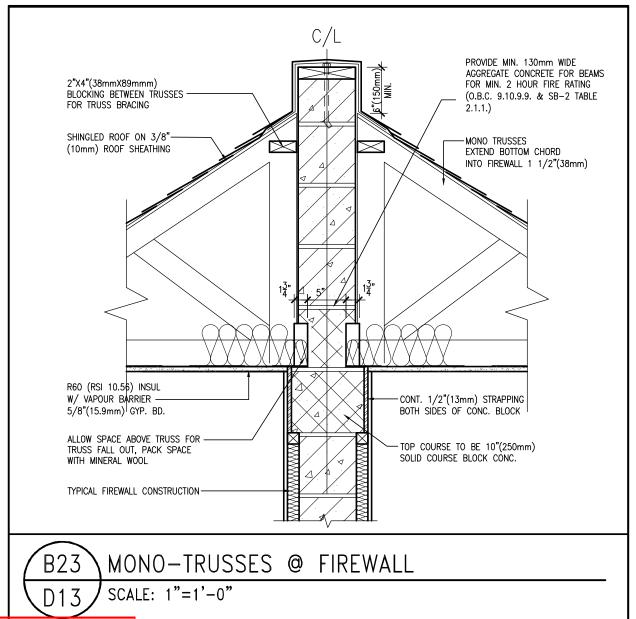

2023-05-02 4:00:35 PM jpenfold

•					
9				The undersigned has reviewed and takes responsibility for this design	Г
8				and has the qualifications and meets the requirements set out in the Ontario Building Code to be a Designer.	ı
7				qualification information	ı
6				Wellington Jno-Baptiste Wisson 25591	ı
5	•			name , signature boin	ı
4				registration information VA3 Design Inc. 42658	ı
3	•		•		ı
2	•			Contractor must verify all dimensions on the job and report any discrepancy to the Designer before proceeding with the work. All	ı
1	ISSUE FOR CLIENT REVIEW	APR 10-18	VA3	drawings and specifications are instruments of service and the property of the Designer which must be returned at the completion of the work.	t
nΛ	description	date	hv	Drawings are not to be escaled	1




BAYVIEW	WELLINGTON	


DETAILS

ROFESSION


M. F. PARENTE 100517923 Mar. 23, 2023

				_	
project name			municipality		project
ALCONA			INNISFIL, ON		130
date APRIL 2018				DETAILS	drawing no.
drawn by	checked by	scale		file name	
VA3	-	3/16" = 1'-0"		13049-DETAIL	$\Box D \Box \omega$

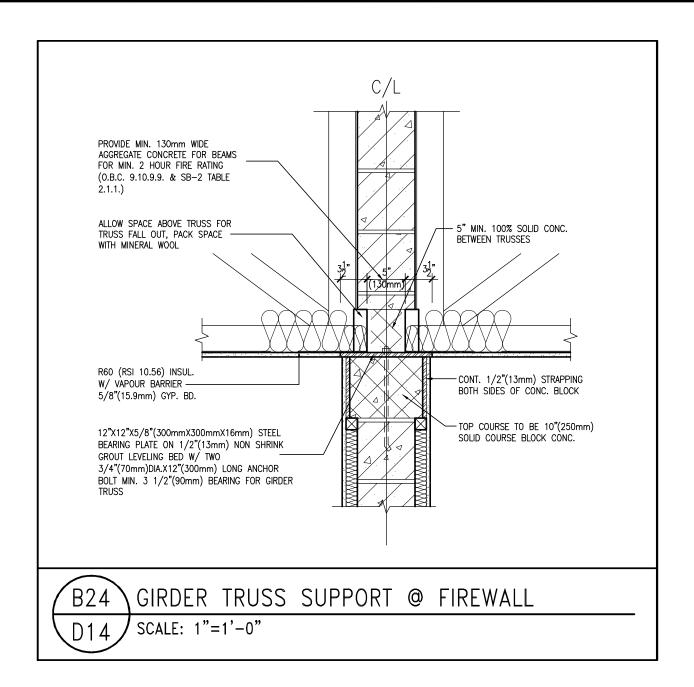

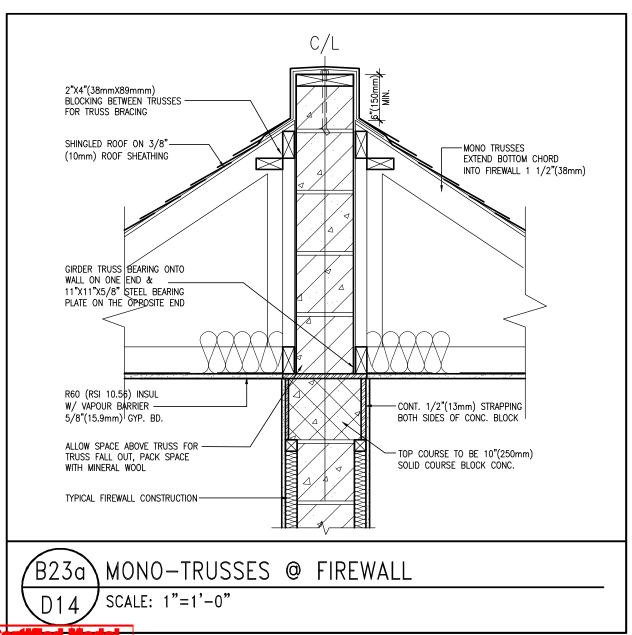

2023-05-02 4:00:36 PM jpenfold

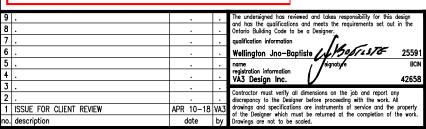



BAYVIEW	WELLINGTON

DETAILS


POFESSION


M. F. PARIENTE 100517923 Mar. 23, 2023

VCE OF CHI

13049

| DETAILS | Town by | Checked by | YA3 | - 3/16" = 1'-0" | 13049-DETAIL | |

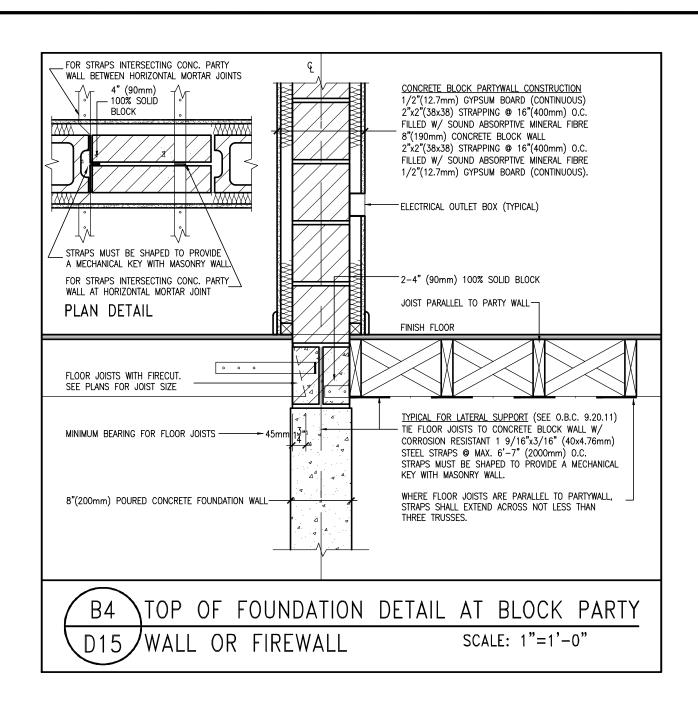

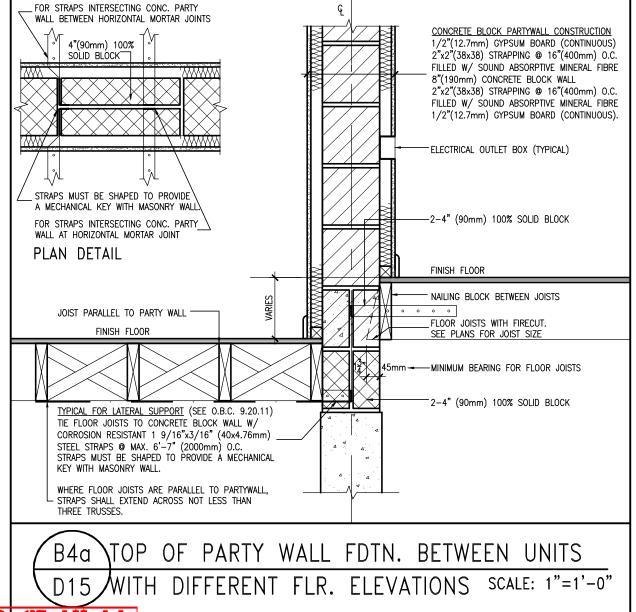

-0"
M. F. PARENTE
100517923
Mar. 23, 2803

ACTESSION .


Town of Innistil Certification


2023-05-02 4:00:36 PM jpenfold

9	•			The undersigned has reviewed and takes responsibility for this design
8	•			and has the qualifications and meets the requirements set out in the Ontario Building Code to be a Designer.
7	•			qualification information
6	•			Wellington Jno-Baptiste Whofis 25591
5	•			name , /signaty/e BCIN
4	•			registration information VA3 Design Inc. 42658
3				
2				Contractor must verify all dimensions on the job and report any discrepancy to the Designer before proceeding with the work. All
1	ISSUE FOR CLIENT REVIEW	APR 10-18	VA3	
no.	description	date	by	Drawings are not to be scaled.



	BAYVIEW	DETAI -	LS		
project name			municipality		project no.
<u>ALCONA</u>			INNISFIL, ON		13049
iate APRIL 2018	}			DETAILS	drawing no.
irawn by	checked by	scale		file name	D1 E
/A3	_ `	3/16" = 1'-0"		13049_DETAIL	11111

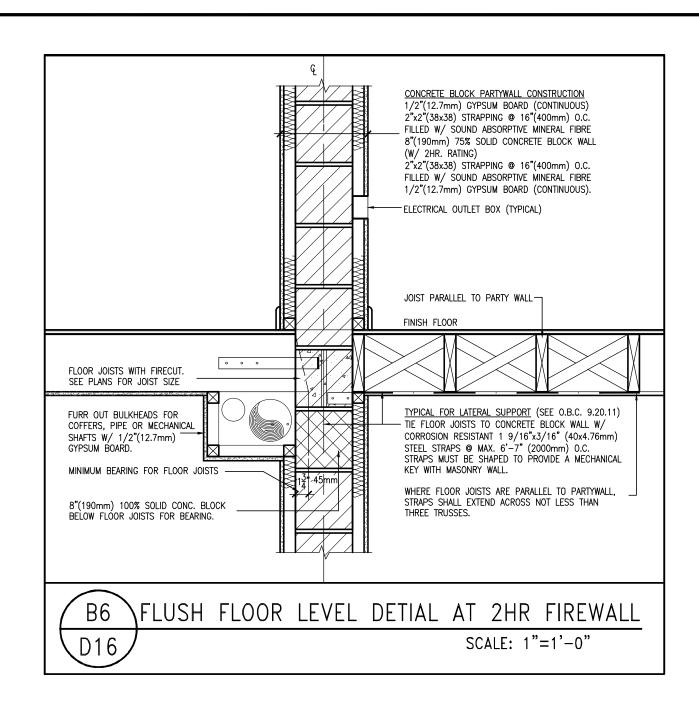

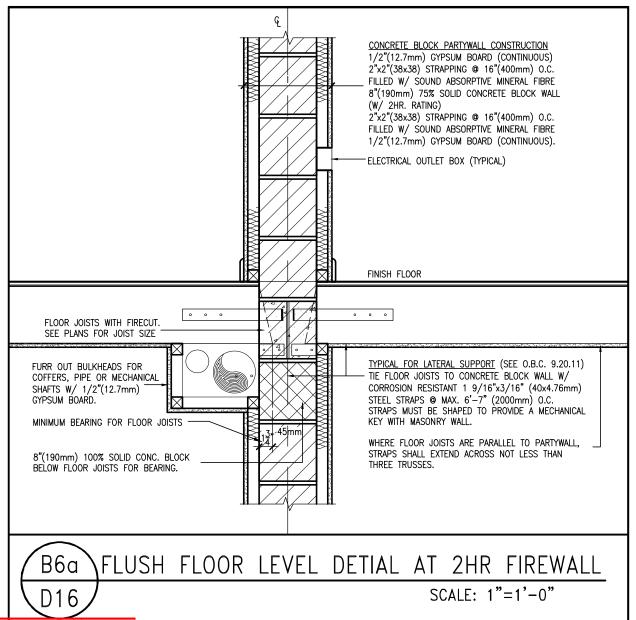

L				
9	•			The undersigned has reviewed and takes responsibility for this design
8	•			and has the qualifications and meets the requirements set out in the Ontario Building Code to be a Designer.
7				qualification information
6	•			Wellington Jno-Baptiste WBoff2376 25591
5	•			ndrie , ragnature boin
4	•			registration information VA3 Design Inc. 42658
3	•			· · ·
2	•			Contractor must verify all dimensions on the job and report any discrepancy to the Designer before proceeding with the work. All
1	ISSUE FOR CLIENT REVIEW	APR 10-18	VA3	drawings and specifications are instruments of service and the property of the Designer which must be returned at the completion of the work.
no.	description	date	by	Drawings are not to be scaled.



DETAILS


ROFESSION


Marente

100517923 Mar. 23, 2023

VCE OF ON

ALCONA INNISFIL, ON 13049 APRIL 2018 drawn by VA3 **DETAILS** 3/16" = 1'-0" **D16** 13049-DETAIL

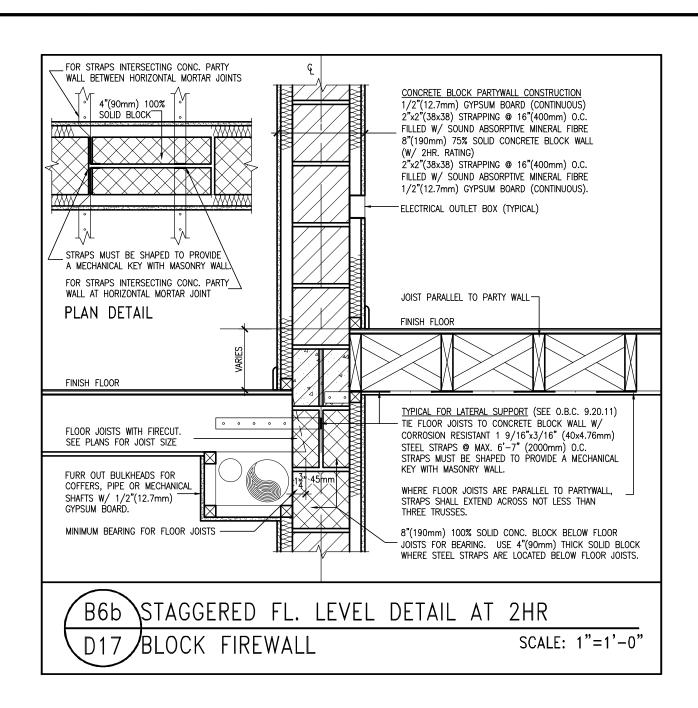

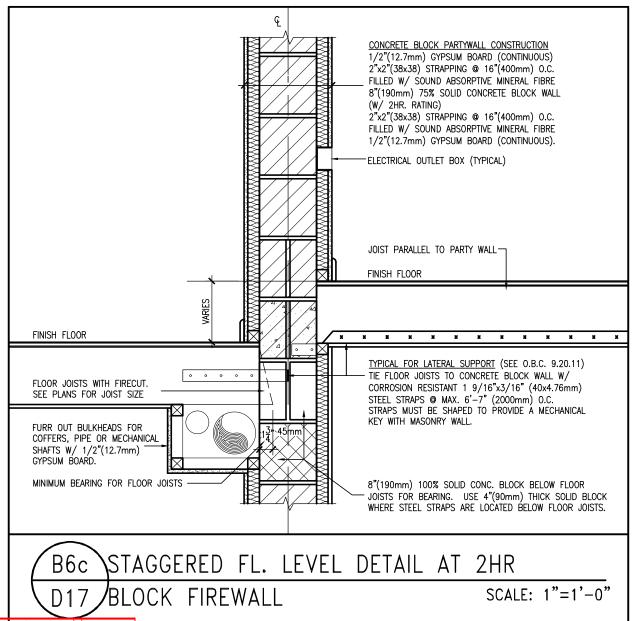

•				
9				The undersigned has reviewed and takes responsibility for this design
8				and has the qualifications and meets the requirements set out in the Ontario Building Code to be a Designer.
7				qualification information
6				Wellington Jno-Baptiste (1805/12376 25591
5				name , signature BCIN
4				registration information VA3 Design Inc. 42658
3				· · ·
2				Contractor must verify all dimensions on the job and report any discrepancy to the Designer before proceeding with the work. All
1	ISSUE FOR CLIENT REVIEW	APR 10-18	VA3	drawings and specifications are instruments of service and the property of the Designer which must be returned at the completion of the work.
nΛ	description	date	hv	Drawings are not to be scaled



BAYVIEW	WELLINGTON
---------	------------


DETAILS


POFESSION

Marente 100517923 Mar. 23, 2023

VICE OF CH

ALCONA INNISFIL, ON 13049 date APRIL 2018 **DETAILS** 3/16" = 1'-0" 13049-DETAIL

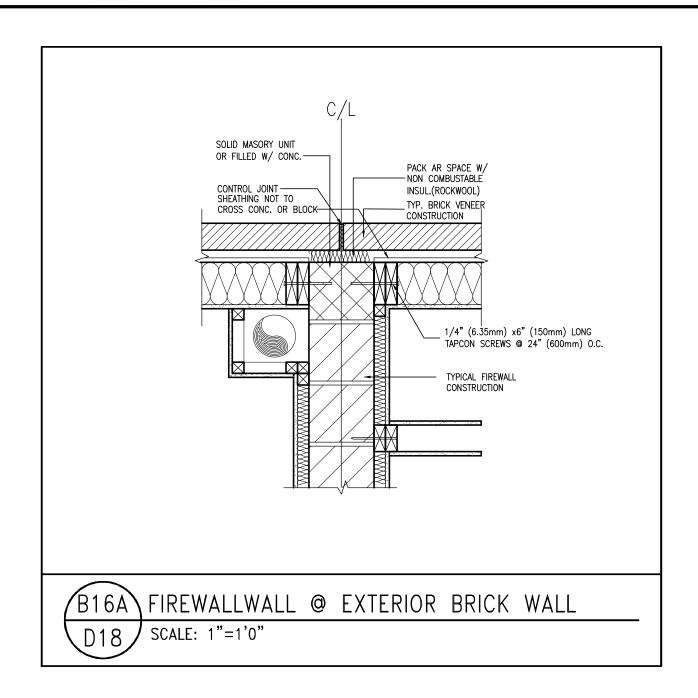

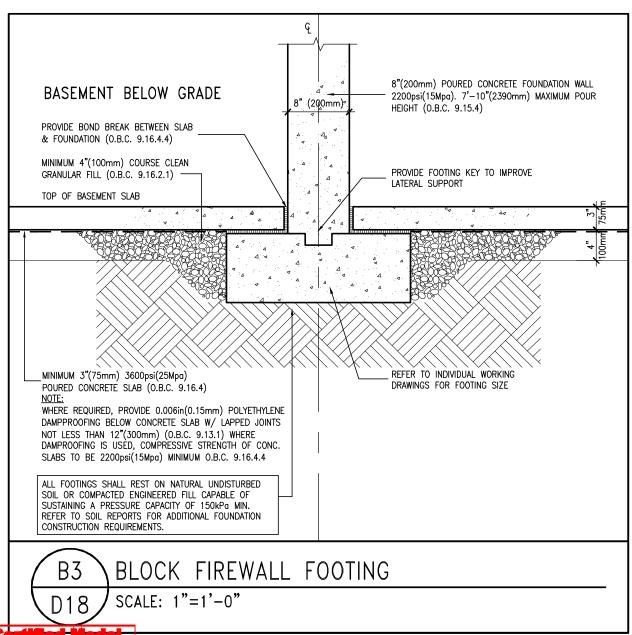

description

The undersigned has reviewed and takes responsibility for this design and has the qualifications and meets the requirements set out in the Ontario Building Code to be a Designer. qualification information

Wellington Jno-Baptiste () Soft 2576 25591 BCIN registration information VA3 Design Inc. 42658 Contractor must verify all dimensions on the job and report any discrepancy to the Designer before proceeding with the work. All drawings and specifications are instruments of service and the property of the Designer which must be returned at the completion of the work. Drawings are not to be scaled. 1 ISSUE FOR CLIENT REVIEW APR 10-18 VA3

date by




DETAILS

PROFESSIONA

Marente M. F. PARENTE 100517923

NCE OF ONTE

ALCONA INNISFIL, ON 13049 date APRIL 2018 **DETAILS** D18 3/16" = 1'-0" 13049-DETAIL

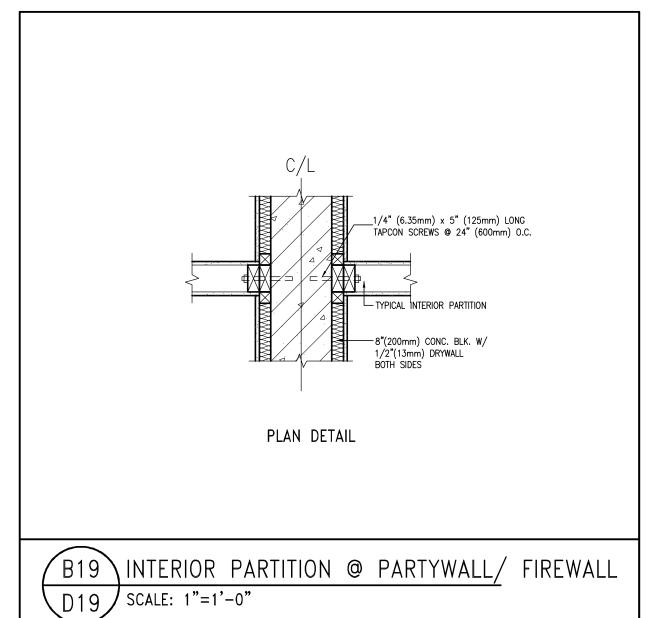




_				
9				The undersigned has reviewed and takes responsibility for this design
8				and has the qualifications and meets the requirements set out in the Ontario Building Code to be a Designer.
7				qualification information
9 8 7 6 5			Γ.	Wellington Jno-Baptiste / 150572576 25591
5				name signature BCIN
4			Γ.	registration information VA3 Design Inc. 42658
3				<u> </u>
2				Contractor must verify all dimensions on the job and report any discrepancy to the Designer before proceeding with the work. All
П	ISSUE FOR CLIENT REVIEW	APR 10-18	VA3	
			1	of the besigner which must be returned at the completion of the work.

\mathbb{W}_3
DESIGN
255 Consumers Rd Suite 120
Toronto ON M2J 1R4
t 416.630.2255 f 416.630.4782
va3desian.com

_	BAYVIEW	DETAI	LS		
project name ALCONA			municipality INNISFIL, ON		project no. 13049
date APRIL 2018				DETAILS	drawing no.
drawn by VA3	checked by	3/16" = 1'-0"		file name 13049—DETAIL	D19

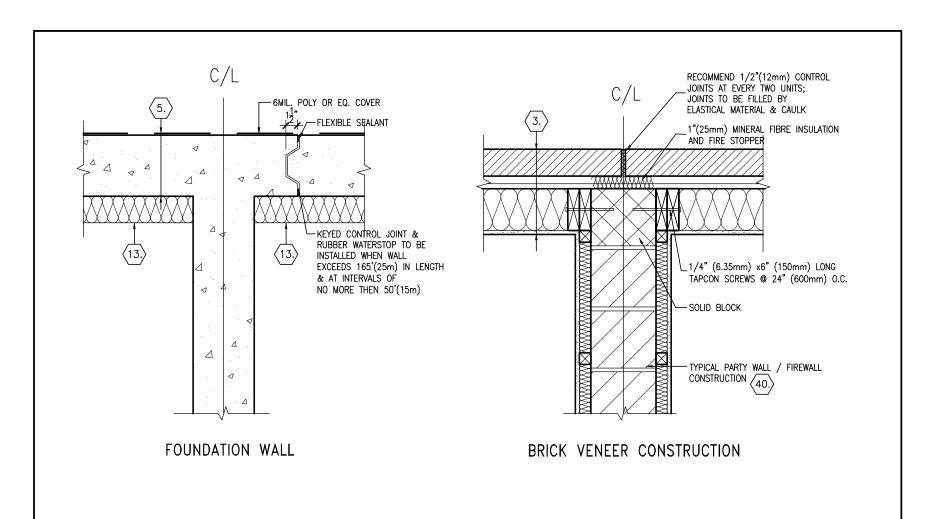


 $\frac{\text{B17}}{\text{D20}}$

STRAIGHT UNITS WALL DETAIL (PLAN)

SCALE: 1"=1'-0"



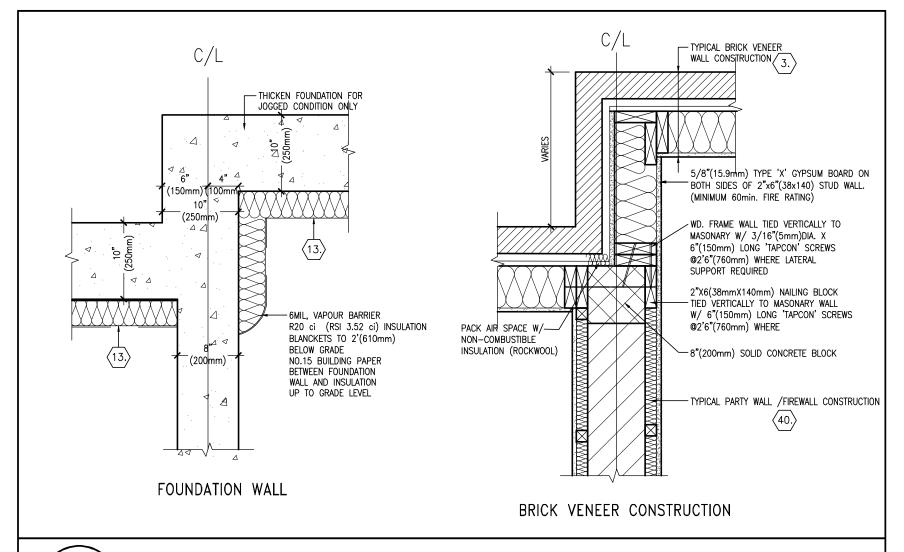


B18 STAGGERED UNIT WALL DETAIL AT PARTYWALL / FIREWALL (PLAN)


D20 / SCALE: 1"=1'-0"

Town of Innisfii Certified Model

2023-05-02 4:00:36 PM jpenfold

8 . 7 . 6 .	 and has the qualifications and meets the requirements set out in the Ontario Building Code to be a Designer. qualification information Wellington Jno-Baptiste		BAYVIEW WELLINGTON	DETAILS -
5 . 4 .	 name signatuye BCN registration information VA3 Design Inc. 42658	DEGLON	project nome municipality ALCONA INNISFIL, ON	13049
3 . 2 . 1 ISSUE FOR CLIENT REVIEW no. description	 Contractor must verify all dimensions on the job and report any discrepancy to the Designer before proceeding with the work. All 3d drawings and specifications are instruments of service and the property of the Designer which must be returned at the completion of the work. 9 Drawings are not to be scaled.	255 Consumers Rd Suite 120 Toronto ON M2J 1R4 t 416.630.2255 f 416.630.4782 va3design.com	date APRIL 2018	DETAILS file name 13049-DETAIL Thu - Mar 23 2023 - 1:14 PM

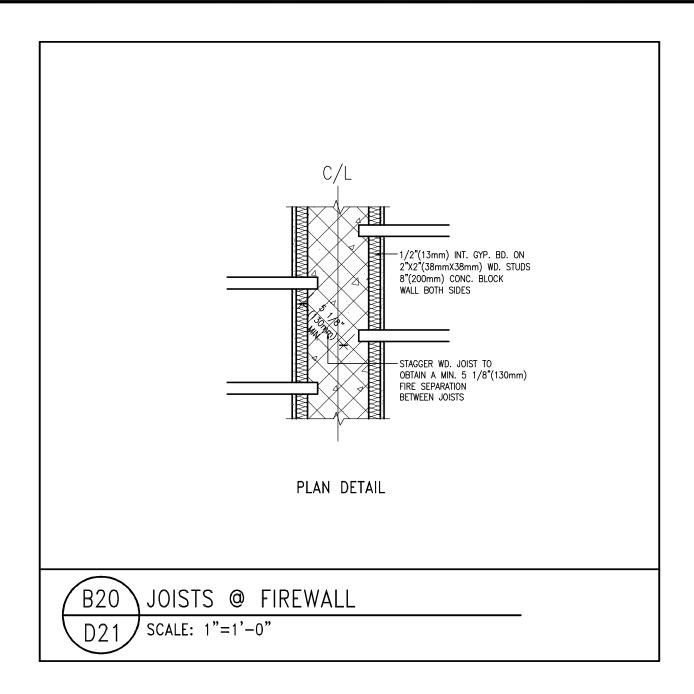

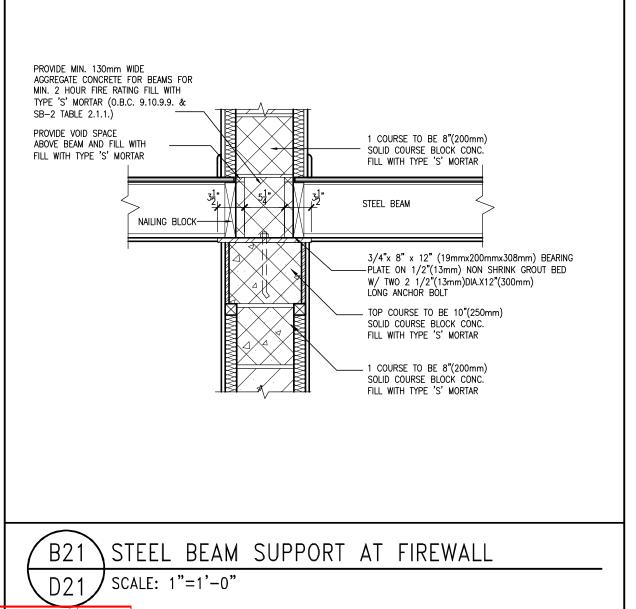




Town of innisfii Certified Model

2023-05-02 4:00:36 PM jpenfold

_				
9				The undersigned has reviewed and takes responsibility for this design
8	•			and has the qualifications and meets the requirements set out in the Ontario Building Code to be a Designer.
7	•			qualification information
6				Wellington Jno-Baptiste Wysofics 25591
5				name , signaty/e BCIN
9 8 7 6 5 4 3	•			registration information VA3 Design Inc. 42658
3	•			,
2	•			Contractor must verify all dimensions on the job and report any discrepancy to the Designer before proceeding with the work. All
1	ISSUE FOR CLIENT REVIEW	APR 10-18	VA3	drawings and specifications are instruments of service and the property of the Designer which must be returned at the completion of the work.
	dan adalah	4-4-	h	of the besigner which must be returned at the completion of the work.



_					
BA	YVIEW	DETAI	LS		
project name ALCONA			municipality INNISFIL, ON		project no. 13049
APRIL 2018 drawn by	checked by	scale		DETAILS file name	drawing no.

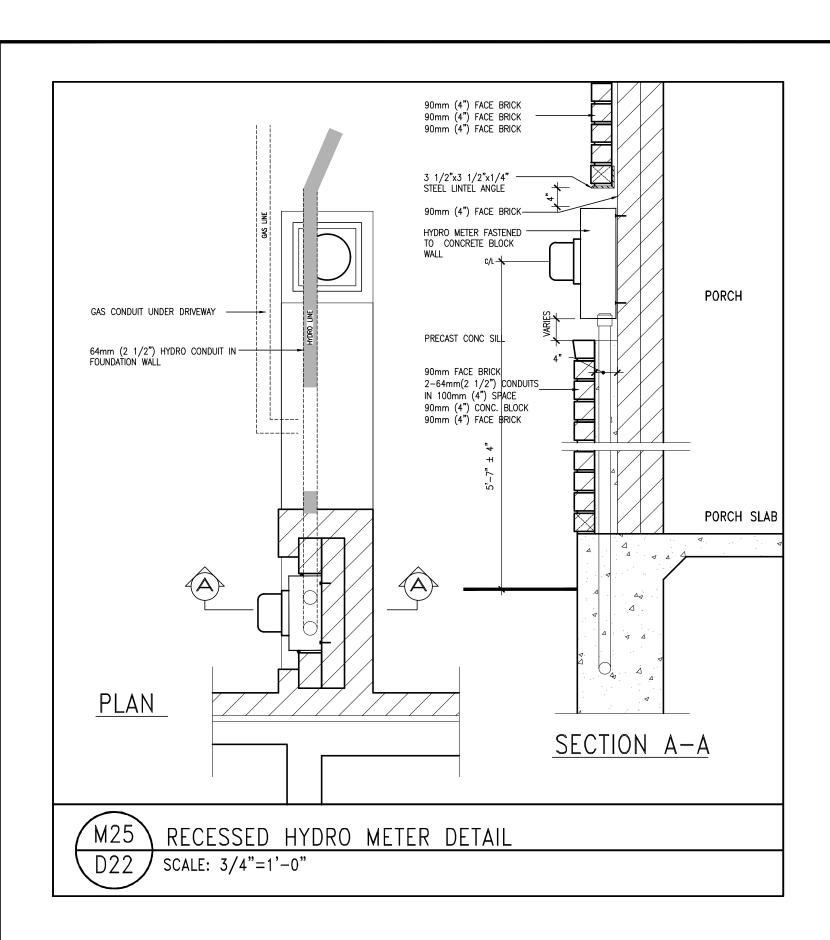



•			The undersigned has reviewed and takes responsibility for this design and has the qualifications and meets the requirements set out in the
			Ontario Building Code to be a Designer.
•			qualification information
•			Wellington Jno-Baptiste Chapter 25591
•			name , //signature BCIN
•			registration information VA3 Design Inc. 42658
		. :	•
>			Contractor must verify all dimensions on the job and report any discrepancy to the Designer before proceeding with the work. All
SSUE FOR CLIENT REVIEW	APR 10-18	VA3	drawings and specifications are instruments of service and the property of the Designer which must be returned at the completion of the work.
description	date	by	Drawings are not to be scaled.




BAYVIEW	WELLINGTON
name	municipality
ONA	INNISFIL, ON

M. F. PARENTE 100517923 NCE OF ON

PROFESSION

DETAILS project no. 13049 APRIL 2018 drawn by VA3 DETAILS scale
3/16" = 1'-0"
(\details\1-0BC 2023 CURRENT\13049

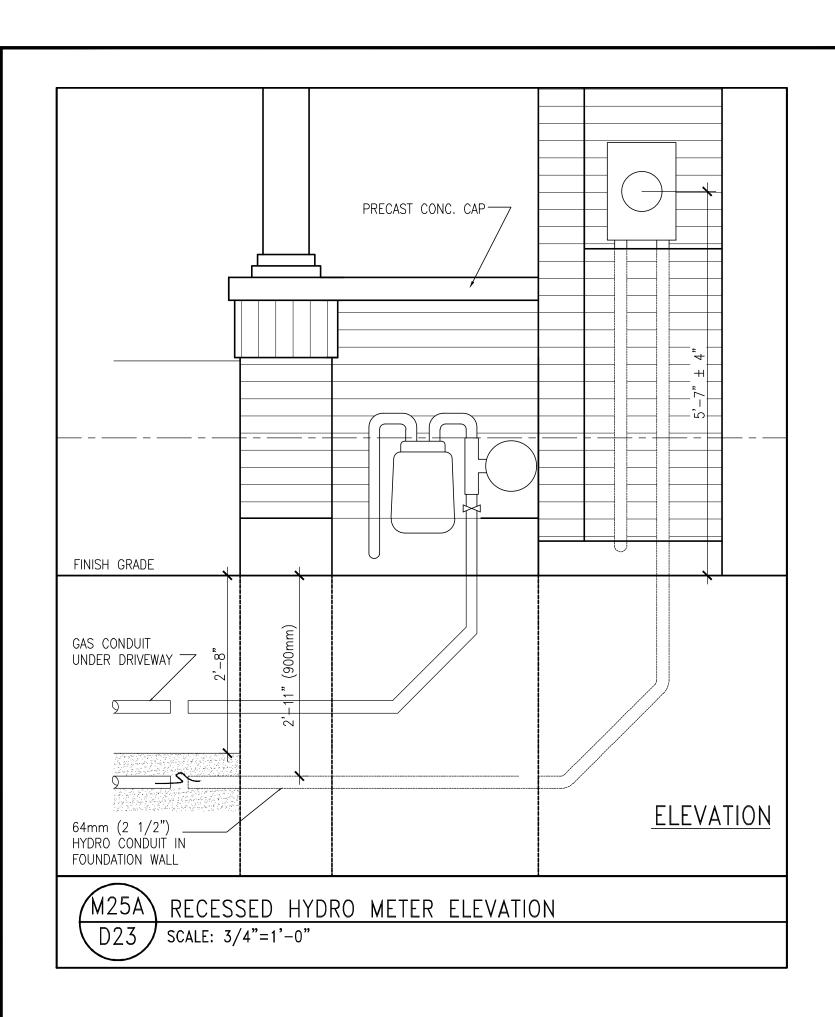



L				
			_	
g,				The undersigned has reviewed and takes responsibility for this design
8				and has the qualifications and meets the requirements set out in the Ontario Building Code to be a Designer.
7				qualification information
6				Wellington Jno-Baptiste Whofist 25591
5				name , //signaty/e BCIN
4				registration information VA3 Design Inc. 42658
3	•		•	
2	•			Contractor must verify all dimensions on the job and report any discrepancy to the Designer before proceeding with the work. All
1	ISSUE FOR CLIENT REVIEW	APR 10-18	VA3	drawings and specifications are instruments of service and the property of the Designer which must be returned at the completion of the work.
no.	description	date	by	Drawings are not to be scaled.



	BAYVIEW	WELLINGTON	_
name		municipality	_
ONA		INNISFIL. ON	

MINCE OF ONTE **DETAILS**


PROFESSIONA

M. F. PARENTE 100517923

Mar. 23, 2023

project r project no. 13049 APRIL 2018 drawn by VA3 DETAILS scale
3/16" = 1'-0"

N\details\1-OBC 2023 CURRENT\13049 file name 1 3049 – DETAIL - Mar 23 2023 – 1:15 PM

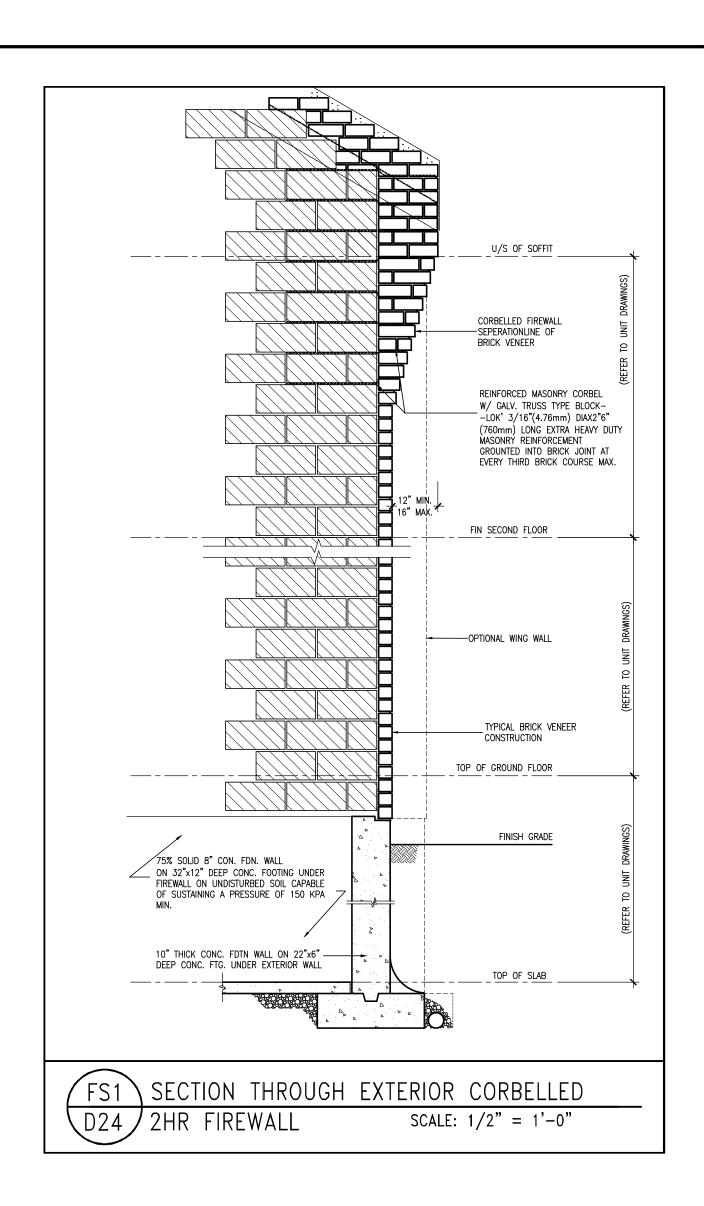

Town of innisfii Certified i

2023-05-02 4:00:37 PM jpenfold

_				
9				The undersigned has reviewed and takes responsibility for this design
8				and has the qualifications and meets the requirements set out in the Ontario Building Code to be a Designer.
7				qualification information
6				Wellington Jno-Baptiste WSOF12576 25591
5				name , / signature BCIN
4			•	registration information VA3 Design Inc. 42658
3				
2				Contractor must verify all dimensions on the job and report any discrepancy to the Designer before proceeding with the work. All
1	ISSUE FOR CLIENT REVIEW	APR 10-18	VA3	
5	description	data	hu	Describes are set to be seeded



	BAYVIEW	WELLINGTON
name		אוווווווווווווווווווווווווווווווווווווו

DETAILS

13049


OROFESSION4

M. F. PARENTE 100517923

Mar. 23, 2023 MCE OF CAN'S

project name ALCONA INNISFIL, ON

APRIL 2018 drawn by VA3 DETAILS scale
3/16" = 1'-0"
(\details\1-0BC 2023 CURRENT\13049-detail.du file name 13049-DETAIL

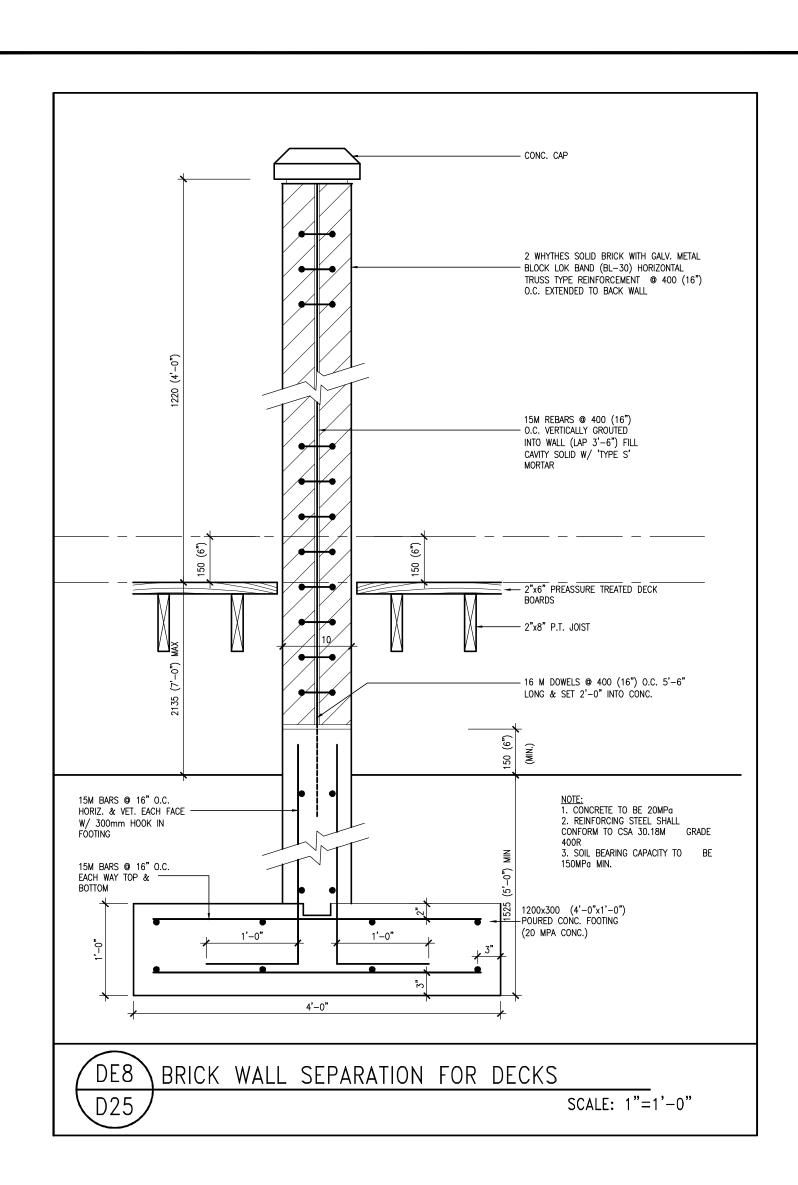

-				
9				The undersigned has reviewed and takes responsibility for this design
8				and has the qualifications and meets the requirements set out in the Ontario Building Code to be a Designer.
7				qualification information
6				Wellington Jno-Baptiste Wysofics76 25591
5				name , signaty/e BCIN
9 8 7 6 5 4 3				registration information VA3 Design Inc. 42658
3	•			ottag
2				Contractor must verify all dimensions on the job and report any discrepancy to the Designer before proceeding with the work. All
1	ISSUE FOR CLIENT REVIEW	APR 10-18	VA3	
	description	data	hu	Describes are set to be seeled




	BAYVIEW	WELLINGTON
t name		mun
$^{\circ}$		INNISTII


DETAILS


M. F. PARENTE 100517923

nunicipality _, ON project no. 13049 date APRIL 2018 drawn by DETAILS drawing no.

property the work.	t 416.630.2255 f 416.630.4782	VA3		3/16" = 1'-0"		13049-DETAIL	IJ	ΖJ)
	va3design.com	RICHARD - H:\ARCH	HIVE\WORKING\2013\13049.BW	\details\1-0BC 2023	CURRENT\13049-detail.dwg - Thu -	Mar 23 2023 - 1:15 PM			
									_
All deams	nan annaifications, valated decuments and deci	an are the securiality	property of VAZ DECICAL Do	araduation of this are	nach, in whala ar in nach in atriath,	probibited without VAZ DECK	"Al" a must	ton normi	

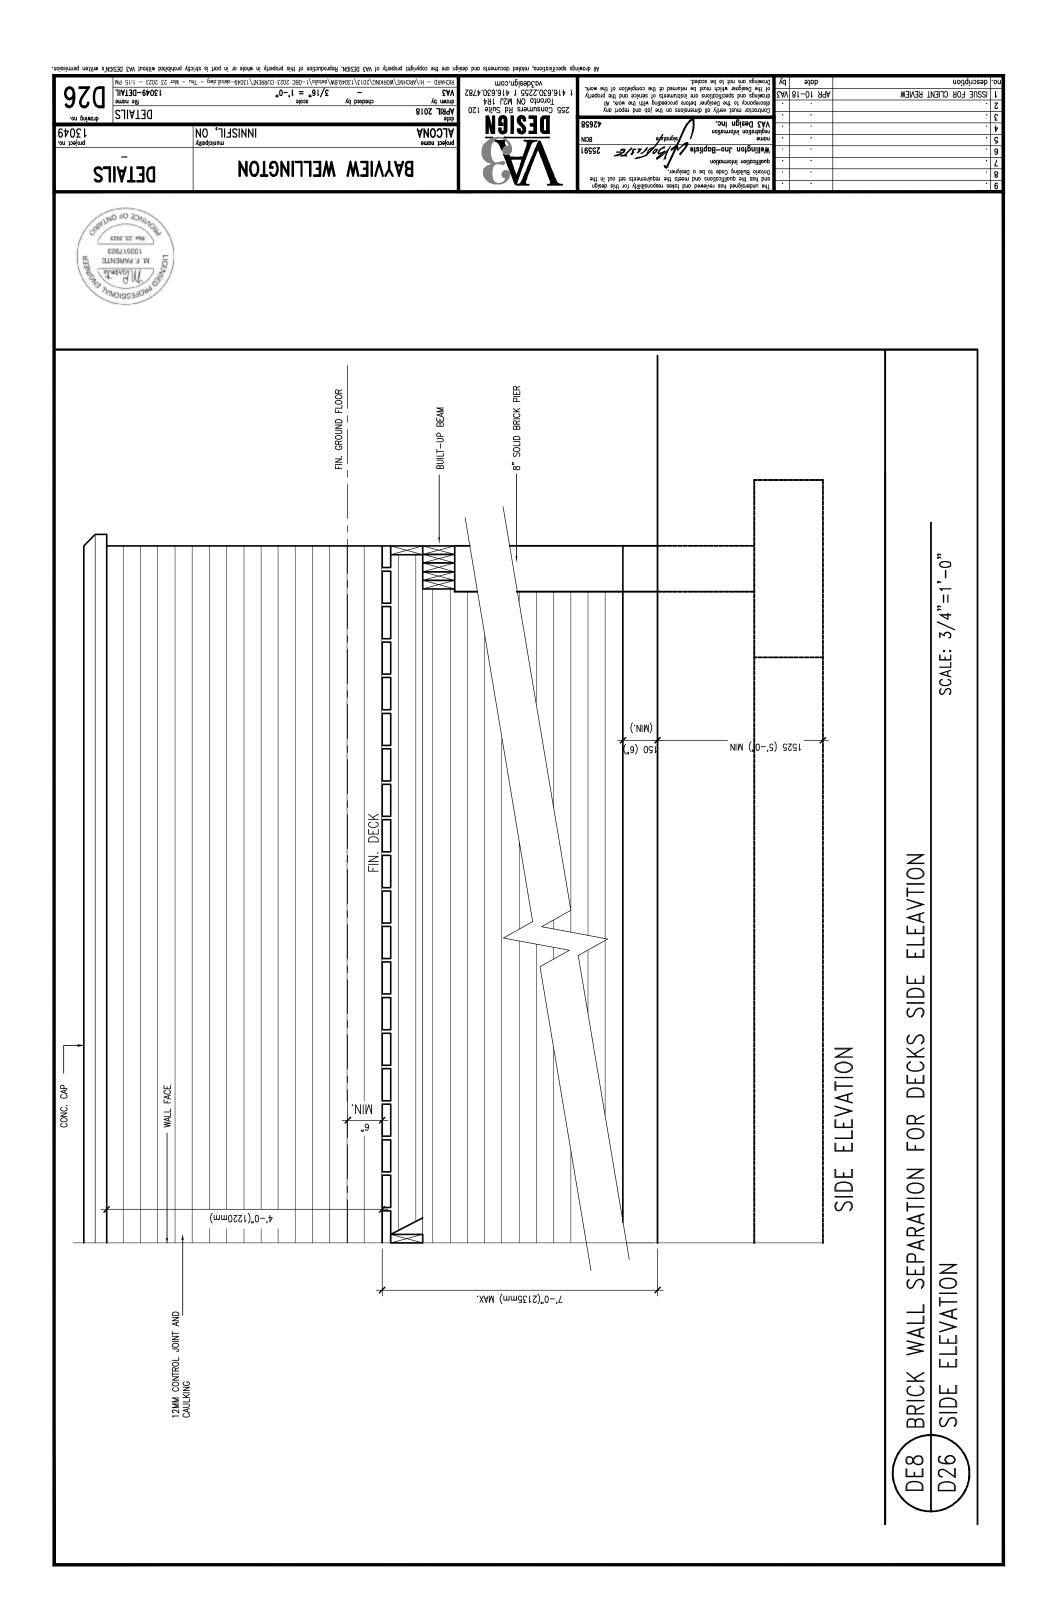

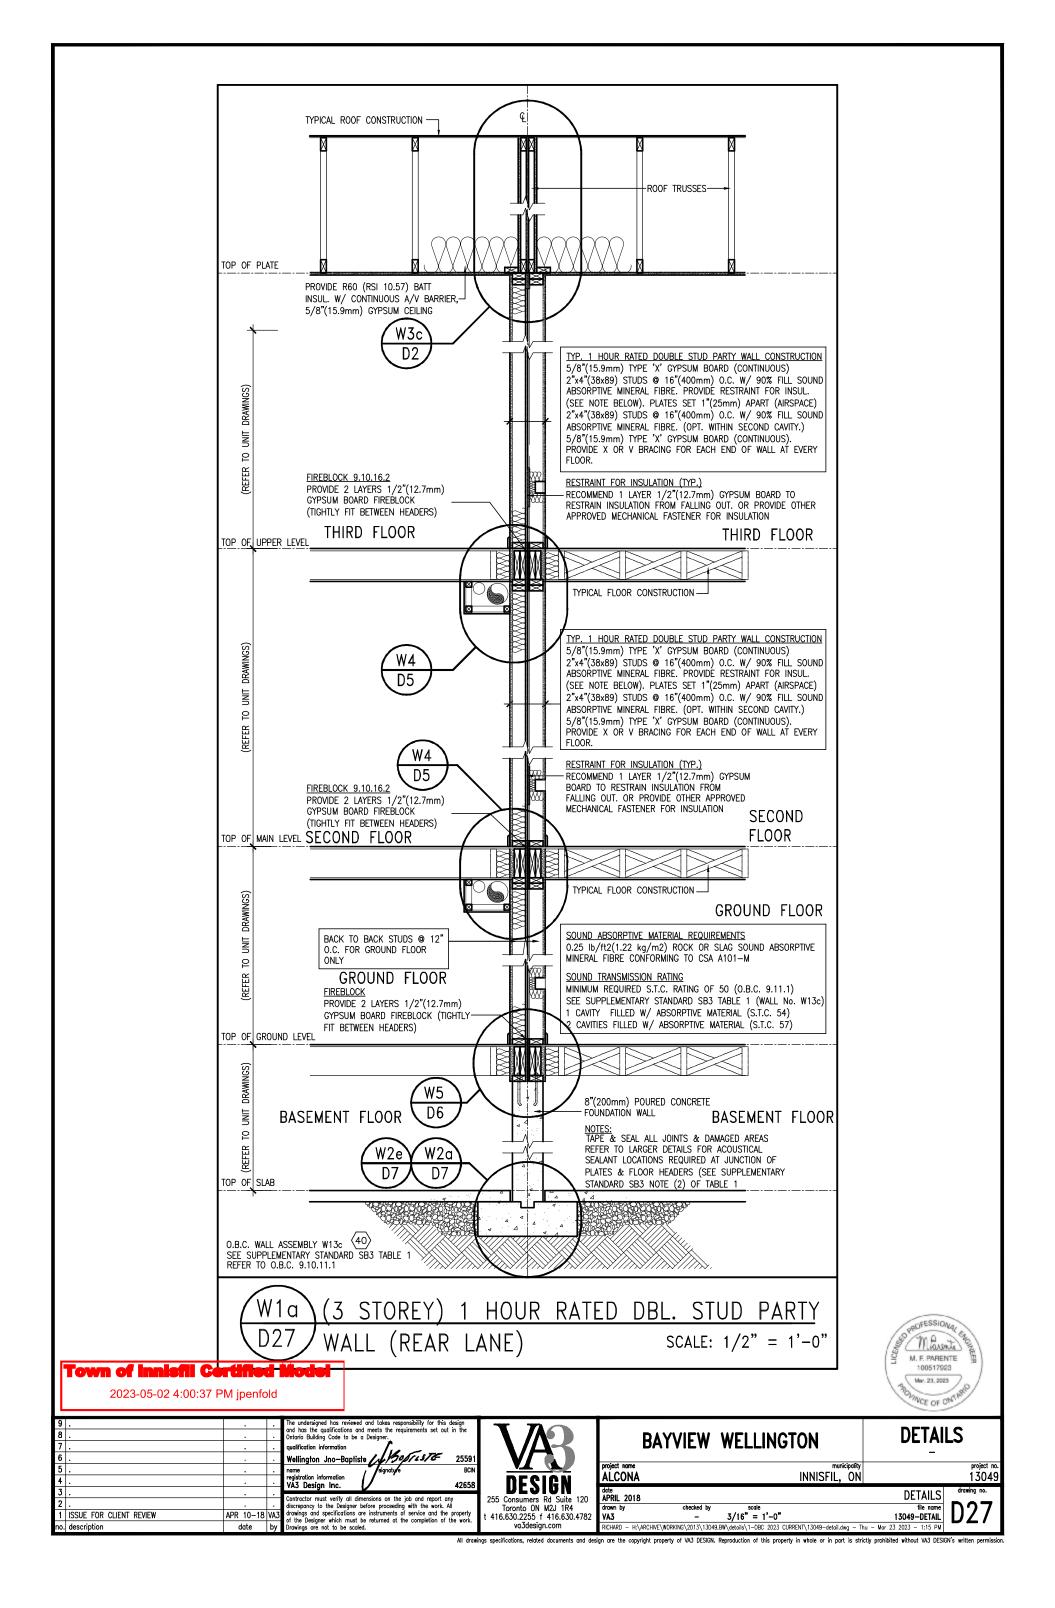

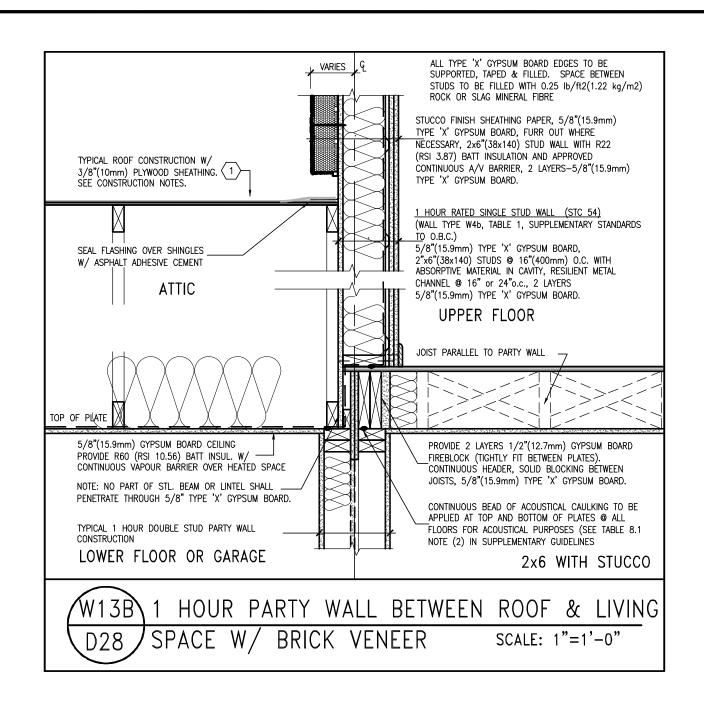



2023-05-02 4:00:37 PM jpenfold

_				
9	•			The undersigned has reviewed and takes responsibility for this design
8				and has the qualifications and meets the requirements set out in the Ontario Building Code to be a Designer.
7				qualification information
6				Wellington Jno-Baptiste Whofist 25591
5				name , //signaty/e BCIN
4				registration information VA3 Design Inc. 42658
3	•			
2				Contractor must verify all dimensions on the job and report any discrepancy to the Designer before proceeding with the work. All
1	ISSUE FOR CLIENT REVIEW	APR 10-18	VA3	
2	describites.	4-4-	h	Or the pesigner which must be returned ut the completion of the work.



	BAYVIEW	WELLINGTON
ect	name	


DETAILS


13049-DETAIL

Marente M. F. PARENTE 100517923

Mar. 23, 2023 VCE OF ON

municipality
INNISFIL, ON project name ALCONA 13049 APRIL 2018 drawn by VA3 **DETAILS** 3/16" = 1'-0"

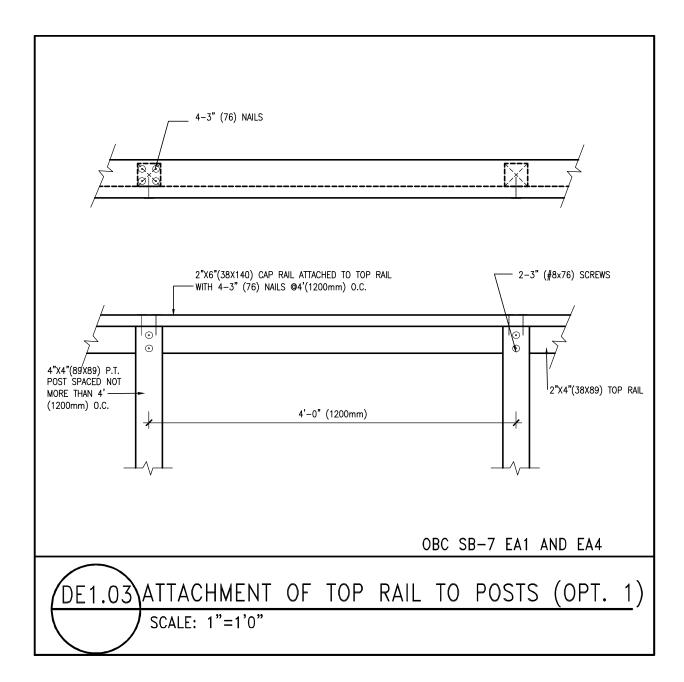

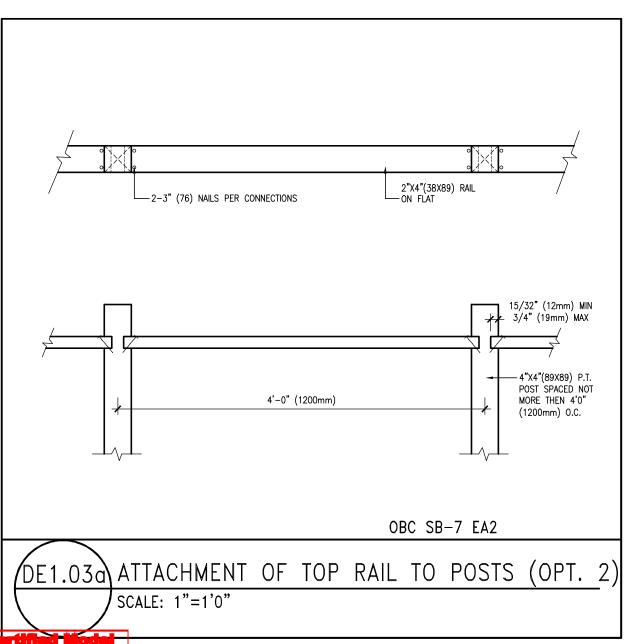



M. F. PARENTE TOUS 17923
Mer. 21, 2023

Town of innisfii Certified Model

2023-05-02 4:00:37 PM jpenfold

9 . 8 . 7 . 6 .			The undersigned has reviewed and takes responsibility for this design and has the qualifications and meets the requirements set out in the Ontario Building Code to be a Designer. qualification information Wellington Jno-Baptiste Wellington Jno-Baptiste	VAR	BAYVIEW	WELLINGTON	DETAILS _
6 . 5 . 4 .			name signature BCIN registration information VA3 Design Inc. 42658	DESIGN	project name ALCONA	INNISFIL, ON	project no. 13049
	APR 10–18	VA3	Contractor must verify all dimensions on the job and report any discrepancy to the Designer before proceeding with the work. All drawings and specifications are instruments of service and the property of the Designer which must be returned at the completion of the work.	255 Consumers Rd Suite 120 Toronto ON M2J 1R4 t 416.630.2255 f 416.630.4782	APRIL 2018 drown by checked by VA3 -	scale 3/16" = 1'-0"	DETAILS file name 13049-DETAIL
no. description	date	by	Drawings are not to be scaled.	va3design.com	RICHARD - H:\ARCHIVE\WORKING\2013\1304	9.BW\details\1-OBC 2023 CURRENT\13049-detail.dwg - The	u - Mar 23 2023 - 1:15 PM

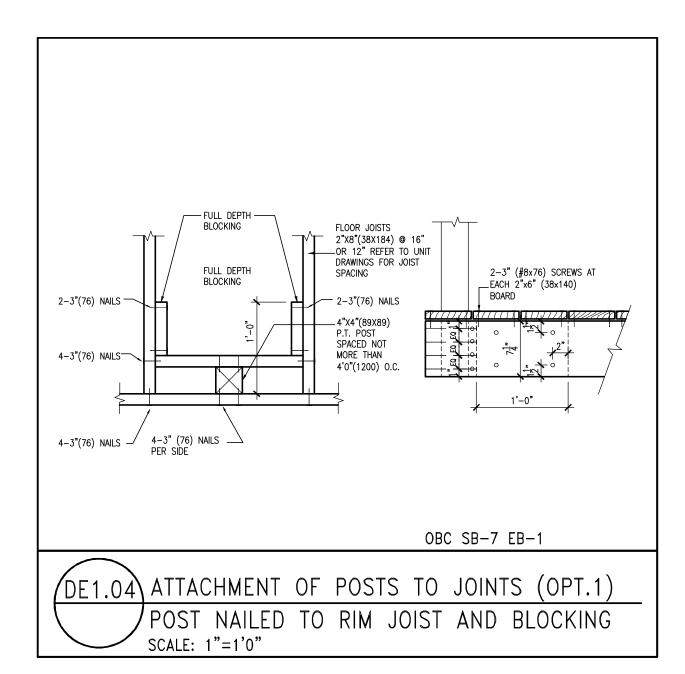

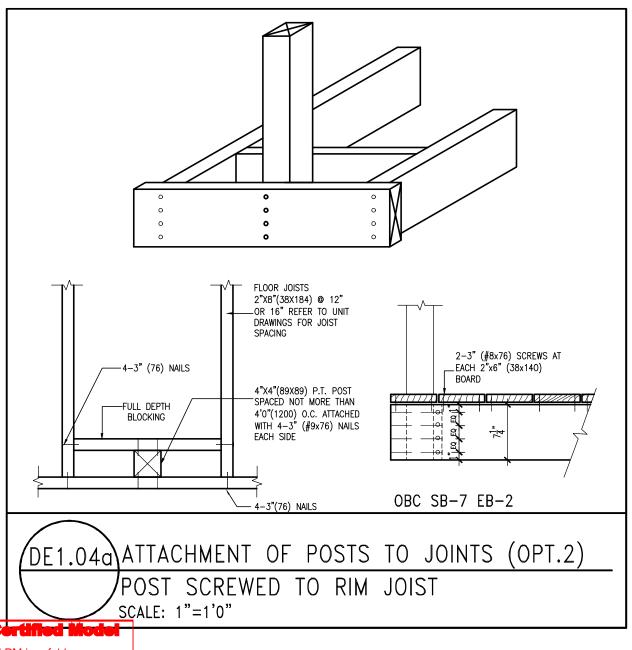




Town of Inniefil Certified Model


2023-05-02 4:00:37 PM jpenfold


9 8				The undersigned has reviewed and takes responsibility for this design and has the qualifications and meets the requirements set out in the Ontario Building Code to be a Designer.					
7	•			qualification information	I 7				
6				Wellington Jno-Baptiste College 25591	,				
5	•			name , /signaty/e BCIN	_				
4	•			registration information VA3 Design Inc. 42658					
3				The second secon	255 Co				
2				Contractor must verify all dimensions on the job and report any discrepancy to the Designer before proceeding with the work. All					
1	ISSUE FOR CLIENT REVIEW	APR 10-18	VA3	drawings and specifications are instruments of service and the property of the Designer which must be returned at the completion of the work.					
no.	description	date	by	of the Designer which must be returned at the completion of the work. Drawings are not to be scaled.					



		BAYVIEW	WELLING	STON	DETAI	LS
i	project name ALCONA			municipality INNISFIL, ON		project no. 13049
120	^{date} APRIL 2018				DETAILS	drawing no.
4 0.4782	drawn by VA3	checked by	3/16" = 1'-0"		file name 13049—DETAIL	DET21
	RICHARD - H:\/	ARCHIVE\WORKING\2013\13049	.BW\details\1-0BC 2023 (CURRENT\13049-detail.dwg - Th	ıu – Mar 23 2023 – 1:15 PM	

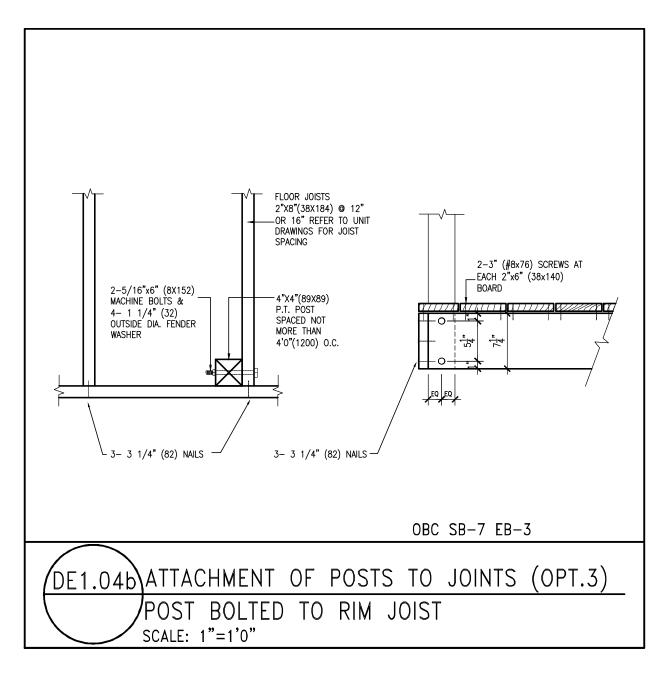

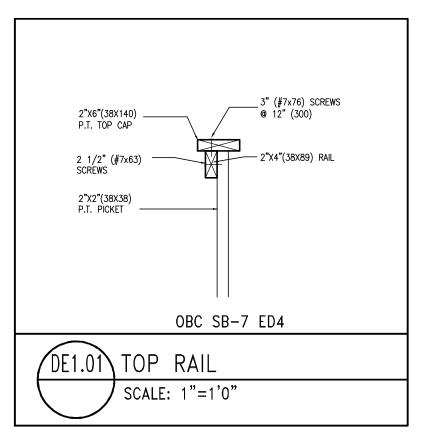

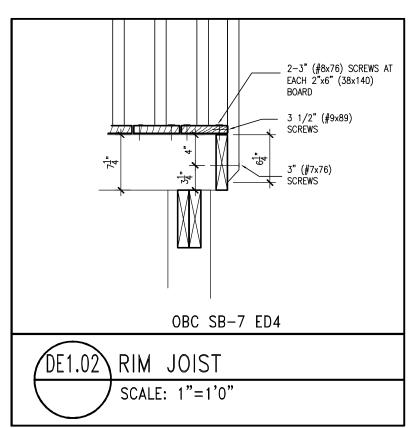

Town of innisfii Certified Model

2023-05-02 4:00:37 PM jpenfold

•				
9				The undersigned has reviewed and takes responsibility for this design
8				and has the qualifications and meets the requirements set out in the Ontario Building Code to be a Designer.
7				qualification information
6				Wellington Jno-Baptiste (1805/12376 25591
5				name , signature BCIN
4				registration information VA3 Design Inc. 42658
3				· · ·
2				Contractor must verify all dimensions on the job and report any discrepancy to the Designer before proceeding with the work. All
1	ISSUE FOR CLIENT REVIEW	APR 10-18	VA3	drawings and specifications are instruments of service and the property of the Designer which must be returned at the completion of the work.
nΛ	description	date	hv	Drawings are not to be scaled




_						
BA	YVIEW	WELLING [*]	ГОН		DETAI	LS
project name ALCONA			munic INNISFIL,	ipality ON		project no. 13049
date APRIL 2018					DETAILS	drawing no.
drawn by VA3	checked by	3/16" = 1'-0"			file name 13049—DETAIL	DET3
RICHARD - H:\ARCHIVE	\WORKING\2013\13049.E	W\details\1-0BC 2023 CUF	RENT\13049-detail.dw	q - Thu	- Mar 23 2023 - 1:15 PM	

M. F. PARENTE 100517923

Mar. 23, 2023

WCE OF CH

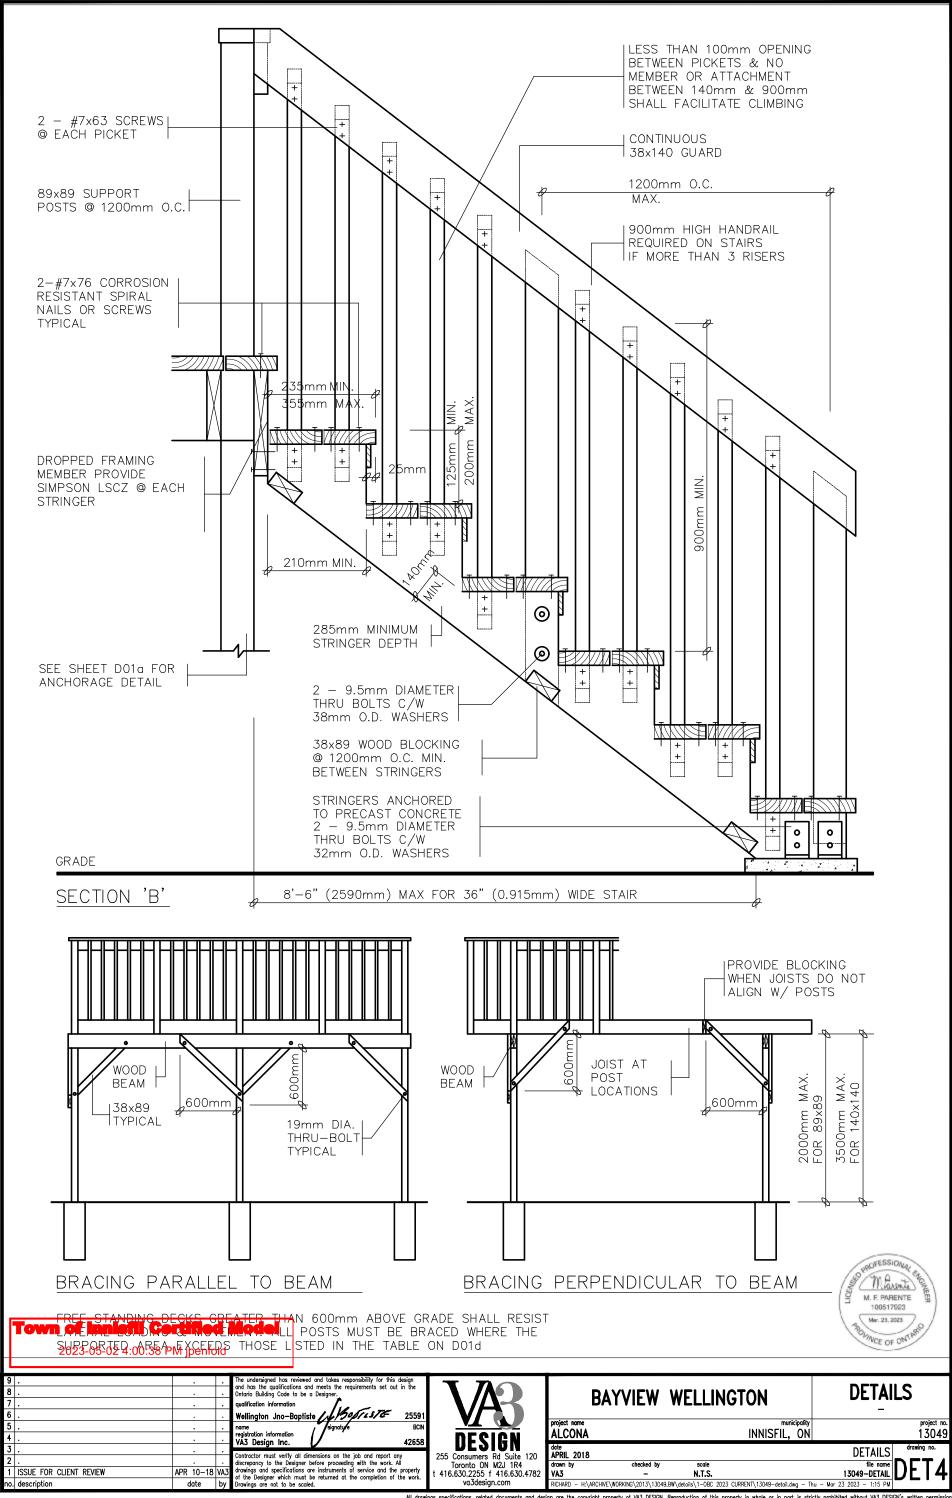

CONSTRUCTION NOTES (Unless etherwise noted)

ALL CONSTRUCTION TO ADHERE TO THESE PLANS AND SPEC'S AND TO CONFORM TO THE ONTARIO BUILDING CODE AND ALL OTHER APPLICABLE CODES AND AUTHORITIES HAVING JURISDICTION. THESE REQUIREMENTS ARE TO BE TAKEN AS MINIMUM SPECIFICATIONS. ONT. REG. 332/12-2012 OBC

IMUM SPECIFICATIONS, ONT. REG. 332/12—2012 OBC

ROOF CONSTRUCTION
NO.210 (10.25kg/m²) ASPHALI SHINGLES, 10mm (3/8") PLYWOOD
SHEATHING WITH "H" CLIPS, APPROVED WOOD TRUSSES @ 600mm
(24") O.C., MAX. APPROVED EAVES PROTECTION TO EXTEND 900mm
(3-0") FROM EDGE OF ROOF AND MIN, 300mm (12") BEYOND INNER
FACE OF EXTERIOR WALL, (FAVES PROTECTION NOT REQ'D FOR
ROOF SLOPES 81: 20 RC GREATER) 3889 (2/x4") TRUSS BRACING @
1830mm (6'-0") O.C., AT BOTTOM CHORD, PREFIN, ALUM,
EAVESTROUGH, FASCIA, RWI, & VENIED SOFFII, PROVIDE ICE &
WATTER SHELD TO ALL ROOF/WALL SURFACES SUSCEPTIBLE TO ICE
DAMMING, ROOF SHEATHING TO BE FASTENED 150 (6") c/c ALONG
EDGES & INTERMEDIATE SUPPORTS WHEN TRUSSES SPACED GREATER
THAN 406 (16"). ATTIC VENTILATION 1:300 OF INSULATED CEILING
AREA WITH MIN, 25% AT EAVES & MIN, 25% AT RIDGE (OBC 9.19.1.2.).
ENSURE ALL OVERLAPPING ROOF SPACES ARE OPEN TO MAIN ROOF
ATTIC SPACE FOR VENTING PURPOSES. ATTIC SPACE FOR VENTING PURPOSES.

FRAME WALL CONSTRUCTION (2"x6") (SB-12-TABLE 3.1.1.2.A) SIDING AS PER ELEV., 19x38 (1'x2") VERTICAL WOOD FURRING, CONTIN, SHEATHING MEMBRANE, 9,5mm (3/8) EXT, TYPE SHEATHING, S8x140 (2'x4) 5 TUDS @ 400mm (16") O.C., RSI 3.87 (R22) INSULATION AND APPR. VAPOUR BARRIER AND APPR. CONTIN. AIR BARRIER, 13mm (1/2") INT. DRYWALL FINISH. SIDING TO BE MIN. 200mm (8") ABOVE FINISH GRADE. REFER TO OBC SB-12, CHAPTER 3 FOR ADDITIONAL THERMAL INSULATION REQUIREMENTS.

RESERVED

FRAME WALL CONSTRUCTION (2"x4")— GARAGE WALLS
SIDING AS PER FLEY, 19x38 (1"x2") VERTICAL WOOD FURRING (2B) SIDING AS PER ELEY, 19X38 (1 XZ) VERILGAL WOOD FURRING, CONTIN, SHEATHING MEMBRANE, 9.5mm (3/8) EXT, TYPE SHEATHING, 38X89 (2X4) STUDS @ 400mm (16°) O.C. (MAX. HEIGHT 3000mm (9°-10°), WITH APPR, DIAGONAL WALL BRACING, SIDING TO BE MIN. 200mm (8") ABOVE FINISH GRADE.

RESERVED

STUCCO WALL CONSTRUCTION (2"x4") —GARAGE WALLS
STUCCO CLADDING SYSTEM CONFORMING TO O.B.C. 9.27.1.1.(2) &
9.28 THAT EMPLOY A MINIMUM IOMM AIR SPACE BEHIND TO
CLADDING WITH POSITIVE DRAINAGE TO THE EXTERIOR AND APPLIED
PER MANUFACTURERS SPECIFICATIONS OVER 25mm (1") MIN.
EXPANDED OR EXTRUDED RIGID POLYSTYRENE ON APPROVED
AIR MANUFACTURERS APPLIED ON 1.3 mm (1.0") EXT. TYPE SEATHING ON (2D.) AIR/MOISTURE BARRIER ON 13mm (1/2") EXT. TYPE SHEATHING ON 38x89 (2'x4") STUDS @ 400 (16") O.C., STUCCO TO BE MIN. 200 (8")

ABOVE FINISH GKADE.

WALLS ADJACENT TO ATTIC SPACE — NO CLADDING

9.5mm (3/8") EXT. TYPE SHEATHING, 38X140 (2 X6") STUDS @ 400mm

(16") O.C., RSI 3.87 (R22) INSULATION AND APPR. VAPOUR BARRIER
AND APPR. CONTIN. AR BARRIER, 13mm (1/2") INTERIOR DRYWALL
FINISH. MID-HEIGHT BLOCKING REQ"D. IF NO SHEATHING APPLIED.

REFER TO OBC SB-12, CHAPTER 3 FOR ADDITIONAL THERMAL

INSULATION PECHUEPANTS

(3.) 90mm (4") MASONRY, 25mm (1") AIR SPÄCE, 22x180x0.76mm (7/8"x7"x0.03") GALV. METAL TIES @ 400mm (16") O.C. HORIZONTAL 600mm (24") O.C. VERTICAL. APPROVED SHEATHING PAPER, 9.5mm GUORM [24] C.C., VERIICAL, APPROVED SHEAHING PAPER, Y.SIMM (3/8] EXT. TYPE SHEATHING, 3BX140 [24%] STUDS @ 400mm [16"] O.C., RSI 3.87 (R22) INSULATION & APPR, VAPOUR BARRIER WITH APPR, CONTIN, AIR BARRIER, 13mm [1/27] INTERIOR DRYWALL FINISH, PROVIDE WEEP HOLES @ 800mm (32") O.C. BOTTOM COURSE AND OVER OPENINGS. PROVIDE BASE FLASHING UP MIN, 150mm (6") BEHIND BUILDING PAPER, REFER TO OBC SB-12, CHAPTER 3 FOR ADDITIONAL THERMAL INSULATION REQUIREMENTS. MASONRY TO BE MIN. 150mm (6") ABOVE FINISH GRADE

RESERVED

MASONRY VENEER CONSTRUCTION (2"x4")- GARAGE WALLS (зв.) 90mm (4") MASONRY, 25mm (1") AIR SPACE, 22x180x0.76mm (7/8'x"X:0.03") GALV. METAL IIES © 400mm (16") O.C. HORIZONTAL 600mm (24") O.C. VERTICAL. APPR. SHEATHING PAPER, 9.5mm (3/8") EXT. TYPE SHEATHING. 38x89 (2'x4") STUDS © 400mm (16") O.C. (MAX. HEIGHT 3000mm 9:10") WITH APPR. DIAGONAL WALL BRACING. PROVIDE WEEP HOLES @ 800mm (32") O.C. BOTTOM COURSE AND PROVIDE WEEF HOLES & BOUTOM COURSE AN OVER OPENINGS, PROVIDE BASE FLASHING UP MIN. 150mm (6") BEHIND BUILDING PAPER. MASONRY TO BE MIN. 150mm (6") ABOVE FINISH GRADE.

STUCCO WALL CONSTRUCTION (2"x6") (SB-12-TABLE 3.1.1.2.A)
STUCCO CLADDING SYSTEM CONFORMING TO O.B.C. 9.27.1.1.(2) &
9.28 THAT EMPLOYS A MINIMUM 10mm AIR SPACE BEHIND THE
CLADDING WITH POSITIVE DRAINAGE TO THE EXTERIOR AND APPLIED
PER MANUFACTURERS SPECIFICATIONS OVER 25mm (1") MIN.
EXTRUDED OR EXPANDED RIGID POLYSTYRENE ON APPR. CONTIN. ARI/MOISTURE BARRIER ON 13mm [1/2"] EXT. TYPE SHEATHING ON 38x140 (2"x6") STUDS @ 400mm [16") O.C., RSI 3,87(R22) INSULATION, APPROVED VAPOUR BARRIER, 13mm [1/2"] GYPSUM WALLBOARD INTERIOR RINSH. REFER TO OBC \$8-12, CHAPTER 3 FOR ADDITIONAL THERMAL INSULATION REQUIREMENTS, STUCCO TO BE MIN. 200 (8") ABOVE FINISH GRADE.

INTERIOR STUD PARTITIONS
FOR BEARING PARTITIONS 38x89 (2'x4") @ 400mm (16") O.C. FOR 2 PLAKING MARIIIIONS 38x89 (2"x4") @ 400mm (16") O.C. FOR 2 STOREYS AND 300mm (12") O.C. FOR 3 STOREYS, NON-BEARING PARTITIONS 38x89 (2"x4") @ 600mm (24") O.C. PROVIDE 38x89 (2"x4") BOTTOM PLATE AND 2/38x89 (2"/2"x4") TOP PLATE, 13mm (1/2") INT. DRYWALL BOTH SIDES OF STUDS, PROVIDE 38x140 (2"x6") STUDS/PLATES WHERE NOTED.

POUNDATION WALL/FOOTINGS:

250mm (10") POURED CONC. FDTN, WALL 20MPG (2900ps) WITH
BITUMENOUS DAMPPROOPING AND DRAINAGE LAYER REQD. WHEN BASEMENT INSUL. EXTENDS 900 (2"-1") BELOW
FIN. GRADE. DRAINAGE LAYER IS NOT REQD. WHEN FDTN, WALL IS
WATERPROOFED. MAXIMUM POUR HEIGHT 2820 (9"-3") ON 560x155
(22%4) CONTINUOUS KEYED CONC. FIG. BRACE FDTN, WALL PRIOR
TO BACKFILLING, ALL FOOTINGS SHALL REST ON NATURAL UNDISTURBED SOIL OR COMPACTED ENGINEERED FILL. WITH MIN.
BEARING CAPACITY OF 150kPg OR GREATER. IF SOIL BEARING DOES
NOT MEET MINIMUM CAPACITY, ENGINEERED FOOTINGS ARE

RESURED.

STOREYS SUPPORTED | W | MASONRY VENEER | W | SIDING ONLY

1 | 18 | WIDE x 6 'DEEP | 18' WIDE x 6' DEEP

2 | 22' WIDE x 6' DEEP | 22' WIDE x 6' DEEP

3 | 28' WIDE x 9' DEEP | 22' WIDE x 6' DEEP

-SEE OBC 9.15.3 -MAXIMUM FLOOR LIVE LOAD OF 2 4kPg. (50psf) PFR FLOOR, AND MAX LENGTH OF SUPPORTED FLOOR JOISTS IS 4 9m (1.6-1) REFER TO SOILS REPORT FOR SOIL CONDITIONS AND BEARING

STRIP FOOTING SUPPORTING EXTERIOR WALLS (FOR W.O.B.) -ASSUMING MASONRY VENEER CONSTRUCTION, MAX. FLOG LOAD OF 2.4kPa. (50psf.) PER FLOOR, AND MAX. LENGTH OF SUPPORTED FLOOR JOISTS IS 4.9m (16'-1"), THE STRIP FOOTING SIZE IS AS FOLLOWS: 2 STOREY WITH WALK-OUT BASEMENT 545×175 (22"×7")

FOUNDATION DRAINAGE OBC. 9.14.2. & 9.14.3. 100mm (4") DIA. FOUNDATION DRAINAGE TILE 150mm (6") CRUSHED STONE OVER AND AROUND DRAINAGE TILES. \langle 6. \rangle

BASEMENT SLAB OBC. 9.3.1.6.(1)(b). 9.16.4.5.(1). 9.25.3.3.(15) COARSE GRANULAR FILL, OR 20MPA, (3000ps)) CONC. WITH DAMPPROOFING BELOW SLAB, UNDER SLAB INSULATION PER SB-12. ALL SLAB JOINTS & PENETRATIONS TO BE CAULKED.

EXPOSED FLOOR TO EXTERIOR (SB-12-TABLE 3.1.1,2,A) PROVIDE RSI 5.46 (R31) INSULATION, APPROVED VAPOUR BAR AND CONTINUOUS AIR BARRIER, FINISHED SOFFIT.

ATTIC INSULATION (SB-12-TABLE 3.1.1.2.A) (SB-12-3.1.1.8) RSI 10.56 (R60) BLOWN IN ROOF INSULATION AND API VAPOUR BARRIER, 16mm (5/8") INT. DRYWALL FINISH OR APPROVED EQUAL, RSI 3.52 (R20) MIN. ABOVE INNER SURFACE OF EXTERIOR WALL

(10) ALL STAIRS/EXTERIOR STAIRS -OBC. 9.8.(PRIVATE STAIRS)
UNIFORM RISE -5mm (1/4") MAX BETWEEN ADJACENT TREADS OR LANDINGS -10mm (3/8") MAX BETWEEN TALLEST & SHORTEST

RISE IN FLIGHT = 200 (7-7/8") = 255 (10") (NOS/NG TO NOS/NG) = RUN + 25 (1") MAX. RISE

MAX. RISE
MIN. RUN
MAX. TREAD
MAX. NOSING
MIN. HEADROOM
RAIL @ LANDING
RAIL @ STAIR = 25 (1") = 1950 (6'-5") = 900 (2'-11") = 865 (2'-10") to 1070 (3'-6") MIN. STAIR WIDTH

FOR CURVED STAIRS (TAPERED TREADS) MIN. RUN AT 300 (12")

HANDRAILS -OBC. 9.8.7.FINISHED RAILING ON PICKETS SPACED MAXIMUM 100mm (4") BETWEEN PICKETS. CLEARANCE BETWEEN HANDRAIL AND SURFACE 35. BEHIND IT TO BE 50 (2") MIN. HANDRAILS TO BE CONTINUOUS EXCEPT FOR NEWEL POST AT CHANGES OF DIRECTION .

INTERIOR GUARDS -OBC. 9.8.8.-INTERIOR GUARDS: 900mm (2'-11") MIN. HIGH

EXTERIOR SUARDS — OBC. 9.8.8.
900mm [36'] HIGH GUARD WHERE DISTANCE FROM PORCH TO FIN.
GAZDE IS LESS THAN 1800mm [71"]. O70mm (42") HIGH GUARD IS
REQUIRED WHERE DISTANCE FXCEEDS 1800mm [71'].

SILL PLATE — OBC, 9.23.7,

38x89 (2"x4") SILL PLATE WITH 13mm (1/2") DIA, ANCHOR BOLIS

200mm (8") LONG, EMBEDDED MIN, 100mm (4") INTO CONC. @

2400mm (7-10") O.C., CAULKING OR 25 (1") MIN, MINERAL WOOL

BETWEEN PLATE AND TOP OF FOTN. WALL.

USE NON-SHRINK GROUT TO LEVEL SILL PLATE WHEN REQUIRED.

BASEMENT INSULATION (SB-12-3.1.1.7), 9.25.2.3, 9.13.2.6)FOUNDATION WALLS ENCLOSING HEATED SPACE SHALL BE INSULATED FROM THE UNDERSIDE OF THE SUBFLOOR TO NOT MORE INSULATED FROM THE UNDERSIDE OF THE SUBFLOOR TO NOT MORE THAN 200mm (8") ABOVE THE FINISHED FLOOR & NO CLOSER THAN 50mm (2") OF THE BASEMENT SLAB. RSI3.52ci (R20ci) BLANKET INSULATION TO HAVE APPROVED VAPOUR BARRIER. RECOMMEND DAMPPROOF WITH BUILDING PAPER BETWEEN THE FOUNDATION WALL AND INSULATION UP TO GRADE LEVEL. NOTE: FULL HEIGHT INSULATION AT COLD CELLAR WALLS. AIR BARRIER TO BE SEALED TO FOUNDATION WALL WITH CAULKING. CONTINUOUS INSULATION (ci) IS NOT TO BE INTERRUPTED BY FRAMING.

BEARING STUD PARTITION
38x89 (2"x4") STUDS @ 400mm (16") O.C. 38x89 (2"x4") STUDS @ 400mm (10") DIA. ANCHOR BOLIS
200mm (8") LONG, EMBEDDED MIN, 100mm (4") INTO CONC. @ 2400mm (7'-10") O.C. 100mm (4") HIGH CONC, CURB ON 350x155 (14"x6") CONC. FOOTING, ADD HORIZ, BLOCKING AT MID-HEIGHT IF WALL ÍS UNFINISHED.

STEEL BASEMENT COLUMN (SEE O.B.C. 9.15.3.3) 89mm(3-1/2") DIA x 3.0mm(0.118) SINGLE WALL TUBE TYPE 2 ADJUSTABLE STL. COL. W/ MIN. CAPACITY OF 71.2kN (16,000lbs.) AT ADJUSTABLE ST.L. COL. WJ. MIJ. CAPACHT V PT. 1.2K. [16,00005.]
A MAX, EXTENSION OF 2318mm (7-7 1/2"). CONFORMING TO
CAN/CGSB-7,2-94. AND WITH 150X 150X-5. (6'X6'X3/8") STL. PLATE
TO B. BOTTOM, 870X870X410 (34"X34"X16") CONC. FOOTING ON
UNDISTURBED SOIL OR ENGINEERED FILL CAPABLE OF SUSTAINING
PRESSURE OF 150 Kpa., MINIMUM AND AS PER SOILS REPORT.

STEEL BASEMENT COLUMN (SEE O.B.C. 9.15.3.3)
89mm(3-1/2") DIA x 4.78mm(.188) HXED STL. COL. WITH 150x150x9.5
(5x6"x3/8") STL. TOP & BOTTOM PLATE ON 1070x1070x460
(42"x42"x18"), CONC, FOOTING ON UNDISTURBED SOIL OR
ENGINEERED HILL CAPABLE OF SUSTAINING A PRESSURE OF 150 Kpa,
MIN. AND AS PER SOILS REPORT.

(5B) STEEL COLUMN 90mm(3-1/2") DIA x 4.78mm(.188) NON-ADJUSTABLE STL. COL. TO BE ON 150x150x9.5 (6'x6'x3/8') STEEL TOP PLATE, & BOTTOM PLATE. BASE PLATE 120x250x12.5 (4 1/2"x10"x1/2") WITH 2-12mm DIA. 300mm LONG x50mm HOOK ANCHORS (2-1/2"x12"x2") FIELD WELD COL. TO BASE PLATE.

MASONRY VENEER CONSTRUCTION (2"x6")(SB-12-TABLE 3.1.1.2.A)

MASONRY VENEER CONSTRUCTION (2"x6")(SB-12-TABLE 3.1.1.2.A)

MIN. BEARING 90mm (3-1/2")

MIN. BEARING 90mm (3-1/2")

19x64 (1"x3") CONTINUOUS WOOD STRAPPING BOTH SIDES OF STEEL

GARAGE SLAB (18₂) 100mm (4") 32MPa (4640psi) CONC. SLAB WITH 5-8% AIR ENTRAINMENT ON OPT. 100 (4") COARSE GRANULAR FILL WITH COMPACTED SUB-BASE OR COMPACTED NATIVE FILL. SLOPE TO EPONT

SLOPE O FROM:

GARGE CELINGS/INTERIOR WALLS

13mm (1/2) GYPSUM BOARD ON WALL AND CEILING BETWEEN
HOUSE AND GARAGE. TAPE AND SEAL ALL JOINTS AIRTIGHT PER
O.B.C. 9, 10.9,16, WALLS (R22), CELINGS (R31), REFER TO SB-12,
IABLE 3.1,1.2.A. FOR REQUIRED THERMAL INSULATION. DOOR AND FRAME GASPROOFED, DOOR EQUIPPED WITH SELF

CLOSING DEVICE AND WEATHERSTRIPPING PER OBC 9,10,13,15. PRECAST CONCRETE STEP OR WOOD STEP WHERE NOT EXPOSED TO WEATHER, MAX. RISE 200mm (7-7/8"), MIN. TREAD 250mm (9-1/2"). SEE OBS. 9.8.9.2. 9.8.9.3. 8.9.8.10.

DRYER EXHAUST (OBC-6.2.3.8.(7) & 6.2.4.11.)
CAPPED DRYER EXHAUST VENTED TO EXTERIOR. (USE 100mm (4") DIA. SMOOTH WALL VENT PIPE

INSULATED ATTIC ACCESS (OBC-9.19.2.1. & SB12-3.1.1.8) ATTIC ACCESS HATCH WITH MIN. DIMENSION OF 545x610mm (21 1/2'x24") & A MIN. AREA OF 0.32 SQ.M. (3.44 SQ.FT.) WITH WEATHERSTRIPPING. RSI 3.52 (R20) RIGID INSUL, BACKING.

FIREPLACE CHIMNEYS DBC. 9.21.

TOP OF FIREPLACE CHIMNEY SHALL BE 915mm (3'-0") ABOVE THE HIGHEST POINT AT WHICH IT COMES IN CONTACT WITH THE ROOF AND 610mm (2'-0") ABOVE THE ROOF SURFACE WITHIN A HORIZ. DISTANCE OF 3050mm (10'-0") FROM THE CHIMNEY.

(25.) LINEN CLOSET, 4 SHELVES MIN. 350mm (14") DEEP.

MECHANICAL EXHAUST FAN, VENTED TO EXTERIOR AS REQUIRED BY OBC. 9.32.3.5. & 9.32.3.10.

STEEL BEARING PLATE FOR MASONRY WALLS
280x280x16 (11"x11"x5/8") STL. PLATE FOR STL BEAMS AND
280x280x12 (11"x11"x1/2") STL. PLATE FOR WOOD BEAMS BEARING
ON CONC. BLOCK PARTYWALL, ANCHORED WITH 2-19mm (3/4") x
200mm (8") LONG GALV. ANCHORS WITHIN SOLID BLOCK COURSE,
LEVEL WITH NON-SHRINK GROUT.

SOLID WOOD BEARING FOR WOOD STUD WALLS SOLID BEARING TO BE AT LEAST AS WIDE AS THE SUPPORTED MEMBER, SOLID WOOD BEARING COMPRISED OF BUILT-UP WOOD STUDS TO BE CONSTRUCTED IN ACCORDANCE WITH OBC 9.17.4.2(2)

BEARING WOOD POST (BASEMENT) (OBC 9.17.4.)
3-38x140 (3-2 x6") BUILT-UP-POST ON METAL BASE SHOE ANCHORED TO CONC. WITH 12.7 DIA. BOLT, 610x610x300 (24"x24"x12") CONC. FOOINING. (29)

STEPPED FOOTINGS OBC 9.15.3.9. MIN. HORIZ, STEP = 600mm (24").

MAX. VERT. STEP = 600mm (24") SLAB ON GRADE
MIN. 100mm (4") CONCRETE SLAB ON GRADE ON 100mm (4")
COARSE GRANULAR FILL. REINFORCED WITH 6x6-W2.9xW2.9 MP
PLACED NEAR MID-DEPTH OF SLAB. CONC. STRENGTH 32 MPa (4640 psi) WITH 5-8% AIR ENTRAINMENT ON COMPACTED SUB-GRADE, WHERE REQUIRED, REFER TO OBC SB-12, TABLE

3.1.1.2 A. FOR REQUIRED MINIMUM, INSULATION UNDER SLAB DIRECT VENTING 6AS FURNACE/ H.W.T VENT

DIRECT VENTING GAS FURNACE/ H.W.T VENT

DIRECT VENT FURNACE TERMINAL MIN. 900mm (36°) FROM A

NATURAL GAS REGULATOR, MIN. 300mm (12°) ABOVE FIN. GRADE,

ROM ALL OPENINGS, EXHAUST AND INTAKE VENTS. HRY INTAKE TO

BE A MIN. OF 1830mm (6-0°) FROM ALL EXHAUST TERMINALS. REFER

TO GAS UTILIZATION CODE. ALL AR INTAKES SHALL BE LOCATED SO THAT THEY ARE SEPARATED FROM KITCHEN EXHAUST BY 3.0M IN COMPLIANCE WITH O.B.C., DIV.-B TABLE 6,2,3,12,.

DIRECT VENTING GAS FIREPLACE VENT DIRECT VENTING GAS FIREPLACE VENT
DIRECT VENT GAS FIREPLACE. VENT TO BE A MINIMUM 300mm (12")
FROM ANY OPENING AND ABOVE FIN. GRADE. REFER TO GAS

34) SUBFLOOR, JOIST STRAPPING AND BRIDGING 16mm (5/8) 1 & G SUBFLOOR ON WOOD FLOOR JOISTS, FOR CERAMIC TILE APPLICATION (* SEE OBC 9:30.6. *) 6mm (1/4") PANEL TYPE UNDERLAY UNDER RESILIENT & PARQUET FLOORING. (* SEE TYPE UNDERLAY UNDER RESILIENT & PARQUET FLOORING. (* SEE OBGC 9.30.2.7). FLOOR JOISTS WITH SPANS OVER 2100mm (6-11") TO BE BRIDGED WITH 38x38 (2"x2") CROSS BRACING OR SOLID BLOCKING @ 2100mm (6-11") O.C., MAX. AND WHERE SPECIFIED BY JOIST TABLES A FLOOR A-2 STRAPPING SHALL BE 17x44 (1"x3") @ 2100mm (6-11") O.C. UNLESS A PANEL TYPE CEILING FINISH IS APPLIED. (* SEE OBC 9.23.9.4. *)

OFESSION

Marente

M. F. PARENTE

100517923

VCE OF ON

EXPOSED BUILDING FACE OBC. 9.10.15. & SB-2-2.3.5.(2) EXTERIOR WALLS TO HAVE A FIRE RESISTANCE RATING OF NOT LESS THAN 45 min. WHERE LIMITING DISTANCE (LD) IS LESS THAN 1.2M (3-11-1). WHERE THE LD IS LESS THAN 600mm (1-1-11") THE EXPOSING FACE SHALL BE CLAD IN NON-COMBUSTIBLE MATERIAL. SEE ELEVATIONS FOR ADDITIONAL NOTES.

OFFENDING GARAGE WALLS INCLUDED.

COLD CELLAR PORCH SLAB (OBC 9.39.)
FOR MAX. 2500mm (8-2') PORCH DEPTH (SHORTEST DIM.),
1250mm (5') 32MPa (4640ps) (CONC. SLAB WITH 5-8" AIR
ENTRAINMENT. REINF. WITH 10M BARS 200mm (7') 7/8") O.C.
EACH WAY IN BOTTOM THIRD OF SLAB, MIN. 30mm (1 1/4") COVER, 600x600 (23 5/8"x23 5/8") 10M DOWELS @ 600mm (23 5/8" O.C., ANCHORED IN PERIMETER FOTH, WALLS, SLOPE SLAB MIN. 1.0% FROM HOUSE WALL. SLAB TO HAVE MIN. 75mm (3') BEARING ON FDIN, WALLS, PROVIDE (L7) LINTEL OVER CELLAR DOOR WITH 100mm (4") END BEARING.

THE FOTN, WALL SHALL NOT BE REDUCED TO LESS THAN 90mm (3-1/2") THICK TO A MAX. DEPTH OF 600mm (24") AND SHALL BE TIED TO THE FACING MATERIAL WITH METAL TIES SPACED 200mm (8") O.C. VERICALLY AND 900mm (35") O.C. HORIZONTALLY. FILL SPACE BETWEEN WALL AND FACING SOLID WITH MORTAR.

CONVENTIONAL ROOF FRAMING (2.0Kpg. SNOW LOAD) 38x140 (2"x6") RAFTERS @ 400mm (16"0.C.) FOR MAX 11"-7"
SPAN, 38x184 (2"x8") RIDGE BOARD, 38x89 (2"x4") COLLAR TIES
AT MIDSPANS. CEILING JOISTS TO BE 38x89 (2"x4") @ 400mm (1
C.C. FOR MAX, 2830mm (9"-3") SPAN & 38x140 (2"x6") @ 400
(16") O.C. FOR MAX, 4450mm (14"-7") SPAN. RAFTERS FOR BUILT-UP ROOF TO BE 38x89 (2'x4") @ 600mm (24") O C WITH A 38x89 (2'x4") CENTRE POST TO THE TRUSS BELOW LATERALLY BRACED @ 1800mm (6'-0") O.C. VERTICALLY.

GENERAL NOTES

WINDOWS: 1) MINIMUM BEDROOM WINDOW —OBC. 9.9.10.1.—
AT LEAST ONE BEDROOM WINDOW ON A GIVEN FLOOR IS TO
HAVE MIN, 0.3570 LINOSTRUCTED CLAZED OR OPENABLE
AREA WITH MIN. CLEAR WIDTH OF 380 mm (1".3").

2) WINDOW GUARDS —OBC. 9.8.8.1.(6).
A GUARD IS REQUIRED WHERE THE TOP OF THE WINDOW SILL IS LOCATED LESS THAN 4807m (1.7.7.) AGOVERN. FLOOR AND THE DISTANCE FROM THE FIN. FLOOR TO THE ADJACENT GRADE IS GREATER THAN 1800mm (5'-11")

3) EXTERIOR WINDOWS
SHALL COMPLY WITH OBC DIV.-B 9.7.3, & \$B12-3.1.1.9

4) GLASS—STRUCTURAL SUFFICIENCY OF GLASS ADEQUATE INFORMATION TO DEMONSTRATE COMPLIANCE WITH OBC DIV.-B 9.6.1.3.

GENERAL: 1) MECHANICAL VENTILATION IS REQUIRED TO COMPLY WITH OBC-DIV. B, 6.2.2. SEE MECHANICAL DRAWINGS. ALL DOWNSPOUTS TO DRAIN AWAY FROM THE BUILDING AS PER OBC 9.26.18.2. & 5.6.2.2.(3) AND MUNICIPAL STANDARDS.

ALL WINDOW WELLS TO DRAIN TO FOOTING LEVEL PER OBC 9.14.6.3. CHECK WITH THE LOCAL AUTHORITY.

STUD WALL REINFORCEMENT FOR FUTURE GRAB BARS IN MAIN BATHROOM REINFORCEMENT OF STUD WALLS SHALL BE INSTALLED ADJACENT TO WATER CLOSETS AND SHOWER OR BATHTUB IN MAIN BATHROOM, REFER TO OBC, DIV. B-9.5.2.3 & DETAIL BEOWLOED.

ALL EXTERIOR DOORS TO COMPLY WITH THERMAL RESISTANCE AS STATED IN O.B.C. SB-12-3.1.1.9.

AS STATED NO. 9.6. 258-12-3, 1.1.9.
ALL AR BARRIER SYSTEMS ARE REQUIRED TO COMPLY WITH O.B.C. DIV.-8 9.25.3.
ALL OUTDOOP ARE INTAKES SHALL BE LOCATED SO THAT THEY ARE SEPARATED FROM SOURCES OF CONTAMINATION (EXHAUST VENTS) IN COMPLIANCE WITH O.B.C. DIV.-8 6,2.3.12.
AND TABLE 4.23 12 AND TABLE 6.2.3.12.

ALL LUMBER SHALL BE SPRUCE NO.2 GRADE, UNLESS NOTED LUMBER: 1) OTHERWISE.
STUDS SHALL BE STUD GRADE SPRUCE, UNLESS NOTED

OTHERWISE.

LUMBER EXPOSED TO THE EXTERIOR TO BE SPRUCE NO.2 GRADE
PRESSURE TREATED OR CEDAR, UNLESS NOTED OTHERWISE.

ALL LAMINATED VENEER LUMBER (L.V.L.) BEAMS, GIRDER
TRUSSES, AND METAL HANGER CONNECTIONS SUPPORTING
ROOF FRAMING TO BE DESIGNED & CERTIFIED BY TRUSS
MANUFACTURER.

MANUFACTURER.

LVL BEAMS SHALL BE 2.0E -2959FD MIN., NAIL EACH PLY OF LVL
WITH 89mm [3 1/2"] LONG COMMON WIRE NAILS @ 300mm
(12") O.C. STAGGERED IN 2 ROWS FOR 184 - 240 & 300mm (7
1/4"9 1/2". 11 7/8] DEPTHS AND STAGGERED IN 3 ROWS FOR
GREATER DEPTHS AND FOR 4 PLY MEMBERS ADD 13mm (1/2")
DIA. GALVANIZED BOLTS BOLTED AT MID-DEPTH OF BEAM @
915mm [3-0"] O.C.
PROVIDE FACE MOUNT BEAM HANGERS TYPE "SCL"
MANUFACTURED BY SIMPSON STRONG-THE OR EQUILA
FOR ALL LVL BEAM TO BEAM CONNECTIONS UNLESS
OTHERWISE NOTICE. REFER TO EING. FLOOR LAYOUTS.
JOST HANGERS: PROVIDE METAL HANGERS FOP ALL JOISTS

JOIST HANGERS: PROVIDE METAL HANGERS FOR ALL JOISTS AND BUILT-UP WOOD MEMBERS INTERSECTING FLUSH BUILT-UP

WOOD MEMBERS, WOOD NEMBERS, WOOD PRESERVATIVE, IN CONTACT WITH CONCRETE, SHALL BE SEPARATED FROM THE CONCRETE BY AT LEAST 2 mill, POLYETHYLENE FILM, No. 50 (430ls.) FOLL FOODNING OF OTHER DAMPFROOPHING MATERIAL. EXCEPT WHERE THE WOOD MEMBER IS AT LEAST 150mm (6") ABOVE THE GROUND.

STEEL: 1)

ABOVE THE GROUND.

STRUCTURAL STEEL SHALL CONFORM TO CAN/CSA-G40-21
GRADE 350W HOLLOW STRUCTURAL SECTIONS SHALL
CONFORM TO CSA-G40.21 GRADE 350W CLASS H'
STRUCTURAL QUALITY STEEL: OBC. B 9-23.4.3
ENINFORCHIOS STEEL SHALL CONFORM TO CSA-G30.18M
GRADE 400R.
ALL STUCCO WALLS TO HAVE A MINIMUM 10mm AIR SPACE
BEHIND THE CLADIDING WITH POSITIVE DPAINAGE TO THE
EXTERIOR. THE EXTERIOR SHEATHING MUST NOT BE GYPSUM.
BASED, ALL STUCCO TO BE INSTALLED AS PER MANUFACTURERS
SPECIFICATIONS.

lacksquare

ф

OUTLET (HEIGHT A.F.F)

GFI DUPLEX OUTLET (HEIGHT A.F.F)

HEAVY DUTY OUTLET (220 volt)

LIGHT FIXTURE (CEILING MOUNTED)

LIGHT FIXTURE (WALL MOUNTED)

HOSE BIB (NON-FREEZE)

<u>LEGEND</u>

CLASS 'B' VENT DUPLEX OUTLET (12" ABOVE SURFACE)

POT LIGHT

LIGHT FIXTURE (PULL CHAIN)

SWITCH

Ò 🚳 🐶 FLOOR DRAIN SJ SINGLE JOIST Ŋ

DOUBLE JOIST TRIPLE JOIST TJ LVL

P.T. PRESSURE TREATED LUMBER G.T. GIRDER TRUSS BY ROOF TRUSS MANUF LAMINATED VENEER LUMBER POINT LOAD FROM ABOVE

F.A. **L** FLAT ARCH MEDICINE CABINET (RECESSED)

DOUBLE VOLUME WALL. SEE NOTE 39 CONCRETE BLOCK WALL SOLID WOOD BEARING (SPRUCE No. 2).
SOLID BEARING TO BE AS WIDE AS SUPPORTED MEMBER OR AS DIRECTED BY STRUCTURAL ENGINEER. SOLID BEARING TO BE MINIMUM 2 PIECES.



SOIL GAS / RADON CONTROL (OBC 9.1.1.7. & 9.13.4.)
PROVIDE CONSTRUCTION TO PREVENT LEAKAGE OF SOIL GAS

INTO THE BUILDING IF REQUIRED. CONTRACTOR MUST VERIEY ALL DIMENSIONS ON THE

SOLID WOOD BEARING TO MATCH FROM ABOVE

CONTRACTOR MOST VERIET ALL DIMENSIONS ON THE JOB AND REPORT ANY DISCREPANCY TO VAS DESIGN BEFORE PROCEEDING WITH THE WORK, ALL DRAWINGS AND SPECIFICATIONS ARE INSTRUMENTS OF SERVICE AND THE PROPERTY OF VA3 DESIGN WHICH IF REQUESTED, MUST BE RETURNED AT THE COMPLETION OF THE WORK, ALI DRAWINGS TO BE USED FOR CONSTRUCTION ONLY AFTER BUILDING PERMIT HAS BEEN ISSUED

39 -FOR A MAXIMUM 5490 mm (18'-0") HEIGHT AND MAXIMUM -FOR A MAXIMUM 5490 mm (18-0) HEIGHT AND MAXIML SUPPORTED ROOF TRUSS LENGTH OF 6.0m, PROVIDE 2-38x1 40 (2-2"x6") SPR.#2 CONTIN. STUDS @ 3000mm (12") O.C. (TRIPLE UP AT EVERY THIRD DOUBLE STUD FOR BRICK O.C. (IRIPLE UP AT EVERY THIRD DOUBLE STUD FOR BRICK WALLS) CTW, 96, (3/8)" THICK EXT. PLYWOOD SHEATHING. PROVIDE SOLID WOOD BLOCKING BETWEEN WOOD STUDS © 1220 mm (4-0") O.C. VERTICALLY. FOR WALLS WITH HORIZ. DISTANCES NOT EXCEEDING 2900 mm (9-6"), PROVIDE 38x140 (22/x6) STUDS © 400 (16") O.C. WITH CONTINUOUS 2-38x140 (2-2/x6) TOP PLATES + 1-38x140 (1-2/x6") BOTTOM PLATE & MINIMUM OF 3-38x184 (3-2/x8") CONT. HEADER AT GRND. CEILING LEVEL TOE-NAILED & CLUED AT 10-2 BOTTOM PLATES AND HEADERS

GLUED AT TOP, BOTTOM PLATES AND HEADERS. TYPICAL 1 HOUR RATED PARTY WALL.
REFER TO DETAILS FOR TYPE AND SPECIFICATIONS

FOUNDATION WALL (W.O.D./W.O.B.) WHERE GRADE TO T/O BASEMENT SLAB EXCEEDS 1200mm (3'-11") A 250mm (10") WIDE FOUNDATION WALL IS REQUIRED.

EXTERIOR WALLS FOR WALK-OUT CONDITIONS
THE EXTERIOR BASEMENT STUD WALL TO BE 38x140 (2"x6")
STUDS @ 400mm (16") o.c. OR 38x89 (2"x4") STUDS @ 300mm

DRAIN WATER HEAT RECOVERY UNIT (DWHR) PER SB12-3.1.1.12., A DRAIN WATER HEAT RECOVERY (DWHR) UNIT SHALL BE INSTALLED IN EACH DWELLING UNIT TO RECOVER DRAIN WATER FROM AT LEAST TWO SHOWERS OR FROM AT LEAST TWO SHOWERS WHERE THERE ARE TWO OR MORE SHOWERS IN THE DWELLING UNIT, DOES NOT APPLY IF THERE ARE NO SHOWERS OR NO STOREY BENEATH ANY OF THE SHOWERS.

ONT. REG. 332/12-2012 OBC ◆ UPDATED Amendment O. Reg. 88/19 MOOD LINTELS AND BUILT-UP WOOD BEAMS

2/38 × 184 (2/2" × 8") SPR,#2 3/38 × 184 (3/2" × 8") SPR,#2 4/38 × 184 (4/2" × 8") SPR,#2 5/38 × 184 (5/2" × 8") SPR,#2 2/38 × 235 (2/2" × 10") SPR.#2 3/38 × 235 (3/2" × 10") SPR.#2 4/38 × 235 (4/2" × 10") SPR.#2 L3 2/38 x 286 (2/2" x 12") SPR.#2 3/38 x 286 (3/2" x 12") SPR.#2 4/38 x 286 (4/2" x 12") SPR.#2 В6

LOOSE STEEL LINTELS

89 x 89 x 6.4L (3-1/2" x 3-1/2" x 1/4"L) 89 x 89 x 7.9L (3-1/2" x 3-1/2" x 5/16"L) 102 x 89 x 7.9L (4" x 3-1/2" x 5/16"L) 127 x 89 x 7.9L (5" x 3-1/2" x 5/16"L) 152 x 89 x 10.0L (6" x 3-1/2" x 5/16"L) 152 x 102 x 11.0L (6"x 4" x 7/16"L) 178 x 102 x 13.0L (7"x 4" x 1/2"L)

LAMINATED VENEER LUMBER (LVL) BEAMS LVL1A 1-1 3/4"x7 1/4" (1-45x184) LVL1 2-1 3/4"x7 1/4" (2-45x184) LVL2 3-1 3/4"x7 1/4" (3-45x184) LVL3 4-1 3/4"x7 1/4" (4-45x184) LVL4A 1-1 3/4"x9 1/2" (1-45x240) LVL4 2-1 3/4"x9 1/2" (2-45x240) LVL5 3-1 3/4"x9 1/2" (3-45x240) LVL5A 4-1 3/4"x9 1/2" (4-45x240) LVL6A 1-1 3/4"x11 7/8" (1-45x300) LVL6 2-1 3/4"x11 7/8" (2-45x300) LVL7 3-1 3/4"x11 7/8" (3-45x300) 4-1 3/4"x11 7/8" (4-45x300)

DOOR SCHEDULE

1. EXTERIOR 815 x 2030 x 45 DOOR (2'-10" x 6'-8" x 1-3/4")

EXTERIOR 865 x 2030 x 45 DOOR (2'-10" x 6'-8" x 1-3/4")

2A DOOR (2'-8" x 6'-8" x 1-3/4") 20
MIN. RATED DOOR AND FRAME,
WITH APPROVED SELF CLOSING

EXTERIOR 815 x 2438 x 45
DOOR (2'-8" x 8'-0" x 1-3/4") 20
MIN. RATED DOOR AND FRAME,
WITH APPROVED SELF CLOSING

3. INTERIOR 760 x 2030 x 35 DOOR (2'-6" x 6'-8" x 1-3/8") 3A INTERIOR 710 x 2030 x 35 DOOR (2'-4" x 6'-8" x 1-3/8")

3B INTERIOR 760 x 2438 x 35 DOOR (2'-6" x 8'-0" x 1-3/8") 3C INTERIOR 710 x 2438 x 35 DOOR (2'-4" x 8'-0" x 1-3/8") 4.) INTERIOR 610 x 2030 x 35 DOOR (2'-0" x 6'-8" x 1-3/8")

4A INTERIOR 660 x 2030 x 35 DOOR (2'-2" x 6'-8" x 1-3/8") (4C) INTERIOR 660 x 2438 x 35 DOOR (2'-2" x 8'-0" x 1-3/8")

5.) INTERIOR 460 x 2030 x 35 DOOR (1'-6" x 6'-8" x 1-3/8") 6. EXTERIOR 815 x 2030 x 45
DOOR (2'-8" x 6'-8" x 1-3/4")
SOLID WOOD CORE

MECHANICAL SYMBOLS HFAT PIPF anminmus WARM AIR PLUMBING (TOILET) RETURN AIR DUCT CTTTT® PLUMBING (BATH,

SINK SHOWER) SMOKE ALARM (REFER TO OBC 9.10.19) PROVIDE 1 PER FLOOR, NEAR THE STAIRS CONNECTING THE FLOOR LEVEL AND ALSO 1 IN EACH BEDROOM NEAR HALL DOOR, ALARMS TO BE CONNECTED TO AN ELECTRICAL CIRCUIT AND INTERCONNECTED TO ACTIVATE ALL ALARMS IF 1 SOUNDS, BATTERY BACK-UP REQUIRED.

(9.10.19.3.(31) CARBON MONOXIDE ALARMS (OBC 9.33.4.)
WHERE A FUEL-BURNING APPLIANCE IS INSTALLED

D IN A DWELLING UNIT WHERE A DELEGIANING AFFLIANCE SI INSIDELED IN A WELLING DIMI, A CARBON MONOXIDE ALARM CONFORMING TO CAN./CSA-6.19 OR UL2034 SHALL BE INSTALLED ADJACENT TO EACH SLEPPING AREA. CARBON MONOXIDE DETECTOR(S) SHALL BE PERMANENTLY WRED SO THAT ITS ACTIVATION WILL ACTIVATE ALL CARBON MONOXIDE DETECTORS AND BE EQUIPPED WITH AN ALARM THAT IS AUDIBLE WITHIN BEDROOMS WHEN THE INTERVENING DOORS ARE CLOSED, REFER TO MANUFACTURER FOR ADDDITIONAL REQUIREMENTS

SMOKE ALARMS TO INCORPORATE VISUAL SIGNALLING COMPONENT

REFER TO UNIT DRAWINGS OR PAGE CN-2 FOR SB-12 COMPLIANCE PACKAGE A1 TO BE USED FOR THIS MODEL. The minimum thermal performance of building envelope and equipment shall conform to the selected package unless otherwise noted.

2022

A1

UPDATE TO OBC VER 2022 FEB 16-22 R UPDATE TO OBC VER 2020 FEB 09-21 RC ISSUE FOR CLIENT REVIEW AUG 04-17 RC date by description


The undersigned has reviewed and takes responsibility for this design and has the qualifications and meets the requirements set out in the Ontario Building Code to be a Designer. aualification information Bosiste Wellington Jno-Baptiste 🖊 y 25591 BCI VA3 Design Inc. 42658 Contractor must verify all dimensions on the job and report any discrepancy to the Designer before proceeding with the work. All drawings and specifications are instruments of service and the property of the Designer which must be returned at the completion of the work Drawings are not to be scaled.



BAYVIEW WELLINGTON


CONST NOTE 13049

ALCONA INNISFIL, ON. MAY 2016 CONSTRUCTION NOTES 3/16" = 1'-0" 13049-CN-A1 VER 2022 CN Notes\13049-CN-A1 VFR 2022.dv

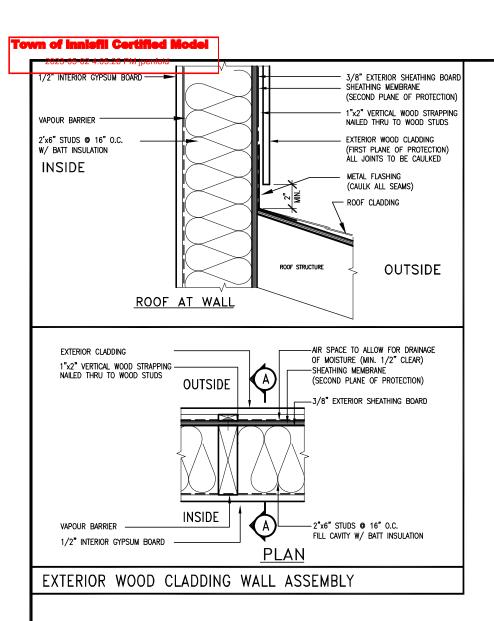

<u>STUD WALL REINFORCEMENT FOR FUTURE GRAB BARS IN MAIN BATHROOM</u>

REINFORCEMENT OF WOOD STUD WALLS SHALL BE INSTALLED ADJACENT TO WATER CLOSETS AND SHOWER OR BATHTUB IN MAIN BATHROOM PER OBC. DIV. B-9.5.2.3 FUTURE GRAB BARS TO BE MOUNTED TO RESIST HORIZ. AND VERT. LOADS OF 1.3 KN (300 lb)

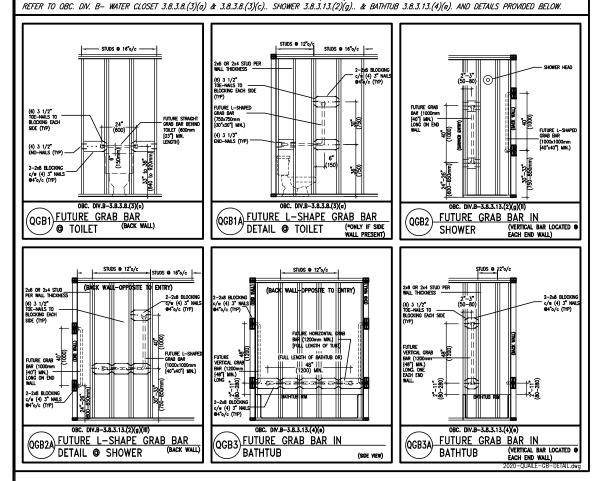


OUTDOOR AIR INTAKE SEPARATION
ALL OUTDOOR AIR INTAKE VENTS TO BE SEPARATED A
MINIMUM DISTANCE FROM SOURCES OF CONTAMINATION PER OBC. DIV. B— TABLE 6.2.3.12.
• KITCHEN EXHAUST. 3.0m

DRIVEWAY, PARKING SPACE, ROAD. SOLID FUEL APPLIANCE EXHAUST 3.0m

TOP PLATE "KING" **POST** "CRIPPLER NUMBER OF SB NOTED

CRIPPLE" DETAIL

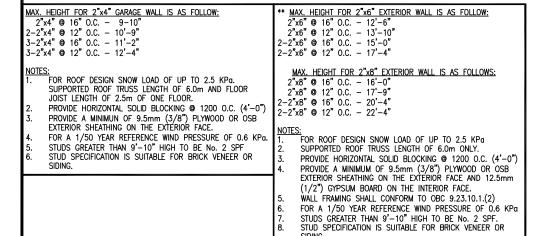



13049-CN-A1 VER 2022

9	•			The undersigned has reviewed and takes responsibility for this design
8				and has the qualifications and meets the requirements set out in the Ontario Building Code to be a Designer.
7				qualification information
6				Wellington Jno-Baptiste / 1/30/125/6 25591
5				name , signature BCIN
4				registration information VA3 Design Inc. 42658
3	UPDATE TO OBC VER 2022	FEB 16-22	RC	
2	UPDATE TO OBC VER 2020	FEB 09-21	RC	Contractor must verify all dimensions on the job and report any discrepancy to the Designer before proceeding with the work. All
1	ISSUE FOR CLIENT REVIEW	AUG 04-17	RC	
no.	description	date	by	Drawings are not to be scaled.



** STUD INFORMATION TAKEN FROM OBC TABLE A-30


BAYVIEW	WELLINGTON	CONST	NOTE
project name ALCONA	municipality INNISFIL,ON.		project no. 13049
date MAY 2016	CONST	RUCTION NOTES	drawing no.

3/16" = 1'-0"

RUBBER MEMBRANE PREFINISHED METAL FLASHING STUCCO DETAIL AS PER ELEVATION : DuROCK STARTER MESH (BACKWRAPPED) REFER TO SPECIFICATIONS FOR MINIMUM SLOPE Durock adhesive Durock Finish Coat DUROCK FIBER MESH EMBEDDED IN DUROCK PREP COAT PUCCS INSULATION BOARD. DUROCK POLAR BEAR AIR/MOISTURE BARRIER MECHANICAL FASTENER-CN3 WINDOW HEADER SCALE: 3"=1'-0" CAULKING - Durock Starter Mesh (Backwrapped) - Prefinished Mlt Flashing for Moisture Drain Out RUBBER MEMBRANE OVERLAPPING FLASHING DUROCK POLAR BEAR AIR/MOISTURE BARRIER
-BLUE SKIN SA WRAPPED INTO WINDOW ROUGH OPENING WINDOW BLUE SKIN SA WRAPPED INTO WINDOW ROUGH OPENING CAULKING

ALL STUCCO WALLS TO HAVE A MINIMUM 10mm AIR SPACE BEHIND THE CLADDING WITH POSITIVE DRAINAGE TO THE EXTERIOR. THE EXTERIOR SHEATHING MUST NOT BE GYPSUM BASED. ALL STUCCO TO BE INSTALLED AS PER MANUFACTURERS SPECIFICATIONS.

DETAILS ARE BASED ON DUROCK PUCCS SYSTEM

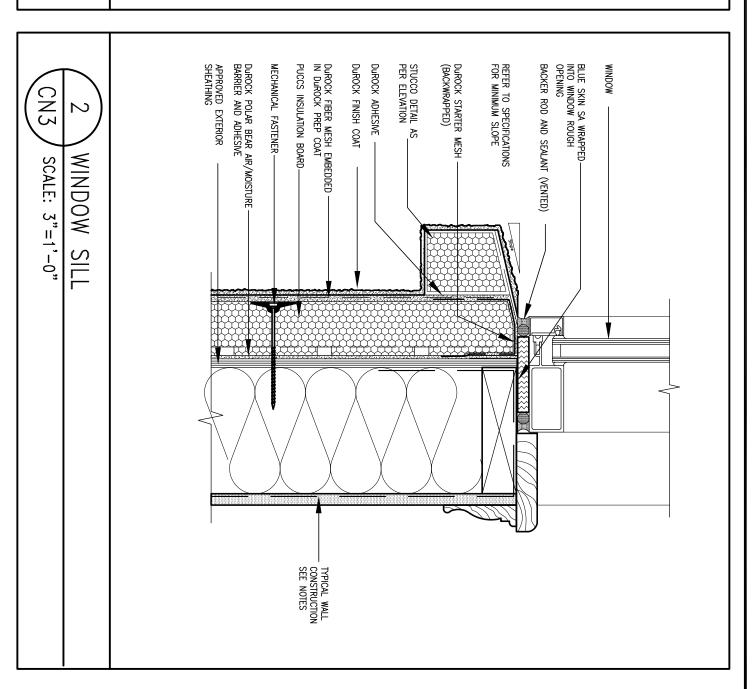

- TYPICAL WALL CONSTRUCTION SEE NOTES



9	•			The undersigned has reviewed and takes responsibility for this design
8				and has the qualifications and meets the requirements set out in the Ontano Building Code to be a Designer.
7				qualification information
6				Wellington Jno-Baptiste / 1/30/16576 25591
5				name / signature BCIN
4				registration information VA3 Design Inc. 42658
3	UPDATE TO OBC VER 2022	FEB 16-22		
2	UPDATE TO OBC VER 2020	FEB 09-21	RC	
1	ISSUE FOR CLIENT REVIEW	AUG 04-17	RC	drawings and specifications are instruments of service and the property of the Designer which must be returned at the completion of the work.
no.	description	date	by	Drawings are not to be scaled.



BAYVIE	W WEL	LINGTON	CONST	NOTE
ect name CONA		municipality INNISFIL,ON.		project no. 13049
Y 2016		CONS	TRUCTION NOTES	drawing no.
	ked by sco - 3/16" =		file name 3049-CN-A1 VER 2022	LNO

APPROVED EXTERIOR SHEATHING

APPROVED EXTERIOR SHEATHING DUROCK STARTER MESH (BACKWRAPPED) 2 1/2" THICK PUCCS INSULATION BOARD DUROCK FINISH COAT MECHANICAL FASTENER DUROCK "POLAR BEAR" AIR/MOISTURE BARRIER/ADHESIVE CN4 STUCCO TERMINATION SCALE: 3"=1'-0" 0 ROOF

FLASHING

DUROCK UNI-TRACK

BEHIND THE CLADDING WITH POSITIVE DRAINAGE TO THE EXTERIOR. THE EXTERIOR SHEATHING MUST NOT BE GYPS BASED. ALL STUCCO TO BE INSTALLED AS PER MANUFACTURERS SPECIFICATIONS.

DETAILS ARE BASED ON DUROCK PUCCS SYSTEM ALL STUCCO WALLS TO HAVE A MINIMUM 10mm AIR SPACE BE GYPSUM

> DUROCK FIBRE MESH EMBEDDED IN DUROCK PREP COAT PUCCS INSULATION BOARD BACKER ROD AND SEALANT (VENTED) DUROCK FINISH COAT 2 1/2" THICK PUCCS INSULATION BOARD DUROCK STARTER MESH (BACKWRAPPED) FIBRE MESH TAPE AT JOINT DUROCK STARTER MESH (BACKWRAPPED) MECHANICAL FASTENER CN4 SCALE: 3"=1'-0" HORIZONTAL **EXPANSION JOIN** FIBRE MESH TAPE AT V
> — JOINT
> — DUROCK STARTER MESH
> (BACKWRAPPED) — DUROCK POLAR BEAR AIR/MOISTURE BARRIER/ADHESIVE APPROVED EXTERIOR SHEATHING DUROCK "POLAR BE AIR/MOISTURE BARRIER/ADHESIVE BEAR"




L					_		
	9 .		The undersigned has reviewed and takes responsibility for this design and has the qualifications and meets the requirements set out in the	TO			001107 11077
	8 .		Ontario Building Code to be a Designer.	 	I BAYVIEW	WELLINGTON	CONST NOTE
	7 .		qualification information	I \ /Δ-<	DAIVIEW	WELLINGTON	
	6 .		Wellington Jno-Baptiste / 6/50/165/6 2559	I V/A			
	5 .		name / signature BCIN	<u> </u>	project name	municipality	
ı	4 .		registration information VA3 Design Inc. 42658	l DESIGN	ALCONA	INNISFIL,ON.	1304
ı	3 UPDATE TO OBC VER 2022	FEB 16-22 RC			date	CON2.	TRUCTION NOTES drawing no.
I	2 UPDATE TO OBC VER 2020	FEB 09-21 RC	Contractor must verify all dimensions on the job and report any discrepancy to the Designer before proceeding with the work. All	255 Consumers Rd Suite 120 Toronto ON M2J 1R4	MAY 2016 drawn by checked by	scale	file name
ı	1 ISSUE FOR CLIENT REVIEW	AUG 04-17 RC	drawings and specifications are instruments of service and the property	t 416.630.2255 f 416.630.4782			3049-CN-A1 VER 2022 (N 4
ı	no. description	date by	of the Designer which must be returned at the completion of the work. Drawings are not to be scaled.	va3design.com		49.BW\UNITS\CN Notes\13049-CN-A1 VER 2022.dwg - T	U III I

13049

DETAILS ARE BASED ON DUROCK PUCCS SYSTEM

CN5 BEHIND THE CLADDING WITH POSITIVE DRAINAGE EXTERIOR. THE EXTERIOR SHEATHING MUST NOT BASED. ALL STUCCO TO BE INSTALLED AS PER MANUFACTURERS SPECIFICATIONS. ALL STUCCO WALLS TO HAVE A MINIMUM 10mm AIR SPACE \mathcal{O} CORNER DETAIL SCALE: 3"=1'-0" 4" MIN ₹ ₹ — DUROCK FIBRE MESH EMBEDDED IN DUROCK PREP COAT 2^1_2 " THICK PUCCS INSULATION BOARD DUROCK FINISH COAT DuROCK "POLAR BEAR" AIR/MOISTURE BARRIER BE GYPSUM TO THE

APPROVED EXTERIOR SHEATHING MECHANICAL FASTENER

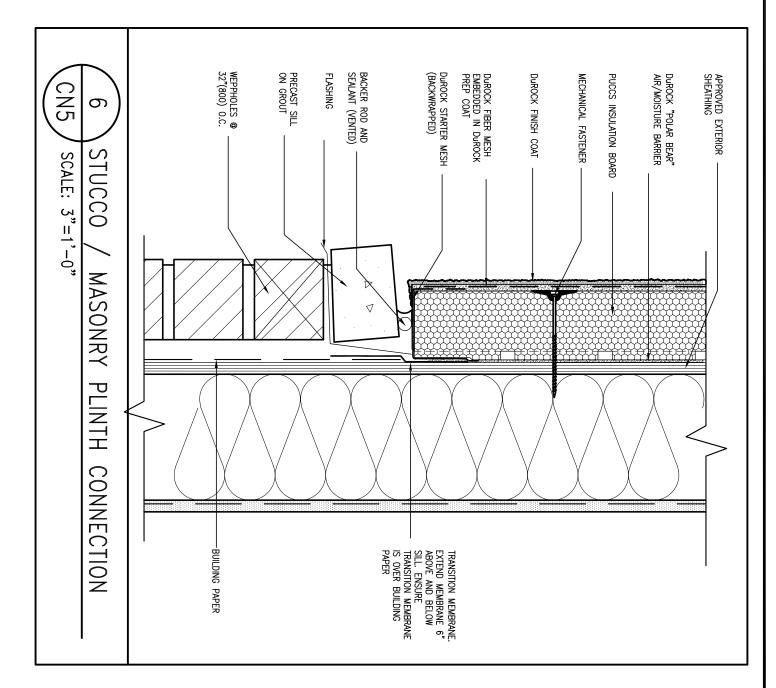




9				The undersigned has reviewed and takes responsibility for this design	
8				and has the qualifications and meets the requirements set out in the Ontario Building Code to be a Designer.	
7				qualification information	
6				Wellington Jno-Baptiste / 1505/15/6 25591	1
5				name / signature BCIN	
4				registration information VA3 Design Inc. 42658	n
3	UPDATE TO OBC VER 2022	FEB 16-22			ע ע
2	UPDATE TO OBC VER 2020	FEB 09-21	RC	Contractor must verify all dimensions on the job and report any discrepancy to the Designer before proceeding with the work. All	255 Con Toro
т	ISSUE FOR CLIENT REVIEW	AUG 04-17	RC	drawings and specifications are instruments of service and the property of the Designer which must be returned at the completion of the work.	t 416.630
no.	description	date	by	Drawings are not to be scaled.	١

VAR	
<u> </u>	Г
DECICN	L
DESIGN	Г
255 Consumers Rd Suite 120	
Toronto ON M2J 1R4	Г
t 416.630.2255 f 416.630.4782	
va3desian.com	Г

	BAYVIEW	WELLINGT	ON	CONST	NOTE
project name ALCONA			municipality INNISFIL,ON.		project no. 13049
date MAY 2016 drawn by	checked by	scale	CONST	RUCTION NOTES	
RC	-	3/16" = 1'-0"	13	5049-CN-A1 VER 2022	LND

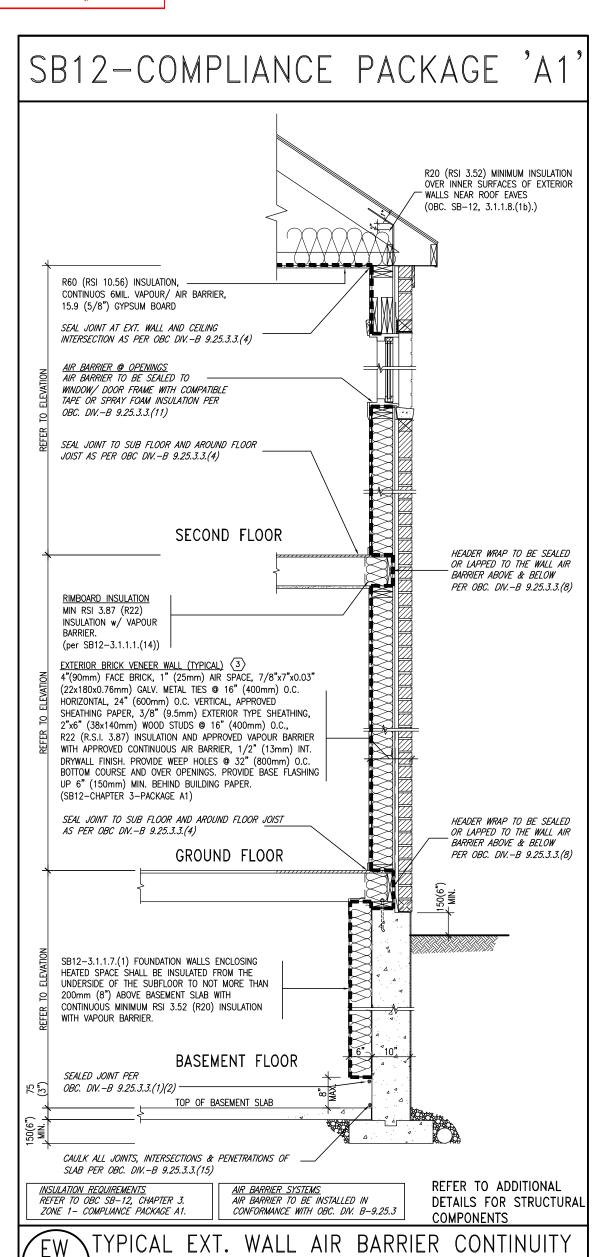


SECTION w/ BRICK VENEER (PACKAGE A1)

THE MINIMAL THERMAL PERFORMANCE OF BUILDING ENVELOPE AND EQUIPMENT SHALL CONFORM TO THE FOLLOWING SB-12 COMPLIANCE PACKAGE AS PER OBC SUPPLEMENTARY STANDARD SB-12, SECTION 3.1.1.1.

USE SB-12 COMF	LIANCE	PACKAGE (A1):				
COMPONENT	A1	Notes:				
Ceiling with Attic Space Minimum RSI (R) value	10.56 (R60)	R20 at inner face of exterior walls				
Ceiling without Attic Space Minimum RSI (R) value	5.46 (R31)	BATT or SPRAY				
Exposed FLoor Minimum RSI (R) value	5.46 (R31)	BATT or SPRAY				
Walls Above Grade Minimum RSI (R) value	3.87 (R22)	6" R22 BATT				
Basement Walls Minimum RSI (R) value	3.52ci (R20ci)	OPTION TO USE R12+R10ci.				
Edge of Below Grade Slab ≤600mm below grade Minimum RSI (R) value	1.76 (R10)	RIGID INSUL				
Windows & Sliding glass Doors Maximum U-value	1.6					
Skylights Maximum U-value	2.8U					
Space Heating Equipment Minimum AFUE	96% Min.	NATURAL GAS				
Hot Water Heater Minimum EF	0.8	NATURAL GAS				
HRV Minimum Efficiency	75%	-				
Drain Water Heat Recovery Unit (DWHR)	Dependent on n	Maximum 2 Required. number of showers installed. -3.1.1.12 for information				
ci— Denotes Continuous Insulation without framing interruption.						



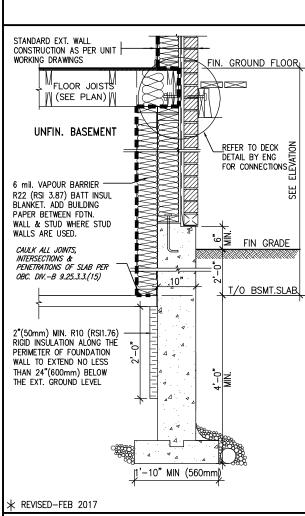

SECTION AT W.O.D/W.O.B.

9				The undersigned has reviewed and takes responsibility for this design
8				and has the qualifications and meets the requirements set out in the Ontario Building Code to be a Designer.
7				qualification information
6				Wellington Jno-Baptiste / 1/30/16576 2559
5				name / signature BCII
4				registration information VA3 Design Inc. 42658
3	UPDATE TO OBC VER 2022	FEB 16-22	RC	
2	UPDATE TO OBC VER 2020	FEB 09-21	RC	Contractor must verify all dimensions on the job and report any discrepancy to the Designer before proceeding with the work. All
1	ISSUE FOR CLIENT REVIEW	AUG 04-17	RC	drawings and specifications are instruments of service and the property of the Designer which must be returned at the completion of the work.
	description	data	by	Description of the work.


10" FOUNDATION WALL

	\ A2
1	V/ R. J
ı	
3	DESIGN
	255 Consumers Rd Suite 120
	Toronto ON M2J 1R4
	t 416.630.2255 f 416.630.4782
	va3design.com


SCALE: N.T.S.

	BAYVIEW	WELLINGTO	NC	COI	NST_	NOTE
oject name	l		municipality INNISFIL,ON.			project no. 13049
nte AY 2016			CONST	RUCTION	NOTES	drawing no.
awn by C	checked by	3/16" = 1'-0"	13	049-CN-A1	file name VER 2022	CN6


13049-CN-A1 VER 2022 UNO

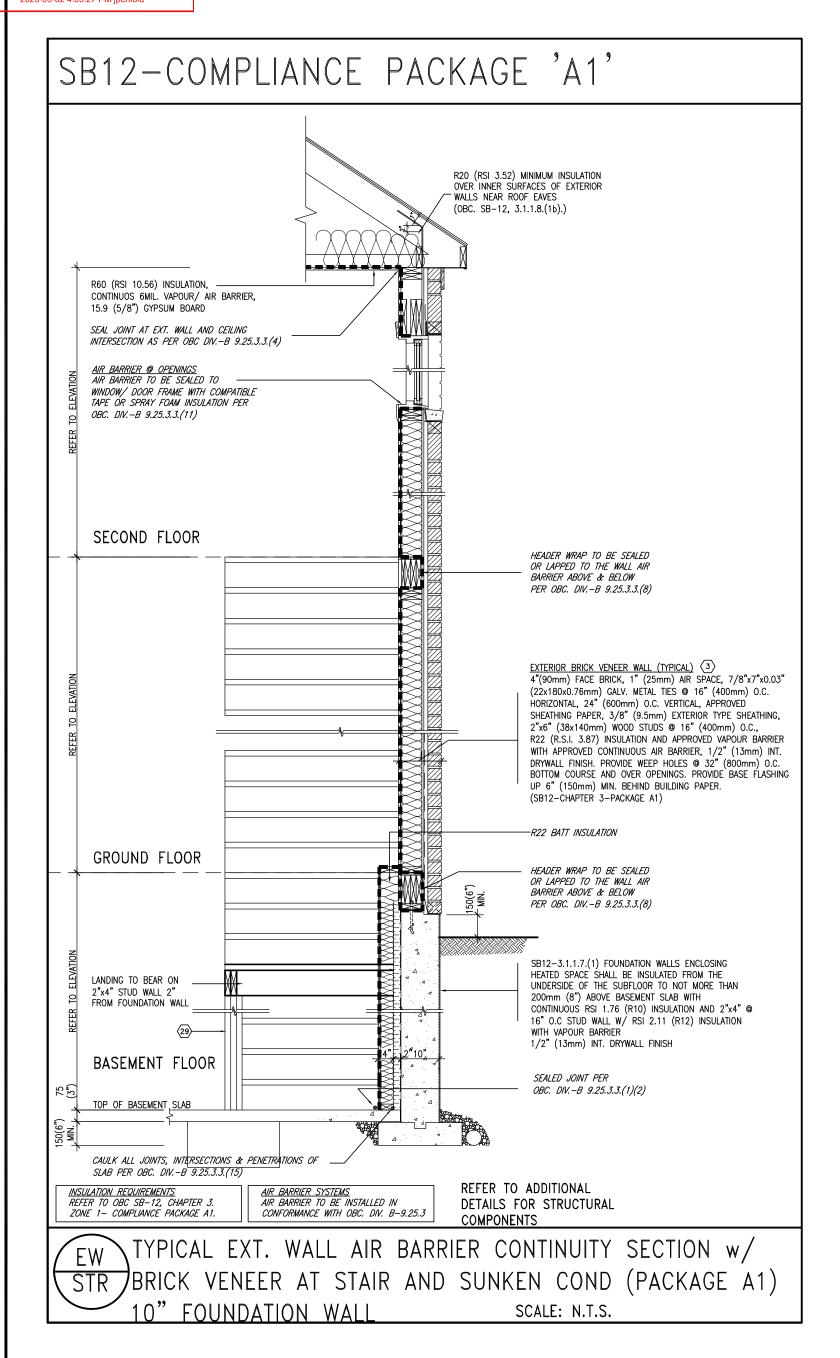

L						_		
9) .			The undersigned has reviewed and takes responsibility for this design	T D O			
8	I .			and has the qualifications and meets the requirements set out in the Ontario Building Code to be a Designer.	 		WELLINGTON	CONST NOTE I
7		•		qualification information	I \	DAIVIEW	WELLINGTON	
6	i .			Wellington Jno-Baptiste / W/30/16576 2559	V/ }			
5	i .			name / signature BCIM		project name	municipality	project no.
4				registration information VA3 Design Inc. 42658	DESIGN	ALCONA	INNISFIL,ON.	13049
3	UPDATE TO OBC VER 2022	FEB 16-22				date MAY 2016	CONST	FRUCTION NOTES drawing no.
2	UPDATE TO OBC VER 2020	FEB 09-21		Contractor must verify all dimensions on the job and report any discrepancy to the Designer before proceeding with the work. All	200 Concumbic Na Callo 120	drawn by checked by	scale	file name
1	ISSUE FOR CLIENT REVIEW	AUG 04-17	RC	drawings and specifications are instruments of service and the property of the Designer which must be returned at the completion of the work.	t 416.630.2255 f 416.630.4782			3049-CN-A1 VER 2022 CN
nc	o. description	date	by	Drawings are not to be scaled.	va3design.com	RICHARD - H:\ARCHIVE\WORKING\2013\130	49.BW\UNITS\CN Notes\13049-CN-A1 VER 2022.dwg - Tr	hu - Mar 23 2023 - 1:11 PM

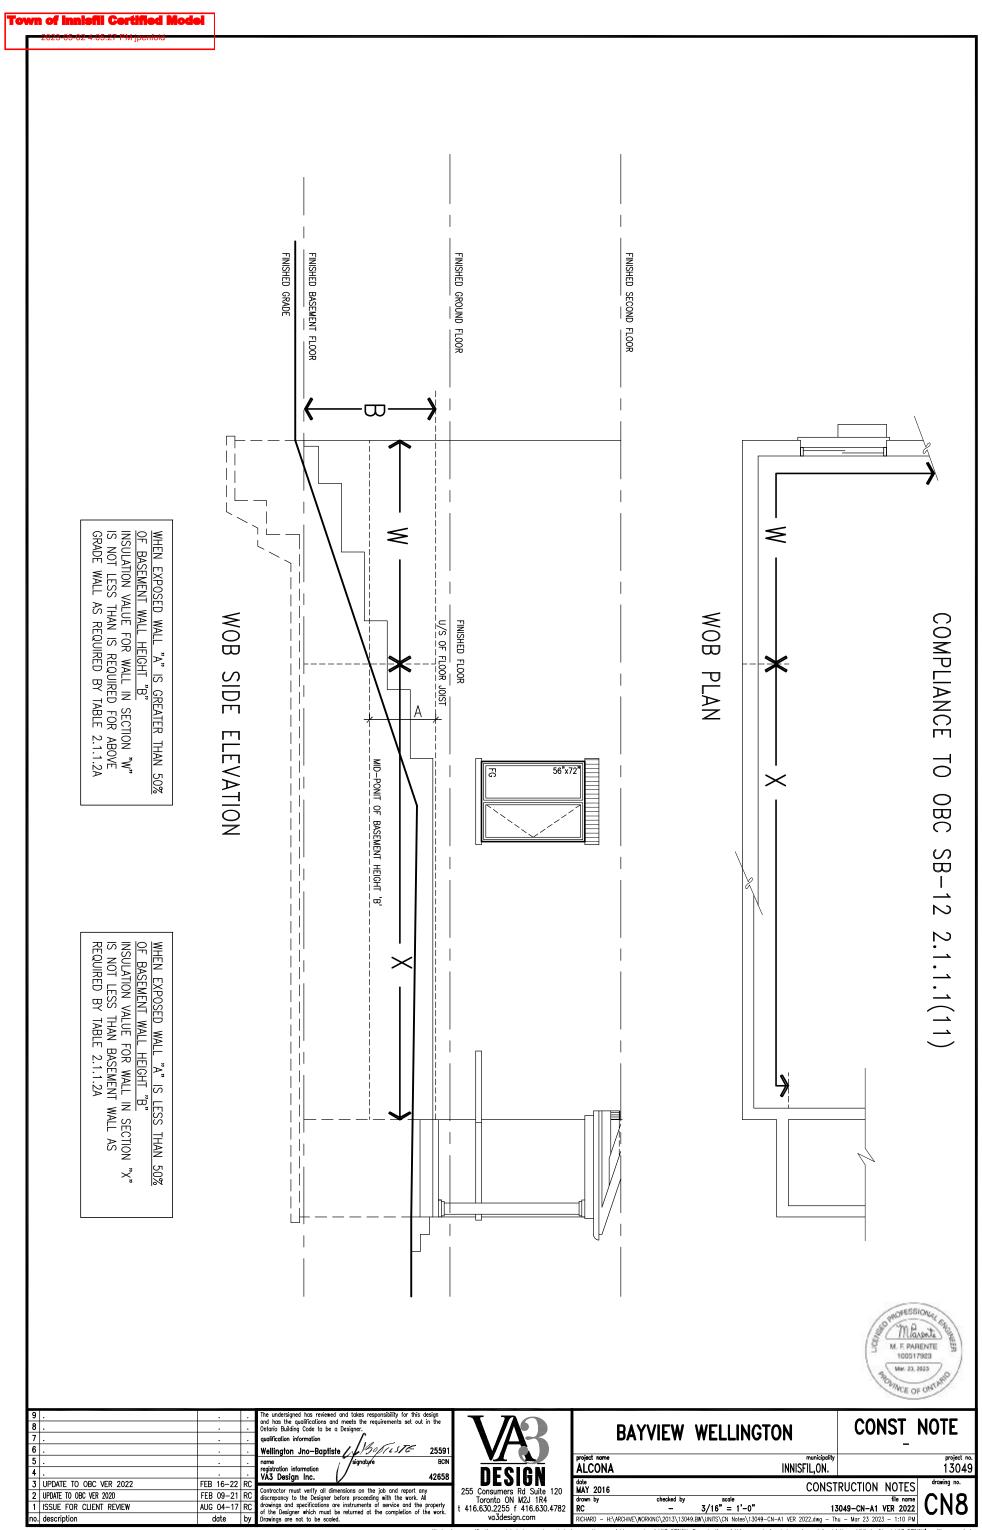

2022a05a02 4 05-27 Philipperfold

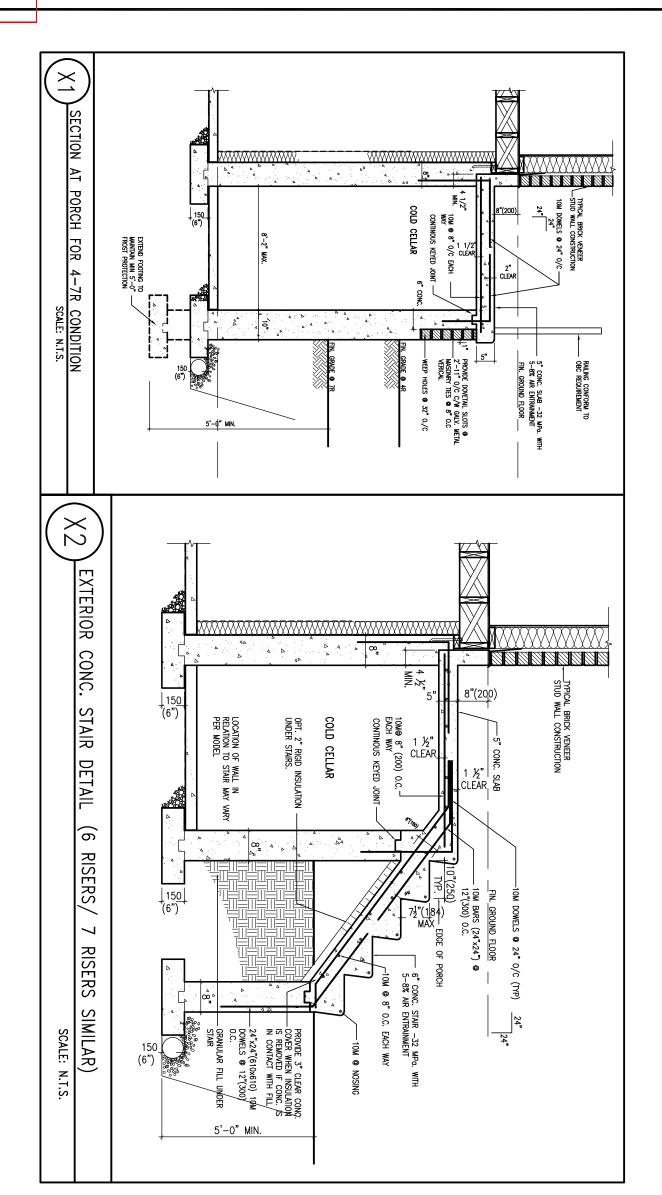





9			•		The undersigned has reviewed and takes responsibility for this design
8					and has the qualifications and meets the requirements set out in the Ontario Building Code to be a Designer.
7					qualification information
6					Wellington Jno-Baptiste / 1/50/16576 25591
5					name / signature BCIN
4					registration information VA3 Design Inc. 42658
3	UPDATE TO OBC VER 2022	FEB	16-22	RC	V
2	UPDATE TO OBC VER 2020	FEB	09-21	RC	Contractor must verify all dimensions on the job and report any discrepancy to the Designer before proceeding with the work. All
1	ISSUE FOR CLIENT REVIEW	AUG	04-17	RC	drawings and specifications are instruments of service and the property of the Designer which must be returned at the completion of the work.
nο	description		data	hv	Drawings are not to be easied



BA	YVIEW	COI	NST_	NOTE		
project name ALCONA			municipality INNISFIL,ON.			project no. 13049
date MAY 2016			CONST	RUCTION	NOTES	drawing no.
drawn by RC	checked by	3/16" = 1'-0"				CN9
	project name ALCONA date MAY 2016 drawn by RC	project name ALCONA dote MAY 2016 drawn by checked by RC –	project name ALCONA date MAY 2016 drawn by checked by scale RC - 3/16" = 1'-0"	project name ALCONA INNISFIL,ON.	Project name	project name ALCONA dote MAY 2016 drawn by checked by scale municipality INNISFIL,ON. CONSTRUCTION NOTES file name

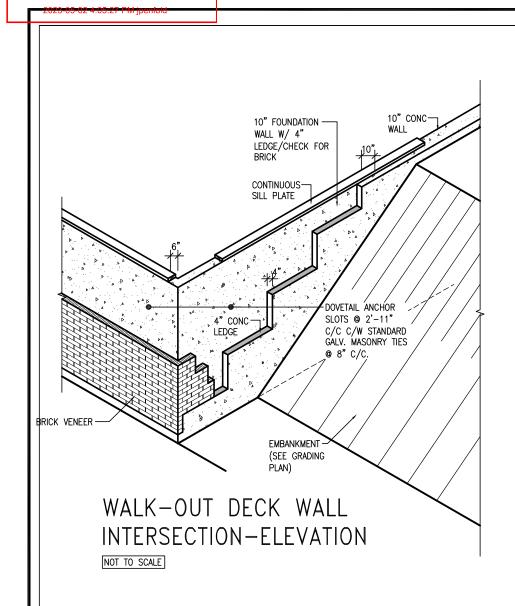

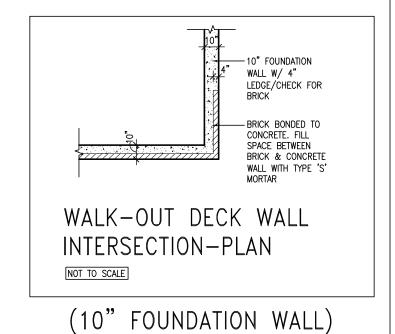


10" FOUNDATION — WALL W/ 4" LEDGE/CHECK FOR 10" CONC-WALL -TOP PLATE OF REAR TYPICAL STUD WALL W/ BRICK VENEER CONTINUOUS-CONNECT STUD WALL TO CONCRETE WALL W/ TAPCON SCREWS CONNECT STUD WALL TO CONCRETE WALL 10" FOUNDATION W/ 1/4"x3-1/4" WALL W/ 4" LEDGE/CHECK FOR BRICK TÁPCÓN SCREWS @ 12" C/C 10" FOUNDATION WALL MAX 4'-7"
FROM FIN GRADE TO DOVETAIL ANCHOR BRICK BONDED TO CONCRETE. FILL .SLOTS 🏻 2'-11" C/C C/W STANDARD
GALV. MASONRY TIES SPACE BETWEEN
BRICK & CONCRETE BRICK VENEER _**9**√8″ C/C. EMBANKMENT — (SEE GRADING WALL WITH TYPE 'S' TYPICAL STUD WALL W/ BRICK VENEER PLAN) 10" CONC BASEMENT FLOOR WALK-OUT BASEMENT WALL BASEMENT FLOOR INTERSECTION-PLAN NOT TO SCALE WALK-OUT DECK WALL (10" FOUNDATION WALL) INTERSECTION-ELEVATION MAX 4'-7" BACKFILL NOT TO SCALE





9				The undersigned has reviewed and takes responsibility for this design
8				and has the qualifications and meets the requirements set out in the Ontario Building Code to be a Designer.
7				qualification information
6				Wellington Jno-Baptiste JASOFILSTE 25591
5				name , /signatyre BCIN
4				registration information VA3 Design Inc. 42658
3	UPDATE TO OBC VER 2022	FEB 16-22		and the second s
2	UPDATE TO OBC VER 2020	FEB 09-21	RC	Contractor must verify all dimensions on the job and report any discrepancy to the Designer before proceeding with the work. All
1	ISSUE FOR CLIENT REVIEW	AUG 04-17	RC	drawings and specifications are instruments of service and the property of the Designer which must be returned at the completion of the work.
no.	description	date	by	Drawings are not to be scaled.



	BAYVIEW	WELLINGTON	CONST	NOTE
oroject name ALCONA	ı	municipality INNISFIL,ON.		project no. 13049
date MAY 2016		CONS	TRUCTION NOTES	drawing no.
drawn by RC	checked by		file name 3049-CN-A1 VER 2022	CN10
NUMBER 113	ADCUIVE WORKING 2017 1704	O DUALINITE CAL Makes 13040 CN A1 VED 2022 due 1	Terr. Mar. 27 2027 1.10 DM	

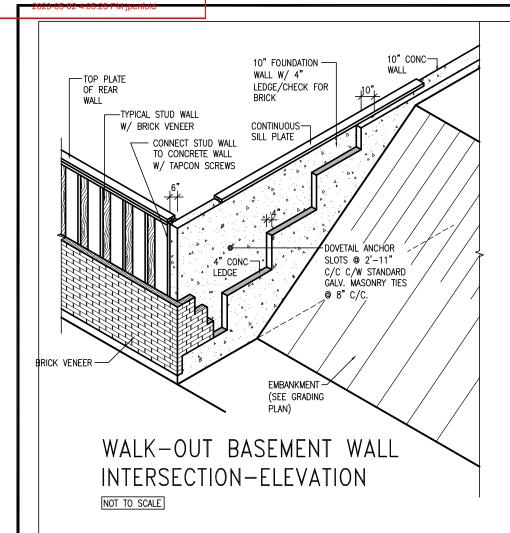

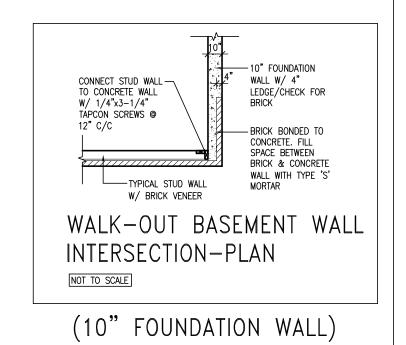

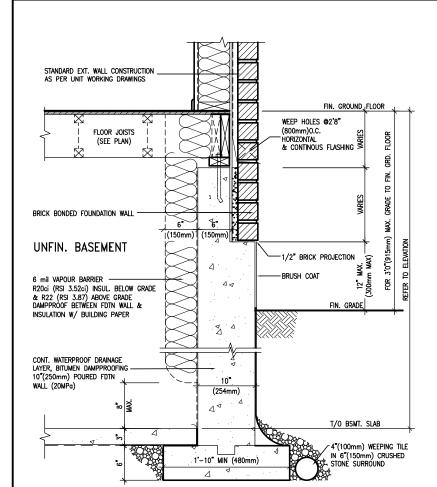


WALL SECTION FOR GRADE TO FIN.

FLOOR MORE THAN 4'7" (1400mm)

HEIGHT DIFFERENCE

SCALE: N.T.S.

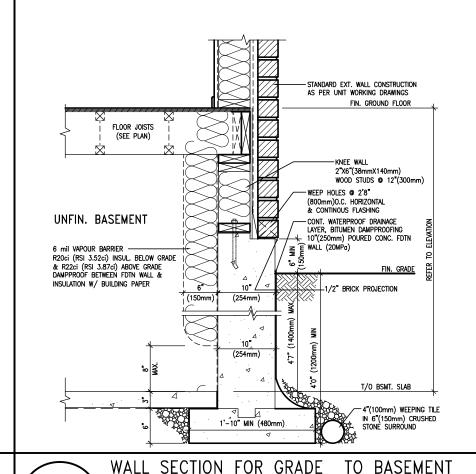

WALL SECTION FOR GRADE SLAB 4'7"(1400mm)
MAX. HEIGHT DIFFERENCE SCALE: N.T.S.





ı						
I	9			•		The undersigned has reviewed and takes responsibility for this design
	8					and has the qualifications and meets the requirements set out in the Ontario Building Code to be a Designer.
	7					qualification information
	6					Wellington Jno-Baptiste / 1/50/125/6 25591
	5					name / signature BCIN
ı	4					registration information VA3 Design Inc. 42658
	3	UPDATE TO OBC VER 2022	FEB	16-22	RC	, , , , , , , , , , , , , , , , , , ,
	2	UPDATE TO OBC VER 2020	FEB	09-21	RC	Contractor must verify all dimensions on the job and report any discrepancy to the Designer before proceeding with the work. All
	1	ISSUE FOR CLIENT REVIEW	AUG	04-17	RC	drawings and specifications are instruments of service and the property of the Designer which must be returned at the completion of the work.
ı	nΛ	description		data	hv	Drawings are not to be espled





EW3.07x

	BAYVIEW	WELLING	TON	COI	NST_	NOTE
oject name LCONA	ı		municipality INNISFIL,ON.			project no. 13049
ate AY 2016			CONST	RUCTION	NOTES	drawing no.
awn by C	checked by	3/16" = 1'-0"	13	049-CN-A1	file name VER 2022	CN11I

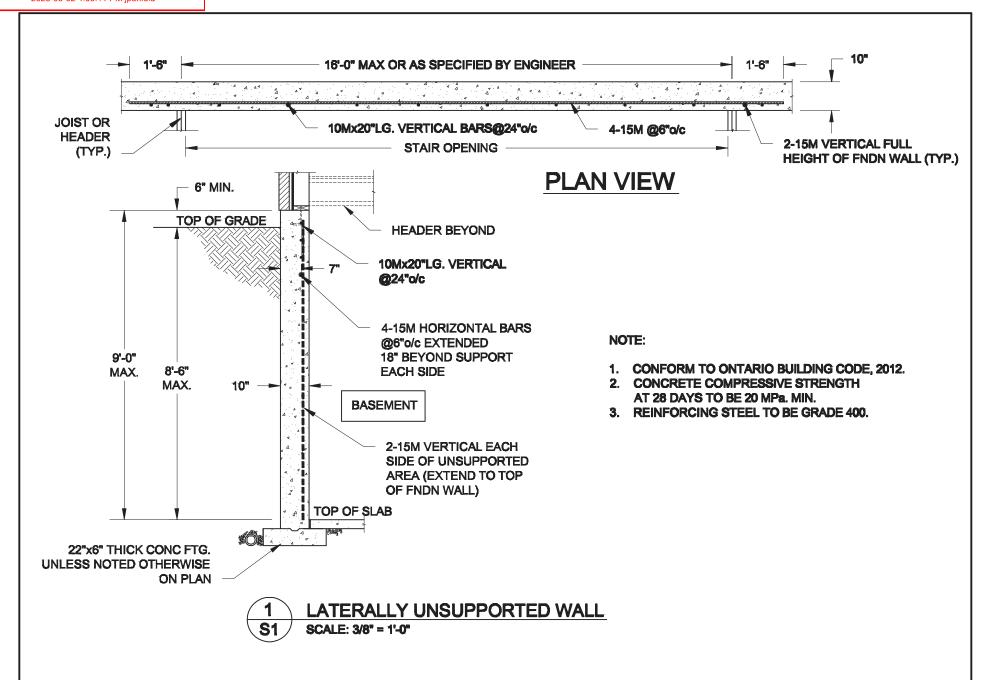


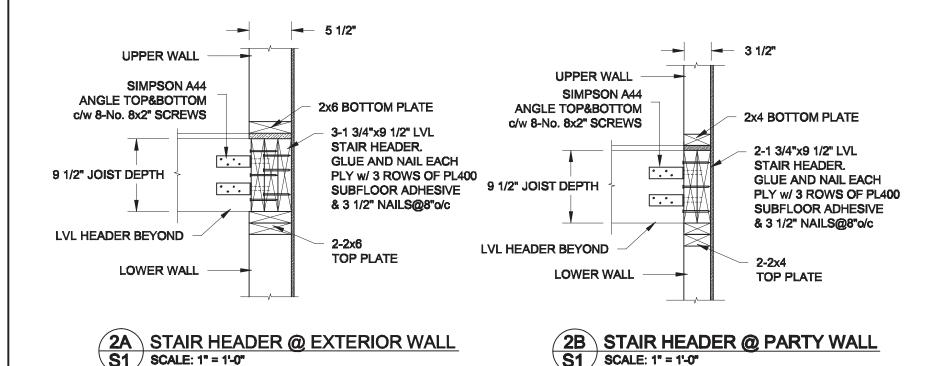

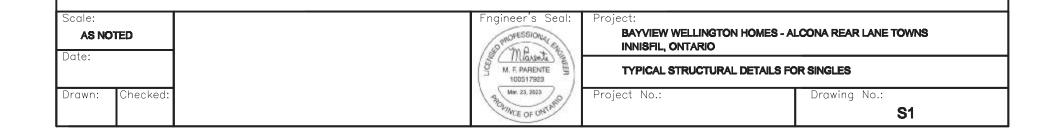


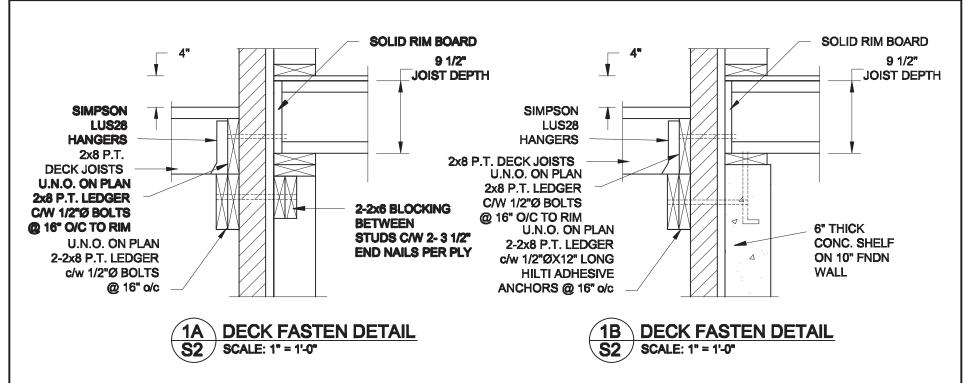

- NOTE: 1. WHERE BACKFILL HEIGHT < 4'-7", PROVIDE 2x6 @ 16" o/c KNEEWALL ON 10" THICK CONC FNDN WALL
 - 2. WHERE BACKFILL HEIGHT > 4"-7", PROVIDE 6" CONC SHELF FOR BRICK VENEER ON 10" THICK CONC FNDN WALL
 - 3. FOOTING TO BE 22"x6" THICK UNLESS NOTED OTHERWISE ON PLAN.

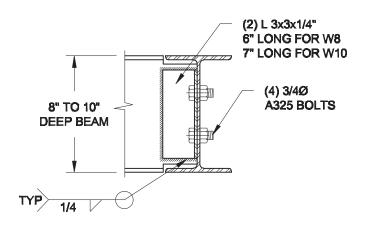


NOTE: DETAIL IS APPLICABLE TO W8x40 (W200x59) BEAM MAX AND W10x39 (W250x58) BEAM MAX.

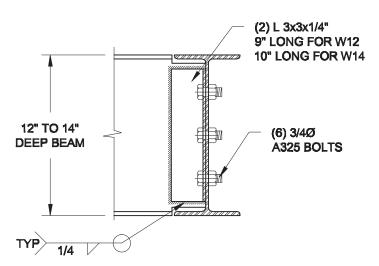

NOTE: DETAIL IS APPLICABLE TO W12x58 (W310x86) BEAM MAX AND W14x48 (W360x72) BEAM MAX.


2 STEEL BEAM CONNECTION DETAIL S2 SCALE: 1-1/2" = 1'-0"

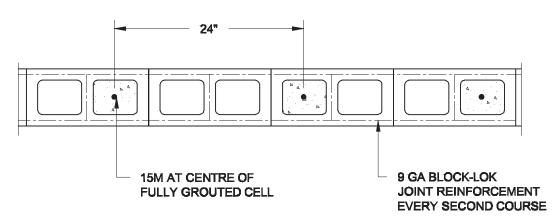

3 PLAN OF FIREWALL @ 2-STOREY CONDITION S2 SCALE: 1" = 1'-0"


NOTES:

- 1. REINFORCING STEEL TO CONFORM TO CSA G30.18, GRADE 400.
- 2. GROUT TO HAVE A COMPRESSIVE STRENGTH OF 20 MPa AT 28 DAYS WITH 10" SLUMP. MAXIMUM AGGREGATE SIZE = 3/8".
- 3. LAP VERTICAL BARS 30" AT ANY SPLICES.

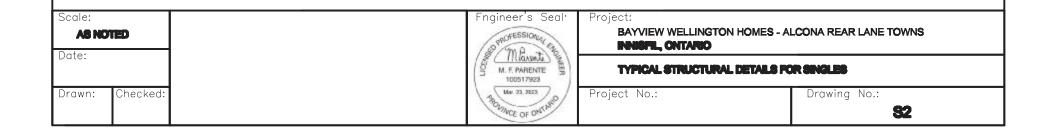

Town of Innisfii Certified Model

2023-05-02 4:05:28 PM jpenfold

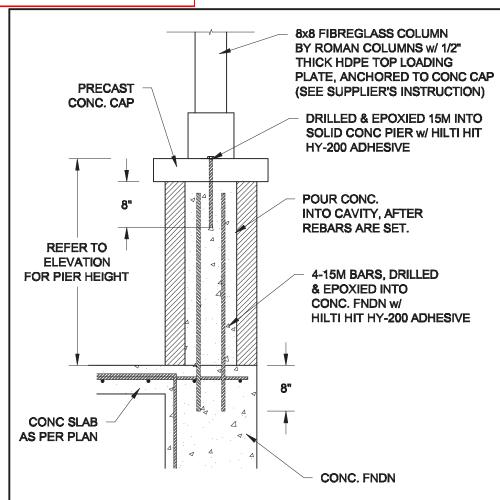

9"

1B TOP VIEW @ MASONRY PIER S3 SCALE: 3/4" = 1'-0"

NOTE:

- 1. CONFORM TO THE ONTARIO BUILDING CODE, 2012.
- 2. CONCRETE TO HAVE A 28 DAY MIN. COMPRESSIVE STRENGTH OF 20 MPa.
- 3. REINFORCING STEEL TO BE GRADE 400.
- 4. PROVIDE 2" CLEAR COVER FOR REBARS.

1A	FRONT PORCH COLUMN DETAIL
S3	SCALE: 3/4" = 1'-0"

Scale:	Fngineer's Seal: Project:			
AS NOTED Date:	BAYVIEW WELLINGT INNIEFIL, ONTARIO	BAYVIEW WELLINGTON HOMES - ALCONA REAR LANE TOWNS INNIETIL, ONTARIO		
Date.	I W BO	TYPICAL STRUCTURAL DETAILS FOR SINGLES		
Drawn: Checked:	Project No.:	Drawing No.:		