

## STRIP FOOTINGS

FOR SINGLES &amp; SEMIS UP TO 2 STOREY

8" OR 10" FOUNDATION WALLS WITH 2"x8" / 2"x10" FLOOR JOISTS  
20"x6" CONCRETE STRIP FOOTINGS BELOW FOUNDATION WALLS.  
24"x8" CONCRETE STRIP FOOTINGS BELOW PARTY WALLS.

FOUNDATION WALLS WITH ENGINEERED JOISTS OVER 16' SPANS  
24"x8" CONCRETE STRIP FOOTINGS BELOW FOUNDATION WALLS.

## FOOTINGS ON ENGINEERED FILL

24"x8" CONCRETE STRIP FOOTINGS WITH REINFORCING  
BELOW EXTERIOR WALLS.

30"x8" CONCRETE STRIP FOOTINGS WITH REINFORCING  
BELOW PARTY WALLS.

(REFER TO FOOTING DETAILS ON ENGINEERED FILL)

ASSUME THE LARGER FOOTING SIZE

WHEN TWO CONDITIONS APPLY

ASSUMED 120 KPa (18 p.s.i.) SOIL BEARING CAPACITY OR 90 KPa  
ENGINEERED SOIL FILL, TO BE VERIFIED ON SITE.

## PAD FOOTINGS

120 KPa NATIVE SOIL

F1 = 42"x42"x18" CONCRETE PAD

F2 = 36"x36"x16" CONCRETE PAD

F3 = 30"x30"x12" CONCRETE PAD

F4 = 24"x24"x12" CONCRETE PAD

F5 = 16"x16"x8" CONCRETE PAD

90 KPa ENGINEERED FILL SOIL

F1 = 48"x48"x20" CONCRETE PAD

F2 = 40"x40"x16" CONCRETE PAD

F3 = 34"x34"x14" CONCRETE PAD

F4 = 28"x28"x12" CONCRETE PAD

F5 = 18"x18"x8" CONCRETE PAD

(REFER TO FLOOR PLAN FOR UNUSUAL SIZE PADS NOT ON CHART)

WHEN VENEER CUT IS GREATER THAN 26" A 10" POURED CONC.  
FDTN. WALL IS REQUIRED.

ALL GARAGE SLABS, PORCH SLABS, STAIRS (EXPOSED CONC.  
FLAT WORK) TO BE 32 MPa WITH 5-8% AIR ENTRAINMENT

## BRICK VENEER LINTELS

ML1 = 3-1/2"x3-1/2"x1/4" (100x90x6.0L) + 2-2"x8" SPR. No.2

ML2 = 4"x3-1/2"x5/16" (100x90x8.0L) + 2-2"x8" SPR. No.2

ML3 = 5"x3-1/2"x5/16" (125x90x8.0L) + 2-2"x10" SPR. No.2

ML4 = 6"x3-1/2"x3/8" (150x90x10.0L) + 2-2"x12" SPR. No.2

ML5 = 6"x4"x3/8" (150x100x10.0L) + 2-2"x12" SPR. No.2

ML6 = 5"x3-1/2"x5/16" (125x90x8.0L) + 2-2"x12" SPR. No.2

ML7 = 5"x3-1/2"x5/16" (125x90x8.0L) + 3-2"x10" SPR. No.2

ML8 = 5"x3-1/2"x5/16" (125x90x8.0L) + 3-2"x12" SPR. No.2

ML9 = 6"x4"x3/8" (150x100x10.0L) + 3-2"x12" SPR. No.2

## WOOD LINTELS AND BEAMS

WB1 = 2-2"x8" SPR. No.2 (2-38x184 SPR. No.2)

WB2 = 3-2"x8" SPR. No.2 (3-38x184 SPR. No.2)

WB3 = 2-2"x10" SPR. No.2 (2-38x235 SPR. No.2)

WB4 = 3-2"x10" SPR. No.2 (3-38x235 SPR. No.2)

WB5 = 2-2"x12" SPR. No.2 (2-38x286 SPR. No.2)

WB6 = 3-2"x12" SPR. No.2 (3-38x286 SPR. No.2)

WB7 = 5-2"x12" SPR. No.2 (5-38x286 SPR. No.2)

WB8 = 4-2"x10" SPR. No.2 (4-38x235 SPR. No.2)

WB9 = 4-2"x12" SPR. No.2 (4-38x286 SPR. No.2)

## LAMINATED VENEER LUMBER (LVL) BEAMS

LVL1A = 1-1 3/4" x 7 1/4" (1-45x184)

LVL1 = 2-1 3/4" x 7 1/4" (2-45x184)

LVL2 = 3-1 3/4" x 7 1/4" (3-45x184)

LVL3 = 4-1 3/4" x 7 1/4" (4-45x184)

LVL4A = 1-1 3/4" x 9 1/2" (1-45x240)

LVL4 = 2-1 3/4" x 9 1/2" (2-45x240)

LVL5 = 3-1 3/4" x 9 1/2" (3-45x240)

LVL5A = 4-1 3/4" x 9 1/2" (4-45x240)

LVL6A = 1-1 3/4" x 11 7/8" (1-45x300)

LVL6 = 2-1 3/4" x 11 7/8" (2-45x300)

LVL7 = 3-1 3/4" x 11 7/8" (3-45x300)

LVL7A = 4-1 3/4" x 11 7/8" (4-45x300)

LVL8 = 2-1 3/4" x 14" (2-45x356)

LVL9 = 3-1 3/4" x 14" (3-45x356)

LVL10 = 2-1 3/4" x 18" (2-45x456)

## LOOSE STEEL LINTELS

L1 = 3-1/2"x3-1/2"x1/4" (100x90x6.0L)

L2 = 4"x3-1/2"x5/16" (100x90x8.0L)

L3 = 5"x3-1/2"x5/16" (125x90x8.0L)

L4 = 6"x3-1/2"x3/8" (150x90x10.0L)

L5 = 6"x4"x3/8" (150x100x10.0L)

L6 = 7"x4"x3/8" (175x100x10.0L)

## DOOR SCHEDULE

NOS.	WIDTH	HEIGHT 8'-4" CEILING	HEIGHT 10' OR MORE CEILING	TYPE
1	2'-10"	6'-8"	8'-0"	INSULATED ENTRANCE DOOR
1a	2'-8"	6'-8"	8'-0"	INSULATED FRONT DOORS
2	2'-8"	6'-8"	8'-0"	WOOD & GLASS DOOR
3	2'-8"	6'-8"	8'-0"	EXTERIOR SLAB DOOR
4	2'-8"	6'-8"	8'-0"	INTERIOR SLAB DOOR
5	2'-6"	6'-8"	8'-0"	INTERIOR SLAB DOOR
6	2'-2"	6'-8"	8'-0"	INTERIOR SLAB DOOR
7	1'-6"	6'-8"	8'-0"	INTERIOR SLAB DOOR


SPACE CONVENTIONAL FLOOR JOISTS @ 12"  
O.C. BELOW ALL CERAMIC TILE AREAS.  
PROVIDE 1 ROW BRIDGING FOR SPANS OF  
5'-7", 2 ROWS FOR SPANS GREATER THAN 7'

REFER TO ROOF TRUSS SHOP DRAWINGS FOR  
ALL ROOF FRAMING INFORMATION

PLANS NOT DRAWN TO ACTUAL GRADE. REFER  
TO FINAL GRADING PLAN.

REFER TO FLOOR FRAMING SHOP DRAWINGS  
FOR ENGINEERED FRAMING LAYOUTS


2-2"x6" STUD WALL NAILED TOGETHER AND  
SPACED @ 12" O.C. FULL HT C/M SOLID  
BLOCKING 4'-0" O.C. VERTICAL AND 7/16"  
EXT. PLYWOOD SHEATHING.

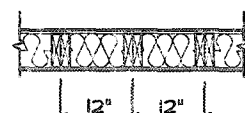

NOTE: MAXIMUM HEIGHT OF WALL  
FOR THIS DETAIL IS 19'-0"

## TWO STORY HEIGHT WALL DETAIL


2 - 1 1/2" x 5 1/2" TIMBERSTRAND (LSL) USE  
STUD WALL GLUED AND NAILED TOGETHER  
AND SPACED MAX. @ 10" O.C. FULL HT C/M  
SOLID BLOCKING MAX. 8'-0" O.C. VERTICAL  
AND 7/16" EXT. OSB SHEATHING.

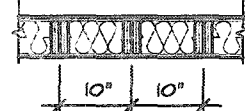

NOTE: MAXIMUM HEIGHT OF WALL FOR THIS  
DETAIL IS 20'-2" AND MAXIMUM WIDTH  
IS 40'-0"

## TWO STORY HEIGHT WALL DETAIL

2 - 1 1/2" x 5 1/2" TIMBERSTRAND (LSL) USE  
STUD WALL GLUED AND NAILED TOGETHER  
AND SPACED MAX. @ 10" O.C. FULL HT C/M  
SOLID BLOCKING MAX. 8'-0" O.C. VERTICAL  
AND 7/16" EXT. OSB SHEATHING.

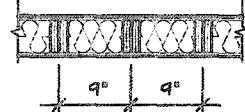

NOTE: MAXIMUM HEIGHT OF WALL FOR THIS  
DETAIL IS 21'-5" AND MAXIMUM WIDTH IS  
40'-0"

## TWO STORY HEIGHT WALL DETAIL

C1 = 4"x4"x1/4" H.S.S.  
W/ 10"x8"x1/2" BASE PLATE & 2-3/4" DIA.  
ANCHOR BOLTS  
C2 = 5"x5"x1/4" H.S.S.  
W/ 12"x12"x1/2" BASE PLATE & 4-3/4" DIA.  
ANCHOR BOLTS

USE 4 BOLTS FOR MOMENT CONNECTION

"M" - MOMENT CONNECTION BEAM/COLUMN  
= 35 kNm

## AREA CALCULATIONS

ELEV. 2

GROUND FLOOR AREA	=	1276	Sq. Ft.
SECOND FLOOR AREA	=	1646	Sq. Ft.
TOTAL FLOOR AREA	=	2922	Sq. Ft.
	=	271.46	Sq. M.
1ST FLOOR OPEN AREA	=	0	Sq. Ft.
2ND FLOOR OPEN AREA	=	11	Sq. Ft.
ADD TOTAL OPEN AREAS	=	11	Sq. Ft.
ADD FIN. BASEMENT AREA	=	0	Sq. Ft.
GROSS FLOOR AREA	=	2933	Sq. Ft.
	=	272.48	Sq. M.
GROUND FLOOR COVERAGE	=	1276	Sq. Ft.
GARAGE COVERAGE / AREA	=	347	Sq. Ft.
PORCH COVERAGE / AREA	=	58	Sq. Ft.
TOTAL COVERAGE W/ PORCH	=	1731	Sq. Ft.
	=	160.82	Sq. m.
TOTAL COVERAGE W/O PORCH	=	1673	Sq. Ft.
	=	155.43	Sq. m.

## VALLEYCREEK

ELEV. 2

ELEVATION	WALL FT	WALL MT	OPENING FT	OPENING MT	PERCENTAGE
FRONT	746.53	64.35	157.08	14.59	21.04 %
LEFT SIDE	1331.79	123.73	65.75	6.11	4.94 %
RIGHT SIDE	1377.54	128.01	48.00	4.46	3.48 %
REAR	831.53	77.25	163.62	15.20	19.68 %
TOTAL	4287.79	398.35	434.45	40.36	10.13 %

THE MINIMUM THERMAL PERFORMANCE OF BUILDING  
ENVELOPE AND EQUIPMENT SHALL CONFORM TO THE  
FOLLOWING

## COMPLIANCE PACKAGE "A1"

COMPONENT	NOTE
CEILING WITH ATTIC SPACE MINIMUM RSI (R) VALUE	10.51 (R60)
CEILING WITHOUT ATTIC SPACE MINIMUM RSI (R) VALUE	5.46 (R31)
EXPOSED FLOOR MINIMUM RSI (R) VALUE	5.46 (R31)
WALLS ABOVE GRADE MINIMUM RSI (R) VALUE	3.51 (R22)
BASEMENT WALLS MINIMUM RSI (R) VALUE	3.52 (R20 BLANKET)
HEATED SLAB OR SLAB < 600mm BELOW GRADE MINIMUM RSI (R) VALUE	1.76 (R10)
WINDOWS & SLIDING GLASS DOORS MAXIMUM U-VALUE	ENERGY RATING = 25, MAX. U=0.28
SPACE HEATING EQUIPMENT MINIMUM AFUE	96%
HVAC MINIMUM EFFICIENCY	75%
HOT WATER TANK	MIN. EF 0.80

CITY OF HAMILTON  
Building Division

Permit No. 21-107128

THESE STAMPED DRAWINGS SHALL BE AVAILABLE ON SITE

THE OWNER AND/OR CONTRACTOR SHALL COMPLY WITH  
THE ONTARIO BUILDING CODE AND ALL OTHER APPLICABLE LAW


These drawings and/or specifications have been reviewed by

FOR CHIEF BUILDING OFFICIAL

MAR 30 2021

DATE

STRUDET INC.

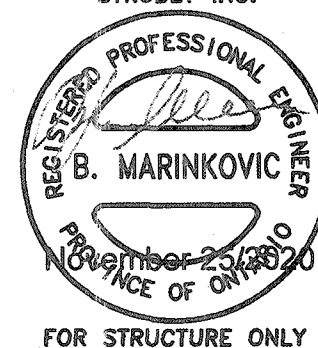

FOR STRUCTURE ONLY

VALLEYCREEK 5-269

COMPLIANCE PACKAGE "A1"

5		
4		
3		
2	UPDATED FOR LOT 269	NOV 2020
1	ISSUED FOR COORDINATION	JAN 2020

## REVISIONS

The undersigned has reviewed and takes responsibility for this  
design, and has the qualifications and meets the requirements set  
out in the Ontario Building Code to be a designer.

QUALIFICATION INFORMATION  
Required unless design is exempt under Division C, Subsection 3.2.5 of the building code

VIKAS GAJJAR  
NAME

28770  
BCINREGION DESIGN INC.  
8700 DUFFERIN ST.  
CONCORD, ONTARIO

L4K 4S6

P (416) 736-4096

F (905) 660-0746

REGION DESIGN INC.

## SHEET TITLE

GENERAL NOTES  
& CHARTS

SCALE

BY VG

DATE DEC 2019

TYPE

CONTRACTOR SHALL CHECK ALL  
DIMENSIONS AND ELEVATIONS BEFORE  
COMMENCING WITH WORK AND REPORT  
ANY DISCREPANCIES TO THE DESIGNER.  
PRINTS ARE NOT TO BE SCALED.

AREA 2,930

PROJECT 12-04-19

PAGE No.


0

Greenpark

PROJECT NAME

RUSSELL GARDENS III



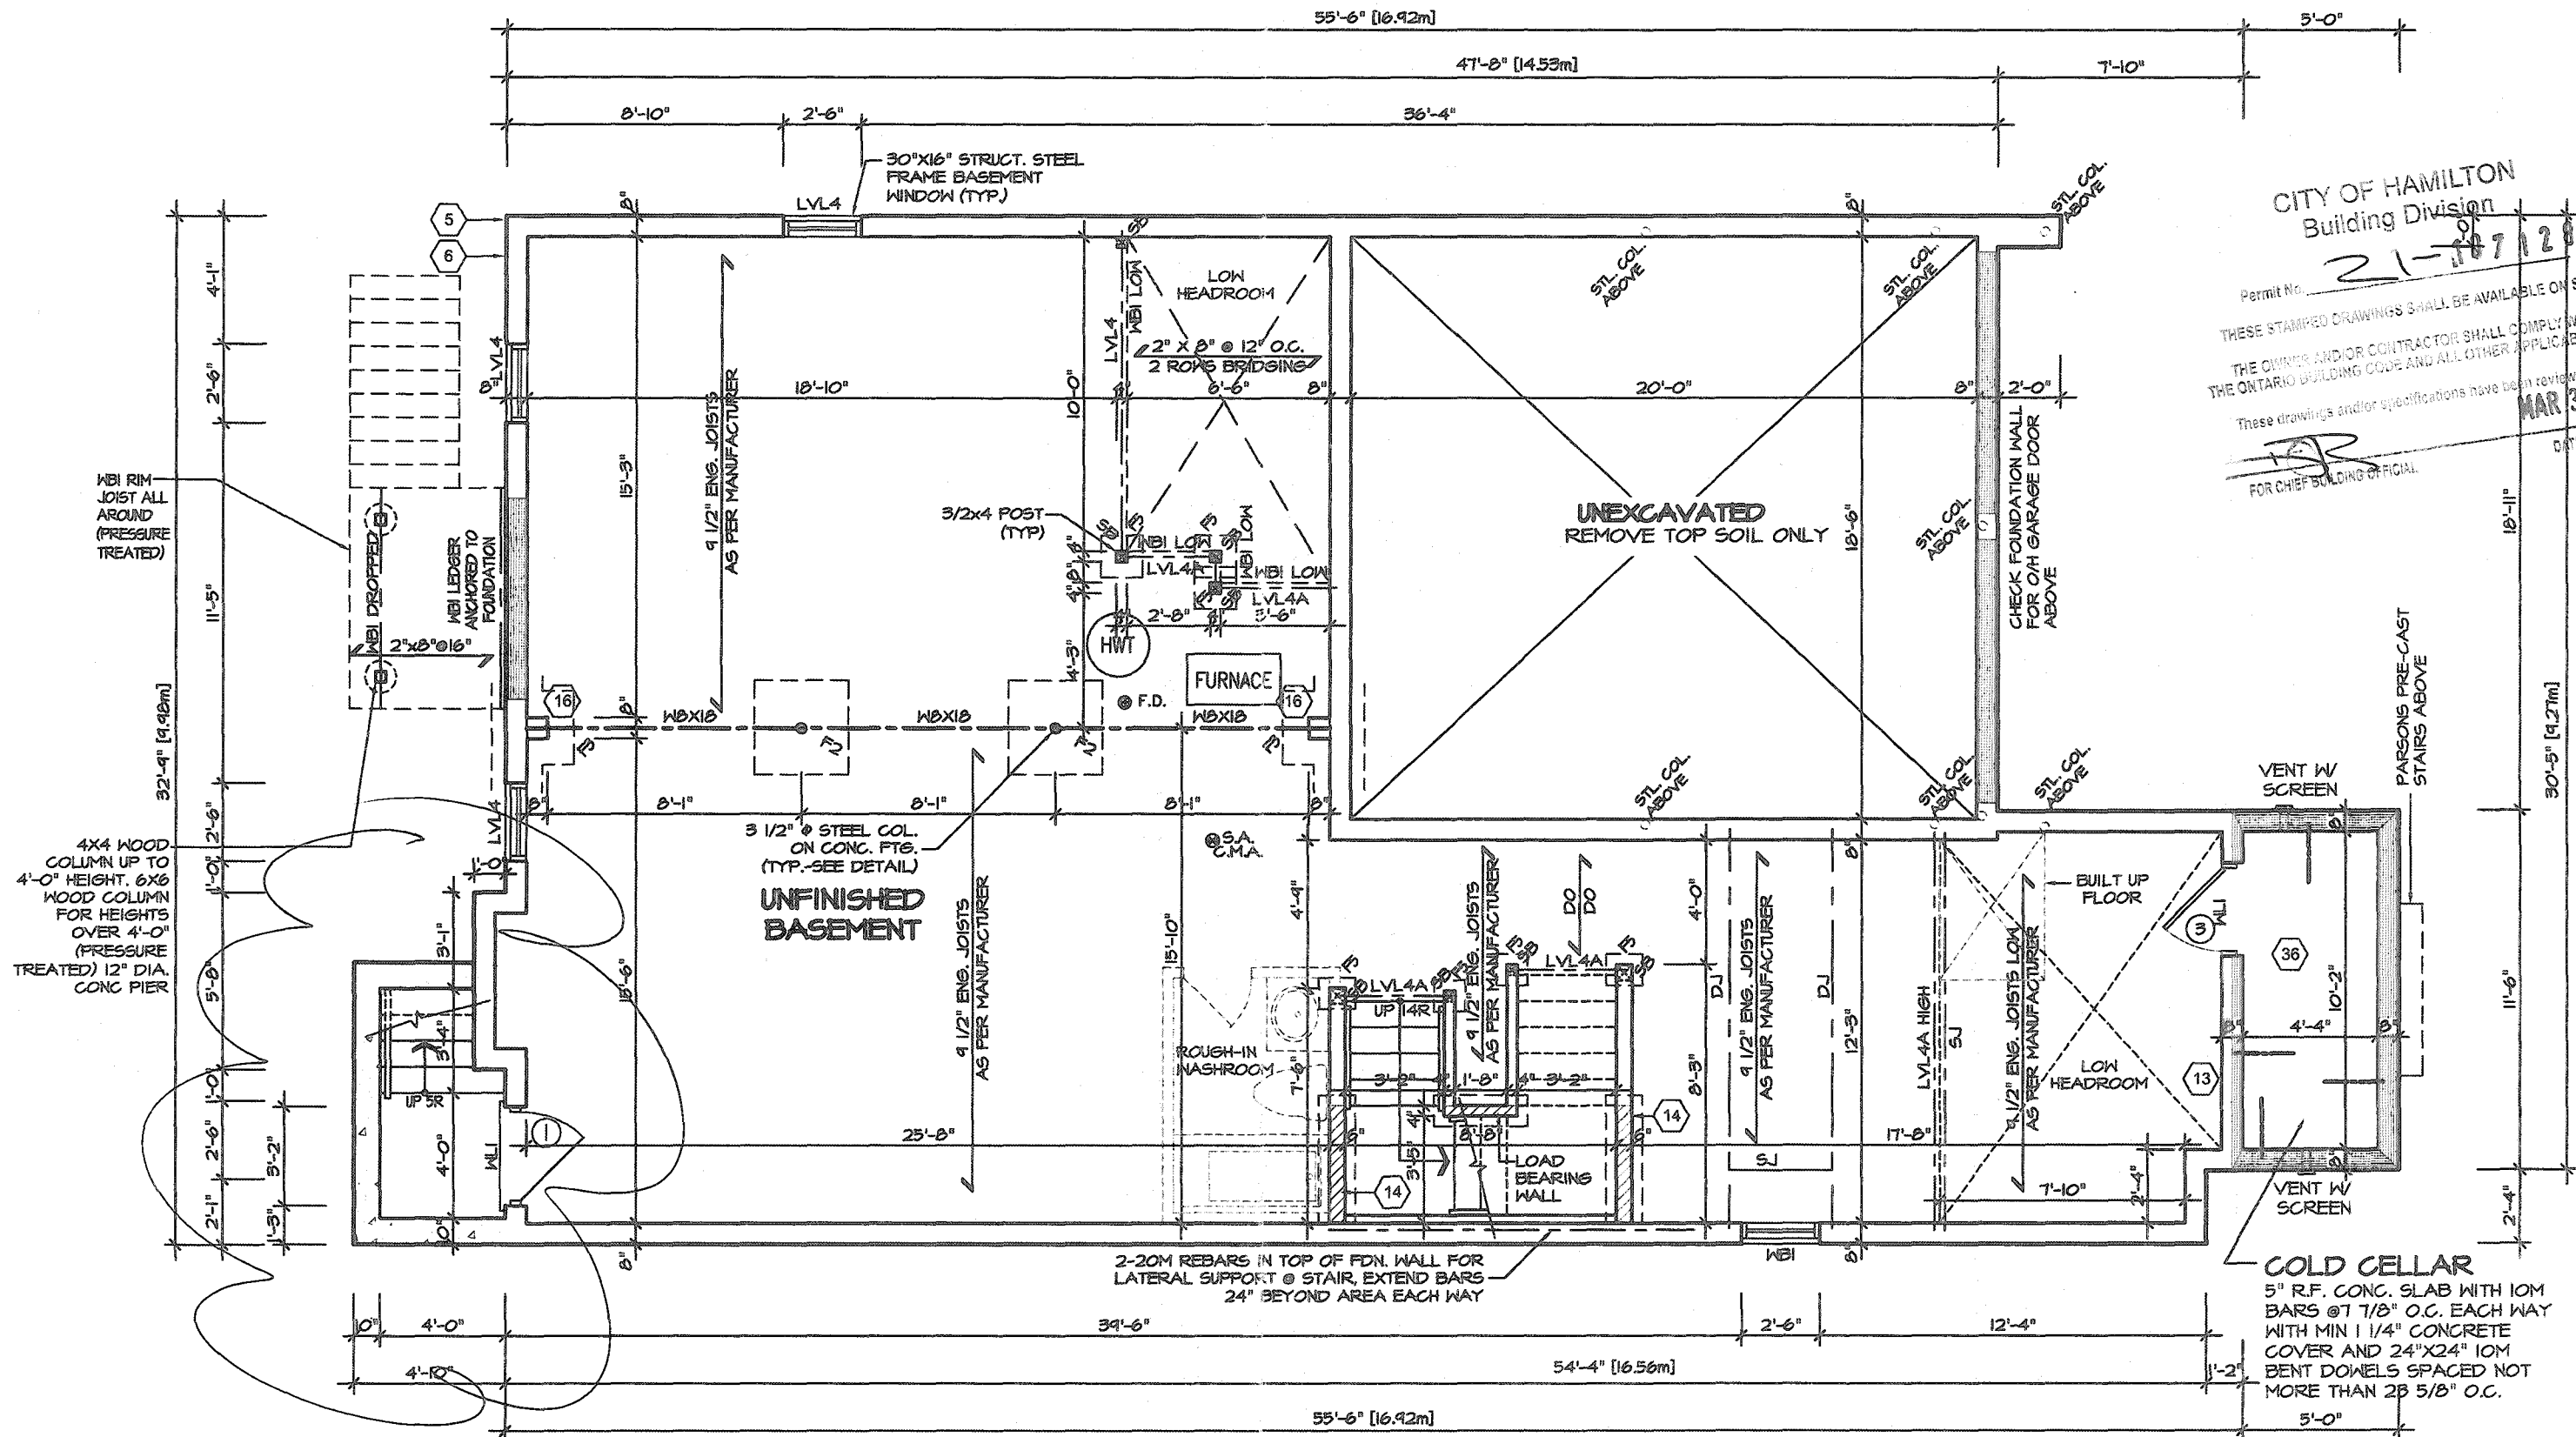

CITY OF HAMILTON  
Building Division  
Permit No. 21-107128  
THESE STAMPED DRAWINGS SHALL BE AVAILABLE ON SITE  
THE OWNER AND/OR CONTRACTOR SHALL COMPLY WITH  
THE ONTARIO BUILDING CODE AND ALL OTHER APPLICABLE LAW  
These drawings and/or specifications have been reviewed by  
FOR CHIEF BUILDING OFFICIAL  
DATE MAR 30 2021

REVISED FOR  
BASEMENT  
WALKOUT

## BASEMENT FLOOR PLAN 2

REFER TO FLOOR FRAMING SHOP  
DRAWINGS FOR ENGINEERED FRAMING  
LAYOUTS

ALL SUBFLOORS TO BE 3/4" PLYWOOD AND  
TO BE GLUED AND NAILED ON THIS FLOOR.

REFER TO SHEET NO. 0 FOR LINTEL, BEAMS  
AND DOOR SIZES


SPACE CONVENTIONAL FLOOR JOISTS @ 12"  
O.C. BELOW ALL CERAMIC TILE AREAS.  
PROVIDE 1 ROW BRIDGING FOR SPANS OF  
5'-1", 2 ROWS FOR SPANS GREATER THAN 7'

**COLD CELLAR**  
5" R.F. CONC. SLAB WITH 10M  
BARS @ 7 1/8" O.C. EACH WAY  
WITH MIN 1 1/4" CONCRETE  
COVER AND 24"X24" 10M  
BENT DOWELS SPACED NOT  
MORE THAN 28 5/8" O.C.

It is the builder's complete responsibility to  
ensure that all plans submitted for approval  
fully comply with the Architectural Guidelines  
and all applicable regulations and requirements  
including zoning provisions and any provisions  
in the subdivision agreement. The Control  
Architect is not responsible in any way for  
examining or approving site (lotting) plans or  
working drawings with respect to any zoning or  
building code or permit matter or that any  
house can be properly built or located on its lot.

This is to certify that these plans comply  
with the applicable Architectural Design  
Guidelines approved by the City of  
HAMILTON

STRUDET INC.

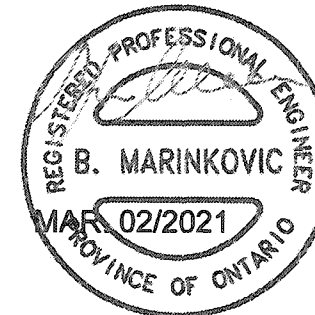

FOR STRUCTURE ONLY

# VALLEYCREEK 5-269

COMPLIANCE PACKAGE "A1"

REVISIONS		
5.		
4.		
3.		
2.	UPDATED FOR LOT 269	NOV 2020
1.	ISSUED FOR COORDINATION	JAN 2020

The undersigned has reviewed and takes responsibility for this design, and has the qualifications and meets the requirements set out in the Ontario Building Code to be a designer.

QUALIFICATION INFORMATION  
Required unless design is exempt under Division C, Subsection 3.2.5 of the building code

VIKAS GAJJAR  
NAME  
28770  
SIGNATURE  
BCIN

REGION DESIGN INC.  
8700 DUFFERIN ST.  
CONCORD, ONTARIO  
L4K 4S6  
P (416) 738-4098  
F (905) 660-0746

REGION  
DESIGN  
INC.

SHEET TITLE  
**BASEMENT PLAN  
ELEVATION 2**

SCALE  
3/16"=1'-0"  
DATE  
DEC 2019

BY  
VG  
TYPE

CONTRACTOR SHALL CHECK ALL  
DIMENSIONS AND ELEVATIONS BEFORE  
COMMENCING WITH WORK AND REPORT  
ANY DISCREPANCIES TO THE DESIGNER.  
PRINTS ARE NOT TO BE SCALED.


AREA  
2,930  
PROJECT  
12-04-19

PAGE No.  
**1-2**

**Greenpark**

PROJECT NAME  
**RUSSELL GARDENS III**




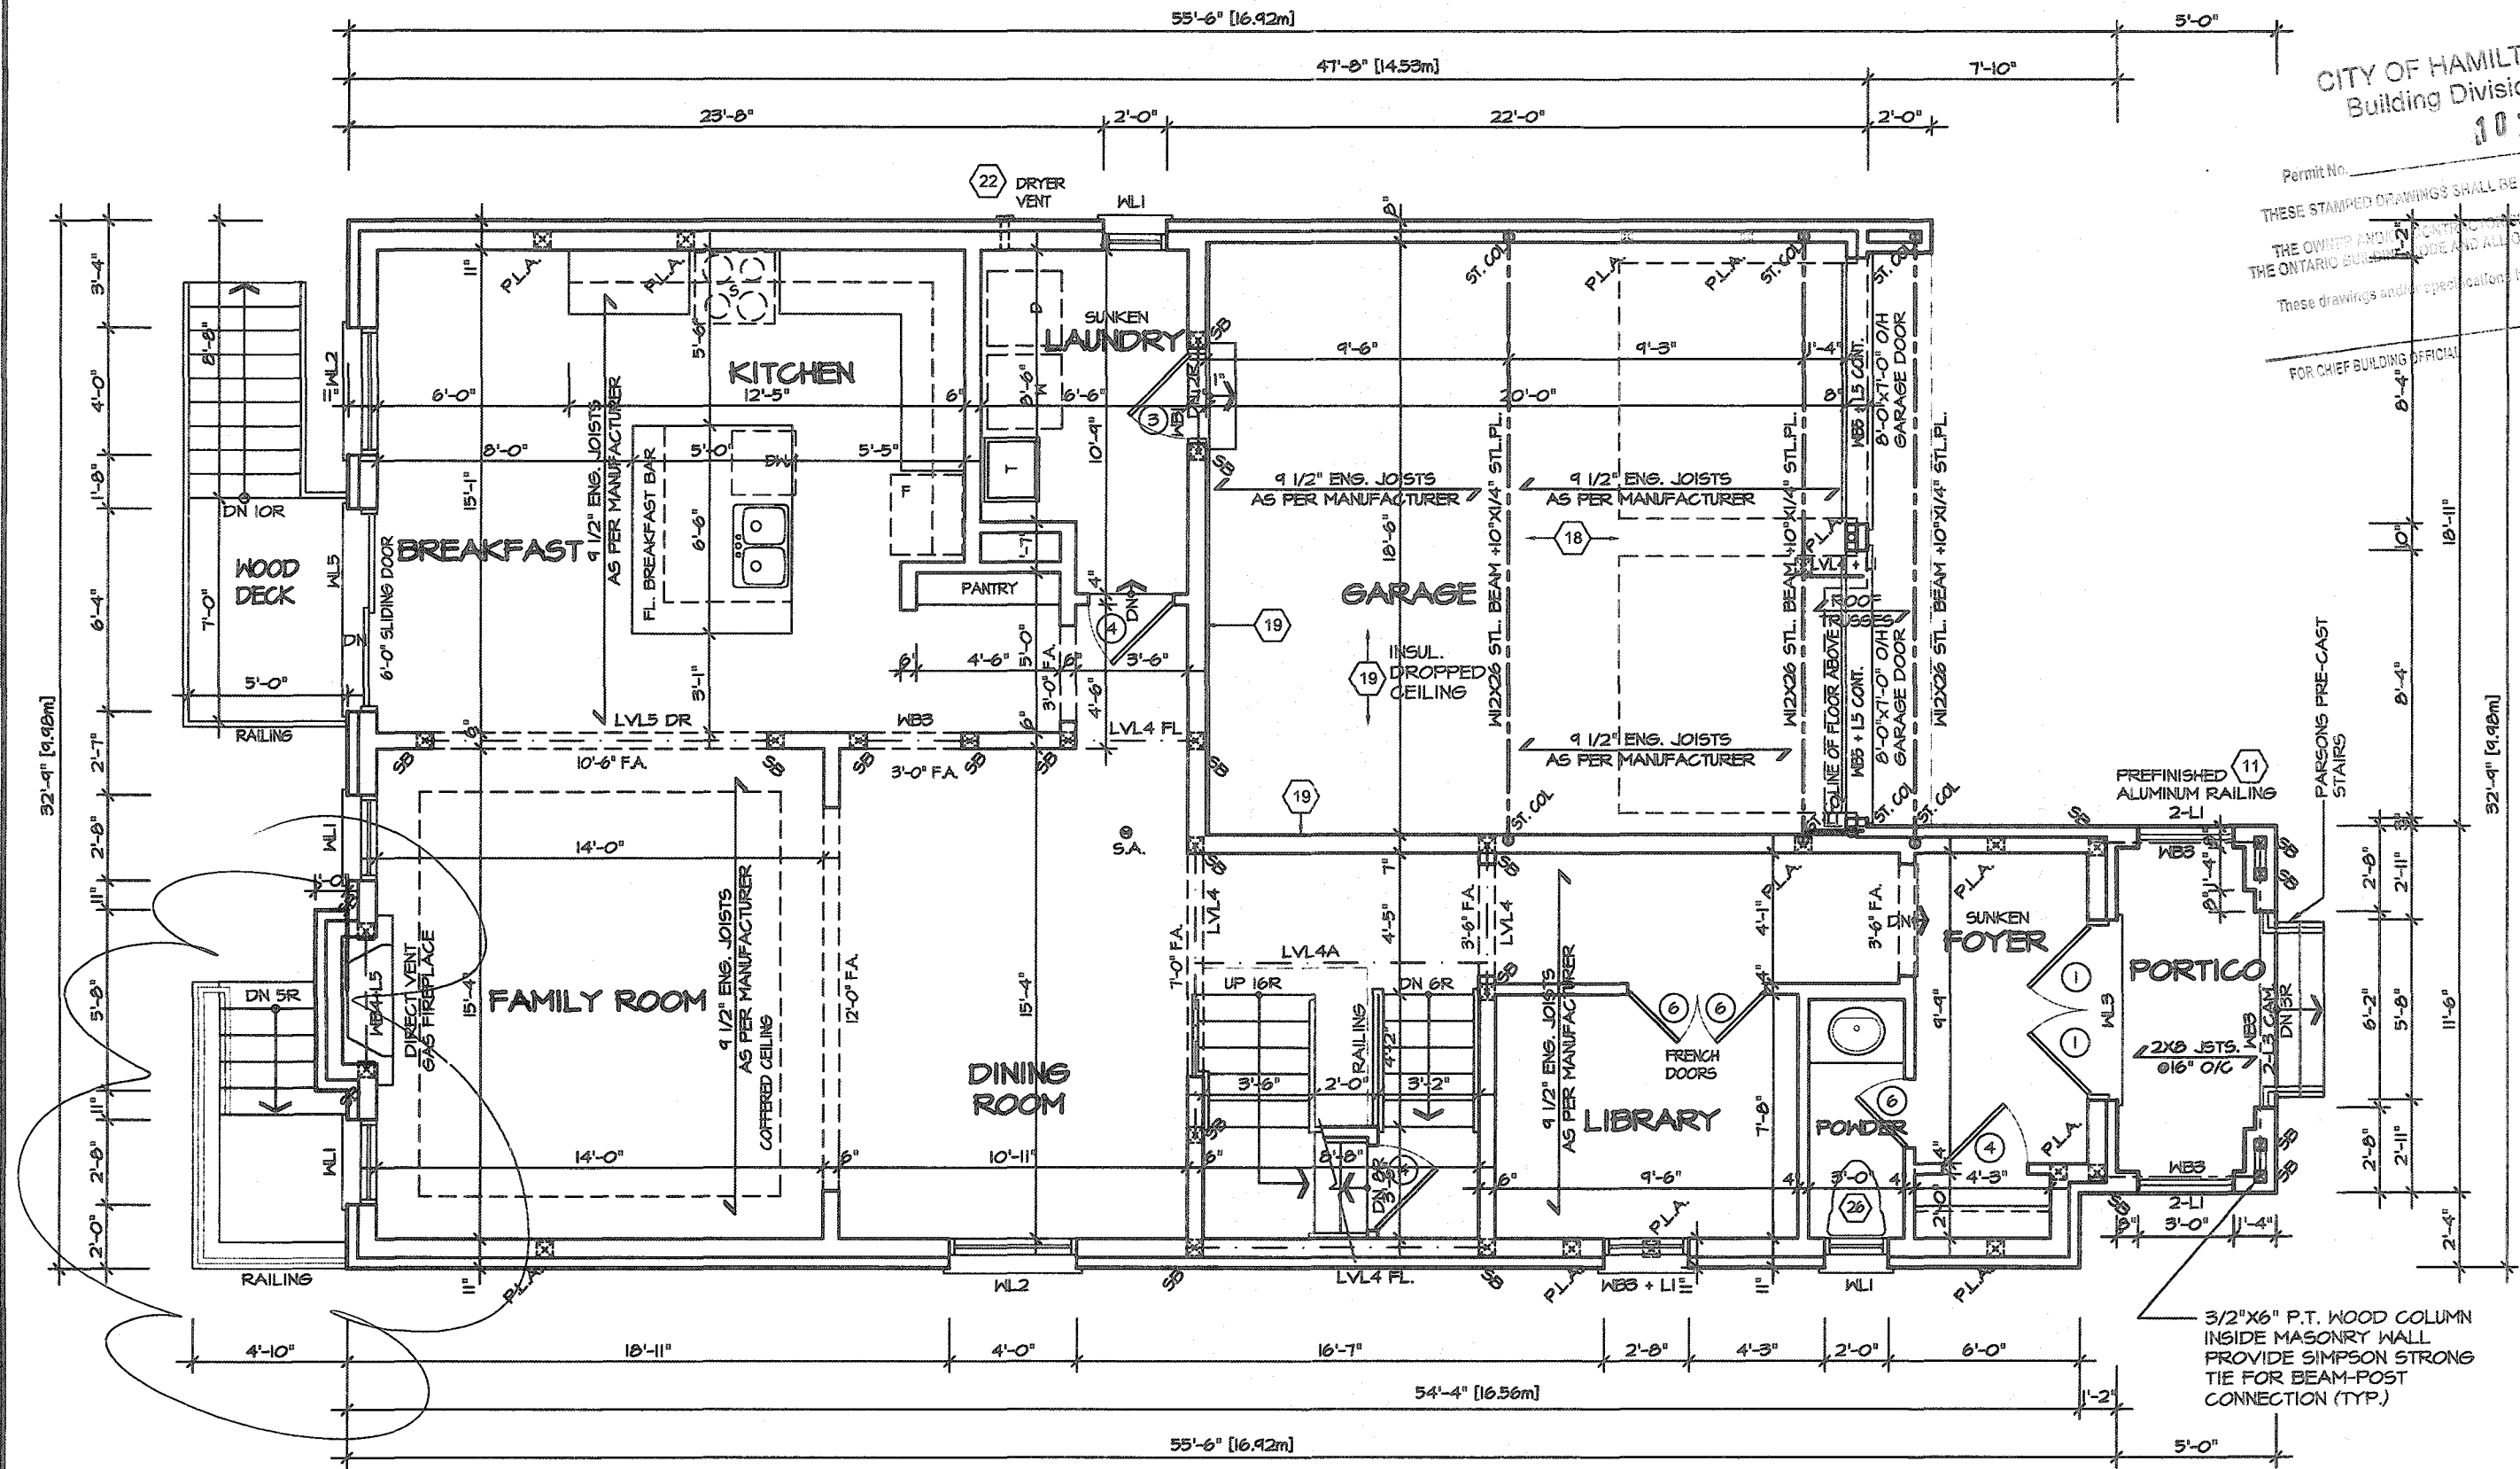

CITY OF HAMILTON  
Building Division  
107128  
Permit No. \_\_\_\_\_  
THESE STAMPED DRAWINGS SHALL BE AVAILABLE ON SITE  
THE OWNER AND CONTRACTOR SHALL COMPLY WITH  
THE ONTARIO BUILDING CODE AND ALL OTHER APPLICABLE LAW  
These drawings and specifications have been reviewed by  
MAR 30 2021  
DATE  
FOR CHIEF BUILDING OFFICIAL

REVISED FOR  
BASEMENT  
WALKOUT

FIRST FLOOR PLAN 2

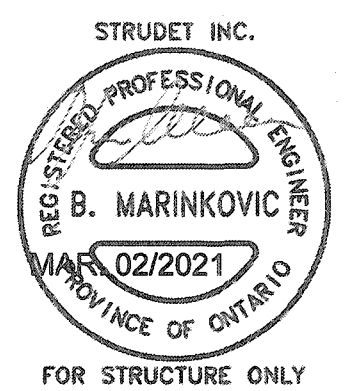

VALLEYCREEK 5-269  
COMPLIANCE PACKAGE "A1"

It is the builder's complete responsibility to ensure that all plans submitted for approval fully comply with the Architectural Guidelines and all applicable regulations and requirements including zoning provisions and any provisions in the subdivision agreement. The Control Architect is not responsible in any way for examining or approving site (lotting) plans or working drawings with respect to any zoning or building code or permit matter or that any house can be properly built or located on its lot.

This is to certify that these plans comply with the applicable Architectural Design Guidelines approved by the City of HAMILTON

REVISIONS	
5.	
4.	
3.	
2.	UPDATED FOR LOT 269 NOV 2020
1.	ISSUED FOR COORDINATION JAN 2020

The undersigned has reviewed and takes responsibility for this design, and has the qualifications and meets the requirements set out in the Ontario Building Code to be a designer.

QUALIFICATION INFORMATION  
Required unless design is exempt under Division C, Subsection 3.2.5 of the building code

VIKAS GAJJAR  
NAME  
28770  
SIGNATURE  
BCIN

REGION DESIGN INC.  
8700 DUFFERIN ST.  
CONCORD, ONTARIO  
L4K 4S5  
P (416) 738-4098  
F (905) 860-0746

**REGION  
DESIGN  
INC.**

SHEET TITLE  
FIRST FLOOR  
ELEVATION 2

SCALE  
3/16"=1'-0"

DATE  
DEC 2019

BY  
VG

TYPE

CONTRACTOR SHALL CHECK ALL DIMENSIONS AND ELEVATIONS BEFORE COMMENCING WITH WORK AND REPORT ANY DISCREPANCIES TO THE DESIGNER. PRINTS ARE NOT TO BE SCALED.


AREA  
2,930

PAGE No.  
2-2

PROJECT  
12-04-19

**Greenpark.**

PROJECT NAME  
RUSSELL GARDENS III

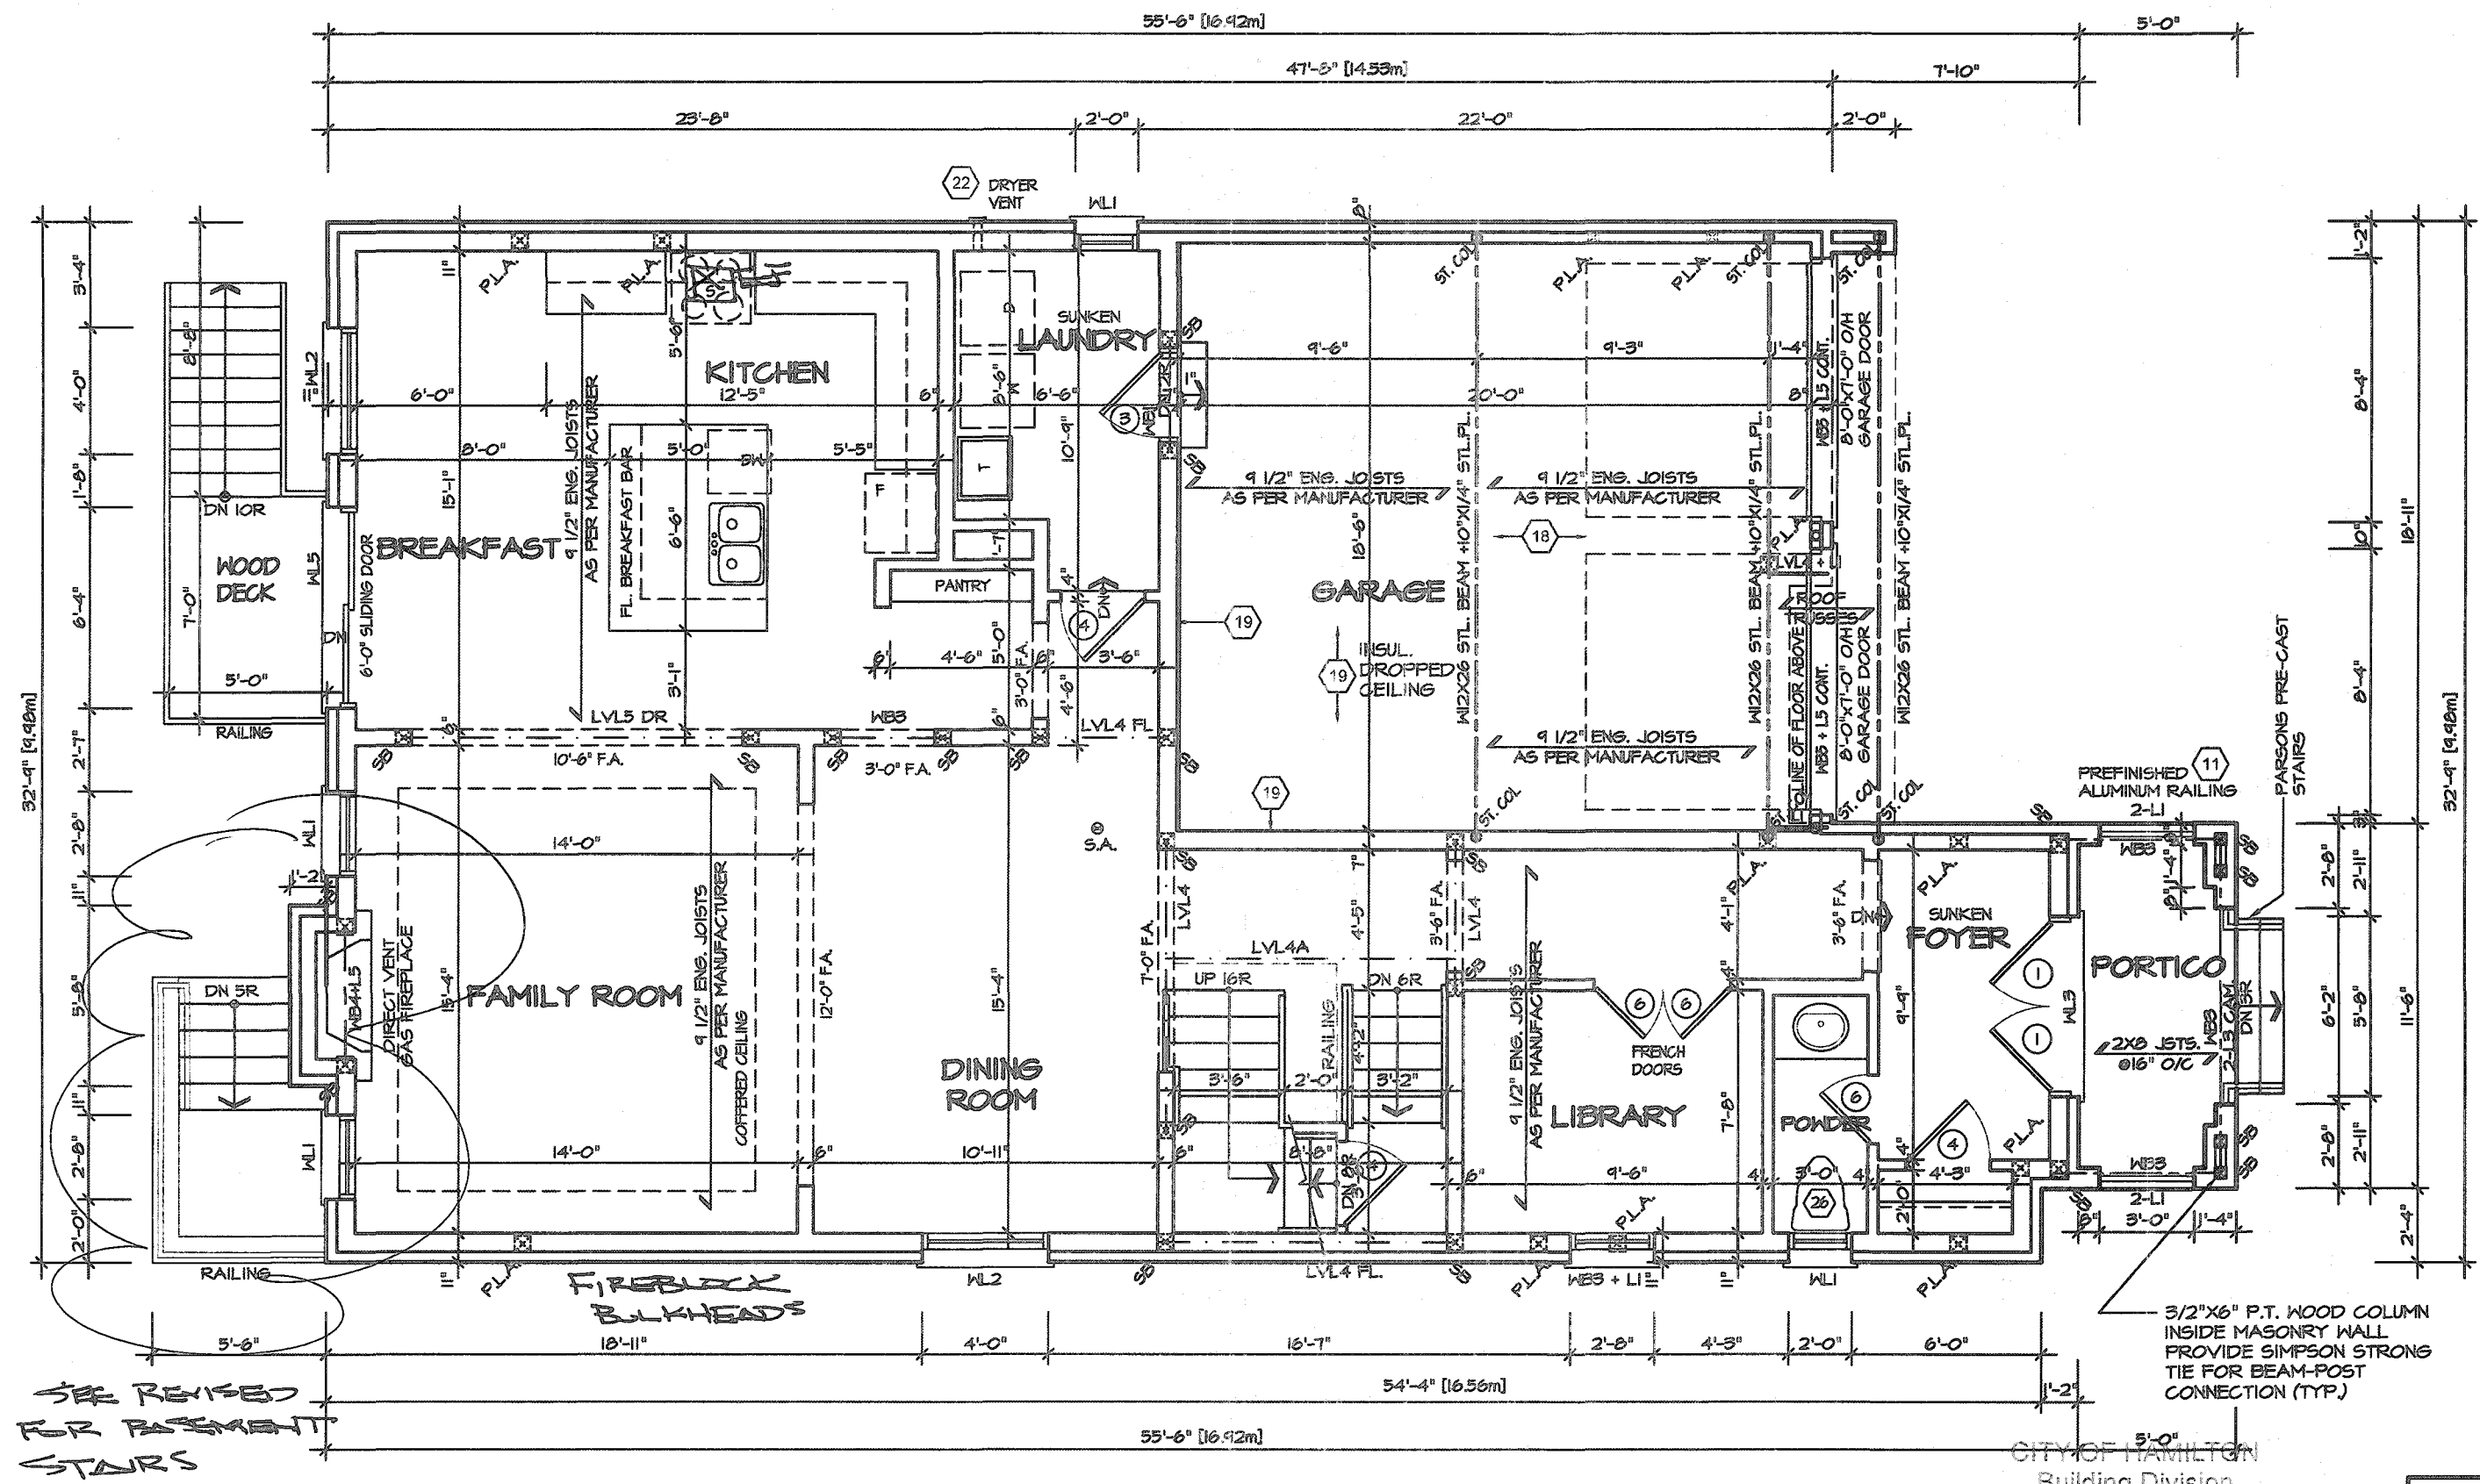

FIRST FLOOR PLAN 2

CITY OF HAMILTON  
Building Division

Permit No. 21-107128

THESE STAMPED DRAWINGS SHALL BE AVAILABLE ON SITE  
THE OWNER AND/OR CONTRACTOR SHALL COMPLY WITH  
THE ONTARIO BUILDING CODE AND ALL OTHER APPLICABLE LAW

STRUDET INC.  
REGISTERED PROFESSIONAL ENGINEER  
B. MARINKOVIC  
November 28, 2020  
OFFICE OF ONTARIO  
FOR STRUCTURE ONLY

These drawings and/or specifications have been reviewed by  
FOR CHIEF BUILDING OFFICIAL  
DATE  
MAR 30 2021

It is the builder's complete responsibility to ensure that all plans submitted for approval fully comply with the Architectural Guidelines and all applicable regulations and requirements including zoning provisions and any provisions in the subdivision agreement. The Control Architect is not responsible in any way for examining or approving site (lotting) plans or working drawings with respect to any zoning or building code or permit matter or that any house can be properly built or located on its lot.

This is to certify that these plans comply with the applicable Architectural Design Guidelines approved by the City of Hamilton

JOHN G. WILLIAMS LTD., ARCHITECT  
ARCHITECTURAL CONTROL REVIEW  
AND APPROVAL  
APPROVED BY  
DATE: JAN 28 2021  
This stamp certifies compliance with the applicable Design Guidelines only and bears no further professional responsibility

VALLEYCREEK 5-269

COMPLIANCE PACKAGE "A1"

REVISIONS	
5	
4	
3	
2	UPDATED FOR LOT 269 NOV 2020
1	ISSUED FOR COORDINATION JAN 2020

The undersigned has reviewed and takes responsibility for this design, and has the qualifications and meets the requirements set out in the Ontario Building Code to be a designer

QUALIFICATION INFORMATION  
Required unless design is exempt under Division C, Subsection 3.2.5 of the building code

VIKAS GAJJAR  
NAME  
28770  
SIGNATURE  
BCIN

REGION DESIGN INC.  
8700 DUFFERIN ST.  
CONCORD, ONTARIO  
L4K 4S6  
P (416) 736-4096  
F (905) 660-0746

REGION  
DESIGN  
INC.

SHEET TITLE  
FIRST FLOOR  
ELEVATION 2

SCALE  
3/16"=1'-0"

DATE  
DEC 2019

BY  
VG

TYPE

CONTRACTOR SHALL CHECK ALL DIMENSIONS AND ELEVATIONS BEFORE COMMENCING WORK AND REPORT ANY DISCREPANCIES TO THE DESIGNER. PRINTS ARE NOT TO BE SCALED.

AREA  
2,930

PAGE No.  
2-2


PROJECT  
12-04-19

PROJECT NAME  
RUSSELL GARDENS III


Greenpark






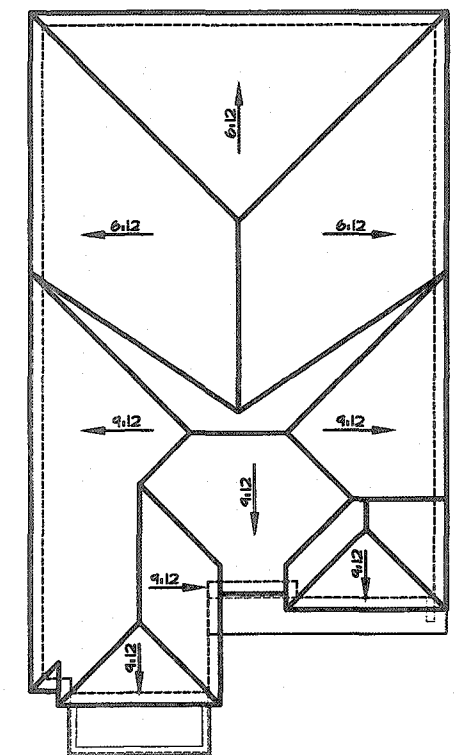

**ROOF PLAN 2**  
Scale: 1/16"=1'-0"

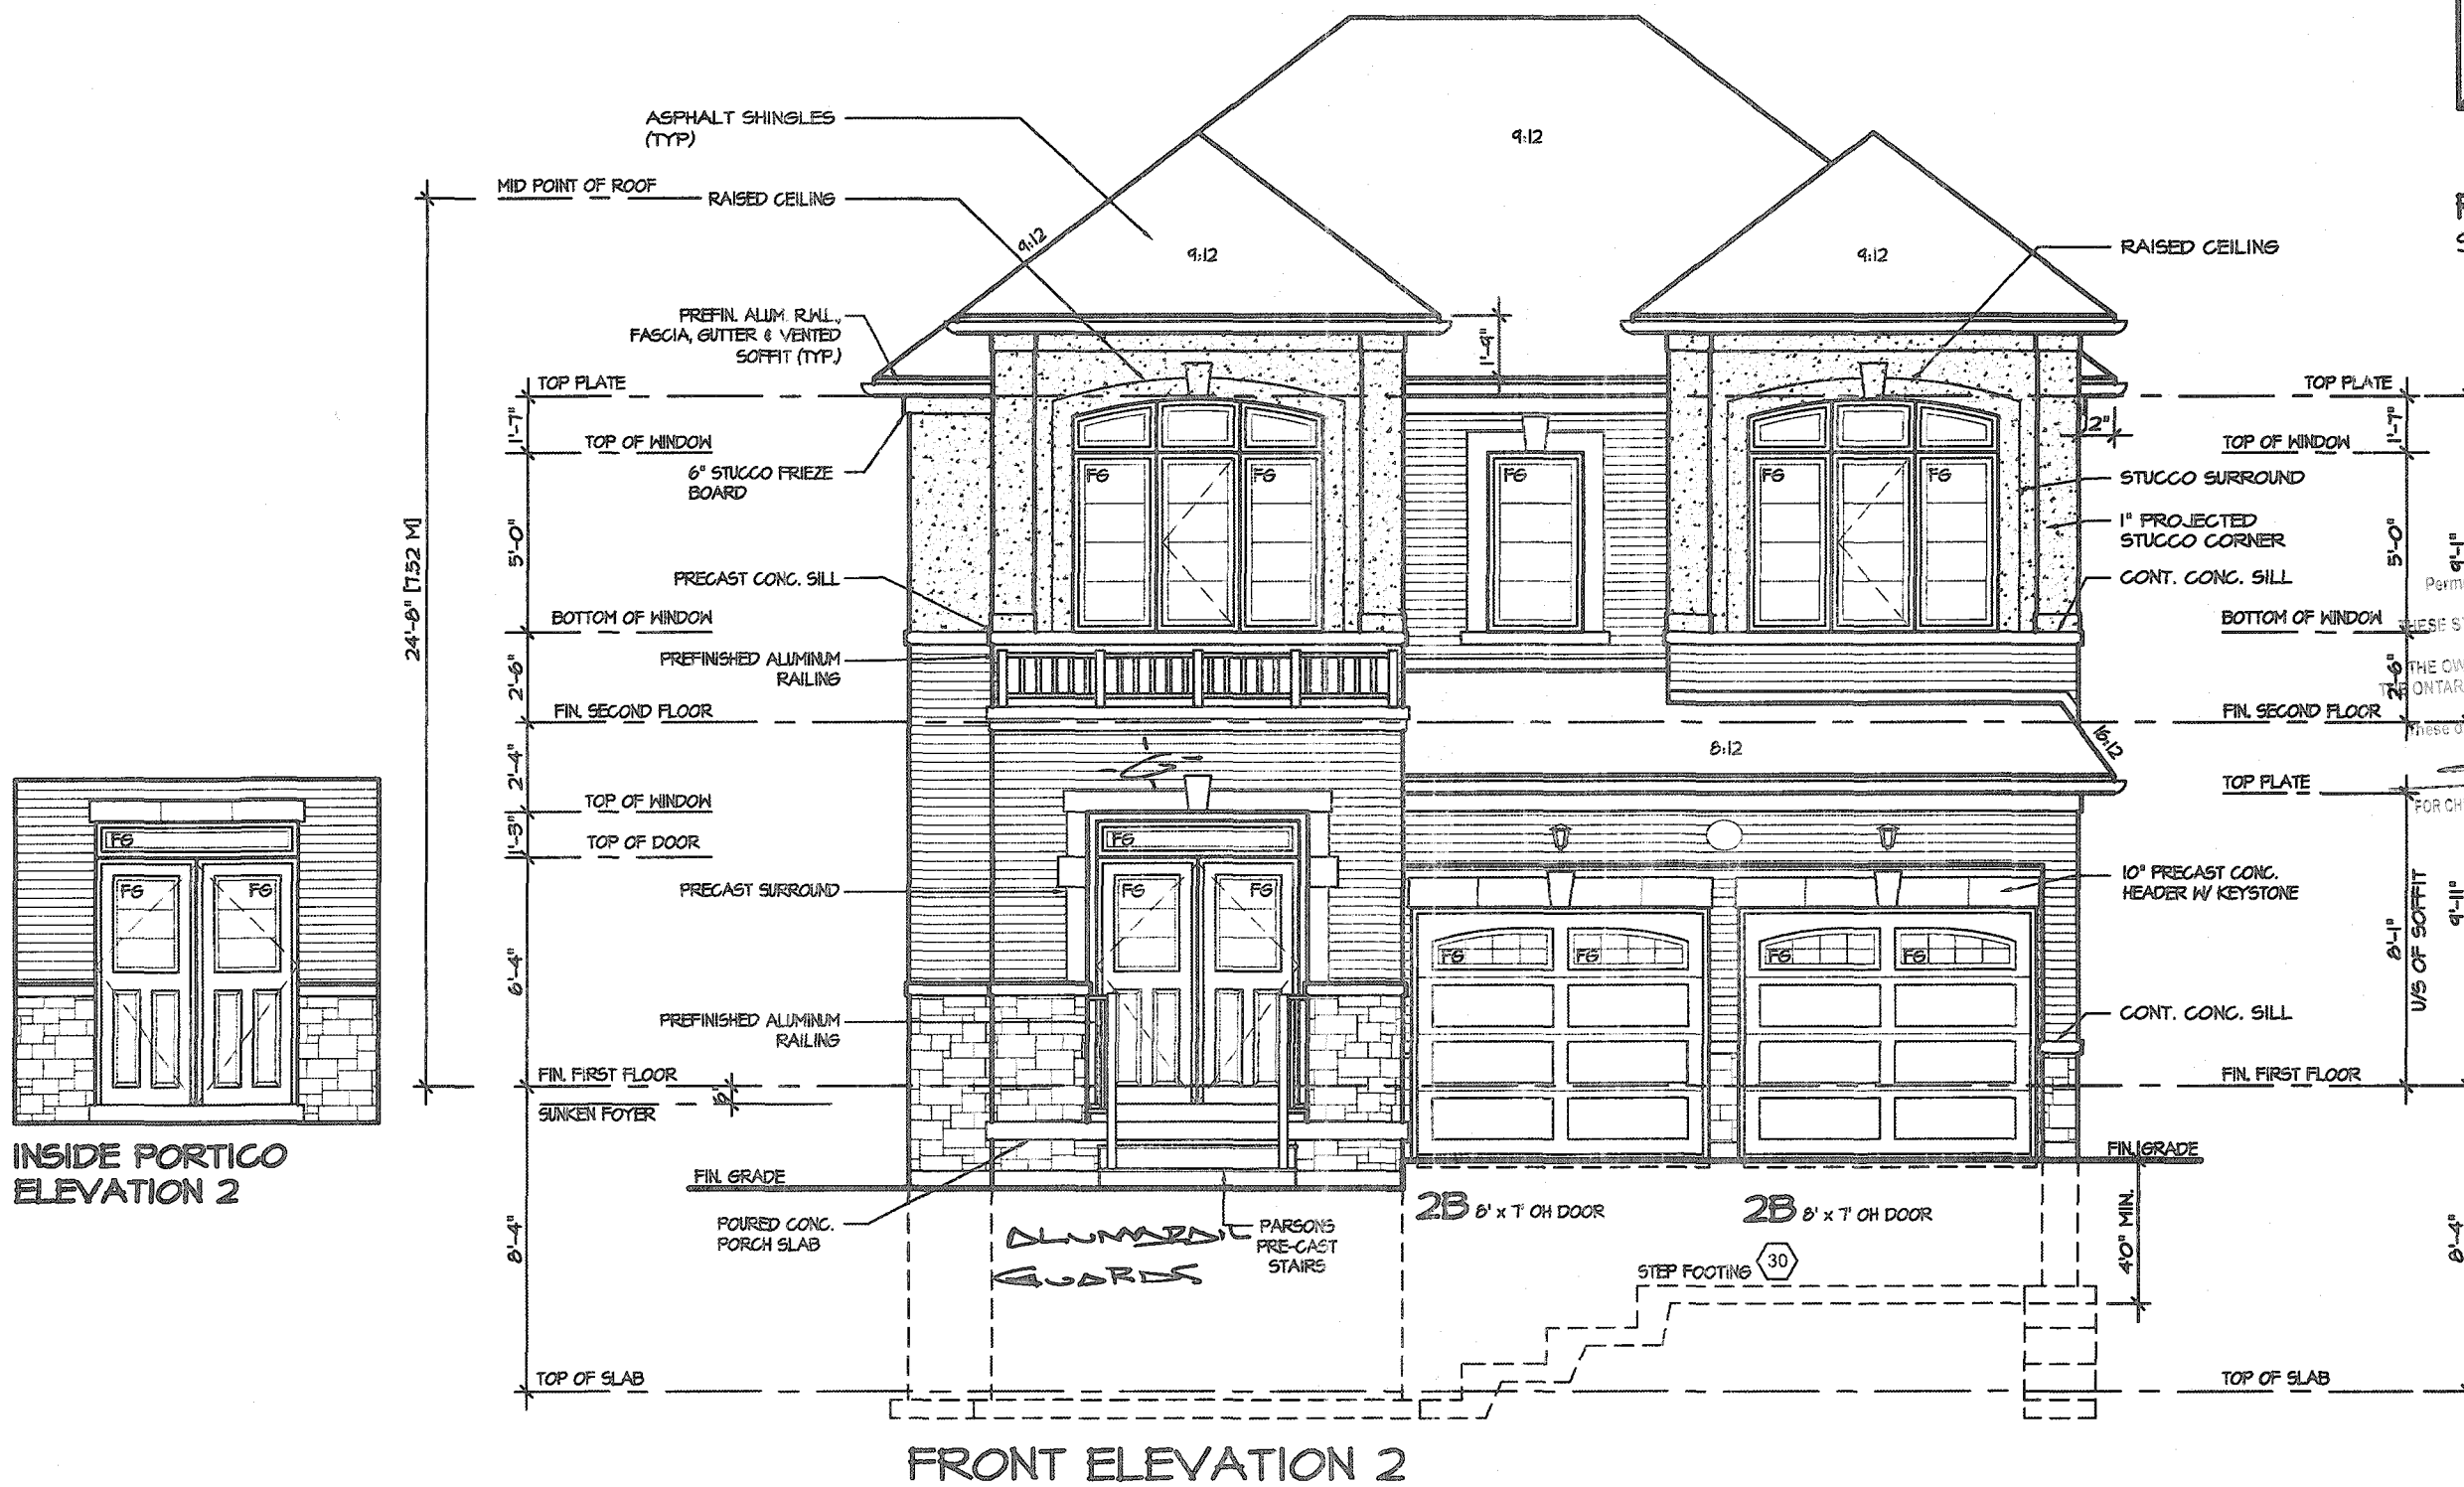

**FRONT ELEVATION 2**

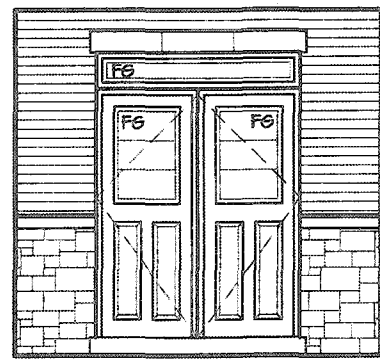

**INSIDE PORTICO ELEVATION 2**

CITY OF HAMILTON  
Building Division  
Permit No. **21-107128**

THESE STAMPED DRAWINGS SHALL BE AVAILABLE ON SITE  
THE OWNER AND/OR CONTRACTOR SHALL COMPLY WITH  
THE ONTARIO BUILDING CODE AND ALL OTHER APPLICABLE LAW  
These drawings and/or specifications have been reviewed by  
**[Signature]** FOR CHIEF BUILDING OFFICIAL  
DATE **MAR 30 2021**

It is the builder's complete responsibility to ensure that all plans submitted for approval fully comply with the Architectural Guidelines and all applicable regulations and requirements including zoning provisions and any provisions in the subdivision agreement. The Control Architect is not responsible in any way for examining or approving site (lotting) plans or working drawings with respect to any zoning or building code or permit matter or that any house can be properly built or located on its lot.

This is to certify that these plans comply with the applicable Architectural Design Guidelines approved by the City of HAMILTON

JOHN G. WILLIAMS LTD., ARCHITECT  
ARCHITECTURAL CONTROL REVIEW AND APPROVAL  
APPROVED BY: **[Signature]**  
DATE: **JAN 28 2021**  
This stamp certifies compliance with the applicable Design Guidelines only and does not further protect the architect's responsibility.

# VALLEYCREEK 5-269

COMPLIANCE PACKAGE "A1"

5		
4		
3		
2	UPDATED FOR LOT 269	NOV 2020
1	ISSUED FOR COORDINATION	JAN 2020
REVISIONS		

The undersigned has reviewed and takes responsibility for this design, and has the qualifications and meets the requirements set out in the Ontario Building Code to be a designer.

QUALIFICATION INFORMATION  
Required unless design is exempt under Division C, Subsection 3.2.5 of the building code

VIKAS GAJJAR  
NAME **[Signature]** 28770  
SIGNATURE BCIN

REGION DESIGN INC.  
8700 DUFFERIN ST.  
CONCORD, ONTARIO  
L4K 4S6  
P (416) 736-4096  
F (905) 660-0746

**REGION DESIGN INC.**

SHEET TITLE  
**FRONT ELEVATION 2**

SCALE 3/16"=1'-0"  
DATE DEC 2019

BY VG  
TYPE


CONTRACTOR SHALL CHECK ALL DIMENSIONS AND ELEVATIONS BEFORE COMMENCING WITH WORK AND REPORT ANY DISCREPANCIES TO THE DESIGNER. PRINTS ARE NOT TO BE SCALED.

AREA 2,930  
PROJECT 12-04-19

PAGE No. **4-2**

**Greenpark**

PROJECT NAME  
**RUSSELL GARDENS III**

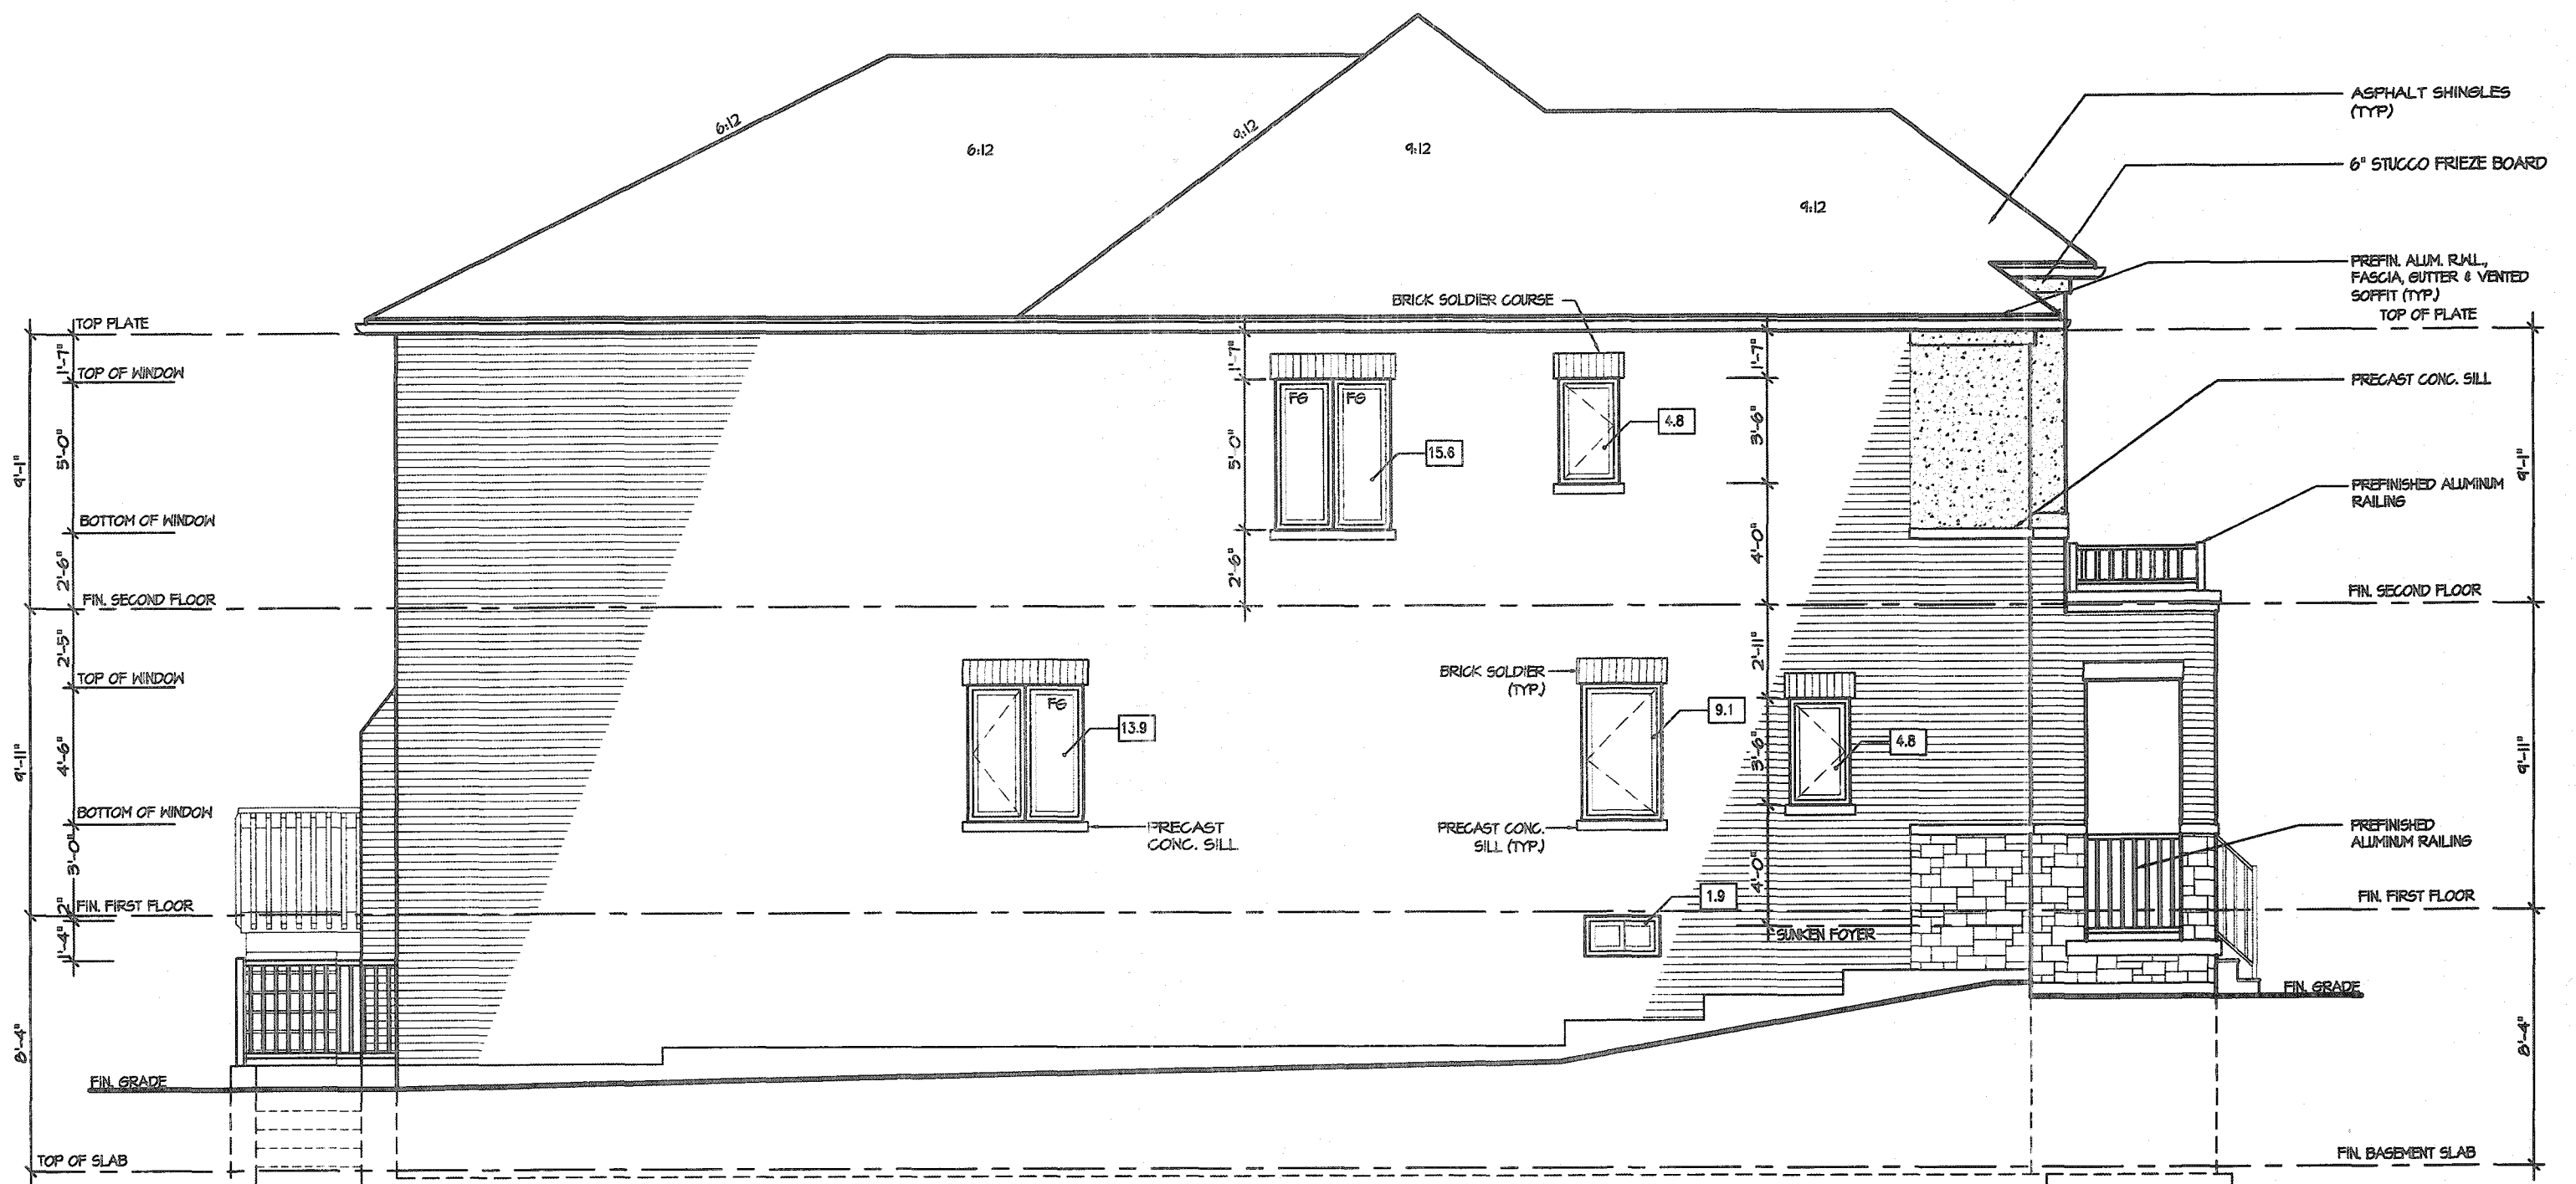

LEFT ELEVATION 2

# ALLOWABLE GLAZING

## WALL AREA

WALL AREA 1331.00  
ALLOWABLE WINDOW AREA @ 7.00 % (1.2 M SIDEYARD) 93.17  
ACTUAL WINDOW AREA 50.10

1331.00  
93.17  
50.10

CITY OF HAMILTON  
Building Division

Permit No. 21-107128

THESE STAMPED DRAWINGS SHALL BE AVAILABLE ON SITE

THE OWNER AND/OR CONTRACTOR SHALL COMPLY WITH THE ONTARIO BUILDING CODE AND ALL OTHER APPLICABLE LAW

These drawings and/or specifications have been reviewed by  
MAR 30 2021

FOR CHIEF BUILDING OFFICIAL

DATE

It is the builder's complete responsibility to ensure that all plans submitted for approval fully comply with the Architectural Guidelines and all applicable regulations and requirements including zoning provisions and any provisions in the subdivision agreement. The Control Architect is not responsible in any way for examining or approving site (lotting) plans or working drawings with respect to any zoning or building code or permit matter or that any house can be properly built or located on its lot.

This is to certify that these plans comply with the applicable Architectural Design Guidelines approved by the City of HAMILTON

JOHN G. WILLIAMS LTD., ARCHITECT  
ARCHITECTURAL CONTROL REVIEW AND APPROVAL

APPROVED BY  
DATE: JAN 28 2021  
This stamp certifies compliance with the applicable Design Guidelines only and does not further professional responsibility.

VALLEYCREEK 5-269

COMPLIANCE PACKAGE "A1"

5		
4		
3		
2	UPDATED FOR LOT 269	NOV 2020
1	ISSUED FOR COORDINATION	JAN 2020
REVISIONS		

The undersigned has reviewed and takes responsibility for this design, and has the qualifications and meets the requirements set out in the Ontario Building Code to be a designer.

QUALIFICATION INFORMATION  
Required unless design is exempt under Division C, Subsection 3.2.5 of the building code

VIKAS GAJJAR  
NAME SIGNATURE BCIN 28770

REGION DESIGN INC.  
9700 DUFFERIN ST.  
CONCORD, ONTARIO  
L4K 4S8  
P (416) 738-4038  
F (905) 660-0746

REGION  
DESIGN  
INC.


SHEET TITLE LEFT SIDE ELEVATION 2	
SCALE 3/16"=1'-0"	BY VG
DATE DEC 2019	TYPE

CONTRACTOR SHALL CHECK ALL DIMENSIONS AND ELEVATIONS BEFORE COMMENCING WITH WORK AND REPORT ANY DISCREPANCIES TO THE DESIGNER. PRINTS ARE NOT TO BE SCALED.

AREA 2,930	PAGE No. 5-2
PROJECT 12-04-19	

**Greenpark**  
PROJECT NAME  
RUSSELL GARDENS III



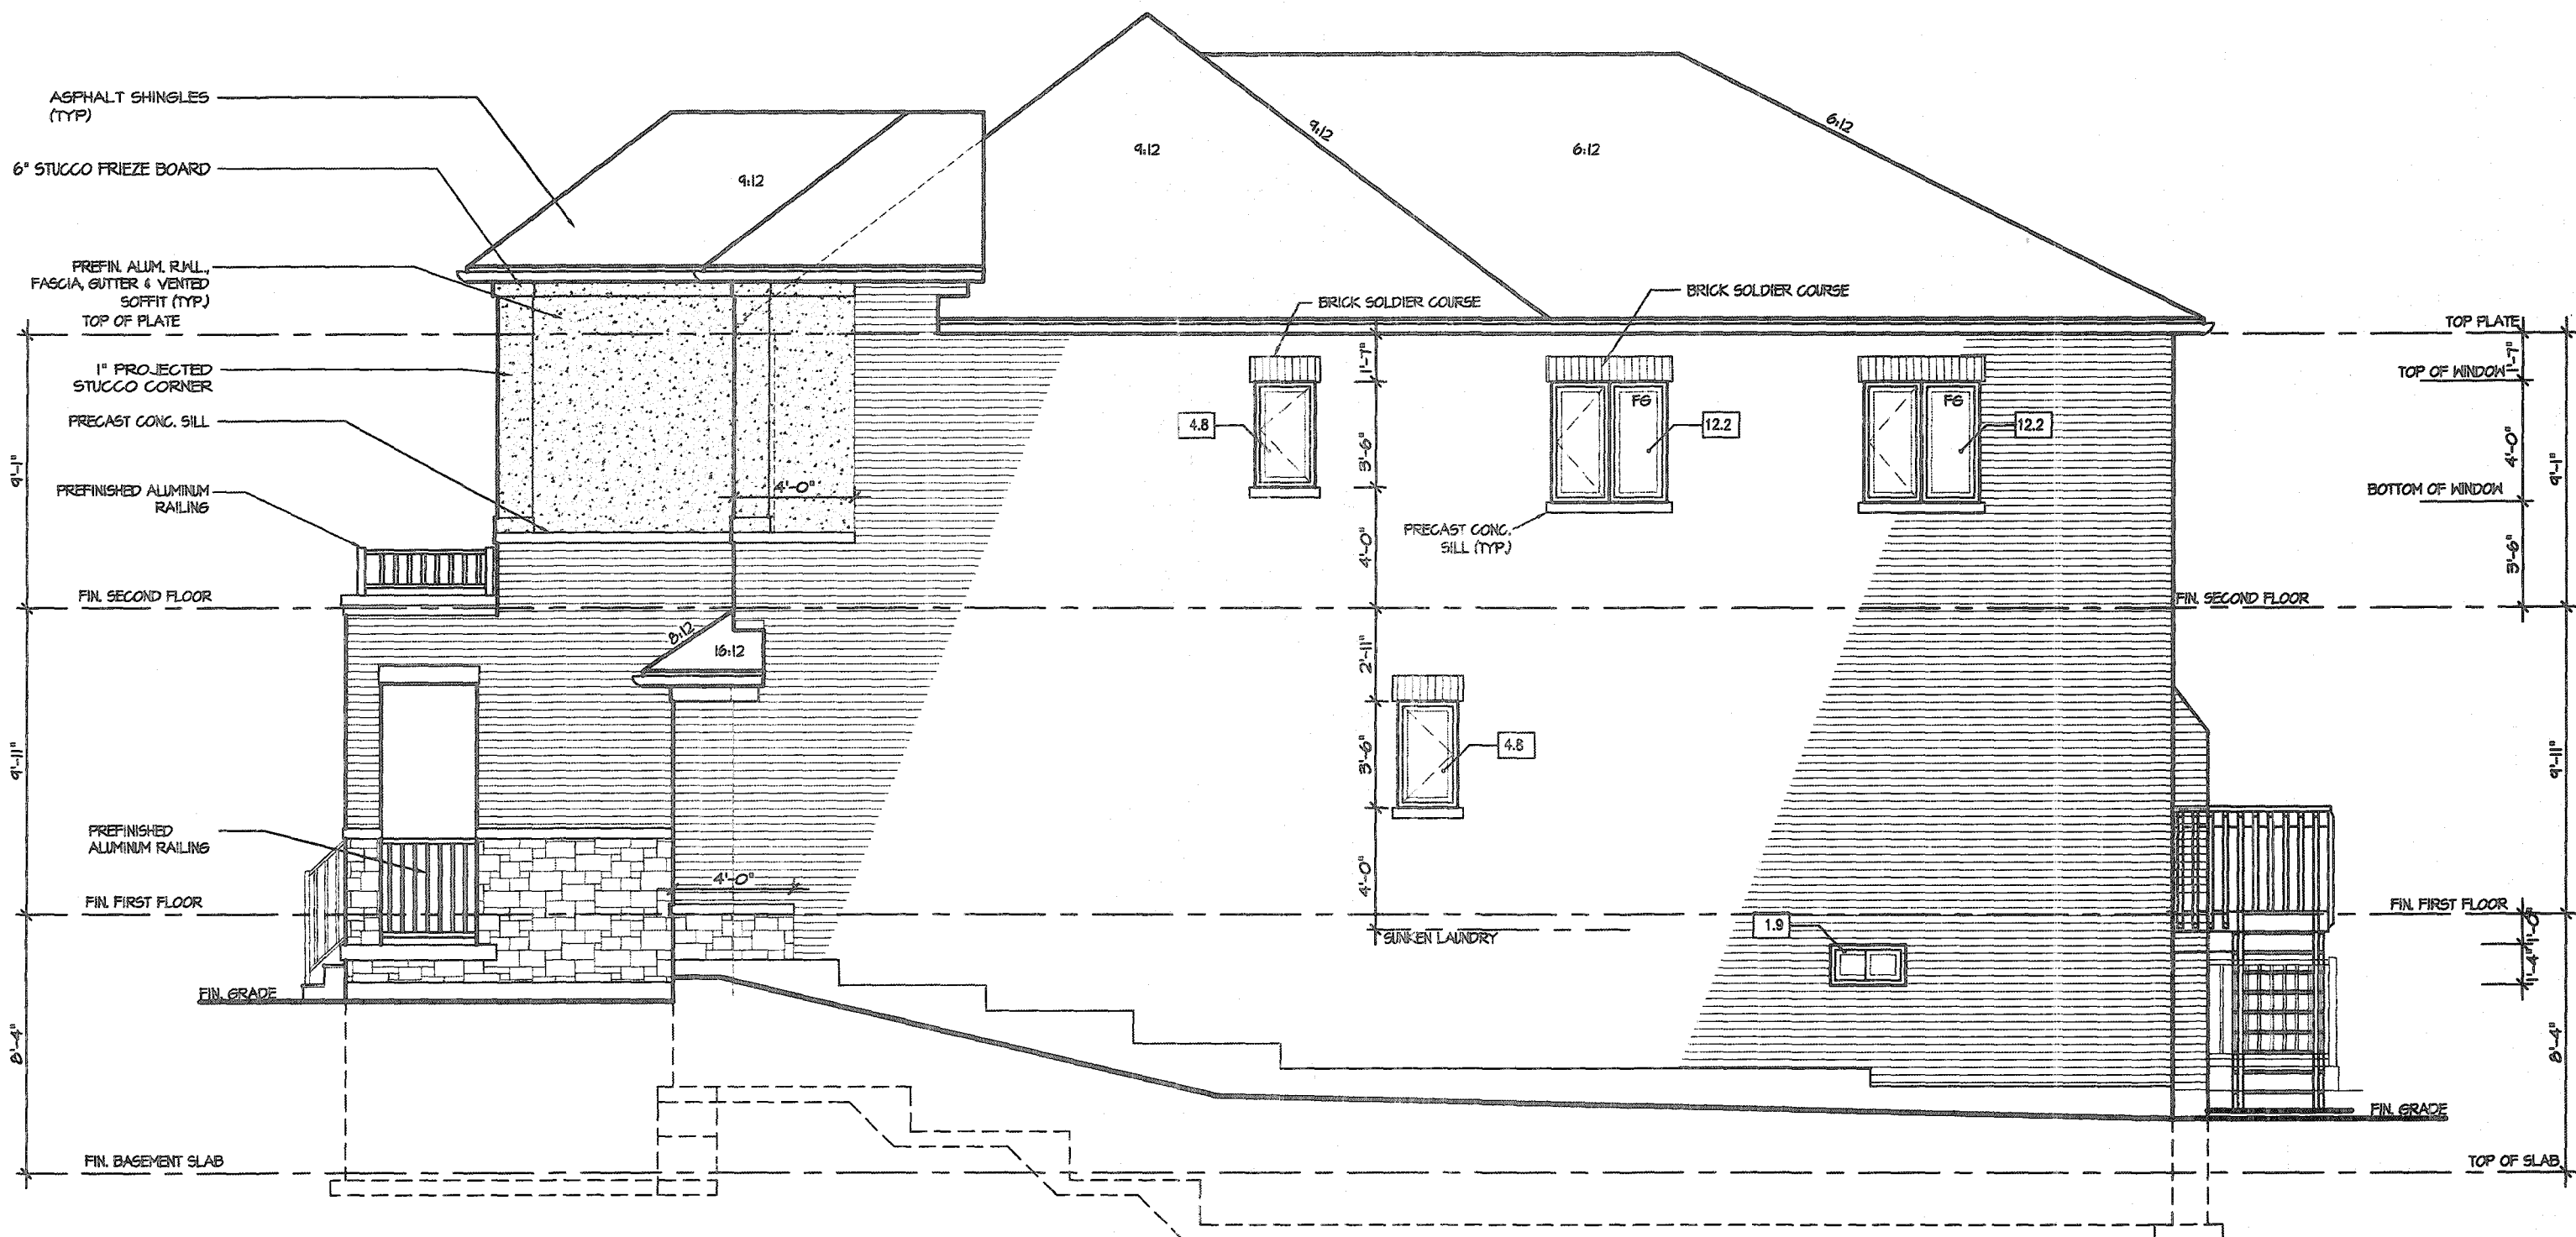

RIGHT ELEVATION 2

ALLOWABLE GLAZING	
WALL AREA	
WALL AREA	1212.45
ALLOWABLE WINDOW AREA @ 700 % (1.2 M SIDEYARD)	84.87
ACTUAL WINDOW AREA	35.90

CITY OF HAMILTON  
Building Division  
Permit No. 21-107128  
THESE STAMPED DRAWINGS SHALL BE AVAILABLE ON SITE  
THE OWNER AND/OR CONTRACTOR SHALL COMPLY WITH  
THE ONTARIO BUILDING CODE AND ALL OTHER APPLICABLE LAW  
These drawings and/or specifications have been reviewed by  
[Signature] **MAR 30 2021**  
DATE  
FOR CHIEF BUILDING OFFICIAL



It is the builder's complete responsibility to ensure that all plans submitted for approval fully comply with the Architectural Guidelines and all applicable regulations and requirements including zoning provisions and any provisions in the subdivision agreement. The Control Architect is not responsible in any way for examining or approving site (lotting) plans or working drawings with respect to any zoning or building code or permit matter or that any house can be properly built or located on its lot.

This is to certify that these plans comply with the applicable Architectural Design Guidelines approved by the City of HAMILTON

JOHN G. WILLIAMS LTD., ARCHITECT  
ARCHITECTURAL CONTROL REVIEW  
AND APPROVAL  
APPROVED BY [Signature]  
DATE: JAN 28 2021  
This stamp certifies compliance with the applicable Design Guidelines only and waives no further professional responsibility.


VALLEYCREEK 5-269

COMPLIANCE PACKAGE "A1"

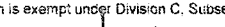5			<div>The undersigned has reviewed and takes responsibility for this design, and has the qualifications and meets the requirements set out in the Ontario Building Code to be a designer.</div> <div>QUALIFICATION INFORMATION Required unless design is exempt under Division C, Subsection 3.2.5 of the building code</div> <div>VIKAS GAJJAR NAME</div> <div>28770 SIGNATUREBCIN</div>	<div>REGION DESIGN INC. 8700 DUFFERIN ST. CONCORD, ONTARIO L4K 4S6 P (416) 735-4096 F (905) 860-0746</div>	SHEET TITLE RIGHT SIDE ELEVATION 2		CONTRACTOR SHALL CHECK ALL DIMENSIONS AND ELEVATIONS BEFORE COMMENCING WITH WORK AND REPORT ANY DISCREPANCIES TO THE DESIGNER. PRINTS ARE NOT TO BE SCALED.		 <div>PROJECT NAME RUSSELL GARDENS III</div>
4									
3									
2	UPDATED FOR LOT 269	NOV 2020							
1	ISSUED FOR COORDINATION	JAN 2020							
REVISIONS					SCALE 3/16"=1'-0"		BY VG	AREA 2,930	PAGE No. 6-2
					DATE DEC 2019		TYPE	PROJECT 12-04-19	



November 11, 2020 3:36:25 PM I:\PROJECTS\RUSSELL GARDENS III\CUSTOM\VALLEYCREEK 5 LOT 269 E2 WALKUP DWG

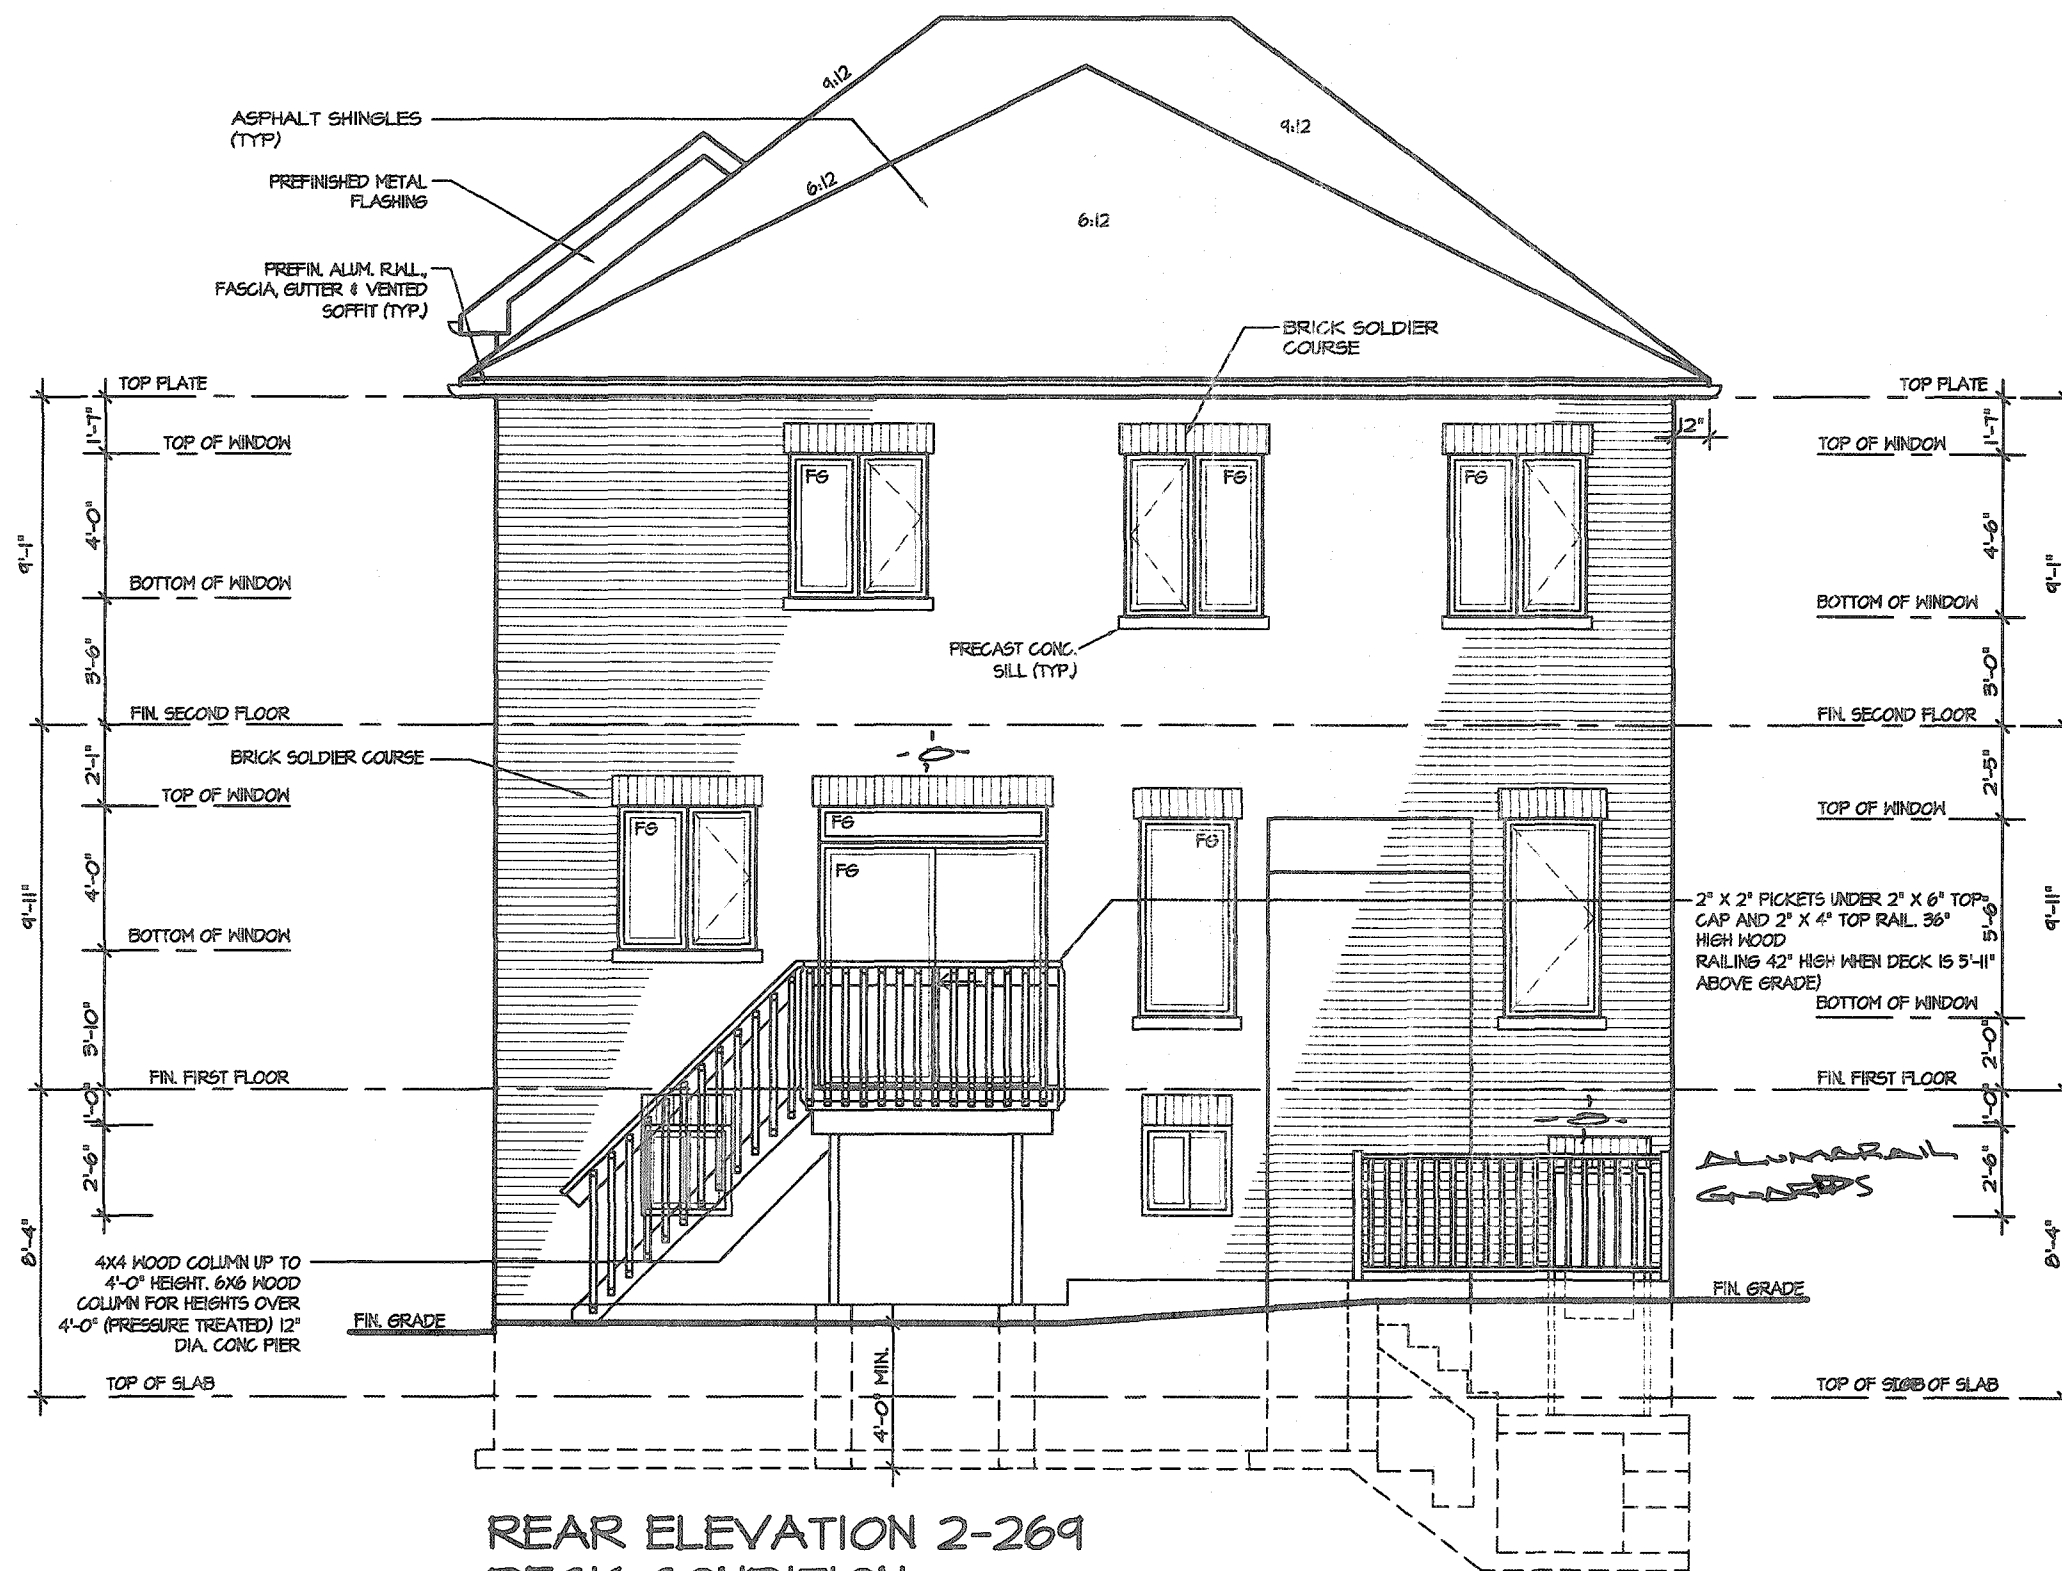

CITY OF HAMILTON  
Building Division

Permit No. **21-107128**

THESE STAMPED DRAWINGS SHALL BE AVAILABLE ON SITE

THE OWNER AND/OR CONTRACTOR SHALL COMPLY WITH  
THE ONTARIO BUILDING CODE AND ALL OTHER APPLICABLE LAW

These drawings and/or specifications have been reviewed by  
**TDS** **MAR 30 2021**

FOR CHIEF BUILDING OFFICIAL

DATE

It is the builder's complete responsibility to ensure that all plans submitted for approval fully comply with the Architectural Guidelines and all applicable regulations and requirements including zoning provisions and any provisions in the subdivision agreement. The Control Architect is not responsible in any way for examining or approving site (lotting) plans or working drawings with respect to any zoning or building code or permit matter or that any house can be properly built or located on its lot.

This is to certify that these plans comply with the applicable Architectural Design Guidelines approved by the City of HAMILTON

JOHN G. WILLIAMS LTD., ARCHITECT  
ARCHITECTURAL CONTROL REVIEW  
AND APPROVAL

APPROVED BY: **[Signature]**  
DATE: **JAN 28 2021**

This stamp certifies compliance with the applicable Design Guidelines only and bears no further professional responsibility.

**VALLEYCREEK 5-269**

COMPLIANCE PACKAGE "A1"

5		
4		
3		
2	UPDATED FOR LOT 269	NOV 2020
1	ISSUED FOR COORDINATION	JAN 2020
REVISIONS		

The undersigned has reviewed and takes responsibility for this design, and has the qualifications and meets the requirements set out in the Ontario Building Code to be a designer.

QUALIFICATION INFORMATION  
Required unless design is exempt under Division C, Subsection 3.2.5 of the building code

VIKAS GAJJAR **28770**  
NAME SIGNATURE BCIN

REGION DESIGN INC.  
8700 DUFFERIN ST.  
CONCORD, ONTARIO

L4K 4S6

P (416) 736-4096

F (603) 660-0746

**REGION DESIGN INC.**

SHEET TITLE  
**REAR ELEVATION 2**

SCALE  
**3/16"=1'-0"**

DATE  
**DEC 2019**

BY  
**VG**

TYPE

CONTRACTOR SHALL CHECK ALL DIMENSIONS AND ELEVATIONS BEFORE COMMENCING WITH WORK AND REPORT ANY DISCREPANCIES TO THE DESIGNER. PRINTS ARE NOT TO BE SCALED.


AREA  
**2,930**

PROJECT  
**12-04-19**


PAGE No.  
**7-2**

**Greenpark.**

PROJECT NAME  
**RUSSELL GARDENS III**

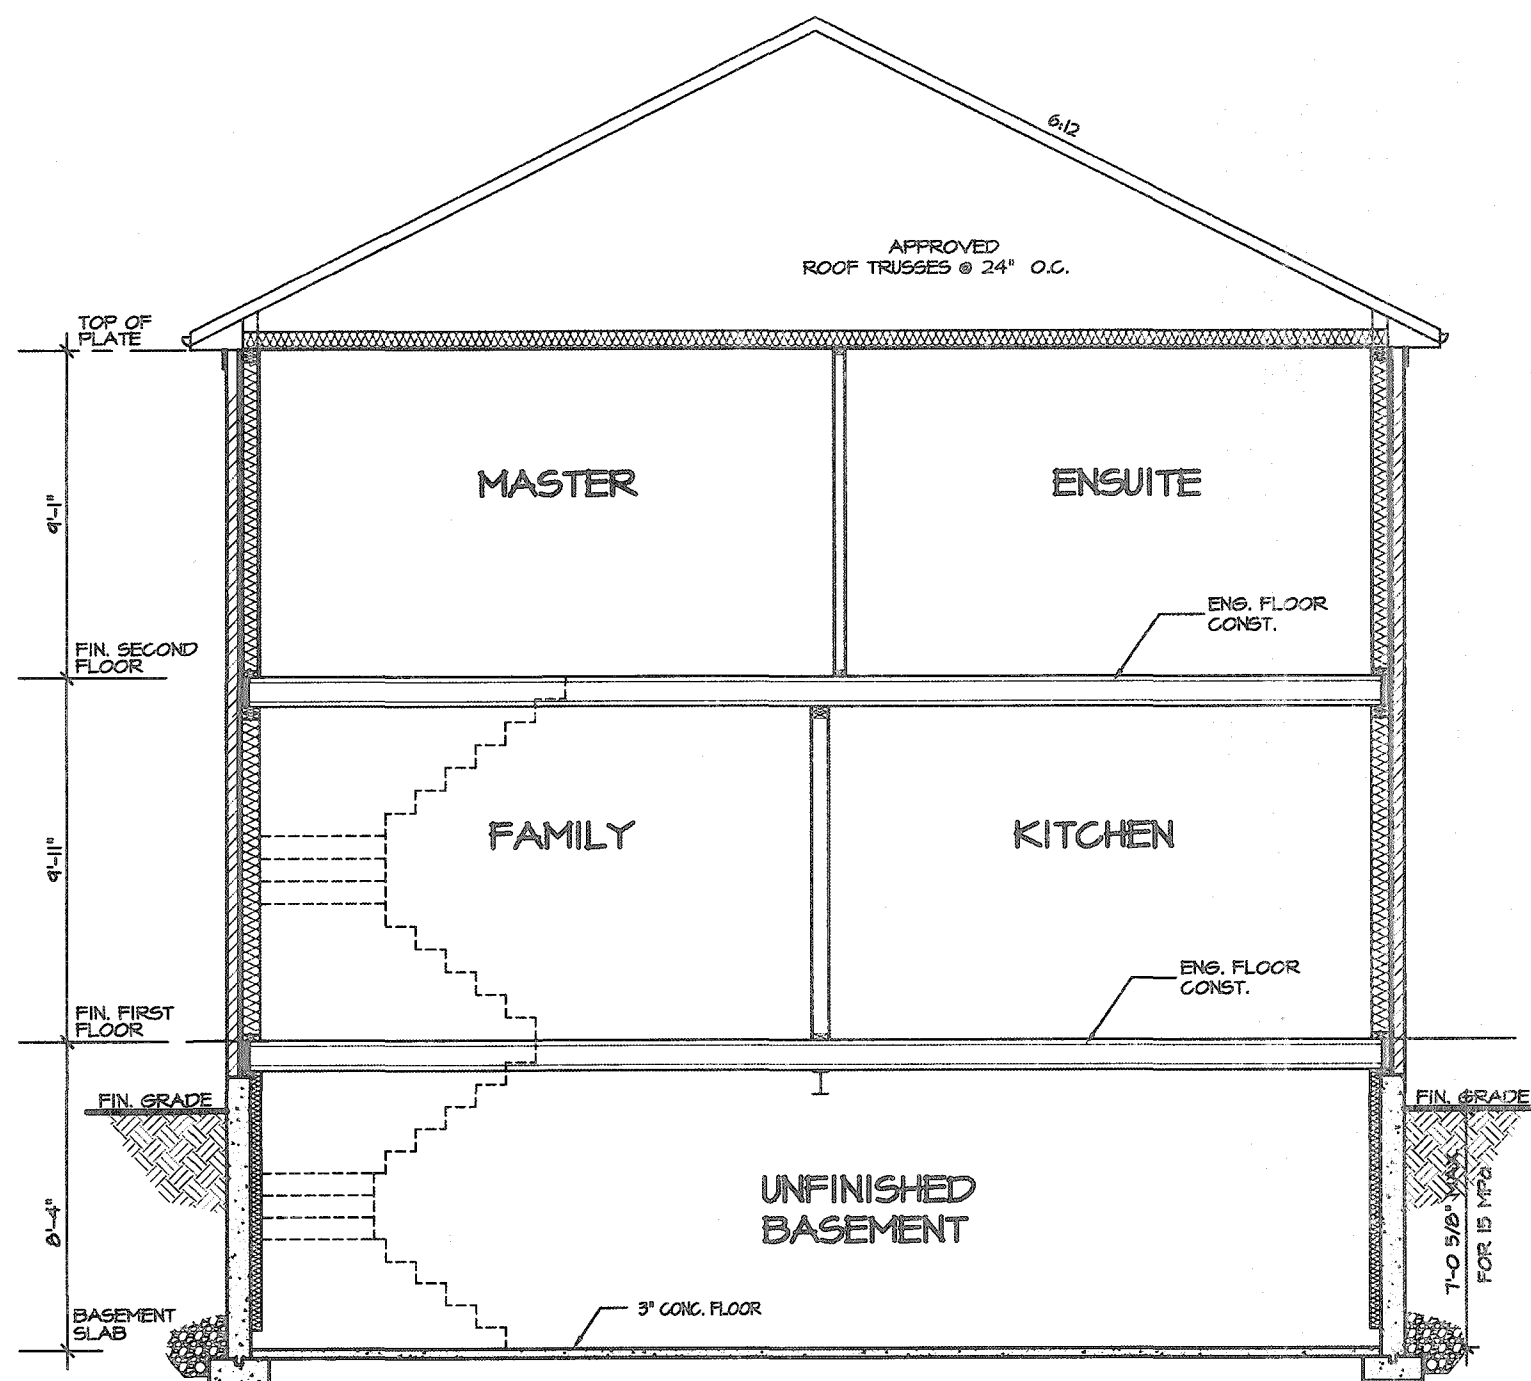

CROSS SECTION

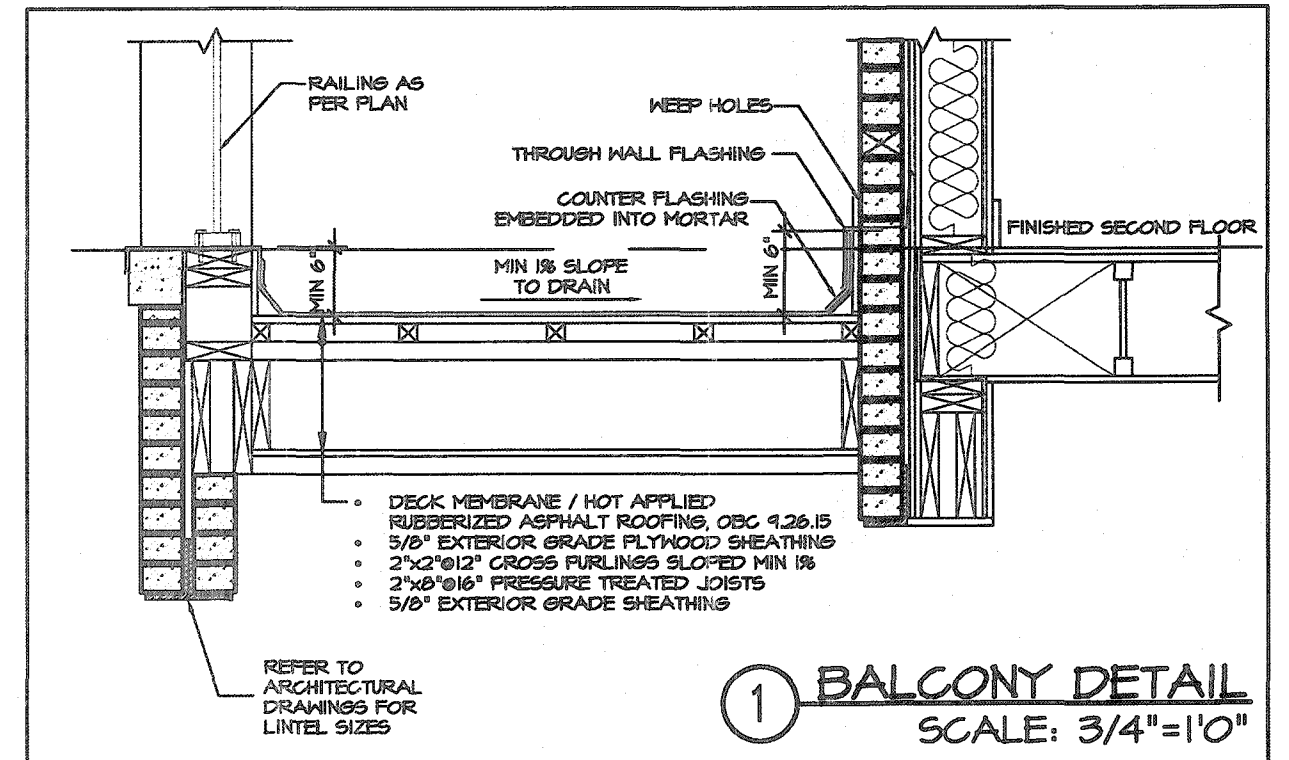

CITY OF HAMILTON  
Building Division  
Permit No. 21-107128  
THESE STAMPED DRAWINGS SHALL BE AVAILABLE ON SITE  
THE OWNER AND/OR CONTRACTOR SHALL COMPLY WITH  
THE ONTARIO BUILDING CODE AND ALL OTHER APPLICABLE LAW  
These drawings and/or specifications have been reviewed by  
[Signature] **MAR 30 2021**  
FOR CHIEF BUILDING OFFICIAL DATE



VALLEYCREEK 5-269

COMPLIANCE PACKAGE "A1"

It is the builder's complete responsibility to ensure that all plans submitted for approval fully comply with the Architectural Guidelines and all applicable regulations and requirements including zoning provisions and any provisions in the subdivision agreement. The Control Architect is not responsible in any way for examining or approving site (lotting) plans or working drawings with respect to any zoning or building code or permit matter or that any house can be properly built or located on its lot.

This is to certify that these plans comply with the applicable Architectural Design Guidelines approved by the City of HAMILTON

<p>5</p> <p>4</p> <p>3</p> <p>2 UPDATED FOR LOT 269 NOV 2020</p> <p>1 ISSUED FOR COORDINATION JAN 2020</p> <p>REVISIONS</p>	<p>The undersigned has reviewed and takes responsibility for this design, and has the qualifications and meets the requirements set out in the Ontario Building Code to be a designer.</p> <p>QUALIFICATION INFORMATION Required unless design is exempt under Division C, Subsection 3.2.5 of the building code</p> <p>VIKAS GAJJAR NAME SIGNATURE 28770 BCIN</p>	<p>REGION DESIGN INC. 8700 DUFFERIN ST. CONCORD, ONTARIO L4K 4S6 P (416) 738-4036 F (905) 660-0745</p>	<p>REGION DESIGN INC.</p>	<p>SHEET TITLE CROSS SECTION ELEV. 1, 2 &amp; 3</p> <p>SCALE 3/16"=1'-0" DATE DEC 2019</p> <p>BY VG TYPE</p>	<p>CONTRACTOR SHALL CHECK ALL DIMENSIONS AND ELEVATIONS BEFORE COMMENCING WITH WORK AND REPORT ANY DISCREPANCIES TO THE DESIGNER. PRINTS ARE NOT TO BE SCALED.</p> <p>AREA 2,930 PROJECT 12-04-19</p>	<p>PAGE No. 8</p> <p>PROJECT NAME RUSSELL GARDENS III</p>
---	--	--	-----------------------------------	--	---	---