STRIP FOOTINGS - FOR SINGLES & SEMIS UP TO 2 STOREYS

8" OR 10" FOUNDATION WALLS WITH 2"x8" / 2"x10" FLOOR JOISTS 20"x6" CONCRETE STRIP FOOTINGS BELOW FOUNDATION WALLS. 24"x8" CONCRETE STRIP FOOTINGS BELOW PARTY WALLS.

FOUNDATION WALLS WITH ENGINEERED JOISTS OVER 16' SPANS 24"x8" CONCRETE STRIP FOOTINGS BELOW FOUNDATION WALLS.

FOOTINGS ON ENGINEERED FILL 24"x8" CONCRETE STRIP FOOTINGS WITH REINFORCING.

BELOW EXTERIOR WALLS.

30"x8" CONCRETE STRIP FOOTINGS WITH REINFORCING. BELOW PARTY WALLS.

(REFER TO ENGINEER FILL FOOTING DETAIL)

ASSUME THE LARGER FOOTING SIZE WHEN TWO CONDITIONS APPLY

ASSUMED 120 KPa (18 p.s.i.) SOIL BEARING CAPACITY FOR SINGLES OR 90 KPa FOR ENGINEERED FILL, TO BE VERIFIED ON SITE.

PAD FOOTINGS

120 KPa. NATIVE SOIL 90 KPa. ENGINEERED FILL SOIL

F1 = 42"x42"x18" CONCRETE PAD F1 = 48"x48"x20" CONCRETE PAD F2 = 36"x36"x16" CONCRETE PAD F2 = 40"x40"x16" CONCRETE PAD F3 = 30"x30"x12" CONCRETE PAD F3 = 34"x34"x14" CONCRETE PAD F4 = 24"x24"x12" CONCRETE PAD F4 = 28"x28"x12" CONCRETE PAD F5 = 16"x16"x8" CONCRETE PAD F5 = 18"x18"x8" CONCRETE PAD

VENEER CUT

WHEN VENEER CUT IS GREATER THAN 26", A 10" POURED CONCRETE FOUNDATION WALL IS REQUIRED

(REFER TO FLOOR PLAN FOR UNUSUAL SIZE PADS NOT ON CHART.)

EXPOSED CONCRETE (FLATWORK)

ALL GARAGE SLABS, PORCH SLABS, STAIRS (EXPOSED CONC. FLAT WORK) TO BE 32 MPa. WITH 5-8% AIR ENTRAINMENT.

BRICK VENEER LINTELS (WL)

WL2 = 4" x 3-1/2" x 5/16"L (100x90x8.0L) WL3 = 5" x 3-1/2" x 5/16"L (125x90x8.0L) WL4 = 6" x 3-1/2" x 3/8"L (150x90x10.0L) WL5 = 6" x 4" x 3/8"L (150x100x10.0L) WL6 = 5" x 3-1/2" x 5/16"L (125x90x8.0L)	+ + + +	2-2"x8" SPR. No.2 2-2"x8" SPR. No.2 2-2"x10" SPR. No.2 2-2"x12" SPR. No.2 2-2"x12" SPR. No.2 2-2"x12" SPR. No.2
WL7 =5" x 3-1/2" x 5/16"L (125x90x8.0L) WL8 =5" x 3-1/2" x 5/16"L (125x90x8.0L)	+	3-2"x12" SPR. No.2 3-2"x10" SPR. No.2 3-2"x10" SPR. No.2 3-2"x10" SPR. No.2

WOOD LINTELS AND BEAMS (WB)

WB1	=2-2"x8" (2-38x184)	SPR. I	No.2
WB2	=3-2"x8" (3-38x184)	SPR. 1	Vo.2
WB3	=2-2"x10"	(2-38x235)	SPR.	No.2
WB4	=3-2"x10"	(3-38x235)	SPR.	No.2
WB5	=2-2"x12"	(2-38x286)	SPR.	No.2
WB6	=3-2"x12"	(3-38x286)	SPR.	No.2
WB7	=5-2"x12"	(5-38x286)	SPR.	No.2
WB11	=4-2"x10"	(4-38x235)	SPR.	No.2
WB12	=4-2"x12"	(4-38x286)	SPR.	No.2

LAMINATED VENEER LUMBER (LVL) BEAMS

LVLIA	= -	
LVL1	=2-1	3/4"x7 1/4" (2-45x184)
LVL2	=3-1	3/4"x7 1/4" (3-45x184)
LVL3	=4-1	3/4"x7 1/4" (4-45x184)
LVL4A	=1-1	3/4"x9 1/2" (1-45x240)
LVL4	=2-1	3/4"x9 1/2" (2-45x240)
LVL5	=3-1	3/4"x9 1/2" (3-45x240)
LVL5A	=4-1	3/4"x9 1/2" (4-45x240)
LVL6A	=1-1	3/4"x11 7/8" (1-45x300)
LVL6	=2-1	3/4"x11 7/8" (2-45x300)
LVL7	=3-1	3/4"x11 7/8" (3-45x300)
LVL8	=2-1	3/4"x14" (2-45x356)
11/10	-3 -1	3/1"v11" (3_15v356)

LOOSE STEEL LINTELS (L)

	
L1	=3-1/2" x $3-1/2$ " x $1/4$ "L (90x90x6.0L)
L2	=4" x 3 $-1/2$ " x 5 $/16$ "L (100x90x8.0L)
L3	=5" x 3 $-1/2$ " x 5 $/16$ "L (125x90x8.0L)
L4	=6" x 3 $-1/2$ " x 3 $/8$ "L (150x90x10.0L)
L5	=6" x 4" x 3/8"L (150x100x10.0L)
L6	=7" x 4" x 3/8"L (180x100x10.0L)

CERAMIC TILE FOR CONVENTIONAL LUMBER (OBC 9.30.6)

SPACE ALL CONVENTIONAL FLOOR JOISTS @ 12" O.C. BELOW ALL CERAMIC TILE AREAS.

PROVIDE 1 ROW BRIDGING FOR SPANS OF 5'0"-7'0". 2 ROWS FOR SPANS GREATER THAN 7'0".

NOTE: ROOF FRAMING

REFER TO ROOF TRUSS SHOP DRAWINGS FOR ALL ROOF FRAMING INFORMATION UNLESS OTHERWISE NOTED.


PLANS NOT DRAWN TO ACTUAL GRADE. REFER TO FINAL APPROVED GRADING PLAN.

NOTE: ENGINEERED FLOOR FRAMING

REFER TO ENGINEERED FLOOR FLAYOUTS FOR ALL ENGINEERED FLOOR FRAMING INFORMATION AND DETAILS. UNLESS OTHERWISE NOTED.


TWO STOREY HEIGHT WALL DETAIL

2-2"x6" STUD WALL NAILED TOGETHER AND SPACED @ 12"o.c. FULL HEIGHT, c/w SOLID BLOCKING @ 4'-0" o.c. VERTICAL AND 7/16" EXT. PLYWOOD SHEATHING.

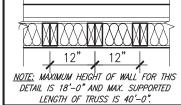

TWO STOREY HEIGHT

WALL DETAIL 2-1 1/2"x 5 1/2" TIMBERSTRAND (LSL) 1.5E STUD WALL GLUED & NAILED TOGETHER AND SPACED MAX. @ 9"o.c. FULL HEIGHT. c/w SOLID BLOCKING @ 8'-0" o.c. VERTICAL AND 7/16"

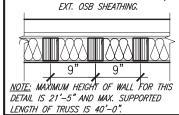


It is the builder's complete responsibility to ensure that all plans submitted for approval fully comply with the Architectural Guidelines and all applicable regulations and requirements including zoning provisions and any provisions in the subdivision agreement. The Control Architect is not responsible in any way for examining or approving site (lotting) plans or working drawings with respect to any zoning or building code or permit matter or that any house can be properly built or located on its lot.

This is to certify that these plans comply with the applicable Architectural Design Guidelines approved by the Town of EAST GWILLIMBURY.

TWO STOREY HEIGHT WALL DETAIL

2–1 1/2"x 5 1/2" TIMBERSTRAND (LSL) 1.5E STUD WALL GLUED & NAILED TOGETHER AND PACED MAX. @ 10"o.c. FULL HEIGHT. c/w SOLI EXT. OSB SHEATHING.

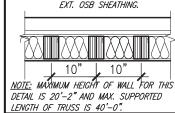

ENERGY STAR V-17

THE MINIMUM THERMAL PERFORMANCE OF BUILDING ENVELOPE AND EQUIPMENT SHALL CONFORM TO THE FOLLOWING:

ENERGY OTHER T	JANUARY 20
COMPONENT	NOTE
CEILING WITH ATTIC SPACE MINIMUM RSI (R) VALUE	10.56 (R60)
CEILING WITHOUT ATTIC SPACE MINIMUM RSI (R) VALUE	5.46 (R31)
EXPOSED FLOOR MINIMUM RSI (R) VALUE	5.46 (R31)
WALLS ABOVE GRADE MINIMUM RSI (R) VALUE	4.75 (R22+R5)
BASEMENT WALLS MINIMUM RSI (R) VALUE	3.52 (R20 BLANKET)
EDGE OF BELOW GRADE SLAB ≤ 600mm BELOW GRADE MINIMUM RSI (R) VALUE	1.76 (R10)
SLAB ≤ 600mm BELOW GRADE MINIMUM RSI (R) VALUE	1.76 (R10)
WINDOWS & SLIDING GLASS DOORS MAXIMUM U-VALUE	ENERGY STAR • •ZONE 2 (ER 29/UV 1.4)
SPACE HEATING EQUIPMENT MINIMUM AFUE	96% AFUE
GAS FIREPLACE	ELECTRONIC SPARK IGNITION
HRV MINIMUM EFFICIENCY	75% SRE ENERGY STAR • *HRV TO BE INTERCONNECTED TO THE FURNACE FAN. MUST BE BALANCED INDICATING ON HIGH SPEED FRESH/STALE
HOT WATER TANK	CONDENSING HOT WATER TANK 90% TE ENVIROSENCE
DRAIN WATER HEAT RECOVERY	TWO SHOWERS > 42%
AIR TIGHTNESS MUST MEET MINIMUM	DETACHED LEVEL 1 (2.5 ACH/0.18 NLR) ATTACHED LEVEL 1 (3.0 ACH/0.26 NLR)
DUCT SEALING	ALL SUPPLY DUCTS & 1m OF RETURN DUCTS
LIGHTS	75% CFLs OR LEDs

UNINSULATED OPEN	NGS (PER OB	C. SB-12,3.1.1	(7))
GLENWAY 12A-036, ELEV. 2	ENERGY EFF	TICIENCY - ENE	RGY STAR
ELEVATION	WALL AREA S.F.	OPENING S.F.	PERCENTAGE
FRONT	824.5 S.F.	112.66 S.F.	13.66 %
LEFT SIDE	1223.3 S.F.	257.69 S.F.	21.07 %
RIGHT SIDE	1243.1 S.F.	9.33 S.F.	0.75 %
REAR	742.3 S.F.	167.01 S.F.	22.50 %
* OPENINGS OMITTED AS PER SB-12 3.1.1.9(4) MAX 19.9 S.F. REFER TO ELEVATION FOR LOCATION		0.0 S.F.	
TOTAL SQ. FT.	4033.20 S.F.	546.69 S.F.	13.55 %
TOTAL SQ. M.	374.69 S.M.	50.79 S.M.	13.55 %

AREA CALCULATIONS	ELEV '2'
GROUND FLOOR AREA SECOND FLOOR AREA	1451 SF 1507 SF
TOTAL FLOOR AREA	2958 SF (274.81 m2)
FIRST FLOOR OPEN AREA SECOND FLOOR OPEN AREA	XX SF 73 SF
ADD TOTAL OPEN AREAS ADD FINISHED BSMT AREA	+73 SF +XX SF
GROSS FLOOR AREA	3031 SF (281.59 m2)
GROUND FLOOR COVERAGE GARAGE COVERAGE/AREA PORCH COVERAGE/AREA	1457 SF 398 SF 182 SF
COVERAGE W/ PORCH	2037 SF (189.24 m2)
COVERAGE W/O PORCH	1855 SF (172.33 m2)

TOWN OF EAST GWILLIMBURY **BUILDING STANDARDS BRANCH**

THIS PERMIT APPLICATION HAS BEEN REVIEWED FOR COMPLIANCE WITH THE ZONING BY-LAW 2018-043, AS AMENDED

FOR	.Model Review
	cfoster
DATE	21/0.1/2021



These plans have been reviewed for use with the corrections as noted. No other changes may be made without written approval of the Building Standards Branch. All work must comply with Stationards Branch. All work must comply win Zoning By-Law 2018-043, as amended, and the Ontario Building Code, as amended. These approved documents must be kept on site at all times. The building permit must be clearly posted on site at all times.

Discipline	Reviewer	BCIN	Date
Building Code	H. Authier	43236	2021-02-03
Sewage System			
Zoning			





1702

GLENWAY 12A-036 **ENERGY STAR**




18				9				The u
17				8				and h Ontari
16				7	CUSTOM PLAN PER PURCHASER.	DEC 8/20	GW	qualifi
15				6	E-STAR UPDATED.	JAN 31/19	GW	Rich
14				5	ISSUED FOR PERMIT.	NOV. 23/17	GW	name
13				4	ROOF SLOPE OVER OTB CHANGED TO 8:12.	OCT. 04/17	GW	registi VA3
12				3	REV. PER CLIENT COMMENTS.	SEP. 05/17	GW	_
11				2		AUG. 30/17		Contro discre
10				1	ISSUED FOR CLIENT REVIEW.	AUG. 14/17	GW	drawin of the
10.	description	date	by	no.	description	date	by	Drawin
				=				V








		*	G	reer	npa
INAR	HALL	HOMES	INC.		To

					GLENWAY	12A
name IAR HALL	HOMES	INC.	Town of EAST GV	municipality WILLIMBURY		1
2017			(GENERAL NO	TES & CHARTS	drawin
by	checked I	3/16" = 1'-0"		1702	file name 6-GLENWAY-12A-036	Α

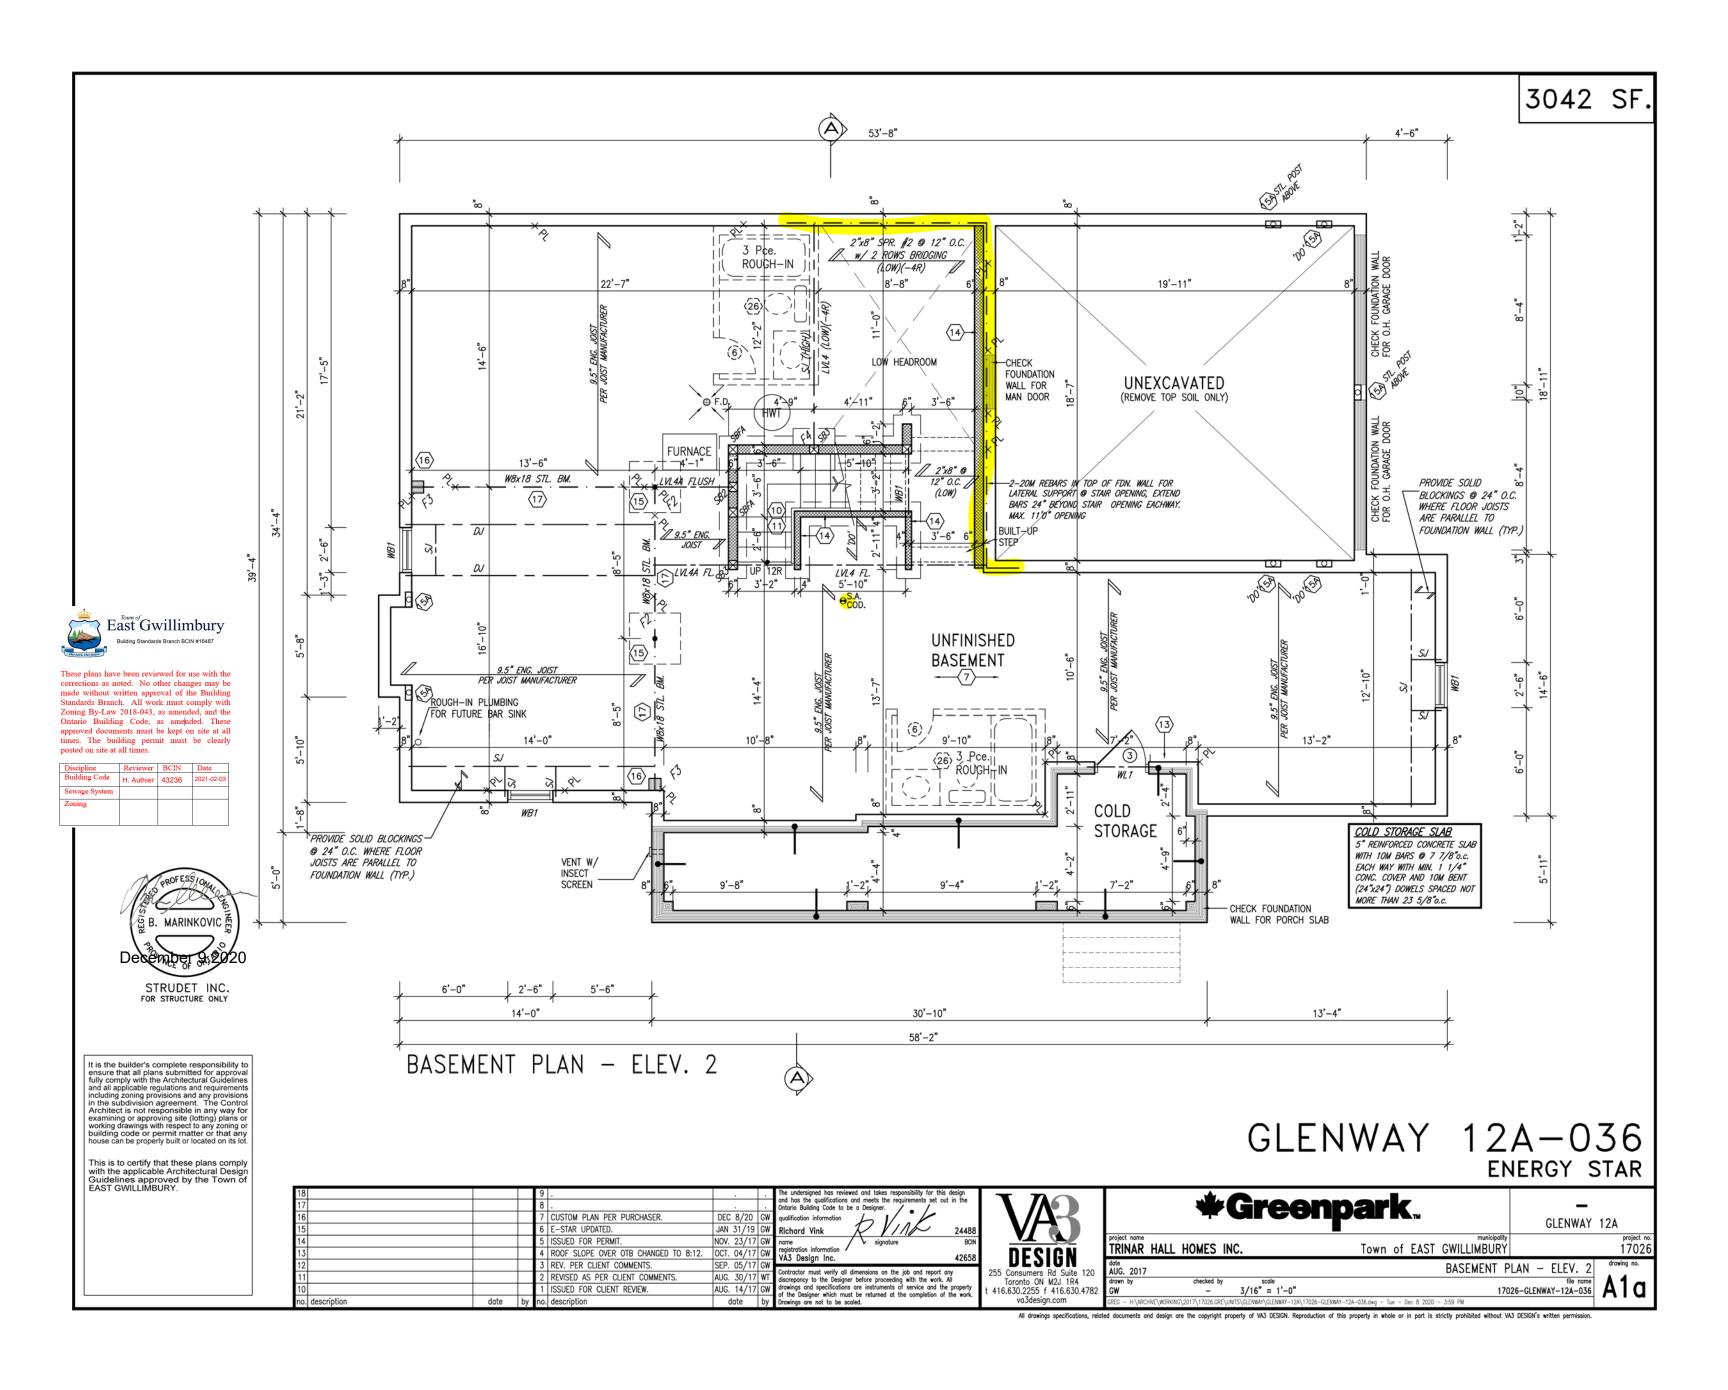


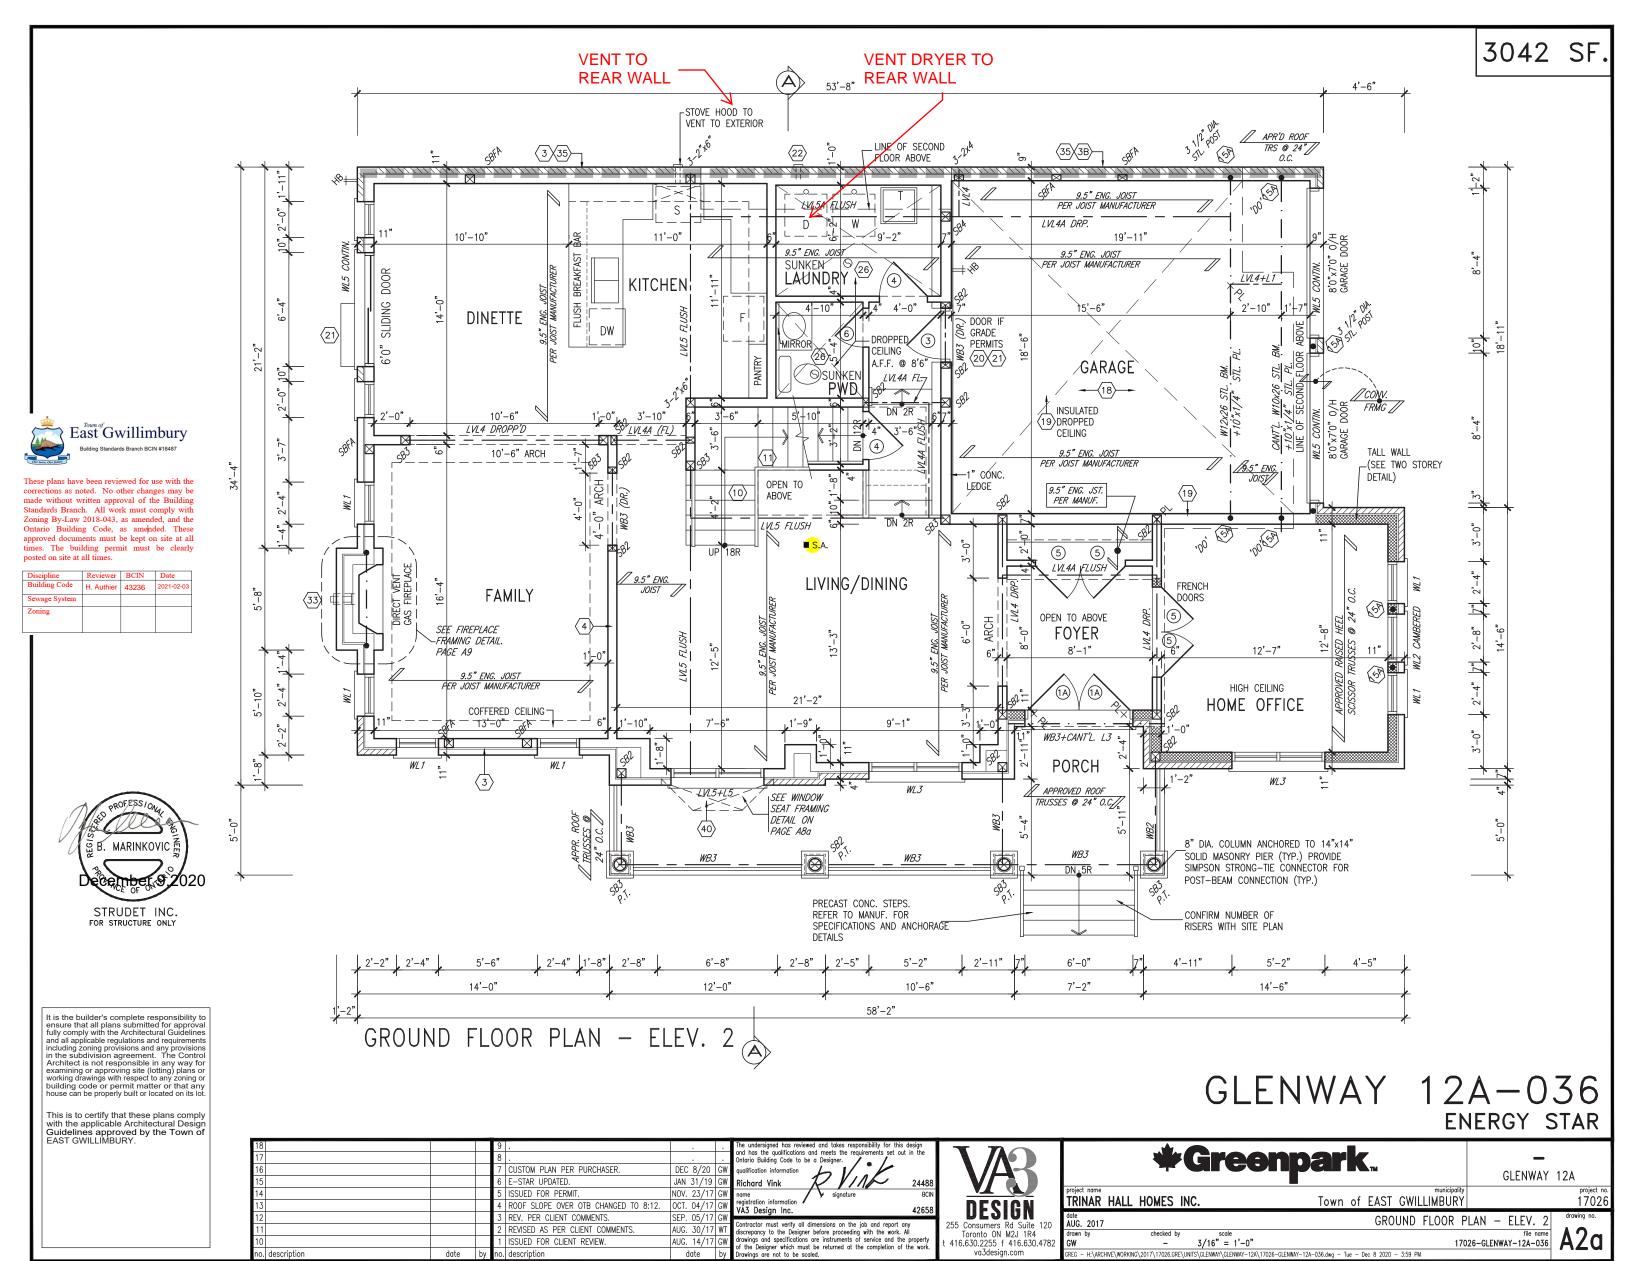


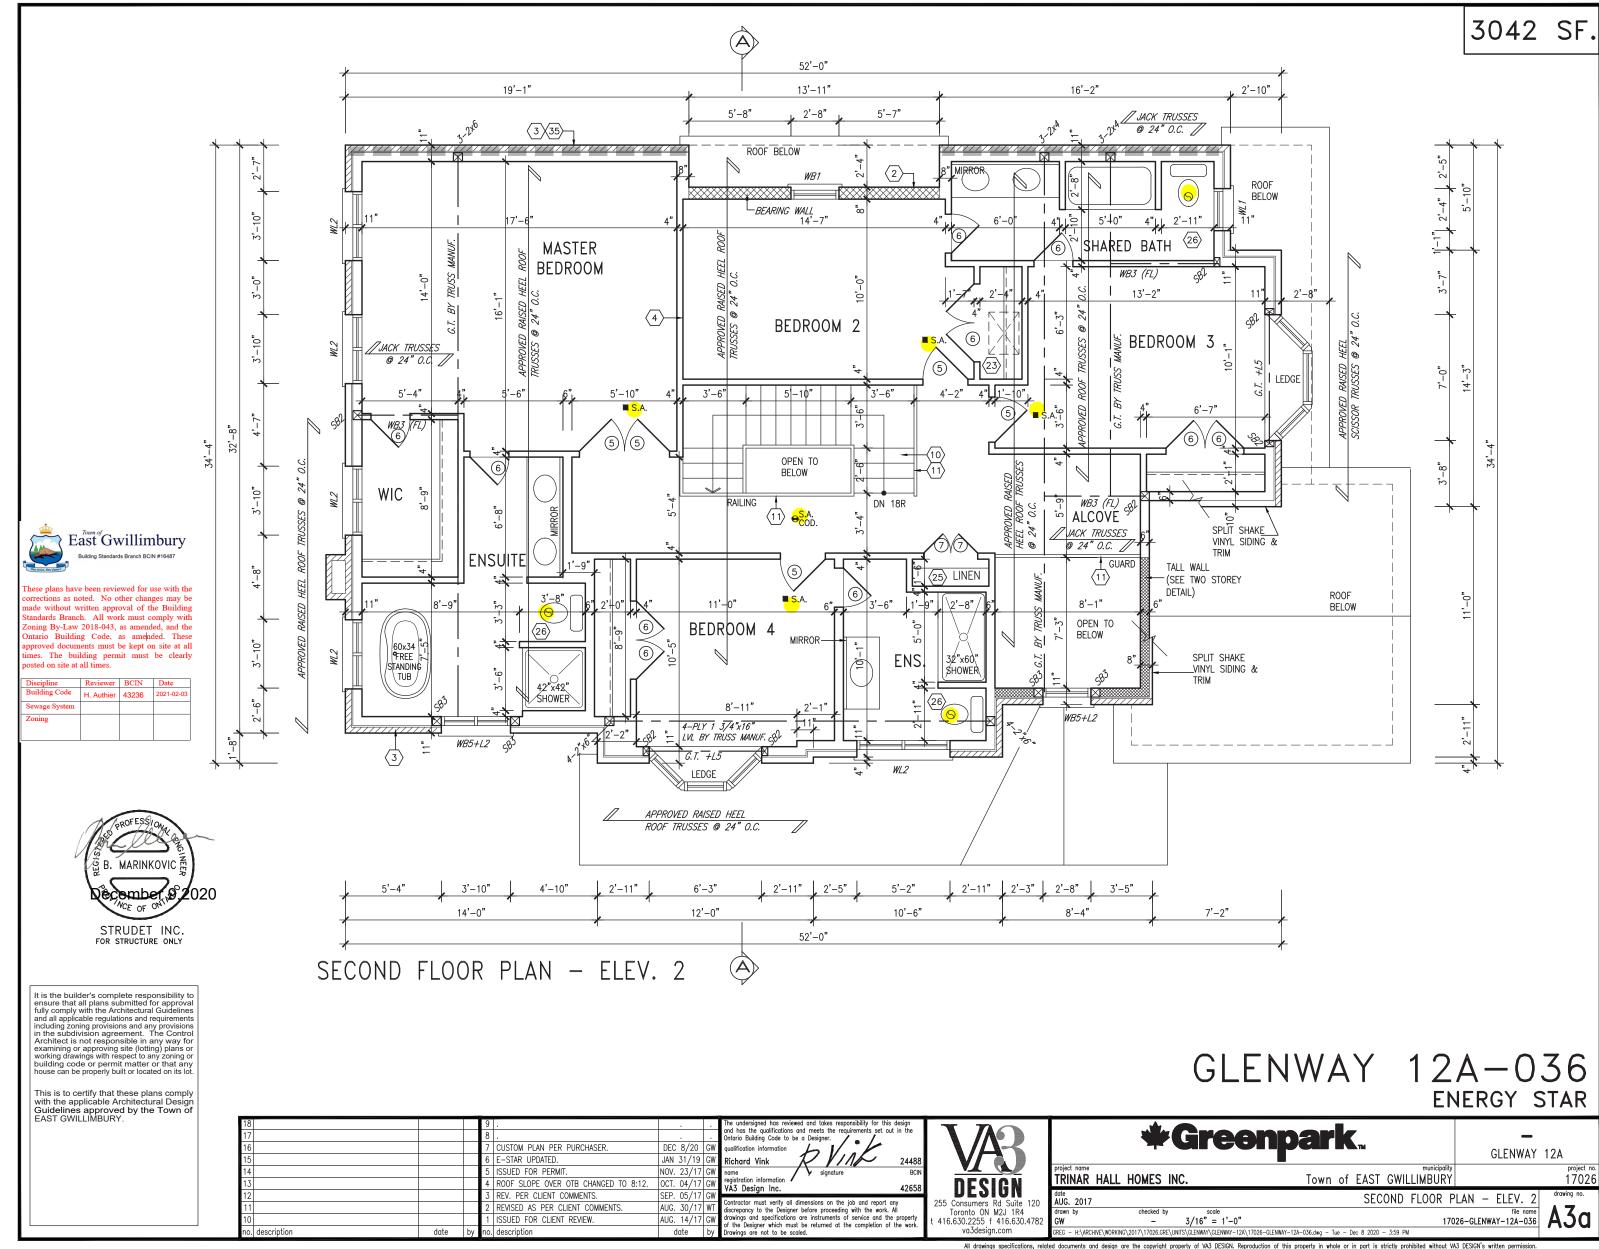


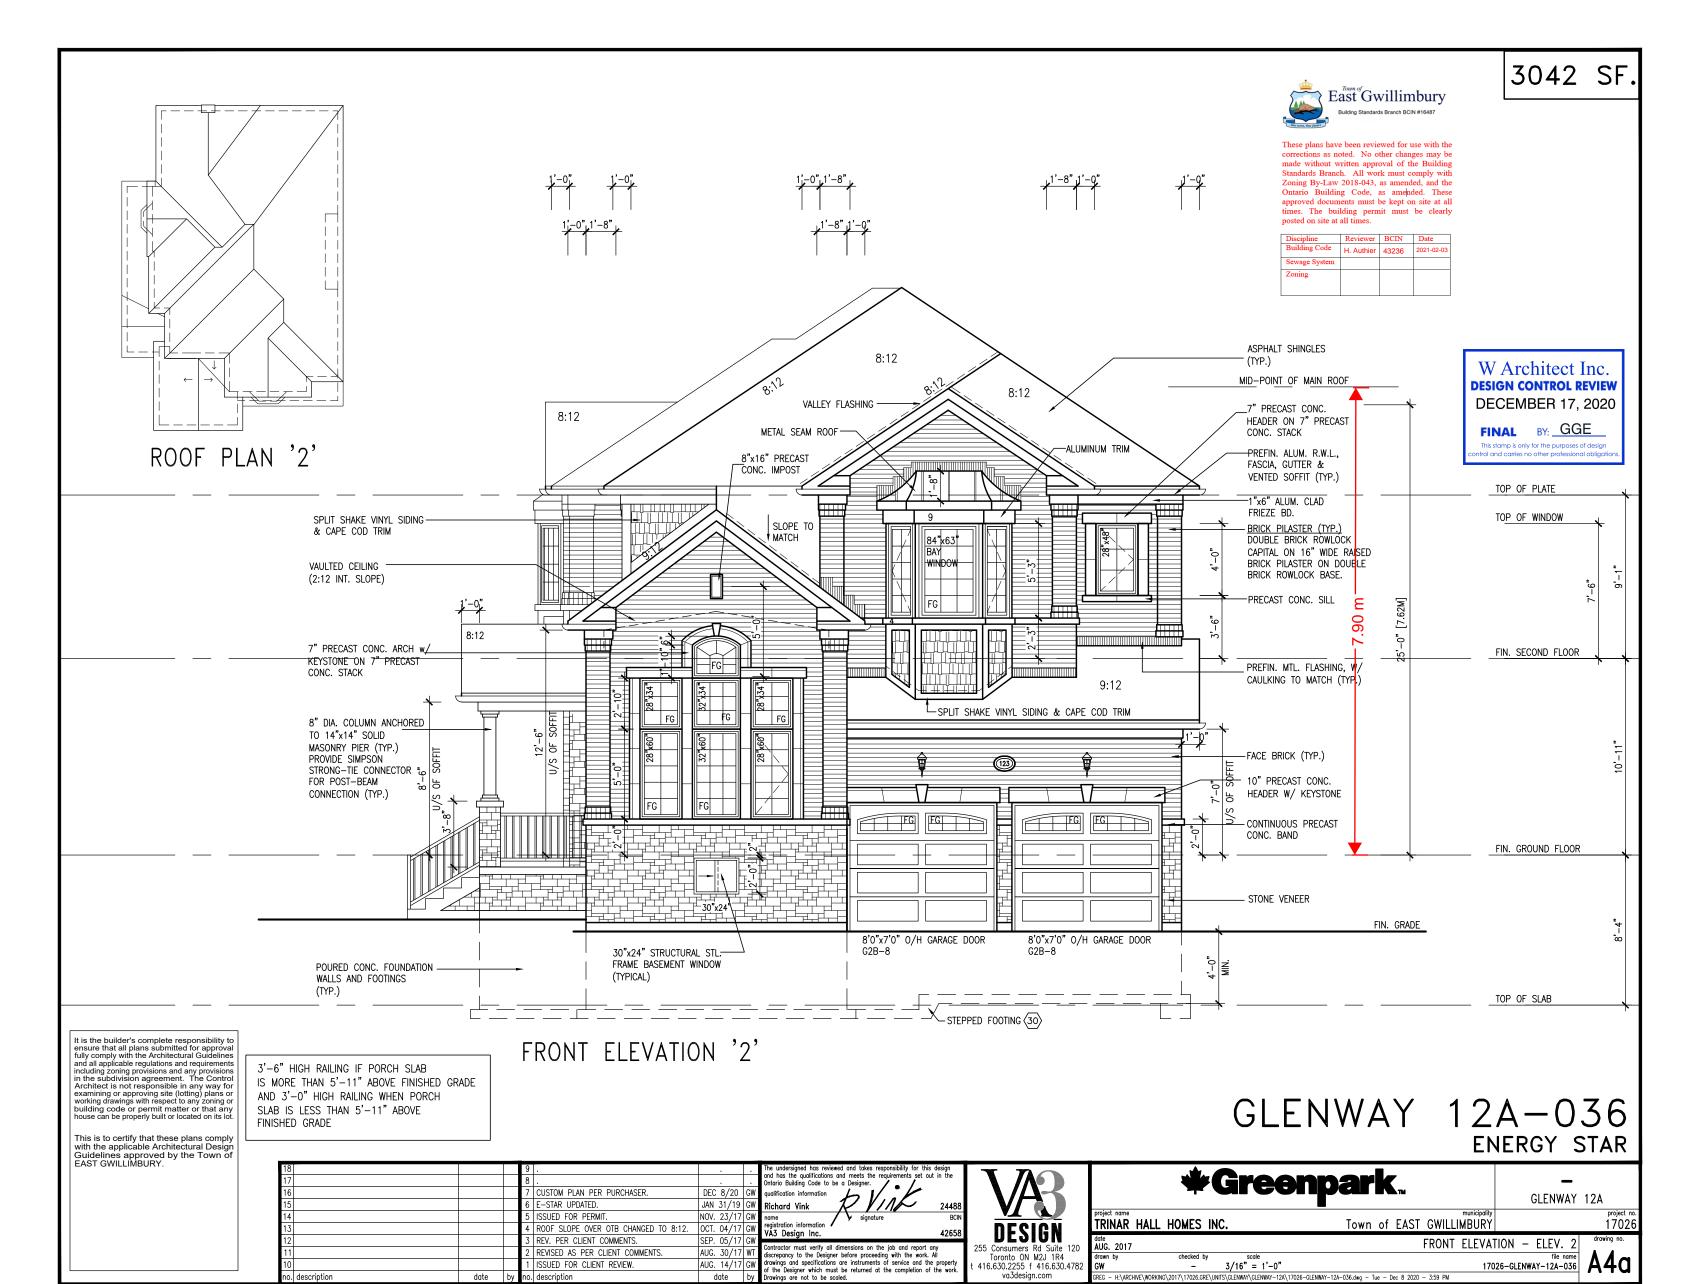

All drawings specifications, related documents and design are the copyright property of VA3 DESIGN. Reproduction of this property in whole or in part is strictly prohibited without VA3 DESIGN's written permissions.

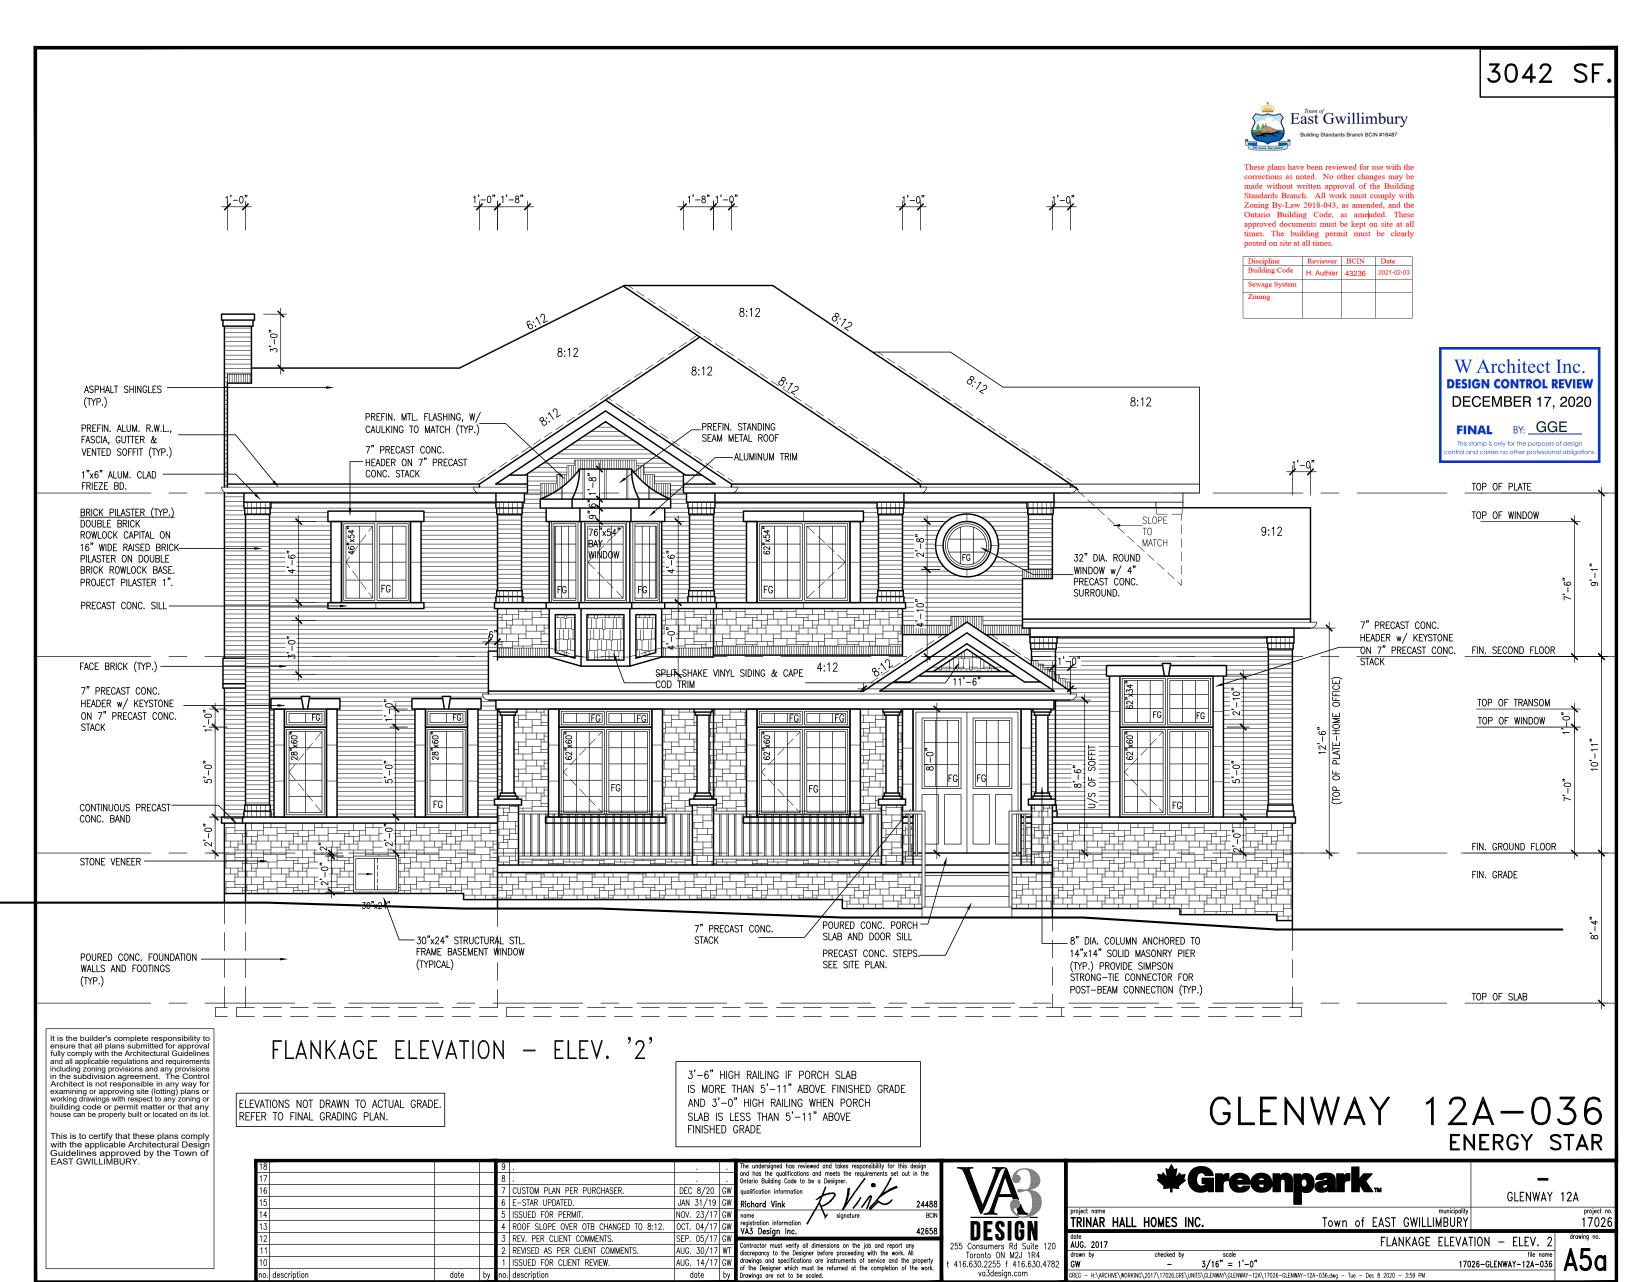

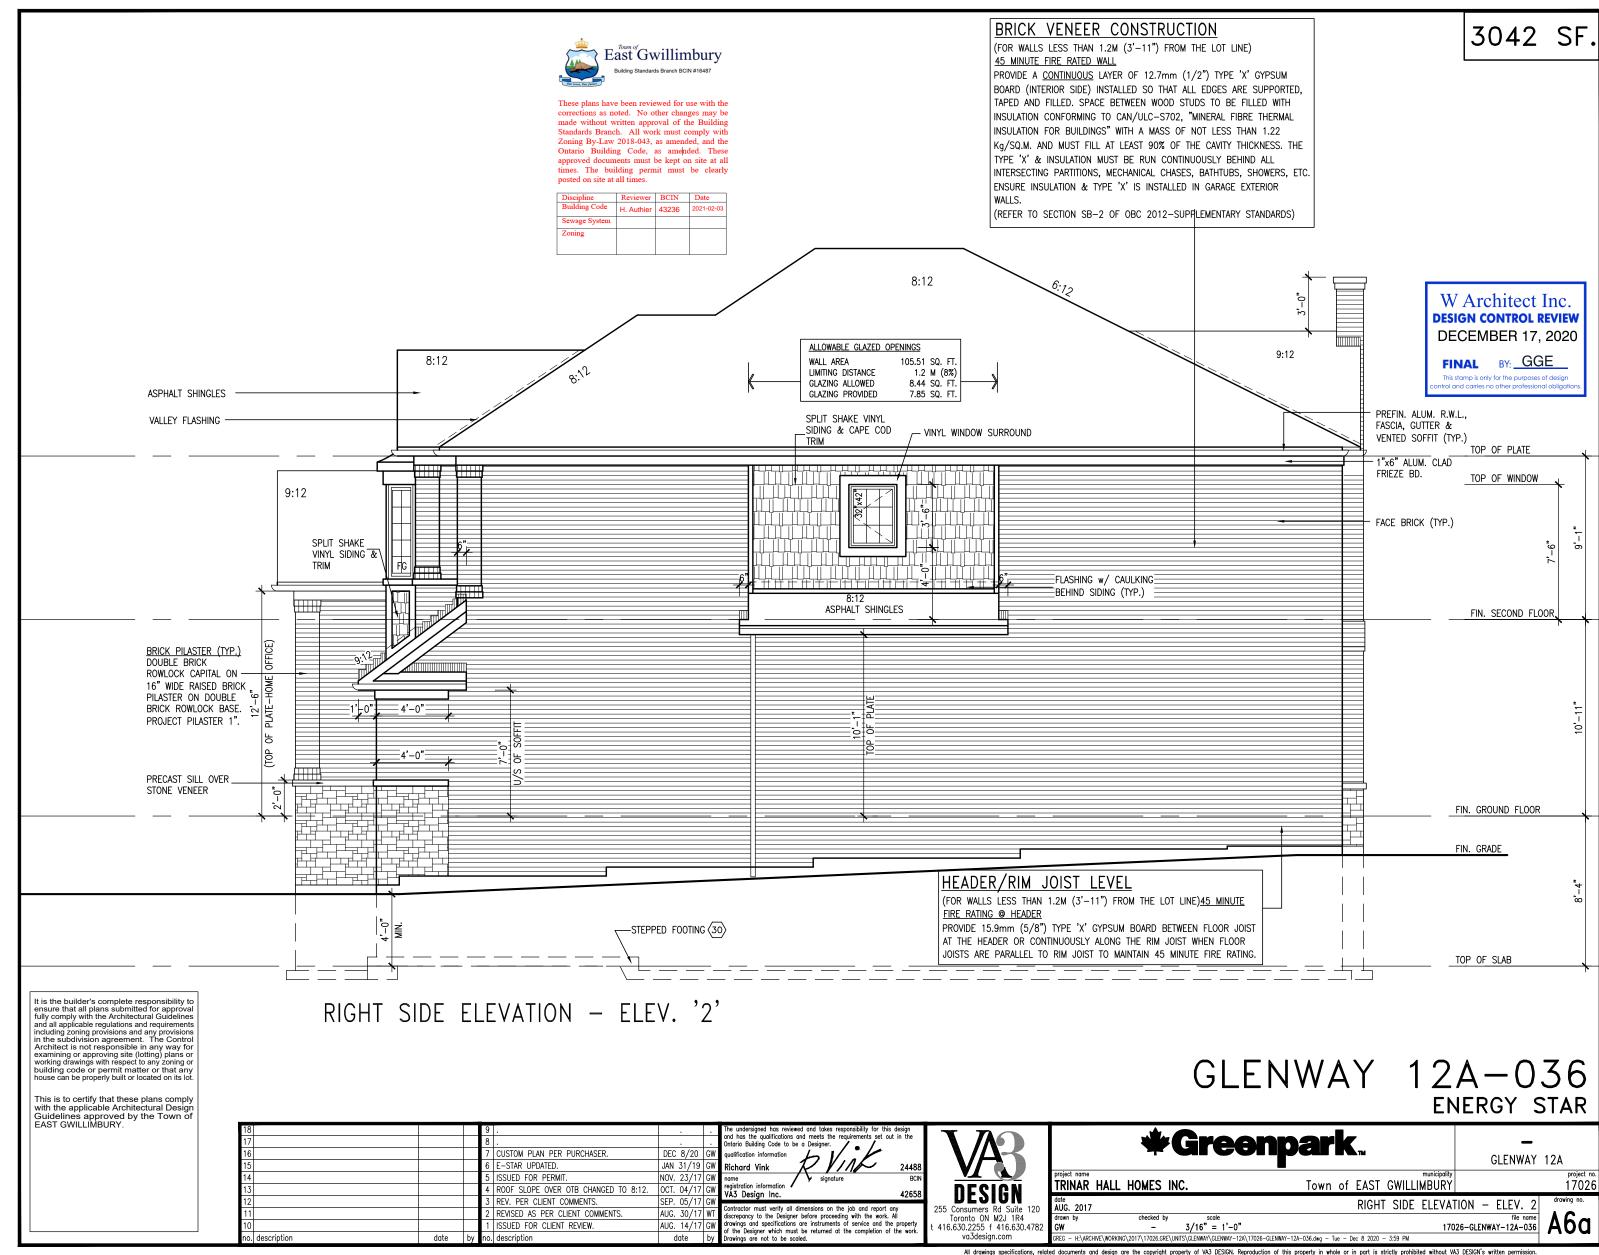

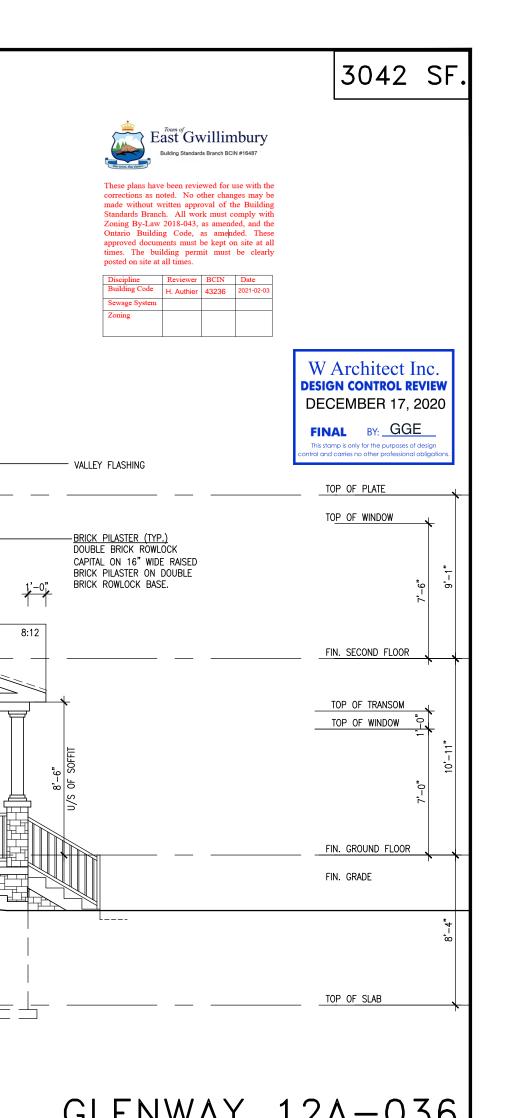

It is the builder's complete responsibility to ensure that all plans submitted for approval fully comply with the Architectural Guidelines and all applicable regulations and requirements including zoning provisions and any provisions in the subdivision agreement. The Control Architect is not responsible in any way for examining or approving site (lotting) plans or working drawings with respect to any zoning or building code or permit matter or that any house can be properly built or located on its lot.

This is to certify that these plans comply with the applicable Architectural Design Guidelines approved by the Town of EAST GWILLIMBURY.

REAR ELEVATION '2'

POURED CONC. DOOR SILL — & PRECAST CONC. STEP

 $\overline{\Box}$

1'-0"

ASPHALT SHINGLES

7" PRECAST CONC.

FACE BRICK (TYP.)-

PRECAST CONC. SILL-

7" PRECAST CONC.

(TYP.)

HEADER w/ KEYSTONE

HEADER

PREFIN. ALUM. R.W.L.. FASCIA.-GUTTER & VENTED SOFFIT (TYP.)

1"x6" ALUM. CLAD FRIEZE BD.

GLENWAY 12A-036 **ENERGY STAR**

Town of EAST GWILLIMBURY

GLENWAY 12A

REAR ELEVATION - ELEV. 2

17026

1	8			9 .			The undersigned has reviewed and takes responsibility for this design and has the qualifications and meets the requirements set out in the		TA			
1	6			7 CUSTOM PLAN PER PURCHASER.	DEC 8/20	GW	Ontario Building Code to be a Designer. qualification information		Ι \		Tures	npark
1	5			6 E-STAR UPDATED.			Richard Vink DVIII 2448	488				
1	4				NOV. 23/17	' GW		BCIN		project name	L HOMES INC.	Town of EAST
1	3			4 ROOF SLOPE OVER OTB CHANGED TO 8:12.	OCT. 04/17	' GW	registration information / VA3 Design Inc. 426	658	DESIGN	IKINAK HAI	L HUMES INC.	TOWN OF EASI
1	2			3 REV. PER CLIENT COMMENTS.	SEP. 05/17	' GW			DESIDIA 100	date AUG. 2017		
1	1			2 REVISED AS PER CLIENT COMMENTS.	AUG. 30/17	WT	Contractor must verify all dimensions on the job and report any discrepancy to the Designer before proceeding with the work. All		255 Consumers Rd Suite 120 Toronto ON M2J 1R4	drawn by	checked by scale	
1	0			1 ISSUED FOR CLIENT REVIEW.	AUG. 14/17	7 GW	drawings and specifications are instruments of service and the propert of the Designer which must be returned at the completion of the world		t 416.630.2255 f 416.630.4782		- 3/16" = 1'-0"	
n	o. description	date	by	no. description	date	by	Drawings are not to be scaled.	JIK.	va3design.com	GREG - H:\ARCHIVE\WO	RKING\2017\17026.GRE\UNITS\GLENWAY\GLENWAY-12A\17	026-GLENWAY-12A-036.dwg - Tue - Dec 8 2020

6:12

FG FG

FG

└ _30¶x₽4"

-30"x24" STRUCTURAL STL. FRAME BASEMENT

WINDOW (TYPICAL)


19'-4"

8:12

CONT. PRECAST CONC. BAND

- STONE VENEER



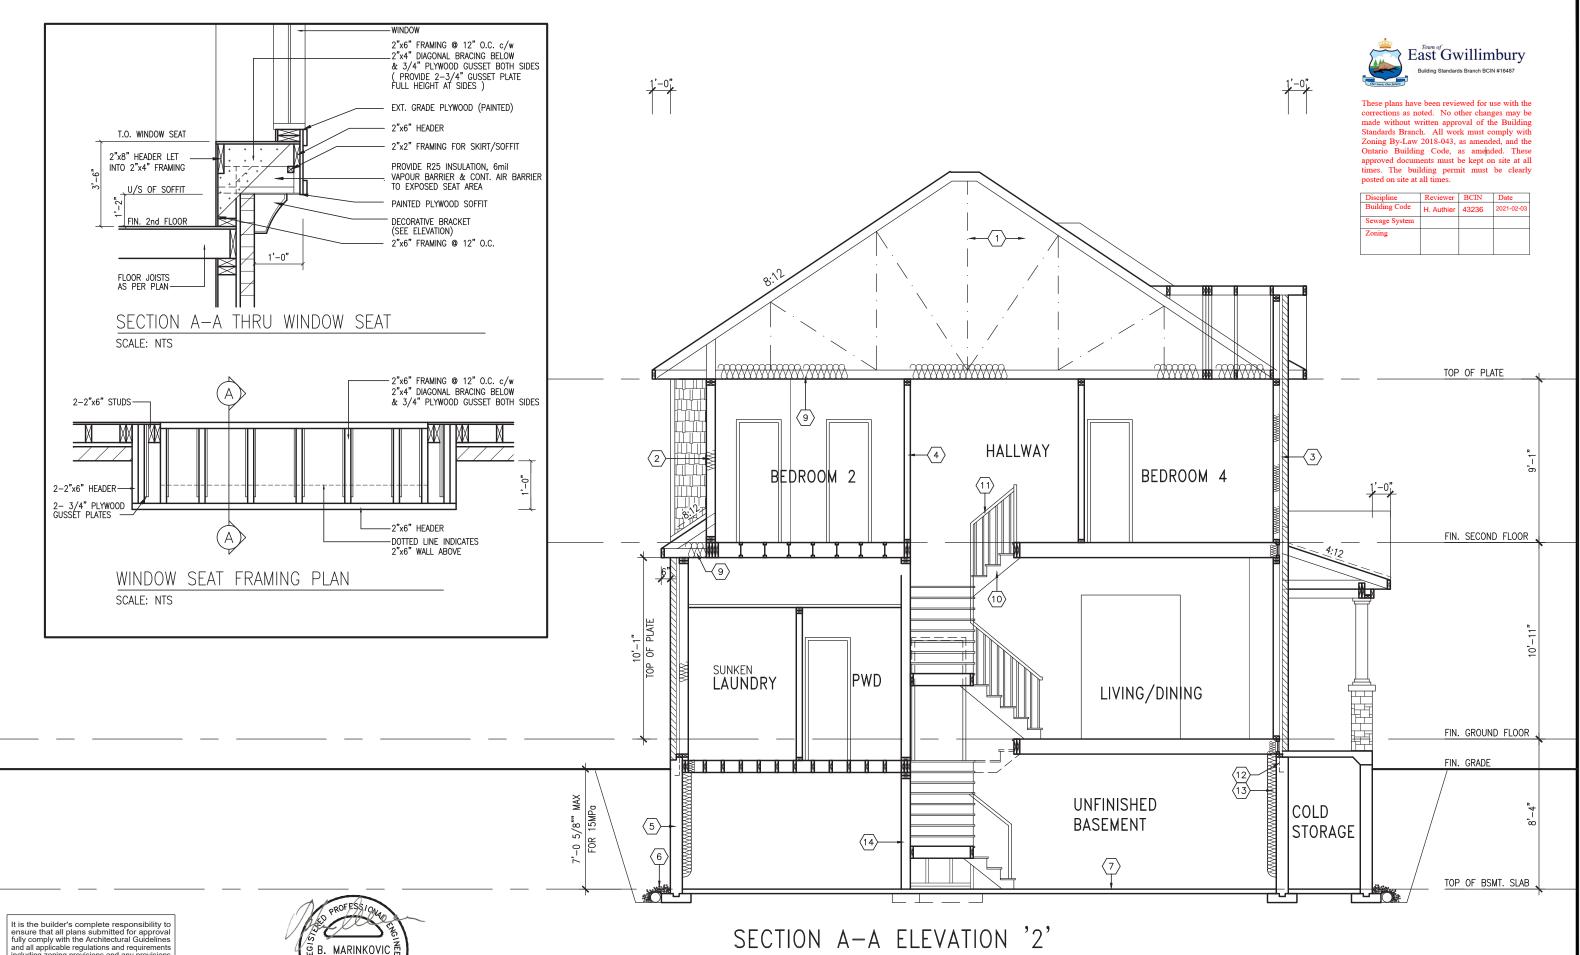

It is the builder's complete responsibility to ensure that all plans submitted for approval fully comply with the Architectural Guidelines and all applicable regulations and requirements including zoning provisions and any provisions in the subdivision agreement. The Control Architect is not responsible in any way for examining or approving site (lotting) plans or working drawings with respect to any zoning or building code or permit matter or that any house can be properly built or located on its lot.

This is to certify that these plans comply with the applicable Architectural Design Guidelines approved by the Town of EAST GWILLIMBURY.




GLENWAY 12A-036 ENERGY STAR

18			9				The undersigned has reviewed and takes responsibility for this design
17			8				and has the qualifications and meets the requirements set out in the Ontario Building Code to be a Designer.
16			7	CUSTOM PLAN PER PURCHASER.			qualification information
15			6	E-STAR UPDATED.	JAN 31/19	GW	Richard Vink 24488
14			5		NOV. 23/17		
13			4	ROOF SLOPE OVER OTB CHANGED TO 8:12.	OCT. 04/17	GW	registration information / VA3 Design Inc. 42658
12			3	REV. PER CLIENT COMMENTS.	SEP. 05/17	GW	The besign me.
11			2	REVISED AS PER CLIENT COMMENTS.	AUG. 30/17	WT	Contractor must verify all dimensions on the job and report any discrepancy to the Designer before proceeding with the work. All
10			1	ISSUED FOR CLIENT REVIEW.	AUG. 14/17	GW	drawings and specifications are instruments of service and the property of the Designer which must be returned at the completion of the work.
no. description	date	by	no.	description	date	by	Drawings are not to be scaled.

8 IN	$\overline{\mathbb{M}}$
8	DESIGN
	255 Consumers Rd Suite 120 Toronto ON M2J 1R4 t 416.630.2255 f 416.630.4782

		*	GLENWAY	12A		
	project name TRINAR HA	LL HOMES	INC.	municipality Town of EAST GWILLIMBURY		project no. 17026
20	date AUG. 2017			SECTION	A-A - ELEV. 2	drawing no.
782	drawn by GW	checked I	3/16" = 1'-	0" 170	file name 126-GLENWAY-12A-036	A8a l

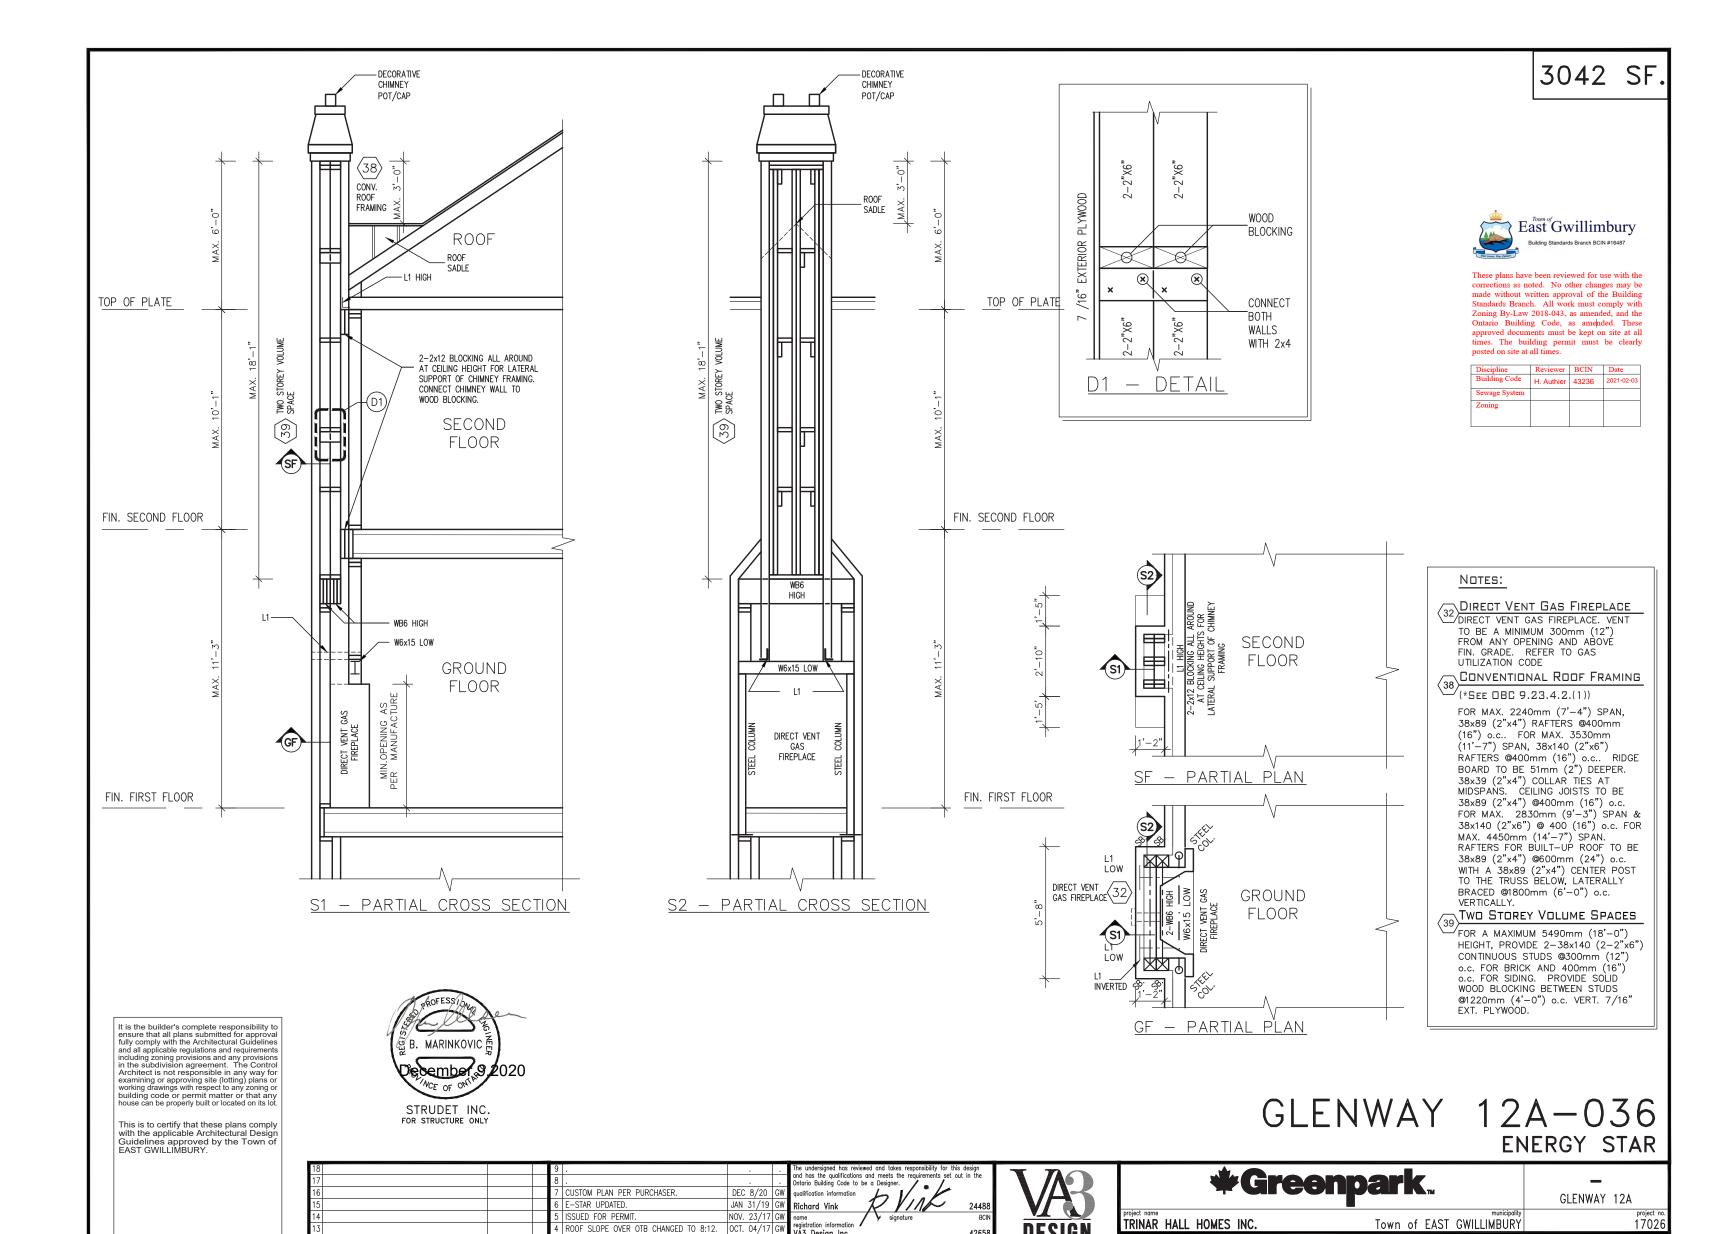

AUG. 30/17

AUG. 14/17 0

ISSUED FOR CLIENT REVIEW.

3/16" = 1'-0"

DETAILS

17026-GLENWAY-12A-036

ate AUG. 2017

ronto ON M2J 1R4

416 630 2255 f 416 630 4782