

## CONSTRUCTION NOTES (Unless otherwise noted)

ALL CONSTRUCTION TO ADHERE TO THESE PLANS AND SPEC'S AND TO CONFORM TO THE ONTARIO BUILDING CODE AND ALL OTHER APPLICABLE CODES AND AUTHORITIES HAVING JURISDICTION. THESE REQUIREMENTS ARE TO BE TAKEN AS MINIMUM SPECIFICATIONS. ONT. REG. 332/12-2012 OBC.

### 1. ROOF CONSTRUCTION

NO.210 (10.25kg/m<sup>2</sup>) ASPHALT SHINGLES, 10mm (3/8") PLYWOOD SHEATHING WITH "H" CLIPS. APPROVED WOOD TRUSSES @ 610mm (24") O.C. MAX. APPROVED EAVES PROTECTION TO EXTEND 900mm (3'-0") FROM EDGE OF ROOF AND MIN. 300mm (12") BEYOND INNER FACE OF EXTERIOR WALL, (EAVES PROTECTION NOT REQ'D FOR ROOF SLOPES 8:12 OR GREATER) 38x89 (2"x4") TRUSS BRACING @ 1830mm (6'-0") O.C. AT BOTTOM CHORD. PREFIN. ALUM. EAVESTROUGH, FASCIA, RVL & VENTED SOFFIT. PROVIDE ICE & WATER SHIELD TO ALL ROOF/WALL SURFACES SUSCEPTIBLE TO ICE DAMMING. ROOF SHEATHING TO BE FASTENED 150 (6") C/C ALONG EDGES & INTERMEDIATE SUPPORTS WHEN TRUSSES SPACED GREATER THAN 406 (16"). ATTIC VENTILATION 1:300 OF INSULATED CEILING AREA WITH MIN. 25% AT EAVES & MIN. 25% AT RIDGE (OBC 9.19.1.2.).

### 2. FRAME WALL CONSTRUCTION (2"x6") (REFER TO B.O.P. FORM)

SIDING, HARDIE BOARD, STUCCO BOARD OR EQUAL AS PER ELEVATION, 19x64 (1"x3") VERTICAL WOOD FURRING, APPROVED SHEATHING PAPER, MIN. RSI. 0.88 (R-5) RIGID INSULATION, 38x140 (2"x6") STUDS @ 400mm (16") O.C. FILLED WITH MIN. RSI. 3.87 (R-22) BATT INSULATION, TOTAL MIN. RSI. 4.75 (R-27). APPROVED DIAGONAL WALL BRACING, VAPOUR BARRIER AND CONT. AIR BARRIER, 13mm (1/2") INT. DRYWALL FINISH.

### 2B. FRAME WALL CONSTRUCTION - GARAGE WALLS

SIDING AS PER ELEV., 19x38 (1"x2") VERTICAL WOOD FURRING, CONTIN. SHEATHING MEMBRANE, 9.5mm (3/8") EXT. TYPE SHEATHING, 38x89 (2"x4") STUDS @ 406mm (16") O.C. ((FOR MAX. HEIGHT 3000mm (9'-10") OR 38x140 (2"x6") STUDS @ 406mm (16") O.C. (FOR MAX. HEIGHT OF 3.6m (11'-10") WITH APPROVED DIAGONAL WALL BRACING. 13mm (1/2") INTERIOR DRYWALL FINISH. REFER TO NOTE 19 WHERE FLOOR EXISTS ABOVE GARAGE. SIDING TO BE MIN. 200mm (8") ABOVE FINISH GRADE.

### 2C. STUCCO WALL CONSTRUCTION (2"x6") (REFER TO B.O.P. FORM)

STUCCO CLADDING SYSTEM CONFORMING TO O.B.C. 9.27.1.1.(2) & 9.28 THAT EMPLOY A MINIMUM 6mm (1/4") AIR SPACE BEHIND THE CLADDING WITH POSITIVE DRAINAGE TO THE EXTERIOR AND APPLIED PER MANUFACTURERS SPECIFICATIONS ON 25mm (1") MIN. EXTRUDED OR EXPANDED RIGID POLYSTYRENE, APPROVED SHEATHING PAPER, MINIMUM RSI. 0.88 (R-5) RIGID INSULATION, 38x140 (2"x6") STUDS @ 400mm (16") O.C. FILLED WITH MIN. RSI. 3.87 (R22) BATT INSUL. TOTAL MIN. RSI. 4.75 (R-27). APPROVED DIAGONAL WALL BRACING, VAPOUR BARRIER AND CONTIN. AIR BARRIER, 13mm (1/2") GYPSUM BOARD INTERIOR FINISH. STUCCO TO BE MIN. 200 (8") ABOVE FINISH GRADE.

### 2D. STUCCO WALL CONSTRUCTION - GARAGE WALLS

STUCCO CLADDING SYSTEM CONFORMING TO O.B.C. 9.27.1.1.(2) & 9.28 THAT EMPLOY A MINIMUM 6mm (1/4") AIR SPACE BEHIND THE CLADDING WITH POSITIVE DRAINAGE TO THE EXTERIOR AND APPLIED PER MANUFACTURERS SPECIFICATIONS OVER 25mm (1") MIN. EXPANDED OR EXTRUDED RIGID POLYSTYRENE ON APPROVED AIR/MOISTURE BARRIER ON 13mm (1/2") EXT. TYPE SHEATHING ON 38x89 (2"x4") STUDS @ 406mm (16") O.C. ((FOR MAX. HEIGHT 3000mm (9'-10") OR 38x140 (2"x6") STUDS @ 406mm (16") O.C. (FOR MAX. HEIGHT OF 3.6m (11'-10") WITH APPROVED DIAGONAL WALL BRACING. 13mm (1/2") INTERIOR DRYWALL FINISH. REFER TO NOTE 19 WHERE FLOOR EXISTS ABOVE GARAGE. STUCCO TO BE MIN. 200mm (8") ABOVE FINISH GRADE.

### 3. BRICK VENEER CONSTRUCTION (2"x6") (REFER TO B.O.P. FORM)

90mm (4") FACE BRICK, 25mm (1") AIR SPACE, 22x180x0.76mm (7/8"x7"x0.03") GALV. METAL TIES @ 406mm (16") O.C. HORIZONTAL 600mm (24") O.C. VERTICAL. APPROVED SHEATHING PAPER, MIN. RSI. 0.88 (R-5) RIGID INSULATION, 38x140 (2"x6") STUDS @ 400mm (16") O.C. FILLED WITH MIN. RSI. 3.87 (R-22) BATT INSULATION, TOTAL MIN. RSI. 4.75 (R-27). APPROVED DIAGONAL WALL BRACING, VAPOUR BARRIER AND CONT. AIR BARRIER, 13mm (1/2") INT. DRYWALL FINISH. PROVIDE WEEP HOLES @ 800mm (32") O.C. BOTTOM COURSE AND OVER OPENINGS. PROVIDE BASE FLASHING UP MIN. 150mm (6") BEHIND BUILDING PAPER.

### 3B. BRICK VENEER CONSTRUCTION - GARAGE WALLS

90mm (4") FACE BRICK, 25mm (1") AIR SPACE, 22x180x0.76mm (7/8"x7"x0.03") GALV. METAL TIES @ 406mm (16") O.C. HORIZONTAL 610mm (24") O.C. VERTICAL. APPROVED SHEATHING PAPER, 9.5mm (3/8") EXTERIOR TYPE SHEATHING, 38x89 (2"x4") STUDS @ 406mm (16") O.C. ((FOR MAX. HEIGHT 3000mm (9'-10") OR 38x140 (2"x6") STUDS @ 406mm (16") O.C. (FOR MAX. HEIGHT OF 3.6m (11'-10") WITH APPROVED DIAGONAL WALL BRACING. 13mm (1/2") INTERIOR DRYWALL FINISH. REFER TO NOTE 19 WHERE FLOOR EXISTS ABOVE GARAGE. PROVIDE WEEP HOLES @ 800mm (32") O.C. BOTTOM COURSE AND OVER OPENINGS. PROVIDE BASE FLASHING UP MIN. 150mm (6") BEHIND BUILDING PAPER. BRICK TO BE MIN. 150mm (6") ABOVE FINISH GRADE.

### 4. INTERIOR STUD PARTITIONS

FOR BEARING PARTITIONS 38x89 (2"x4") @ 406mm (16") O.C. FOR 2 STOREYS AND 305mm (12") O.C. FOR 3 STOREYS, NON-BEARING PARTITIONS 38x89 (2"x4") @ 610mm (24") O.C. PROVIDE 38x89 (2"x4") BOTTOM PLATE AND 2/38x89 (2/2"x4") TOP PLATE. 13mm (1/2") INT. DRYWALL BOTH SIDES OF STUDS, PROVIDE 38x140 (2"x6") STUDS/PLATES WHERE NOTED.

### 5. FOUNDATION WALL/FOOTINGS: (9.15.3, 9.15.4, 9.13.2, 9.14.2.1(2))

200mm (8") POURED CONC. FDTN. WALL 15MPa (2200psi) WITH BITUMENOUS DAMPROOFING AND DRAINAGE LAYER. DRAINAGE LAYER REQ'D. WHEN BASEMENT INSUL. EXTENDS 900 (2'-11") BELOW FIN. GRADE. DRAINAGE LAYER IS NOT REQ'D. IF FOUNDATION WALL IS WATERPROOFED. MAXIMUM POUR HEIGHT 2390 (7'-10") ON 500x155 (20"x6") CONTINUOUS KEYED CONC. FTG. BRACE FDTN. WALL PRIOR TO BACKFILLING. ALL FOOTINGS SHALL REST ON NATURAL UNDISTURBED SOIL OR COMPACTED ENGINEERED FILL.

### \* REFER TO UNIT PLANS FOR STRIP FOOTING SIZES \*

-MAXIMUM FLOOR LIVE LOAD OF 2.4kPa. (50psf.) PER FLOOR. -REFER TO SOILS REPORT FOR SOIL CONDITIONS AND BEARING CAPACITY.

### 6. FOUNDATION DRAINAGE OBC. 9.14.2. & 9.14.3.

100mm (4") DIA. FOUNDATION DRAINAGE TILE 150mm (6") CRUSHED STONE OVER AND AROUND DRAINAGE TILES.

### 7. BASEMENT SLAB OBC. 9.3.1.6(1)(b), 9.16.4.5(1), 9.25.3.3(15)

80mm (3") MIN. 25MPa (3600psi) CONC. SLAB ON 100mm (4") COARSE GRANULAR FILL, OR 15MPa. (2200psi) CONC. WITH DAMPROOFING BELOW SLAB. UNDER SLAB INSULATION PER B.O.P. FORM where required. ALL SLAB JOINTS & PENETRATIONS TO BE SEALED TO MAINTAIN AIR BARRIER.

### 8. WOOD SUBFLOORS (SEE OBC. 9.23.14. & 9.30.2.1)

-19mm (3/4") MIN. T & G SUBFLOOR UNDER GROUND FLOOR FINISH FLOOR. 16mm (5/8") T&G SUBFLOOR UNDER SECOND FLOOR FINISH FLOOR. 16mm (5/8") PANEL-TYPE UNDERLAY FOR CERAMIC TILE APPLICATION. 6mm (1/4") PANEL-TYPE UNDERLAYMENT UNDER RESILIENT & PARQUET FLOORING.

### 9. ATTIC INSULATION (REFER TO B.O.P. FORM)

RSI 10.56 (R60) BLOWN IN ROOF INSULATION AND APPROVED VAPOUR BARRIER, 16mm (5/8") INT. DRYWALL FINISH OR APPROVED EQUAL. RSI 3.52 (R20) MIN. ABOVE INNER SURFACE OF EXTERIOR WALL.

### 10. ALL STAIRS/EXTERIOR STAIRS - OBC. 9.8 -

UNIFORM RISE 5mm (1/4") MAX BETWEEN ADJACENT TREADS OR LANDINGS -10mm (1/2") MAX BETWEEN TALLEST & SHORTEST RISE IN FLIGHT

MAX. RISE = 200 (7'-7/8")  
MIN. RUN = 210 (8'-1/4")  
MIN. TREAD = 235 (9'-1/4")  
MAX. NOSING = 25 (1")  
MIN. HEADROOM = 1950 (6'-5")  
RAIL @ LANDING = 900 (2'-11")  
RAIL @ STAIR = 865 (2'-10") to 965 (3'-2")  
MIN. STAIR WIDTH = 860 (2'-10")  
FOR CURVED STAIRS  
MIN. RUN = 150 (6")  
MIN. AVG. RUN = 200 (8")

### 11. HANDRAILS - OBC. 9.8.7. -

FINISHED RAILING ON PICKETS SPACED MAXIMUM 100mm (4") BETWEEN PICKETS. CLEARANCE BETWEEN HANDRAIL AND SURFACE BEHIND IT TO BE 50 (2") MIN. HANDRAILS TO BE CONTINUOUS EXCEPT FOR NEWEL POST AT CHANGES OF DIRECTION .

### INTERIOR GUARDS - OBC. 9.8.8. -

INTERIOR GUARDS: 900mm (2'-11") MIN. HIGH

### EXTERIOR GUARDS - OBC. 9.8.8.

900mm (36") HIGH GUARD WHERE DISTANCE FROM PORCH TO FIN. GRADE IS LESS THAN 1800mm (71"). 1070mm (42") HIGH GUARD IS REQUIRED WHERE DISTANCE EXCEEDS 1800mm (71").

### 12. SILL PLATE ANCHORAGE

38x89 (2"x4") SILL PLATE WITH 13mm (1/2") DIA. ANCHOR BOLTS 200mm (8") LONG, EMBEDDED MIN. 100mm (4") INTO CONC. @ 2400mm (7'-10") O.C., CAULKING OR 25 (1") MIN. MINERAL WOOL BETWEEN PLATE AND TOP OF FDTN. WALL. USE NON-SHRINK GROUT TO LEVEL SILL PLATE WHEN REQUIRED.

### 13. BASEMENT INSULATION (REFER TO B.O.P. FORM)

FOUNDATION WALLS ENCLOSING HEATED SPACE SHALL BE INSULATED FROM THE UNDERSIDE OF THE SUBFLOOR TO NOT MORE THAN 200mm (8") ABOVE THE FINISHED FLOOR & NO CLOSER THAN 50mm (2") OF THE BASEMENT SLAB. FOUNDATION WALL INSULATION SHALL BE MINIMUM RSI. 3.52 (R20). INSULATION TO HAVE APPROVED VAPOUR BARRIER. DAMPROOF WITH BUILDING PAPER BETWEEN THE FOUNDATION WALL AND INSULATION UP TO GRADE LEVEL. NOTE: FULL HEIGHT INSULATION AT COLD CELLAR WALLS. AIR BARRIER TO BE SEALED TO FOUNDATION WALL WITH CAULKING.

### 14. BASEMENT BEARING STUD PARTITION

38x89/140 (2"x4"/6") STUDS @ 406mm (16") O.C. 38x89/140 (2"x4"/6") SILL PLATE ON DAMPROOFING MATERIAL, 13mm (1/2") DIA. ANCHOR BOLTS 200mm (8") LONG, EMBEDDED MIN. 100mm (4") INTO CONCRETE @ 2400mm (7'-10") O.C. 100mm (4") HIGH CONCRETE CURB ON 305x155 (12"x6") FOR 2x4 STUDWALL OR 400x155 (16"x6") FOR 2x6 STUD WALL, CONCRETE FOOTING. ADD HORIZONTAL BLOCKING AT MID-HEIGHT IF WALL IS UNFINISHED.

### 15. STEEL BASEMENT COLUMN (SEE O.B.C. 9.17.3)

89mm (3-1/2") DIA x 4.78mm(0.188") STEEL COLUMN WITH 150x150x9.5 (6"x6"x3/8") STEEL TOP & BOTTOM PLATE.

### 15A. STEEL COLUMN (SEE O.B.C. 9.17.3)

90mm(3-1/2") DIA x 4.78mm(0.188") STEEL COLUMN WITH 100x100x6.0 (4"x4"x1/4") TOP & BOTTOM PLATES. FIELD WELD BOTTOM PLATE TO 100x250x12.5 (4"x10"x1/2") BASE PLATE C/W 2-12mm DIA. x 300mm LONG x50mm HOOK ANCHORS (2-1/2"x12"x2"). THE COLUMN TO STUD WALL WITH 2-32x3.175 (1 1/4"x 1/8") STEEL STRAP WELDED TO COLUMN AND FASTENED TO STUD WITH 2-SDS 6.35x38 (1/4"x1 1/2") SCREWS MANUF. BY SIMPSON STRONG TIE.

### 16. CONCRETE PILASTER

BEAM POCKET OR 200x200 (8"x8") POURED CONC. NIB WALLS. MIN. BEARING 90mm (3-1/2")

### 17. 19x38 (1"x2") CONTINUOUS WOOD STRAPPING BOTH SIDES OF STEEL BEAM. (OBC. 9.23.4.3.(3c))

### 18. GARAGE SLAB

100mm (4") 32MPa (4640psi) CONC. SLAB WITH 5-8% AIR ENTRAINMENT ON OPTIONAL 100 (4") COARSE GRANULAR FILL WITH COMPACTED SUB-BASE OR COMPACTED NATIVE FILL. SLOPE TO FRONT (EXTERIOR) AT 1% MIN.

### 19. INTERIOR GARAGE WALLS & CEILINGS (REFER TO B.O.P. FORM)

13mm (1/2") GYPSUM BOARD ON WALL AND CEILING BETWEEN HOUSE AND GARAGE. WALL INSULATION = RSI. 3.87 (R22) BATTs+ RSI. 0.88 (R5) CONTINUOUS RIGID INSUL. CEILING INSUL.= RSI. 5.46 (R31). TAPE AND SEAL ALL JOINTS AIRTIGHT PER O.B.C. 9.10.9.16.

### 20. DOOR AND FRAME GASPROOFED. DOOR EQUIPPED WITH SELF CLOSING DEVICE AND WEATHERSTRIPPING PER OBC 9.10.13.15.

### 21. EXTERIOR STEP

PRECAST CONCRETE STEP OR WOOD STEP WHERE NOT EXPOSED TO WEATHER. MAX. RISE 200mm (7-7/8") MIN. TREAD 250mm (9-1/2"). SEE OBC. 9.8.9.2., 9.8.9.3. & 9.8.10.

### 22. DRYER VENT (OBC-6.2.3.8(7), 6.2.4.1.1 & 6.2.4.1.1)

CAPPED DRYER EXHAUST VENTED TO EXTERIOR. (USE 100mm (4") DIA. SMOOTH WALL VENT PIPE).

### 23. INSULATED ATTIC ACCESS (OBC-9.19.2.1)

ATTIC ACCESS HATCH WITH MIN. DIMENSION OF 545x700mm (21'-1/2"x27'-1/2") & A MIN. AREA OF 0.32 SQ.M. (3.4 SQ.FT.) WITH WEATHERSTRIPPING. RSI 3.52 (R20) RIGID INSULATION BACKING.

### 24. FIREPLACE CHIMNEYS - OBC. 9.21. -

TOP OF FIREPLACE CHIMNEY SHALL BE 915mm (3'-0") ABOVE THE HIGHEST POINT AT WHICH IT COMES IN CONTACT WITH THE ROOF AND 610mm (2'-0") ABOVE THE ROOF SURFACE WITHIN A HORIZ. DISTANCE OF 3050mm (10'-0") FROM THE CHIMNEY.

### 25. LINEN CLOSETS

4 SHELVES MIN. 350mm (14") DEEP.

### 26. MECHANICAL EXHAUST

MECHANICAL EXHAUST FAN, VENTED TO EXTERIOR AS REQUIRED BY OBC. 9.32.3.5. & 9.32.3.10.

### 27. STEEL BEARING PLATE FOR MASONRY WALLS

280x280x16 (11"x11"x5/8") STL. PLATE FOR STL BEAMS AND 280x280x12 (11"x11"x1/2") STL. PLATE FOR WOOD BEAMS BEARING ON CONC. BLOCK PARTYWALL, ANCHORED WITH 2-19mm (3/4") x 200mm (8") LONG GALV. ANCHORS WITHIN SOLID BLOCK COURSE. LEVEL WITH NON-SHRINK GROUT.

### 27A. SOLID WOOD BEARING FOR WOOD STUD WALLS

SOLID BEARING TO BE AT LEAST AS WIDE AS THE SUPPORTED MEMBER. SOLID WOOD BEARING COMPRISED OF BUILT-UP WOOD STUDS TO BE CONSTRUCTED IN ACCORDANCE WITH OBC 9.17.4.2(2).

### 28. CLASS 'B' VENT

U.L.C. RATED CLASS "B" VENT 610mm (2'-0") ABOVE THE POINT IN CONTACT WITH THE ROOF FOR SLOPES UP TO 9/12, REFER TO THE ONTARIO GAS UTILIZATION CODE.

### 29. BASEMENT WOOD POST (OBC 9.17.4.)

3-38x140 (3-2"x6") BUILT-UP-POST ON METAL BASE SHOE ANCHORED TO CONC. WITH 12.7 DIA. BOLT, 406x406x203 (16"x16"x8") CONC. FTG. OR AS OTHERWISE SPECIFIED ON DRAWING.

### 30. STEPPED FOOTINGS (OBC 9.15.3.9.)

MIN. HORIZ. STEP = 600mm (24"). MAX. VERT. STEP = 600mm (24").

### 31. SLAB ON GRADE

MIN. 100mm (4") CONCRETE SLAB ON GRADE ON 100mm (4") COARSE GRANULAR FILL. REINFORCED WITH 6x6-W2.9xW2.9 MESH PLACED NEAR MID-DEPTH OF SLAB. CONC. STRENGTH 32 MPa (4640 psi) WITH 5-8% AIR ENTRAINMENT ON COMPACTED SUB-GRADE. UNDER SLAB INSULATION AS PER B.O.P. FORM where required. ALL JOINTS & PENETRATIONS OF INTERIOR SLABS TO BE SEALED TO MAINTAIN AIR BARRIER.

### 32. DIRECT VENTING GAS FURNACE VENT

DIRECT VENT FURNACE TERMINAL MIN. 900mm (36") FROM A GAS REGULATOR. MIN. 300mm (12") ABOVE FIN. GRADE, FROM ALL OPENINGS, EXHAUST AND INTAKE VENTS. HRV INTAKE TO BE A MIN. OF 1830mm (6'-0") FROM ALL EXHAUST TERMINALS. REFER TO GAS UTILIZATION CODE.

### 33. DIRECT VENTING GAS FIREPLACE VENT

DIRECT VENT GAS FIREPLACE, VENT TO BE A MINIMUM 300mm (12") FROM ANY OPENING AND ABOVE FIN. GRADE. REFER TO GAS UTILIZATION CODE.

### 34. JOIST STRAPPING AND BRIDGING (SEE OBC. 9.23.9.4)

ALL CONVENTIONAL FRAMED FLOOR JOISTS WITH SPANS OVER 2100mm (6'-11") TO BE BRIDGED WITH 38x38 (2"x2") CROSS BRACING OR SOLID BLOCKING @ 2100mm (6'-11") O.C. MAX. AND WHERE SPECIFIED BY JOIST TABLES A-1 OR A-2 STRAPPING SHALL BE 19x64 (1"x3") @ 2100mm (6'-11") O.C. UNLESS A PANEL TYPE CEILING FINISH IS APPLIED. (\* SEE OBC 9.23.9.4. \*) REFER TO FLOOR LAYOUTS FOR ENGINEERED FLOOR JOISTS.

### 35. EXPOSED BUILDING FACE - OBC. 9.10.15.

EXTERIOR WALLS TO HAVE A FIRE RESISTANCE RATING OF NOT LESS THAN 45 min. WHERE LIMITING DISTANCE (LD) IS LESS THAN 1.2M (3'-11"). WHERE THE LD IS LESS THAN 600mm (1'-11") THE EXPOSING FACE SHALL BE CLAD IN NON-COMBUSTIBLE MATERIAL. SEE ELEVATIONS FOR ADDITIONAL NOTES.

### 36. COLD CELLAR PORCH SLAB (OBC 9.39.)

FOR MAX. 2500 mm (8'-2") PORCH DEPTH (SHORTEST DIM.), 125mm (4 7/8") 32MPa (4640psi) CONC. SLAB WITH 5-8% AIR ENTRAINMENT. REINF. WITH 10M BARS @ 200mm (7 7/8") O.C. EACH WAY IN BOTTOM THIRD OF SLAB, 600x600 (23 5/8"x 23 5/8") 10M DOWELS @ 600mm (23 5/8") O.C., ANCHORED IN PERIMETER FTG. WALLS. SLOPE SLAB MIN. 1.0% FROM DOOR. SLAB TO HAVE MIN 75mm (3") BEARING ON FDTN. WALLS. PROVIDE (WL1) UNLETS OVER CELLAR DOOR AND WITH 100mm (4") END BEARING.

### 37. FOUNDATION LEDGE FOR BRICK/MASONRY

THE FDTN. WALL SHALL NOT BE REDUCED TO LESS THAN 90mm (3-1/2") THICK TO A MAX. DEPTH OF 660mm (26") AND SHALL BE TIED TO THE FACING WALL WITH METAL TIES SPACED 200mm (8") O.C. VERTICALLY AND 900mm (36") O.C. HORIZONTALLY. FILL SPACE BETWEEN WALL AND FACING SOLID WITH MORTAR.

### 38. CONVENTIONAL ROOF FRAMING (2.0Kpa. SNOW LOAD)

38x140 (2"x6") RAFTERS @ 406mm (16") O.C. FOR MAX 11'-7" SPAN, 38x184 (2"x8") RIDGE BOARD, 38x89 (2"x4") COLLAR TIES AT MIDSPANS. CEILING JOISTS TO BE 38x89 (2"x4") @ 406mm (16") O.C. FOR MAX. 2830mm (9'-3") SPAN & 38x140 (2"x6") @ 406 (16") O.C. FOR MAX. 4450mm (14'-7") SPAN. RAFTERS FOR BUILT-UP ROOF TO BE 38x89 (2"x4") @ 610mm (24") O.C. WITH A 38x89 (2"x4") CENTRE POST TO THE TRUSS BELOW, LATERALLY BRACED @ 1800mm (6'-0") O.C. VERTICALLY.

### 39. TWO STOREY VOLUME SPACES

-FOR A MAXIMUM 5490 mm (18'-0") HEIGHT AND MAXIMUM SUPPORTED ROOF TRUSS LENGTH OF 6.0m, PROVIDE 2-38x140 (2-2"x6") SPR #2 CONTIN. STUDS @ 305mm (12") O.C. (TRIPLE UP AT EVERY THIRD DOUBLE STUD FOR BRICK WALLS) C/W 9.6 (3/8") THICK EXT. PLYWOOD SHEATHING. PROVIDE SOLID WOOD BLOCKING BETWEEN WOOD STUDS @ 1220 mm (4'-0") O.C. VERTICALLY. -FOR WALLS WITH HORIZ. DISTANCES NOT EXCEEDING 2900 mm (9'-6"), PROVIDE 38x140 (2"x6") STUDS @ 406 (16") O.C. WITH CONTINUOUS 2-38x140 (2-2"x6") TOP PLATES + 1-38x140 (1-2"x6") BOTTOM PLATE & MINIMUM OF 3-38x184 (3-2"x8") CONT. HEADER AT GRND. CEILING LEVEL TOE-NAILED & GLUED AT TOP, BOTTOM PLATES AND HEADERS.

### 40. EXPOSED FLOOR TO EXTERIOR (REFER TO B.O.P. FORM)

PROVIDE RSI 5.46 (R31) INSULATION, APPROVED VAPOUR BARRIER AND CONTINUOUS AIR BARRIER, FINISHED SOFFIT.

### 41. PARTYWALLS

TYPICAL 1 HOUR RATED PARTYWALL. REFER TO DETAILS FOR TYPE AND SPECIFICATIONS.

### 42. EXTERIOR WALLS FOR WALK-OUT CONDITIONS

THE EXTERIOR BASEMENT STUD WALL TO BE 38x140 (2"x6") STUDS @ 406mm (16") O.C. OR 38x89 (2"x4") STUDS @ 305mm (12") O.C. WALL INSULATION TO BE SAME AS STANDARD ABOVE GRADE WOOD STUD WALLS (R20+R5).

### LOOSE STEEL UNLETS

L1 = 3-1/2" x 3-1/2" x 1/4" (90x90x6.0L)  
L2 = 4" x 3-1/2" x 5/16" (100x90x8.0L)  
L3 = 5" x 3-1/2" x 5/16" (125x90x8.0L)  
L4 = 6" x 3-1/2" x 3/8" (150x90x10.0L)  
L5 = 6" x 4" x 3/8" (150x100x10.0L)  
L6 = 7" x 4" x 3/8" (180x100x10.0L)

### LAMINATED VENEER LUMBER (LV) BEAMS


LV1A = 1-1 3/4"x7 1/4" (1-45x184)  
LV1 = 2-1 3/4"x7 1/4" (2-45x184)  
LV2 = 3-1 3/4"x7 1/4" (3-45x184)  
LV3 = 4-1 3/4"x7 1/4" (4-45x184)  
LV4A = 1-1 3/4"x9 1/4" (1-45x235)  
LV4 = 2-1 3/4"x9 1/4" (2-45x235)  
LV5 = 3-1 3/4"x9 1/4" (3-45x235)  
LV5A = 4-1 3/4"x9 1/4" (4-45x235)  
LV6A = 1-1 3/4"x11 7/8" (1-45x300)  
LV6 = 2-1 3/4"x11 7/8" (2-45x300)  
LV7 = 3-1 3/4"x11 7/8" (3-45x300)  
LV7A = 4-1 3/4"x11 7/8" (4-45x300)  
LV8 = 2-1 3/4"x14" (2-45x356)  
LV9 = 3-1 3/4"x14" (3-45x356)

### BRICK VENEER UNLETS


WL1 = 3-1/2" x 3-1/2" x 1/4" (89x89x6.4L)  
WL2 = 4" x 3-1/2" x 5/16" (102x89x7.9L)  
WL3 = 5" x 3-1/2" x 5/16" (127x89x7.9L)  
WL4 = 6" x 3-1/2" x 7/16" (152x89x11.0L)  
WL5 = 6" x 4" x 7/16" (152x102x11.0L)  
WL6 = 5" x 3-1/2" x 5/16" (127x89x7.9L)  
WL7 = 5" x 3-1/2" x 5/16" (127x89x7.9L)  
WL8 = 5" x 3-1/2" x 5/16" (127x89x7.9L)  
WL9 = 6" x 4" x 7/16" (152x102x11.0L)

### PAD FOOTINGS





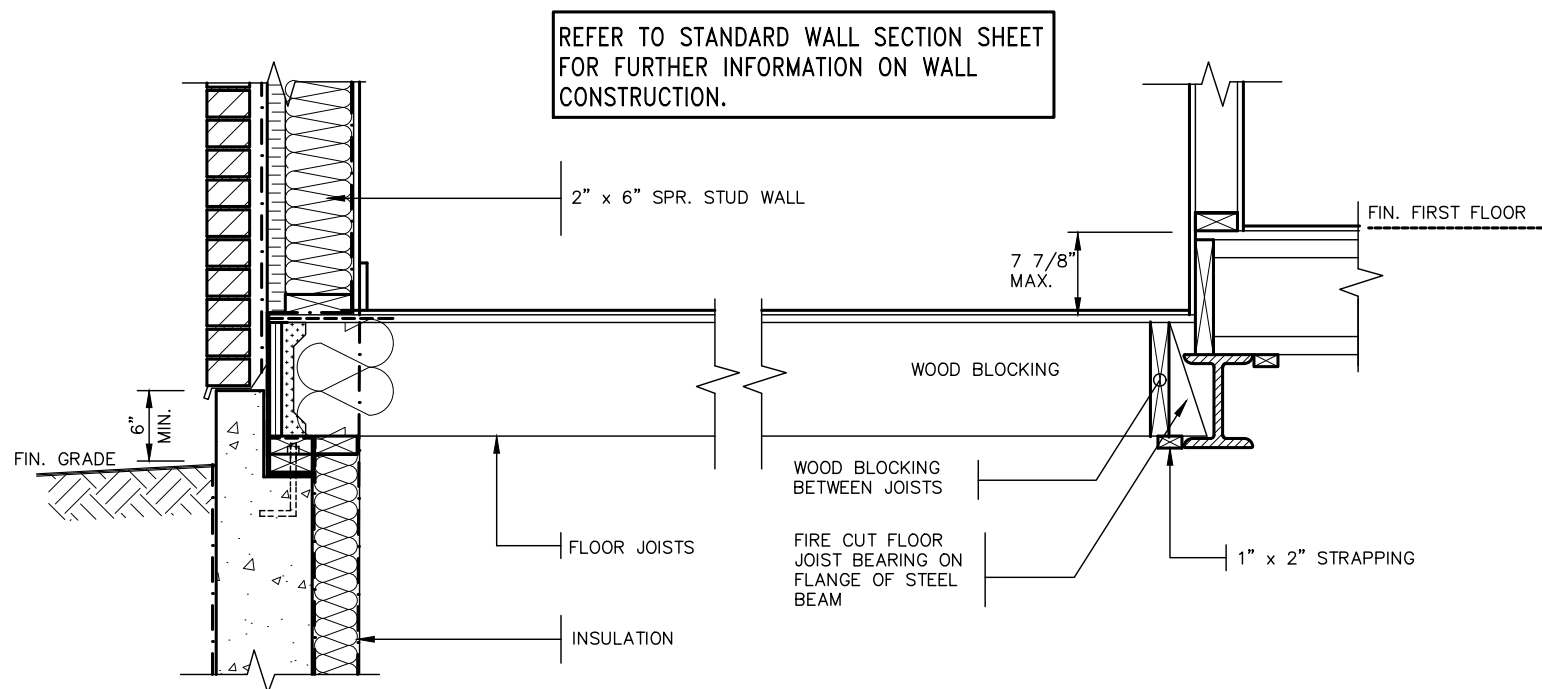

DETAIL OF SUNKEN LAUNDRY/ENTRY  
(ONE RISER)

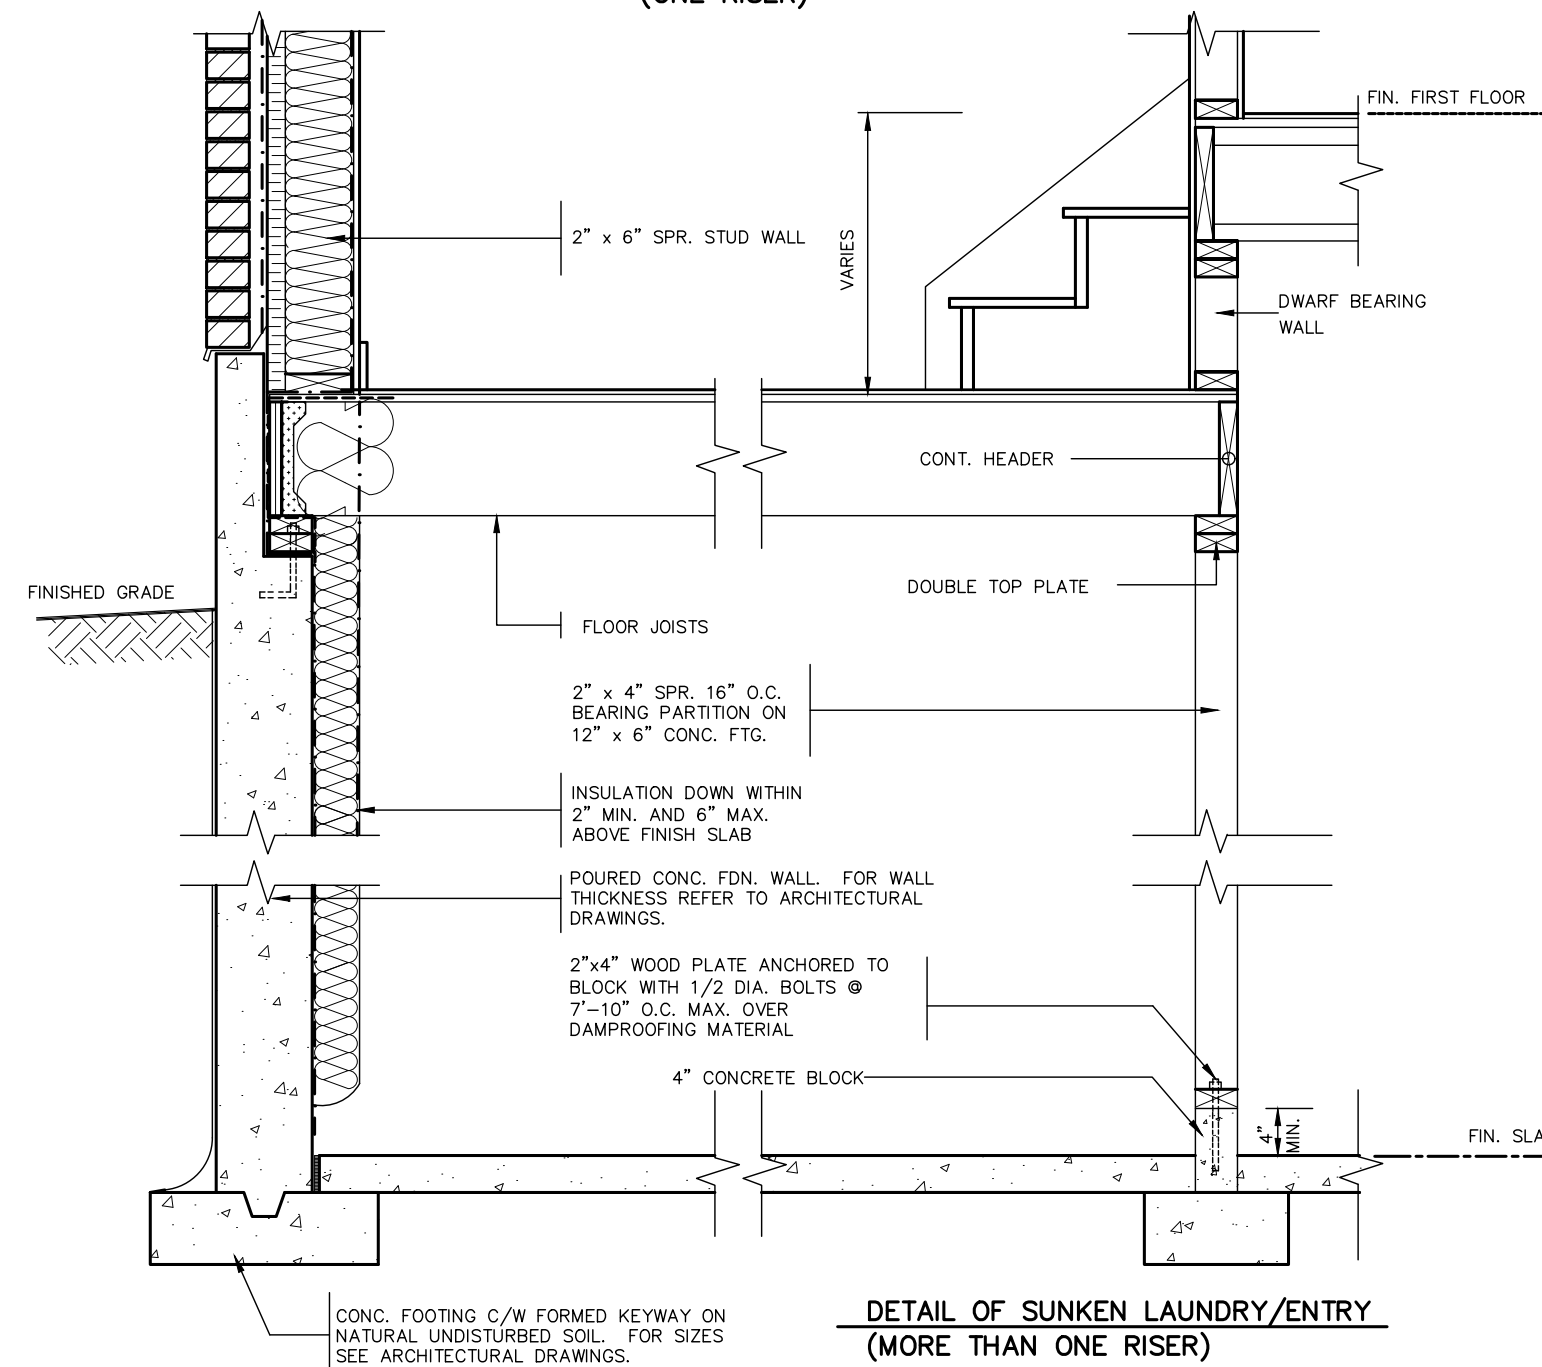

DETAIL OF SUNKEN LAUNDRY/ENTRY  
(MORE THAN ONE RISER)

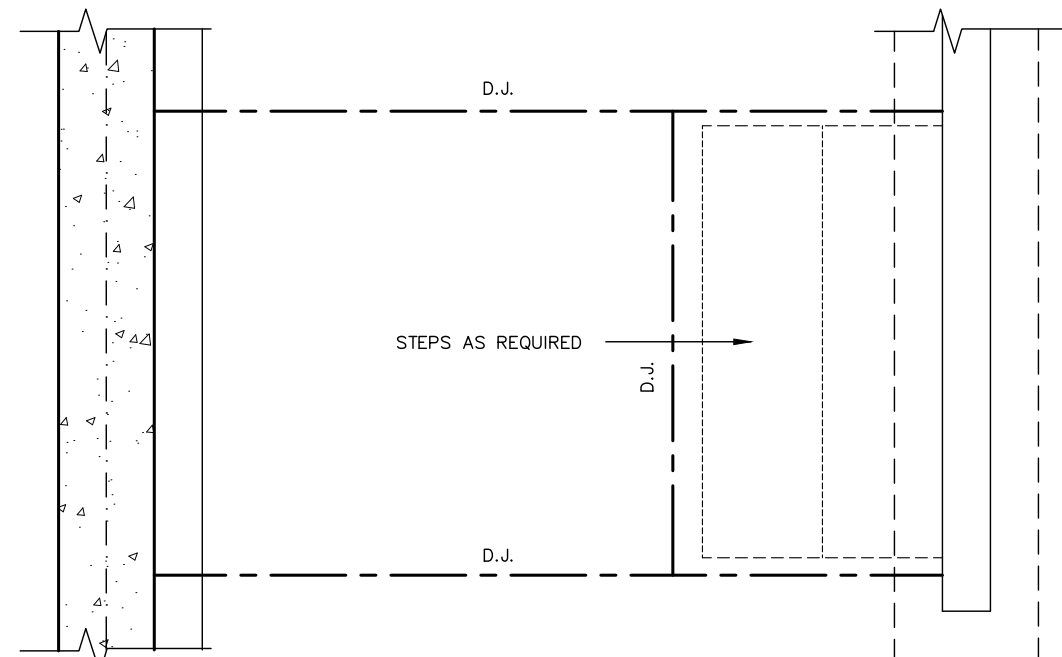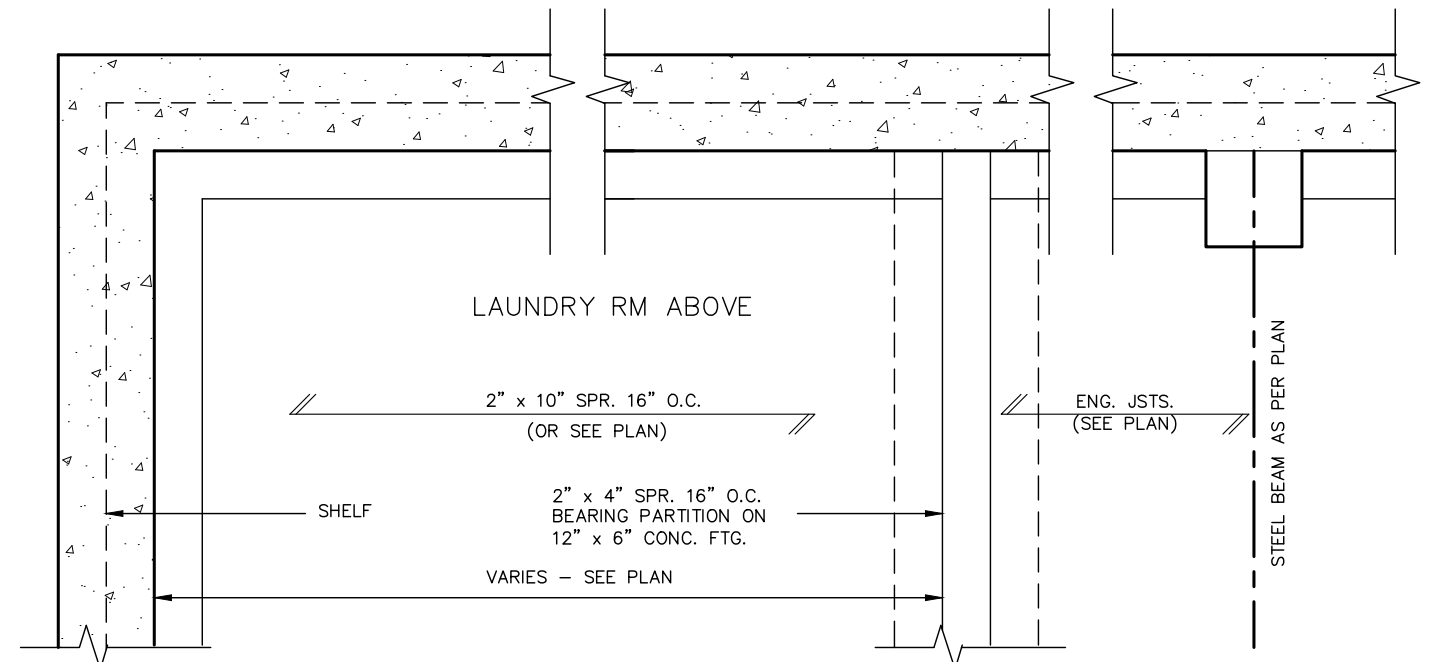

PARTIAL FOUNDATION PLAN



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Discipline	Reviewer	BCIN	Date
Building Code	H. Authier	43236	2021-02-03
Sewage System			
Zoning			



STRUDET INC.  
FOR STRUCTURE ONLY

2012 CODE  
ENERGY STAR

9	.	.	.
8	.	.	.
7	.	.	.
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5	.	.	.
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3	.	.	.
2	INSUL VALUES ADJUSTED PER ESTAR V17	JAN 31/19	GW
1	ISSUED FOR PERMIT.	JAN. 26/18	GW
no.	description	date	by

The undersigned has reviewed and takes responsibility for this design and has the qualifications and meets the requirements set out in the Ontario Building Code to be a Designer.

qualification information

Richard Vink 24488

signature

BCIN
name	VA3 Design Inc.	42658
registration information		
VA3 Design Inc.		
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va3design.com



project name  
TRINAR HALL HOMES INC. EAST GWILLIMBURY

date  
OCT. 2017

drawn by  
GW

checked by  
-


scale  
Not to Scale

file name  
17026-GP-STD\_DETAILS\_ES17

date  
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drawing no.

2

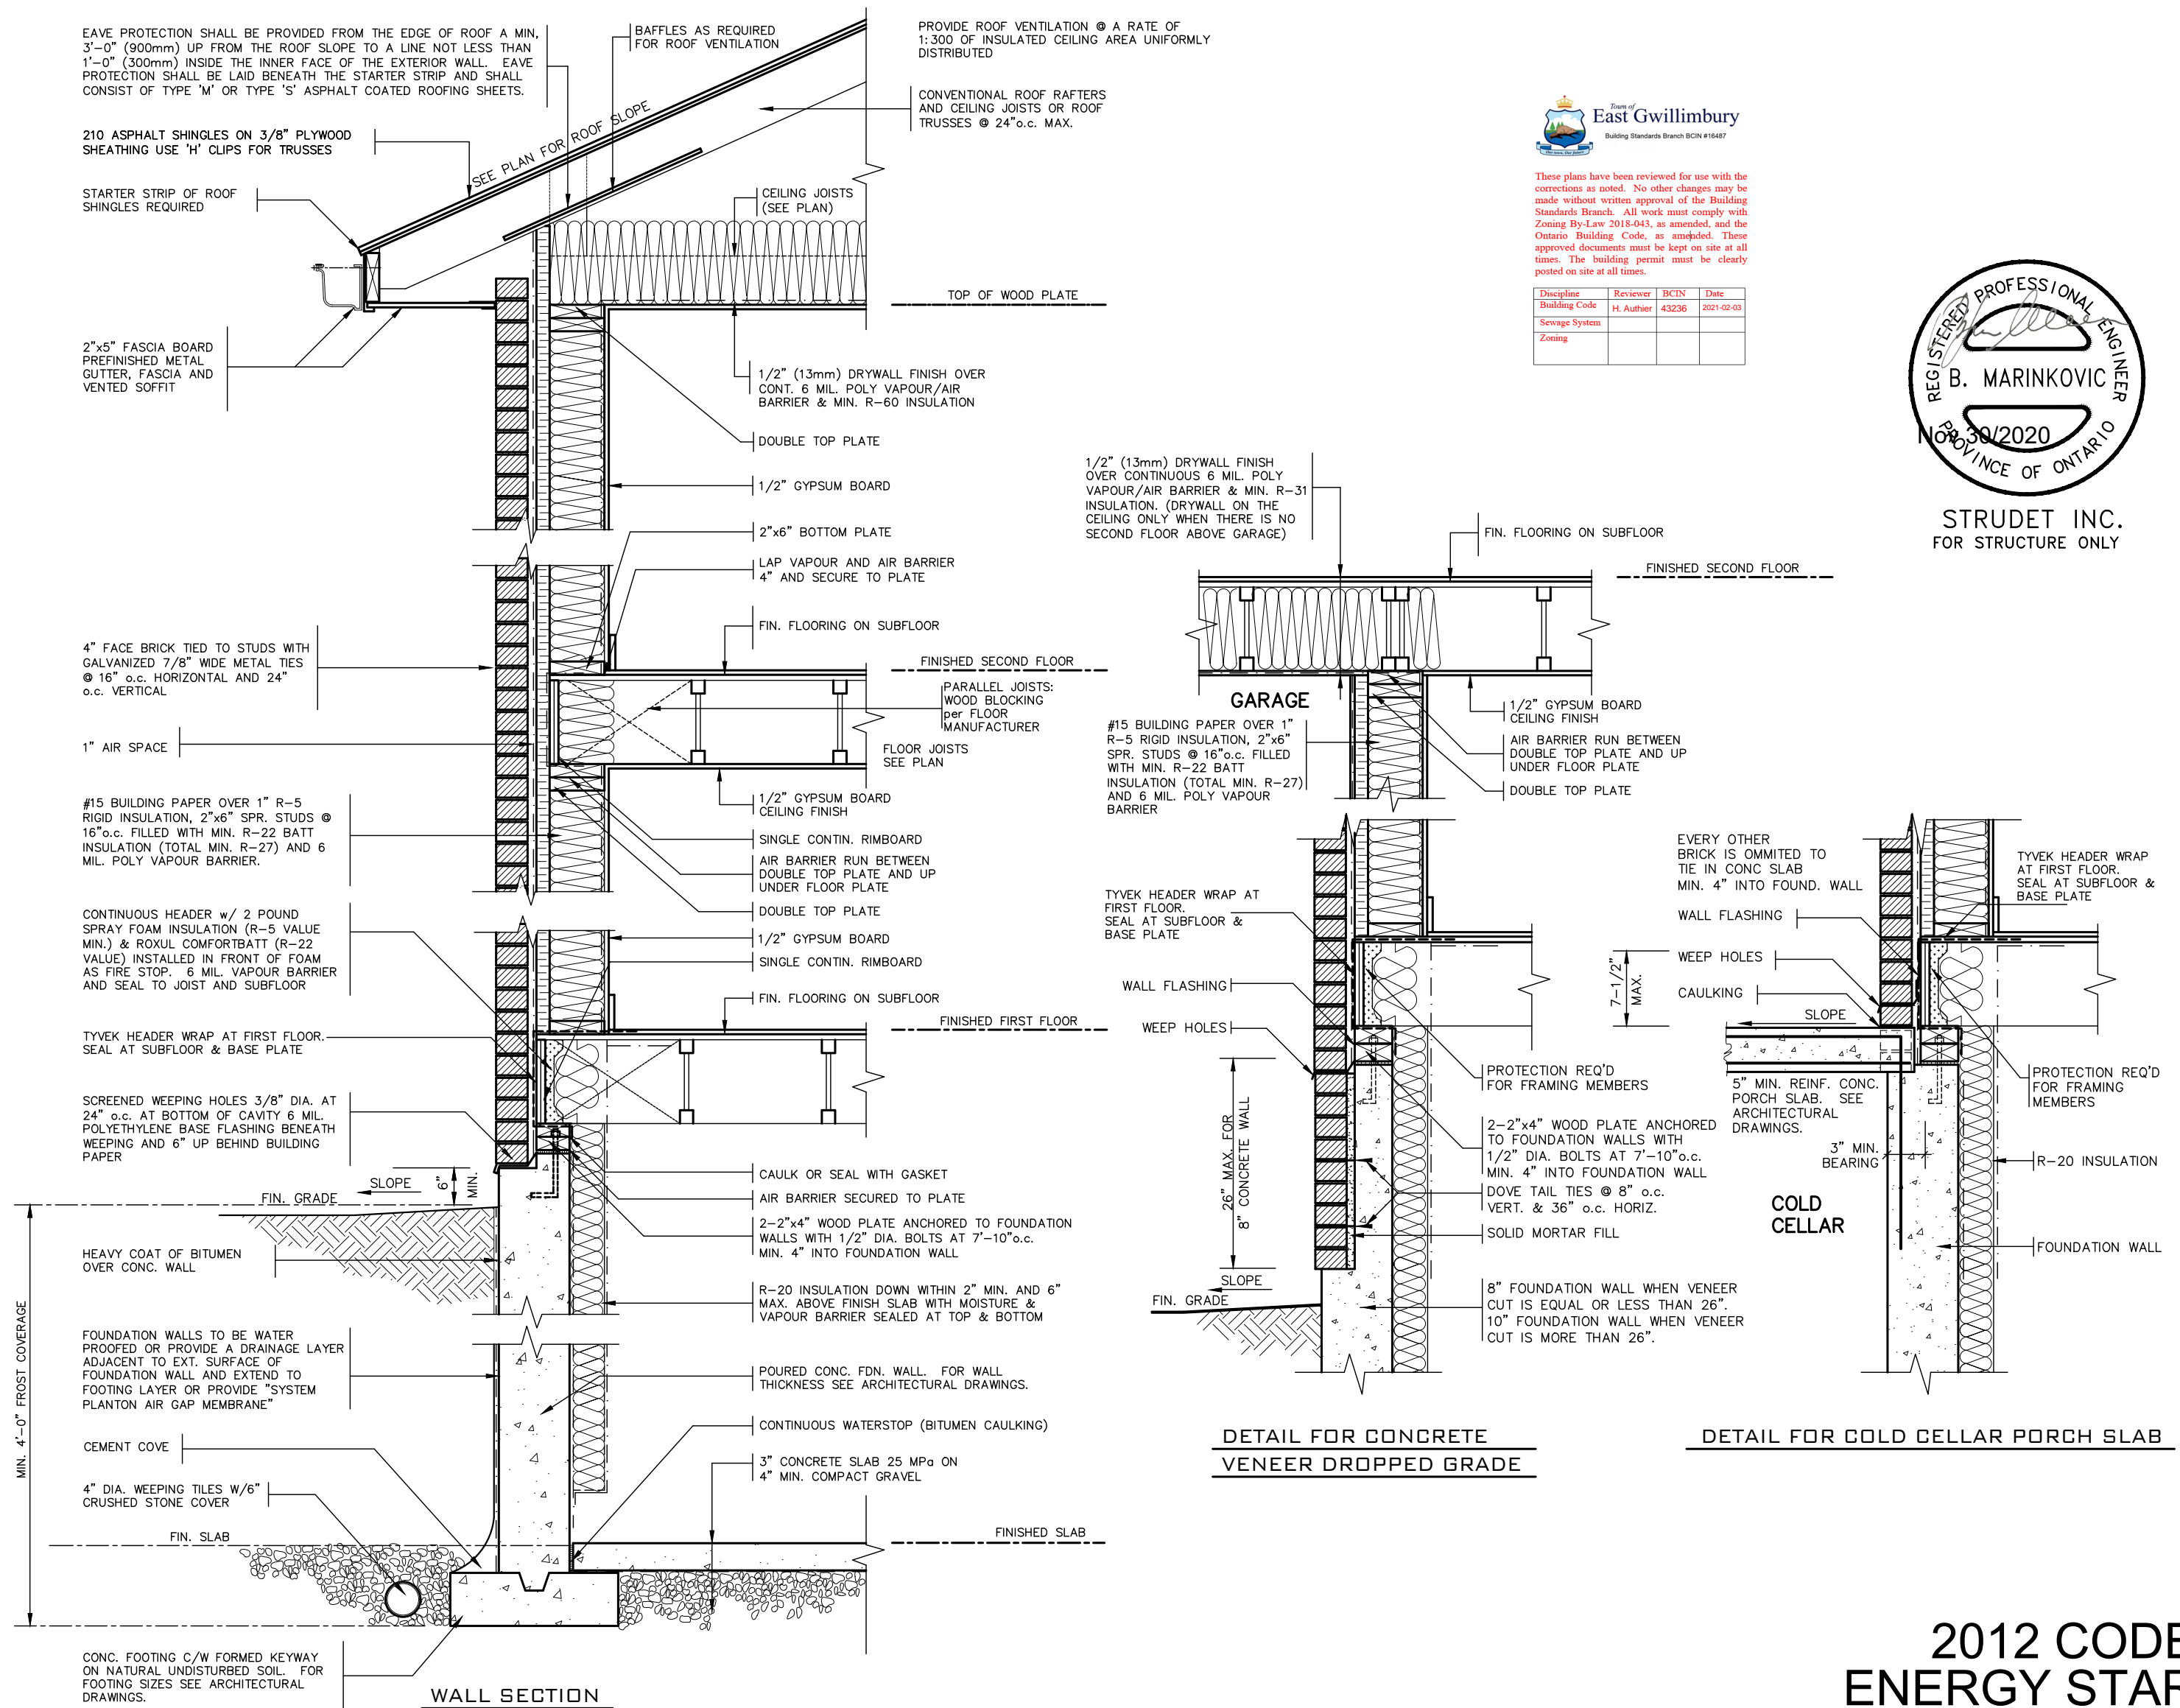

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qualification information  
**Richard Vink** 24488  
signature  
name  
registration information  
**VA3 Design Inc.** 42658

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project name <b>TRINAR HALL HOMES INC.</b>	municipality <b>EAST GWILLIMBURY</b>	project no. <b>17026</b>
date <b>OCT. 2017</b>	checked by <b>Not to Scale</b>	scale <b>2"x6" BRICK VENEER SECTIONS</b>
drawn by <b>GW</b>	file name <b>17026-GP-STD_DETAILS_ES17</b>	drawing no. <b>3</b>
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Sewage System			
Zoning			

EAVE PROTECTION SHALL BE PROVIDED FROM THE EDGE OF ROOF A MIN. 3'-0" (900mm) UP FROM THE ROOF SLOPE TO A LINE NOT LESS THAN 1'-0" (300mm) INSIDE THE INNER FACE OF THE EXTERIOR WALL. EAVE PROTECTION SHALL BE LAID BENEATH THE STARTER STRIP AND SHALL CONSIST OF TYPE 'M' OR TYPE 'S' ASPHALT COATED ROOFING SHEETS.

BAFFLES AS REQUIRED FOR ROOF VENTILATION

PROVIDE ROOF VENTILATION @ A RATE OF 1:300 OF INSULATED CEILING AREA UNIFORMLY DISTRIBUTED

210 ASPHALT SHINGLES ON 3/8" PLYWOOD SHEATHING USE 'H' CLIPS FOR TRUSSES

STARTER STRIP OF ROOF SHINGLES REQUIRED

SEE PLAN FOR ROOF SLOPE

ROOF TRUSSES @ 24" o.c. MAX. RAISED HEEL TO MATCH PLATE

TOP OF WOOD PLATE

2"x5" FASCIA BOARD  
PREFINISHED METAL  
GUTTER, FASCIA AND  
VENTED SOFFIT

1 1/2"x6" RAISED STUCCO FRIEZE BOARD (TYP.)

MESH BACKWRAPPED

1/2" (13mm) DRYWALL FINISH OVER  
CONT. 6 MIL. POLY VAPOUR/AIR  
BARRIER & MIN. R-60 INSULATION

DOUBLE TOP PLATE

1/2" GYPSUM BOARD

2"x6" BOTTOM PLATE

LAP VAPOUR AND AIR BARRIER  
4" AND SECURE TO PLATE

FIN. FLOORING ON SUBFLOOR

FINISHED SECOND FLOOR

PARALLEL JOISTS:  
WOOD BLOCKING  
per FLOOR  
MANUFACTURER

FLOOR JOISTS  
SEE PLAN

1/2" GYPSUM BOARD  
CEILING FINISH

DOUBLE CONTIN. RIMBOARD

AIR BARRIER RUN BETWEEN  
DOUBLE TOP PLATE AND UP  
UNDER FLOOR PLATE

DOUBLE TOP PLATE

1/2" GYPSUM BOARD

DOUBLE CONTIN. RIMBOARD

FIN. FLOORING ON SUBFLOOR

FINISHED FIRST FLOOR

CONTINUOUS HEADER w/ 2 POUND  
SPRAY FOAM INSULATION (R-5 VALUE  
MIN.) & ROXUL COMFORTBATT (R-22  
VALUE) INSTALLED IN FRONT OF FOAM  
AS FIRE STOP. 6 MIL. VAPOUR BARRIER  
AND SEAL TO JOIST AND SUBFLOOR

4" FACE BRICK TIED TO STUDS WITH  
GALVANIZED 7/8" WIDE METAL TIES @ 16"  
o.c. HORIZONTAL AND 24" o.c. VERTICAL

SCREENED WEEPING HOLES 3/8" DIA. AT 24"  
o.c. AT BOTTOM OF CAVITY 6 MIL.  
POLYETHYLENE BASE FLASHING BENEATH  
WEEPING AND 6" UP BEHIND BUILDING PAPER

FIN. GRADE

HEAVY COAT OF BITUMEN  
OVER CONC. WALL

FOUNDATION WALLS TO BE WATER  
PROOFED OR PROVIDE A DRAINAGE  
LAYER ADJACENT TO EXT. SURFACE OF  
FOUNDATION WALL AND EXTEND TO  
FOOTING LAYER OR PROVIDE "SYSTEM  
PLANTON AIR GAP MEMBRANE"

CEMENT COVE

4" DIA. WEEPING TILES W/6"  
CRUSHED STONE COVER

FIN. SLAB

CONC. FOOTING C/W FORMED KEYWAY  
ON NATURAL UNDISTURBED SOIL. FOR  
FOOTING SIZES SEE ARCHITECTURAL  
DRAWINGS.

WALL SECTION



STRUDET INC.  
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WOOD SHEATHING

AIR/MOISTURE BARRIER

FIBRE MESH EMBEDDED  
IN PREP COAT

INSULATION BOARD (R-5) MIN  
W/ GEOMETRICALLY DEFINED  
DRAINAGE CAVITY HAVING A  
MIN. CAVITY DEPTH OF 1/4"

STARTER MESH (BACKWRAPPED)

CAULK WITH BEAD VENT

FLASHING

CONCRETE SILL

MASONRY CLADDING AS PER  
ELEVATION

A. TERMINATION AT MASONRY  
CLADDING WITH SEALANT 1

1 1/2" = 1'0"

EVERY OTHER  
BRICK IS OMITTED TO  
TIE IN CONC SLAB  
MIN. 4" INTO FOUND. WALL

WALL FLASHING

WEEP HOLES

CAULKING

SLOPE

5" MIN. REINF. CONC.  
PORCH SLAB. SEE  
ARCHITECTURAL  
DRAWINGS.

3" MIN.  
BEARING

COLD  
CELLAR

R-20 INSULATION  
FULL HEIGHT

FOUNDATION WALL

PROTECTION REQ'D  
FOR FRAMING MEMBERS

2"x4" WOOD PLATE ANCHORED  
TO FOUNDATION WALLS WITH  
1/2" DIA. BOLTS AT 7'-10" o.c.  
MIN. 4" INTO FOUNDATION WALL

DOVE TAIL TIES @ 8" o.c.  
VERT. & 36" o.c. HORIZ.

SOLID MORTAR FILL

8" FOUNDATION WALL WHEN VENEER  
CUT IS EQUAL OR LESS THAN 26".  
10" FOUNDATION WALL WHEN VENEER  
CUT IS MORE THAN 26".

DETAIL FOR CONCRETE  
VENEER DROPPED GRADE

3/4" = 1'0"

DETAIL FOR COLD  
CELLAR PORCH SLAB

3/4" = 1'0"

2012 CODE  
ENERGY STAR

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no.	description	date	by	

24488	BCIN	42658
signature	name	registration information
VA3 Design Inc.	VA3 Design Inc.	VA3 Design Inc.
255 Consumers Rd Suite 120	Toronto ON M2J 1R4	t 416.630.2255 f 416.630.4782
va3design.com		



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project name	TRINAR HALL HOMES INC.	municipality	EAST GWILLIMBURY	project no.	17026
date	OCT. 2017	checked by	scale	file name	drawing no.
drawn by	GW	checked by	Not to Scale	17026-GP-STD_DETAILS_ES17	3-2
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2" x 2" PICKETS CHAMFERED AT BOTTOM WITH 2" x 6" TOP CAP AND 2" x 4" TOP RAIL (REFER TO DETAIL 1)

3'-6" HIGH WOOD RAILING IF DECK FLOOR IS MORE THAN 5'-11" ABOVE GRADE AND 3'-0" HIGH WOOD RAILING IF DECK IS LESS THAN 5'-11" ABOVE GRADE

MAX. 4" OPENING BETWEEN PICKETS

5/4 x 6 PRESSURE TREATED DECKING WITH 1/4" GAP

WB1 RIM JOISTS (PRESSURE TREATED)

GUARDS FOR STAIRS SHALL NOT BE LESS THAN 2'-11" HIGH MEASURED VERTICALLY FROM A LINE DRAWN THROUGH THE OUTSIDE EDGES OF THE STAIR NOSINGS

4 7/8" MIN. 9 1/4" MIN. 14" MAX.

2" x 4" WOOD BLOCKING @ 4'-0" O.C. MIN. BETWEEN STRINGERS

2" x 12" STRINGER


PRECAST CONCRETE SLAB

(CORROSION RESISTANT) SIMPSON STRONG-TIE COLUMN BASE. 1/2" DIA. ANCHOR BOLT.

12" CONC. PIER

## WOOD DECK SECTION WITH BRICK VENEER

SCALE: 1/2" = 1'-0"

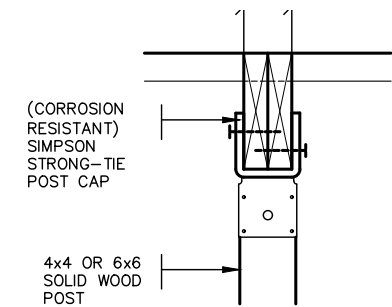

DETAIL 2 - BEAM-TO-POST  
SCALE: 1" = 1'-0"

TYPICAL BRICK VENEER WALL CONSTRUCTION

1/2" Ø BOLTS @ 24" O/C ACROSS DECK ANCHORED TO HOUSE RIM BOARD

10" FOUNDATION WALL REQUIRED WHEN VENEER CUT IS GREATER THAN 26"

2-2x8 LEDGER BOARD (LEDGER BOARD PRESSURE TREATED)

BRICK MECH. FASTENED TO 4" CONC. FOUND. WALL WITH DOVE TAIL ANCHORS AND MORTAR FILL IN BETWEEN

DETAIL 3  
STEEL ANGLE  
SCALE: 1" = 1'-0"

1/2" Ø BOLTS @ 24" O/C ACROSS DECK ANCHORED TO HOUSE RIM BOARD



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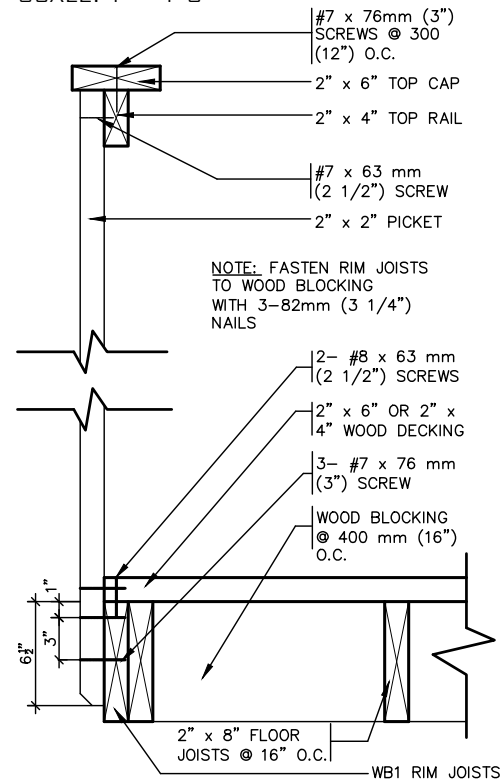
Discipline	Reviewer	BCIN	Date
Building Code	H. Authier	43236	2021-02-03
Sewage System			
Zoning			

### DETAIL 1

#### CANTILEVERED PICKET SCREWED TO RIM JOIST AND DECK



##### GUARD PARALLEL TO FLOOR JOISTS

SCALE: 1" = 1'-0"



##### GUARD PERPENDICULAR TO FLOOR JOISTS

SCALE: 1" = 1'-0"

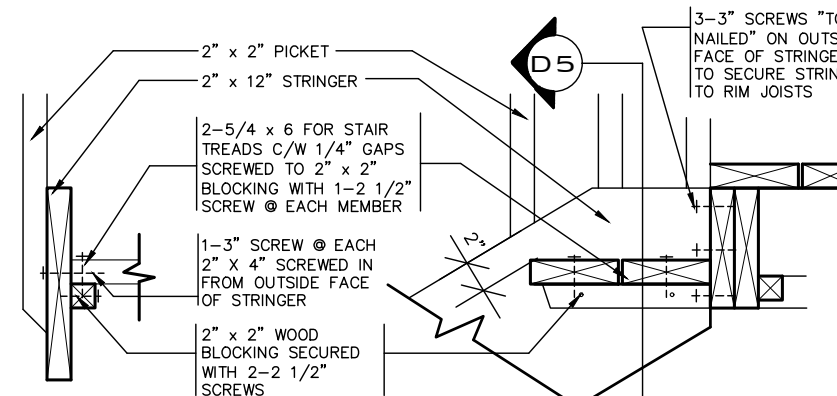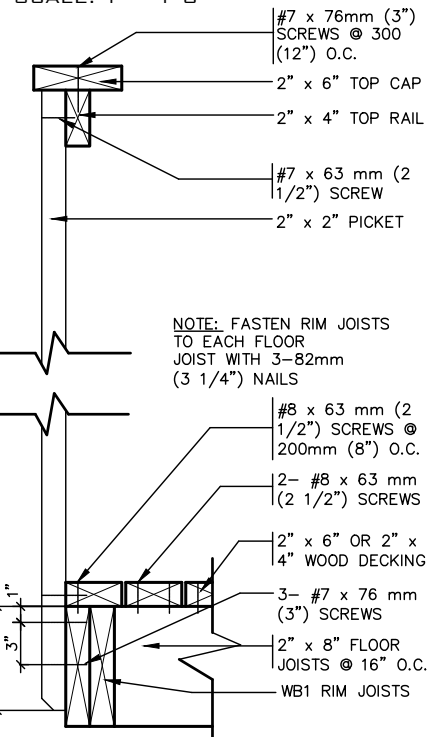

DETAIL 5  
SECTION THROUGH  
STAIR STRINGER  
SCALE: 1" = 1'-0"

DETAIL 4  
SECTION @ TREAD AND  
STRINGER SECUREMENT  
SCALE: 1" = 1'-0"

### GENERAL NOTES

- BRICK TO BE COMPRESSIVE STRENGTH OF 15 mPA (2200 p.s.i.) MIN. UNITS TO BE LAID WITH FULL HEAD AND BED JOINTS.
- MORTAR TO BE TYPE S WITH JOINT THICKNESS OF 10mm (3/8") MIN. AND 20mm (3/4") MAX.
- ALL NAILS AND SCREWS TO BE GALVANIZED.
- WB1 = 2- 2 x 8 (PRESSURE TREATED)  
WB3 = 2- 2 x 10 (PRESSURE TREATED)
- WOOD FOR CANTILEVERED PICKETS SHALL BE DOUGLAS FIR-LARCH, SPRUCE-PINE-FIR, OR HEM-FIR SPECIES.



STRUDET INC.  
FOR STRUCTURE ONLY

2012 CODE  
ENERGY STAR

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no.	description	date	by	

**VA3**  
DESIGN

255 Consumers Rd Suite 120  
Toronto ON M2J 1R4  
t 416.630.2255 f 416.630.4782  
va3design.com

**Greenpark**

project name  
TRINAR HALL HOMES INC. EAST GWILLIMBURY

project no.  
17026

date  
OCT. 2017

WOOD DECK DETAILS


drawn by  
GW

checked by  
As Shown


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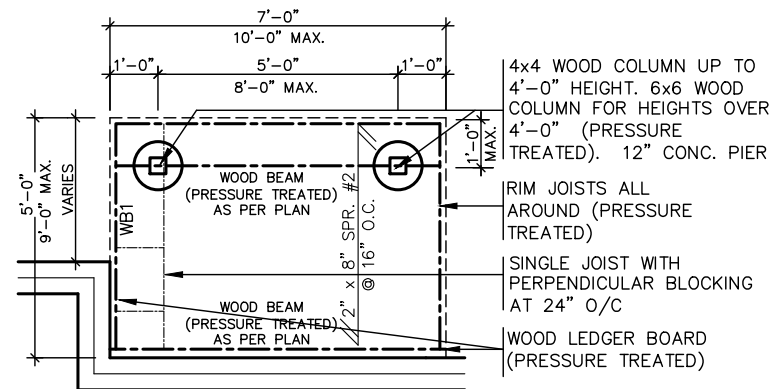
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5




**TYPICAL DECK LAYOUT**  
SCALE: 1/4" = 1'-0"

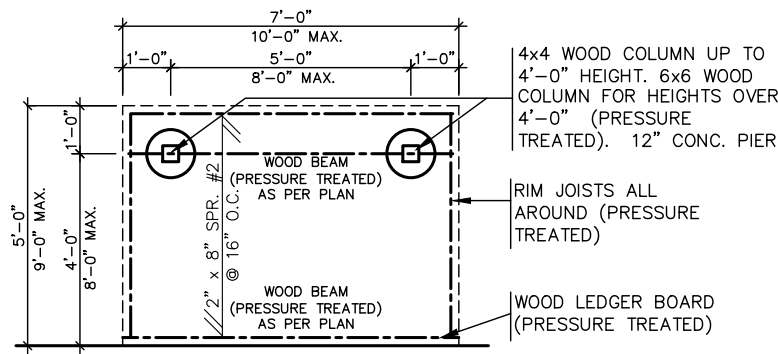

**TYPICAL DECK LAYOUT**  
SCALE: 1/4" = 1'-0"

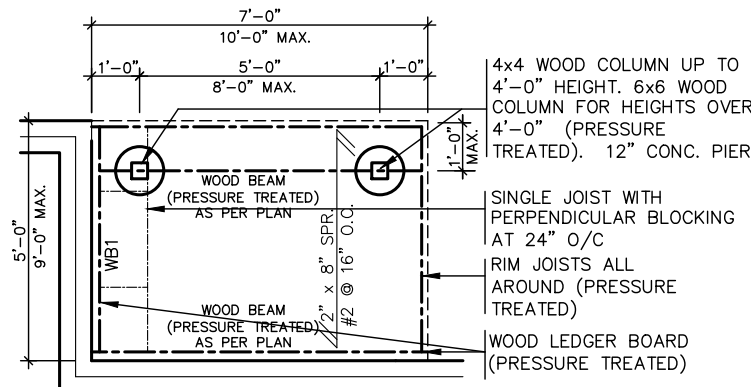

**TYPICAL DECK LAYOUT**  
SCALE: 1/4" = 1'-0"

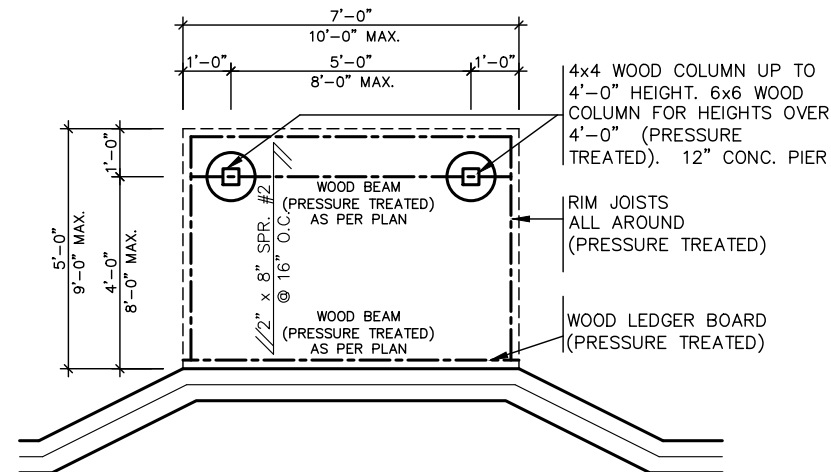

**TYPICAL DECK LAYOUT**  
SCALE: 1/4" = 1'-0"



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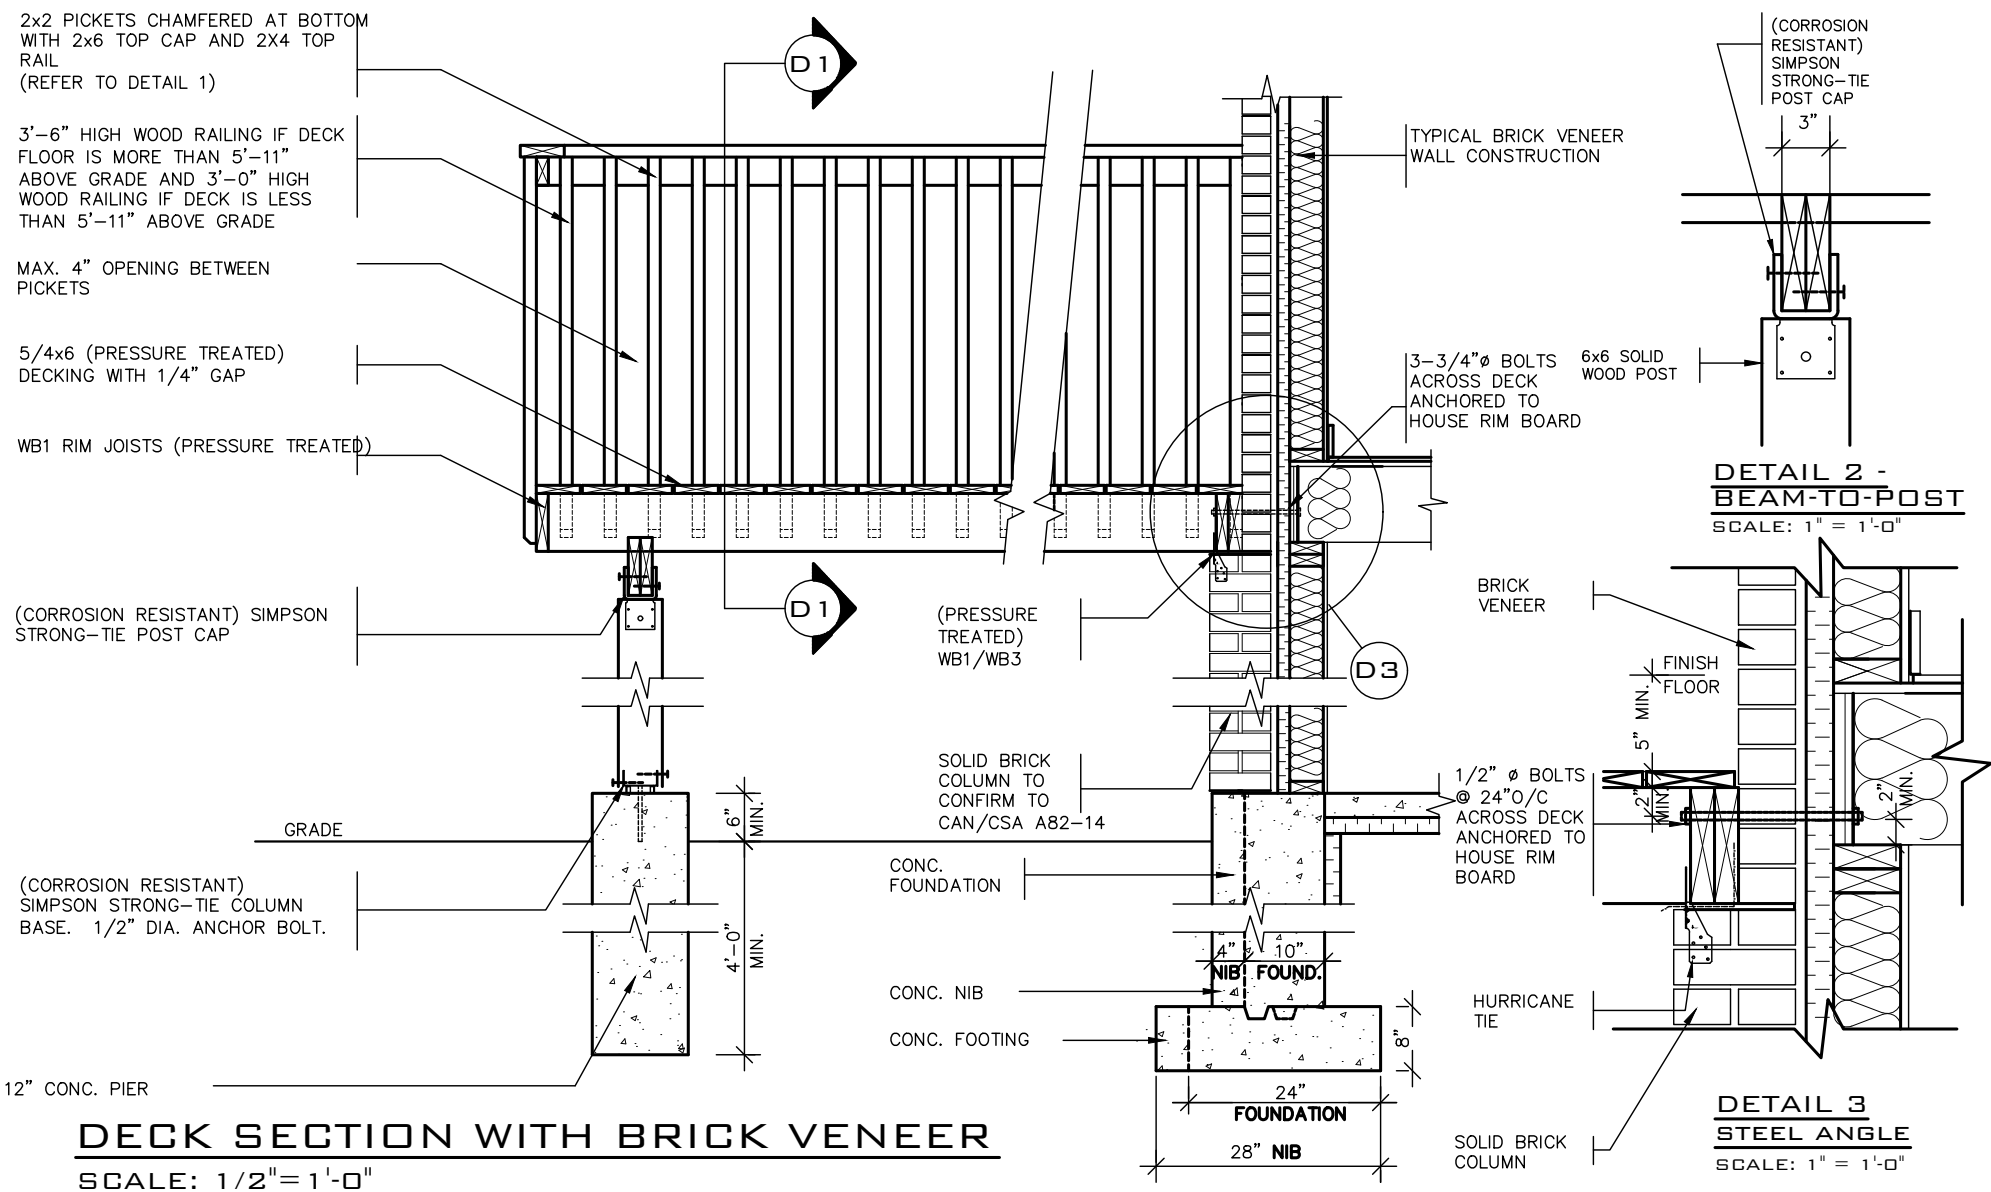
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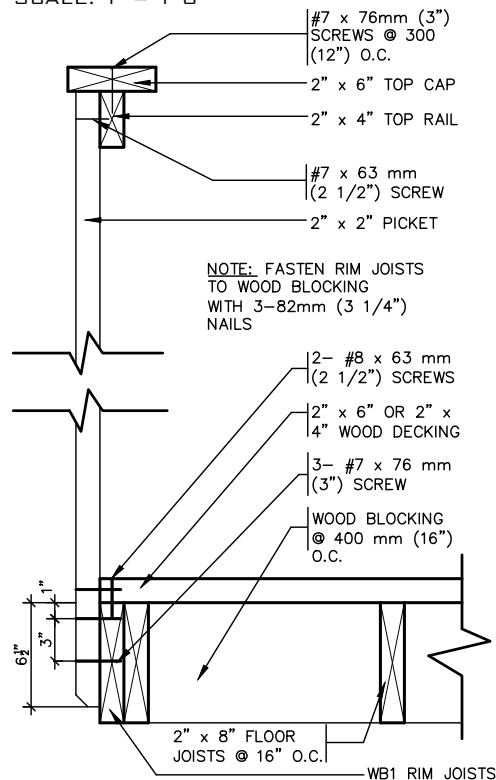
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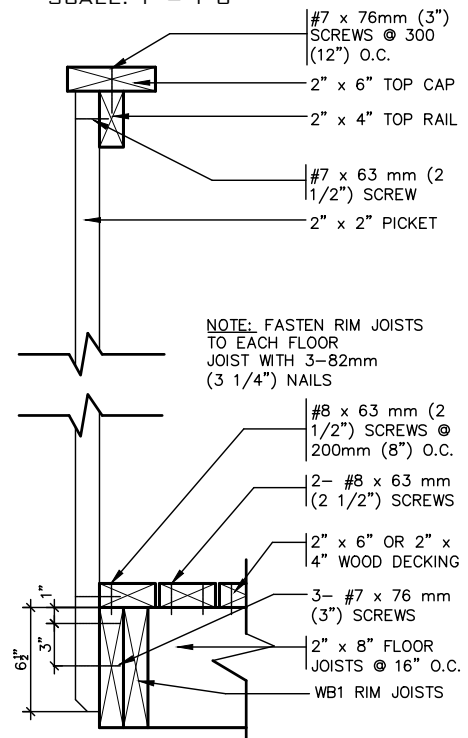
project name	TRINAR HALL HOMES INC.	municipality	EAST GWILLIMBURY	project no.	17026
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drawn by	GW	file name	17026-GP-STD_DETAILS_ES17	drawing no.	5-2
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**DETAIL 1**  
**CANTILEVERED PICKET SCREWED TO RIM JOIST AND DECK**  
**GUARD PARALLEL TO FLOOR JOISTS**  
SCALE: 1" = 1'-0"



**GUARD PERPENDICULAR TO FLOOR JOISTS**  
SCALE: 1" = 1'-0"



### GENERAL NOTES

- BRICK TO BE COMPRESSIVE STRENGTH OF 15 mPA (2200 p.s.i.) MIN. UNITS TO BE LAID WITH FULL HEAD AND BED JOINTS.
- MORTAR TO BE TYPE S WITH JOINT THICKNESS OF 10mm (3/8") MIN. AND 20mm (3/4") MAX.
- ALL NAILS AND SCREWS TO BE GALVANIZED.
- WB1 = 2- 2 x 8 (PRESSURE TREATED)  
WB3 = 2- 2 x 10 (PRESSURE TREATED)
- WOOD FOR CANTILEVERED PICKETS SHALL BE DOUGLAS FIR-LARCH, SPRUCE-PINE-FIR, OR HEM-FIR SPECIES.



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no.	description	date	by	

**VA3**  
**DESIGN**

255 Consumers Rd Suite 120  
Toronto ON M2J 1R4  
t 416.630.2255 f 416.630.4782  
va3design.com

**Greenpark**

project name  
**TRINAR HALL HOMES. INC.**

municipality  
**EAST GWILLIMBURY**

project no.  
**17026**

date  
**OCT. 2017**

**WOOD DECK -WALK-OUT CONDITION**

drawn by  
**GW**

checked by  
**-**





scale  
**As Shown**

file name  
**17026-GP-STD\_DETAILS\_ES17**

drawing no.  
**5-3**

FILED  
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


STRUDET INC.  
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Discipline	Reviewer	BCIN	Date
Building Code	H. Authier	43236	2021-02-03
Sewage System			
Zoning			

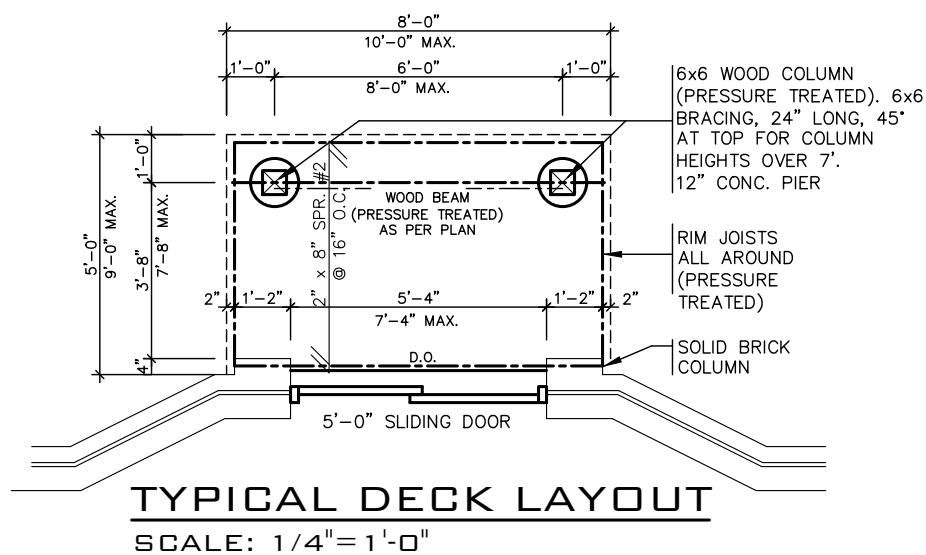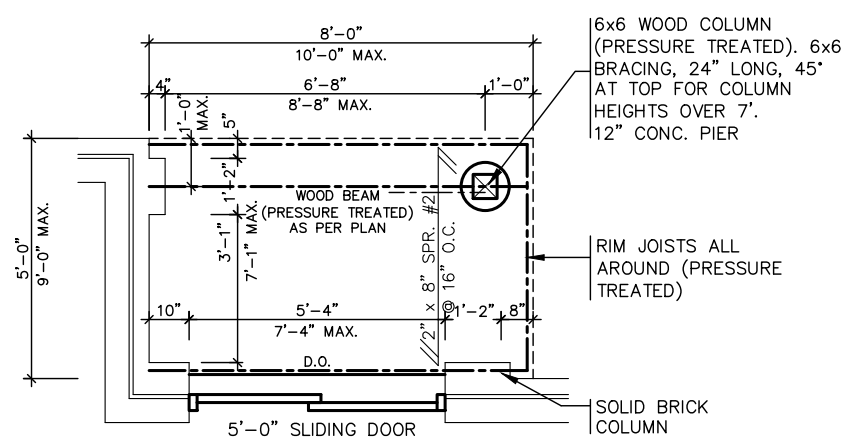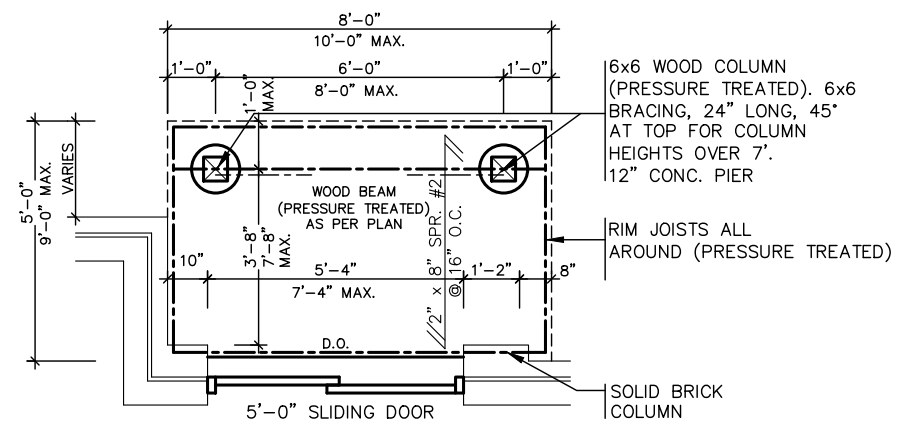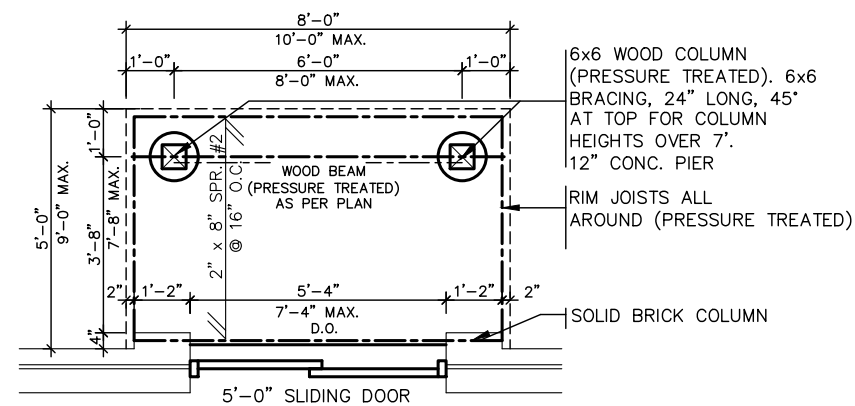9	.	.	.	The undersigned has reviewed and takes responsibility for this design and has the qualifications and meets the requirements set out in the Ontario Building Code to be a Designer.
8	.	.	.	
7	.	.	.	qualification information
6	.	.	.	<b>Richard Vink</b> 24488
5	.	.	.	name  signature BCI
4	.	.	.	registration information
3	.	.	.	<b>VA3 Design Inc.</b> 42658
2	INSUL. VALUES ADJUSTED PER ESTAR V17	JAN 31/19	GW	Contractor must verify all dimensions on the job and report any discrepancy to the Designer before proceeding with the work. All drawings and specifications are instruments of service and the property of the Designer which must be returned at the completion of the work. Drawings are not to be scaled.
1	ISSUED FOR PERMIT.	NOV. 10/17	GW	
no.	description	date	by	

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<p>         qualification information  <b>Richard Vink</b>          name          registration information  <b>VA3 Design Inc.</b> </p>	<p>           signature       </p>	<p>         2448          BCIN          4265       </p>
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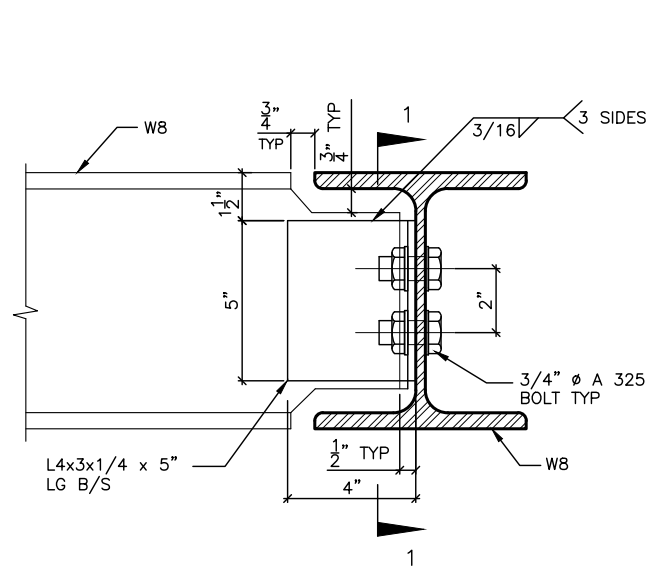
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255 Consumers Rd Suite 120  
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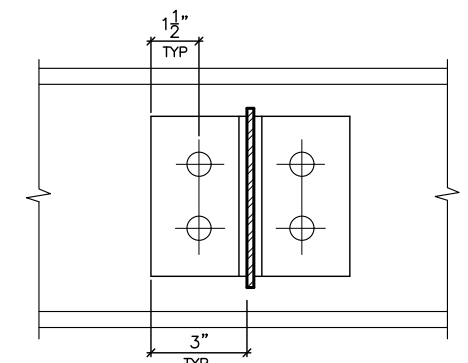


project name	municipality	project no.
TRINAR HALL HOMES INC.	EAST GWILLIMBURY	17026
<div> <div>date</div> <div> <div>OCT. 2017</div> <div>WOOD DECK DETAILS-WALK-OUT CONDITION</div> </div> </div> <div> <div> <div>drawing no.</div> <div>5-4</div> </div> <div> <div>drawing name</div> <div>17026-GP-STD_DETAILS_ES17</div> </div> </div>		
drawn by	checked by	scale
—	As Shown	
<div> <div>file name</div> <div>17026-GP-STD_DETAILS_ES17</div> </div> <div> <div>gpg - h:\ARCHIVE\WORKING\17026\17026.GRE\DETAILS\17026-GP-STD_DETAILS_ES17.dwg - Thu - Feb 14 2019 - 4:52 PM</div> </div>		




DETAIL 1.

W8  
TO  
W8  
CONNECTION




SECTION 1-1

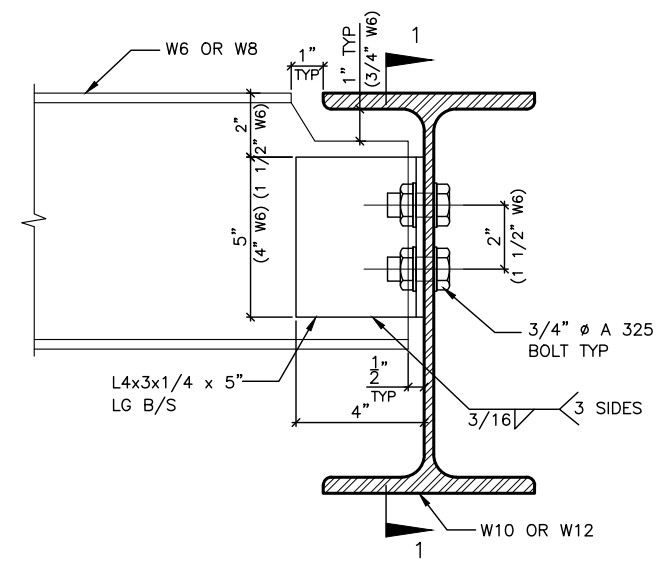


DETAIL 2.

W6(W8)  
TO  
W10(W12)  
CONNECTION

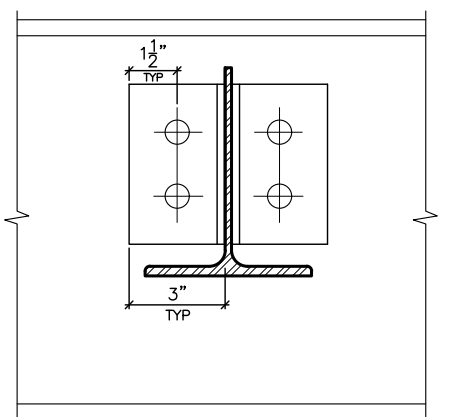


SECTION 1-1

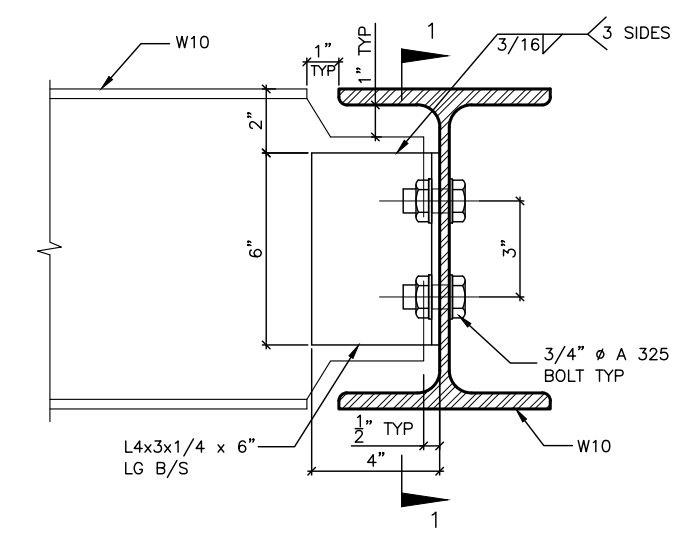

DETAIL 3.

W10  
TO  
W10  
CONNECTION

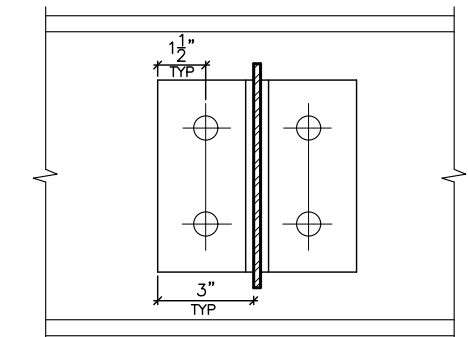


SECTION 1-1




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Discipline	Reviewer	BCIN	Date
Building Code	H. Authier	43236	2021-02-03
Sewage System			
Zoning			

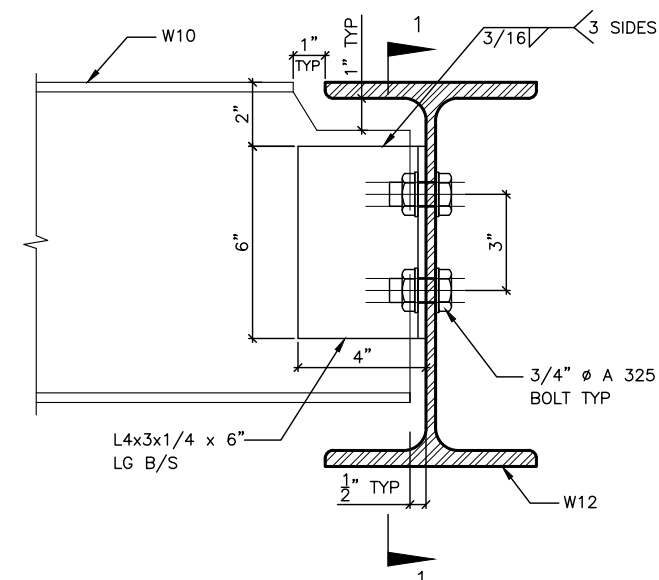


DETAIL 4.

W10  
TO  
W12  
CONNECTION

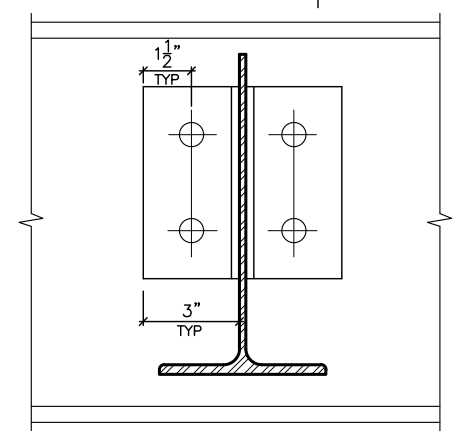


SECTION 1-1

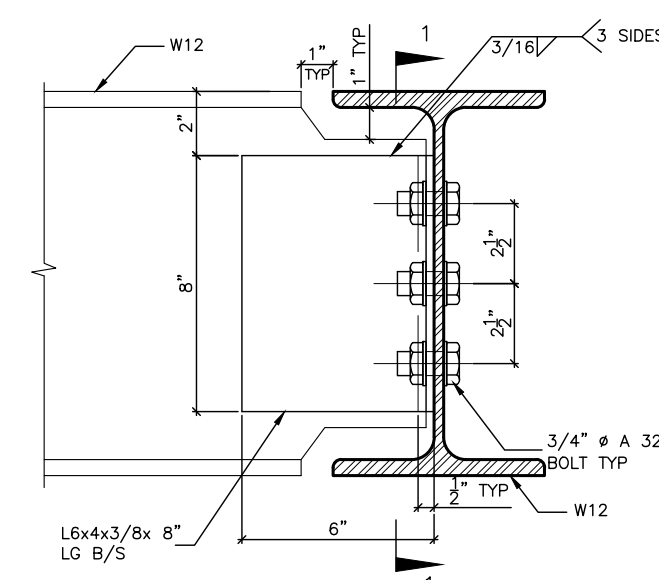

DETAIL 5.

W12  
TO  
W12  
CONNECTION

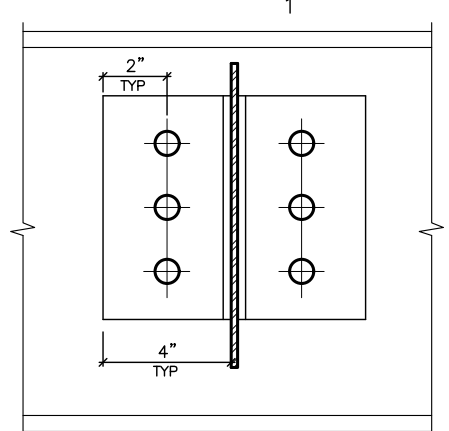


SECTION 1-1




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DETAIL 6.

ANGLE  
TO  
BEAM  
CONNECTION

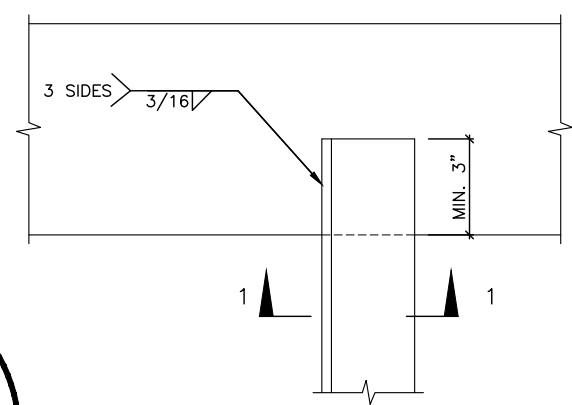

PLAN VIEW

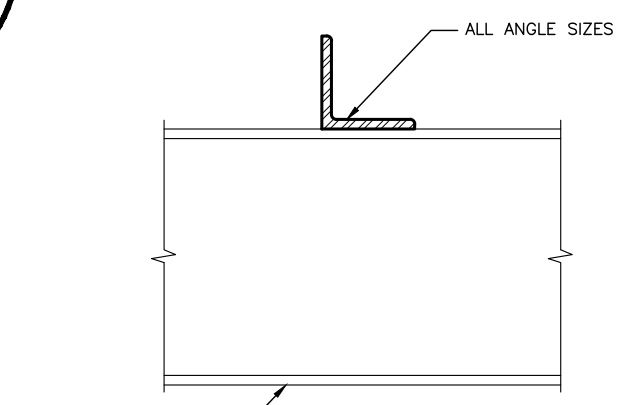

SECTION 1-1

2012 CODE  
ENERGY STAR


9.					
8.					
7.					
6.					
5.					
4.					
3.					
2.	INSUL VALUES ADJUSTED PER ESTAR V17	JAN 31/19	GW		
1.	ISSUED FOR PERMIT.	JAN. 26/18	GW		
no.	description	date	by		

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qualification information  
Richard Vink 24488  
name registration information  
VA3 Design Inc. 42658  
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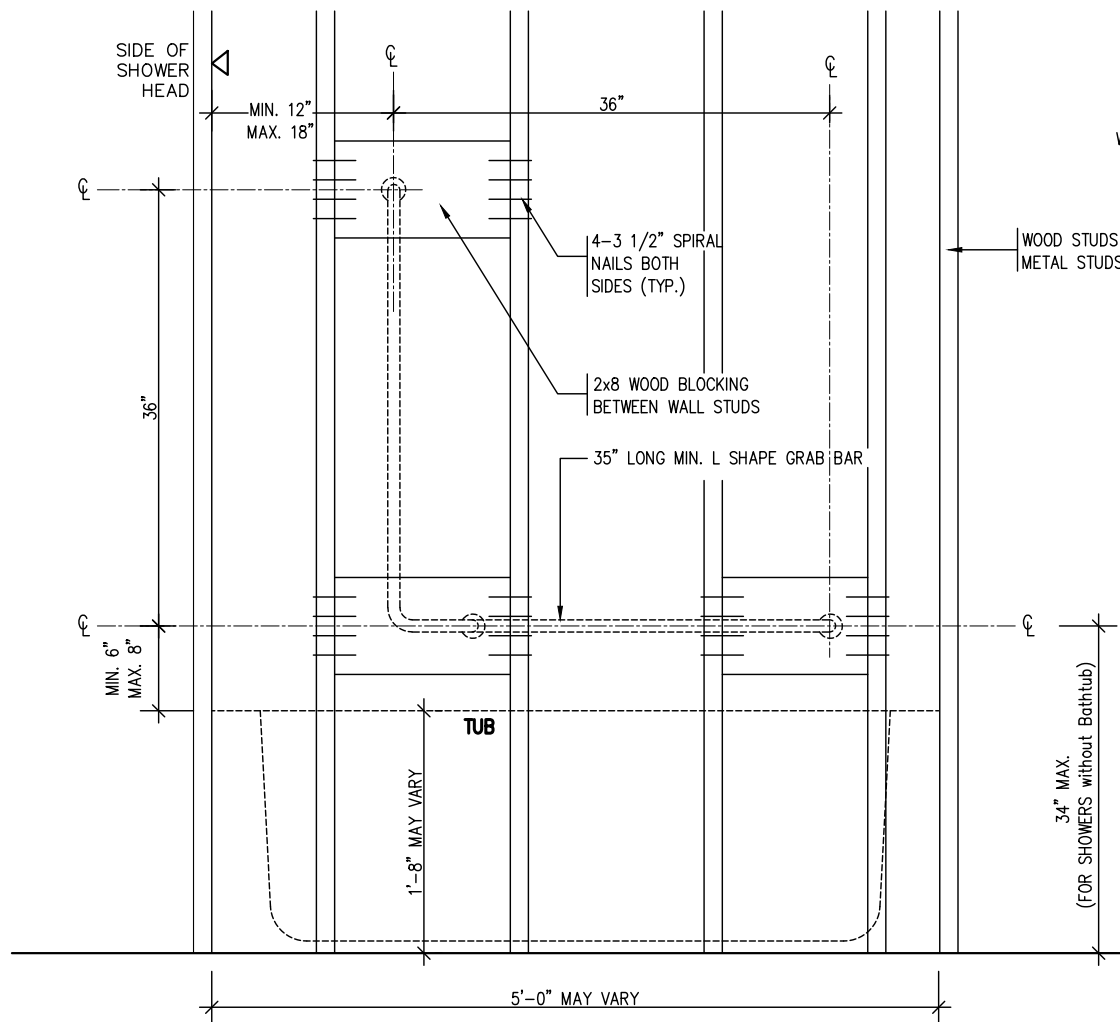


project name TRINAR HALL HOMES INC.		municipality EAST GWILLIMBURY		project no. 17026
date OCT. 2017	checked by -	scale Not to Scale	file name 17026-GP-STD_DETAILS_ES17	drawing no. 6
GREG - H:\ARCHIVE\WORKING\2017\17026.GRE\DETAILS\17026-GP-STD_DETAILS_ES17.dwg - Thu - Feb 14 2019 - 4:52 PM				




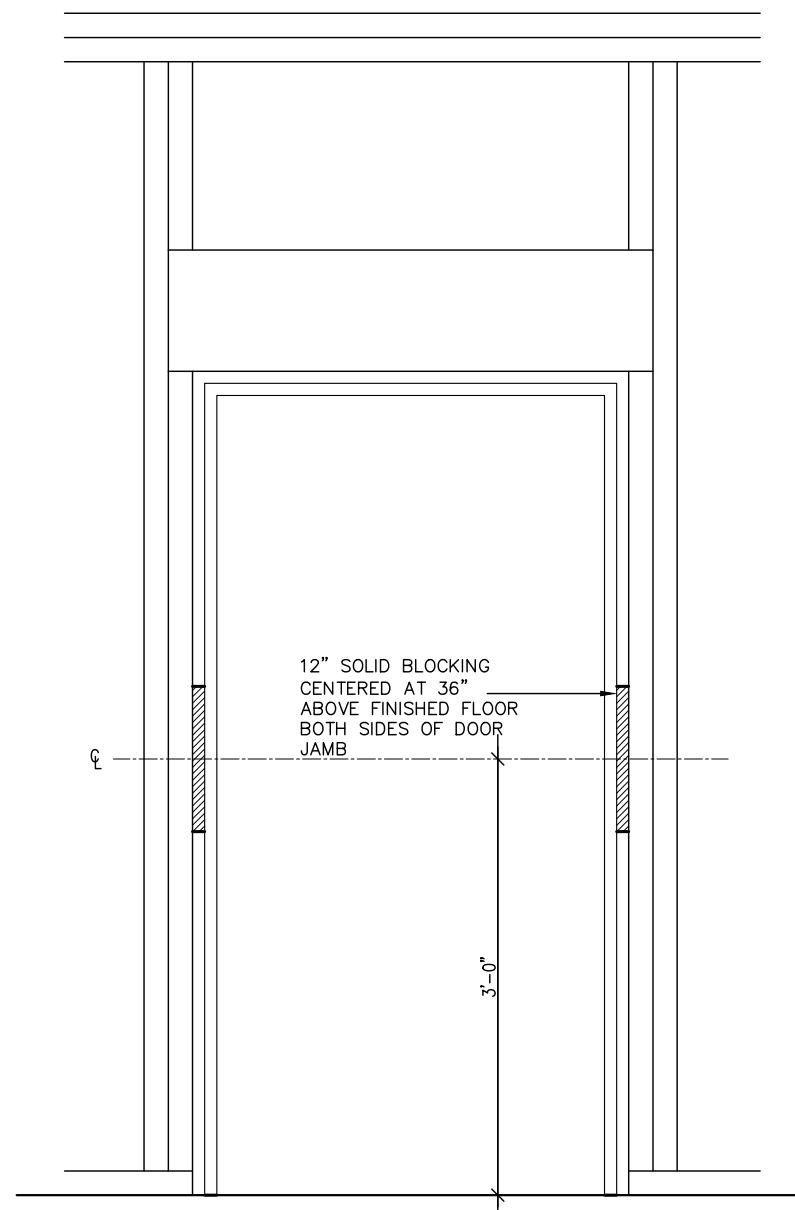


RESISTANCE TO FORCED ENTRY (OBC 9.6.8.)



BATH TUB/ SHOWER FRONT ELEVATION

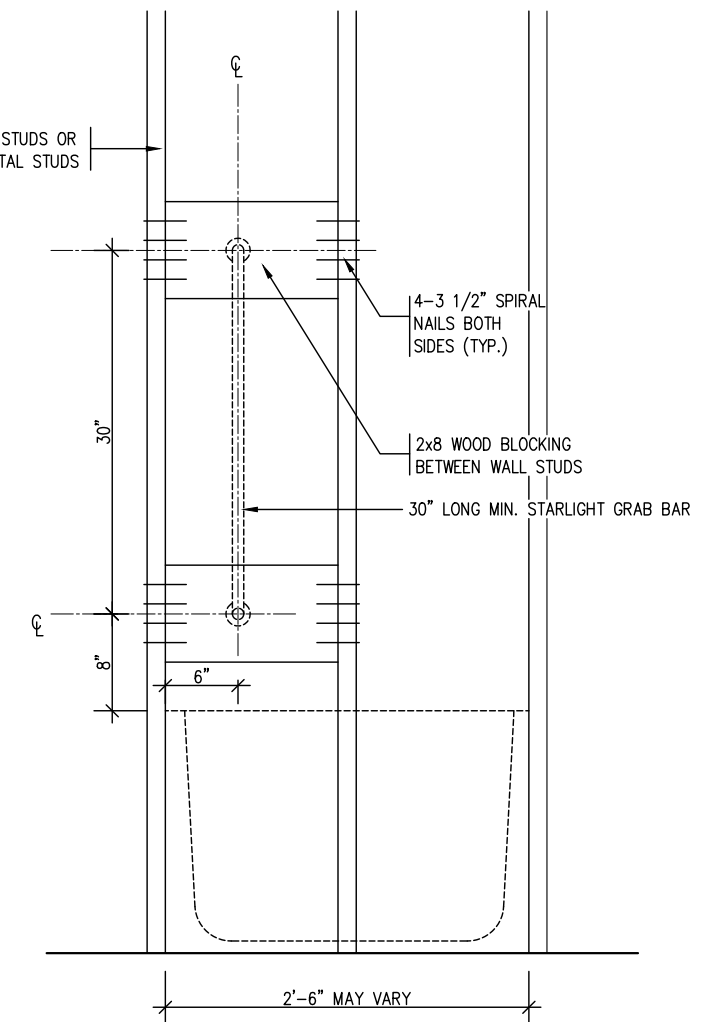


BATH TUB SHOWER HEAD SIDE ELEVATION

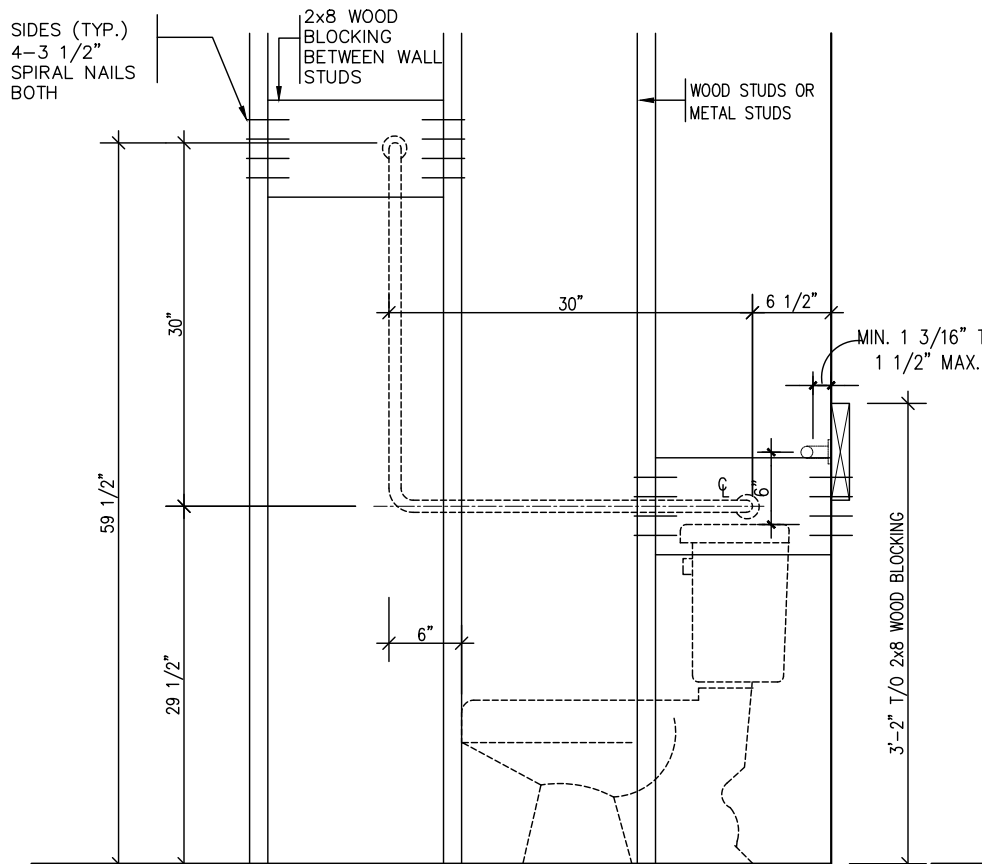

TOILET SIDE ELEVATION

STRUCTURAL REINFORCEMENT FOR GRAB BAR (OBC 9.5.2.3.)  
FOR MAIN BATH ONLY

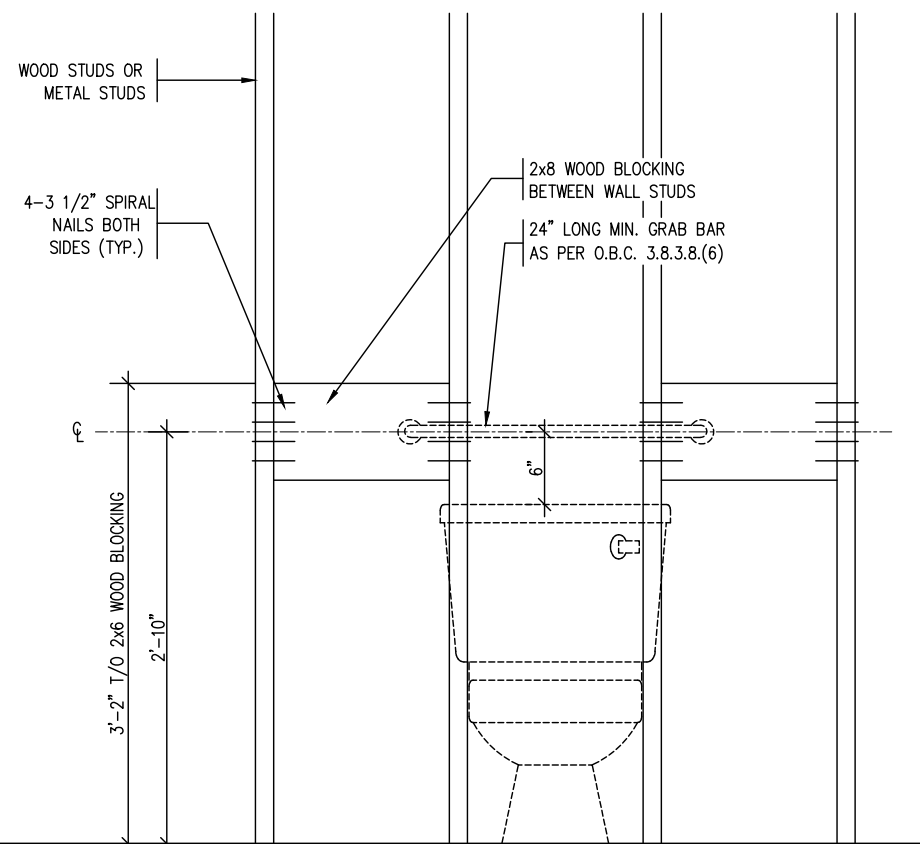

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Discipline	Reviewer	BCIN	Date
Building Code	H. Authier	43236	2021-02-03
Sewage System			
Zoning			

2012 CODE  
ENERGY STAR

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7	.	.	.	Richard Vink 24488
6	.	.	.	signature
5	.	.	.	BCIN
4	.	.	.	name
3	.	.	.	registration information
2	INSUL VALUES ADJUSTED PER ESTAR V17	JAN 31/19	GW	VA3 Design Inc. 42658
1	ISSUED FOR PERMIT.	JAN. 26/18	GW	
no.	description	date	by	

**VA3**  
DESIGN

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va3design.com

**Greenpark**

project name  
TRINAR HALL HOMES INC. EAST GWILLIMBURY

date  
OCT. 2017

drawn by  
GW

checked by  
-

scale  
Not to Scale


STUD WALL REINFORCEMENT

file name  
17026-GP-STD\_DETAILS\_ES17

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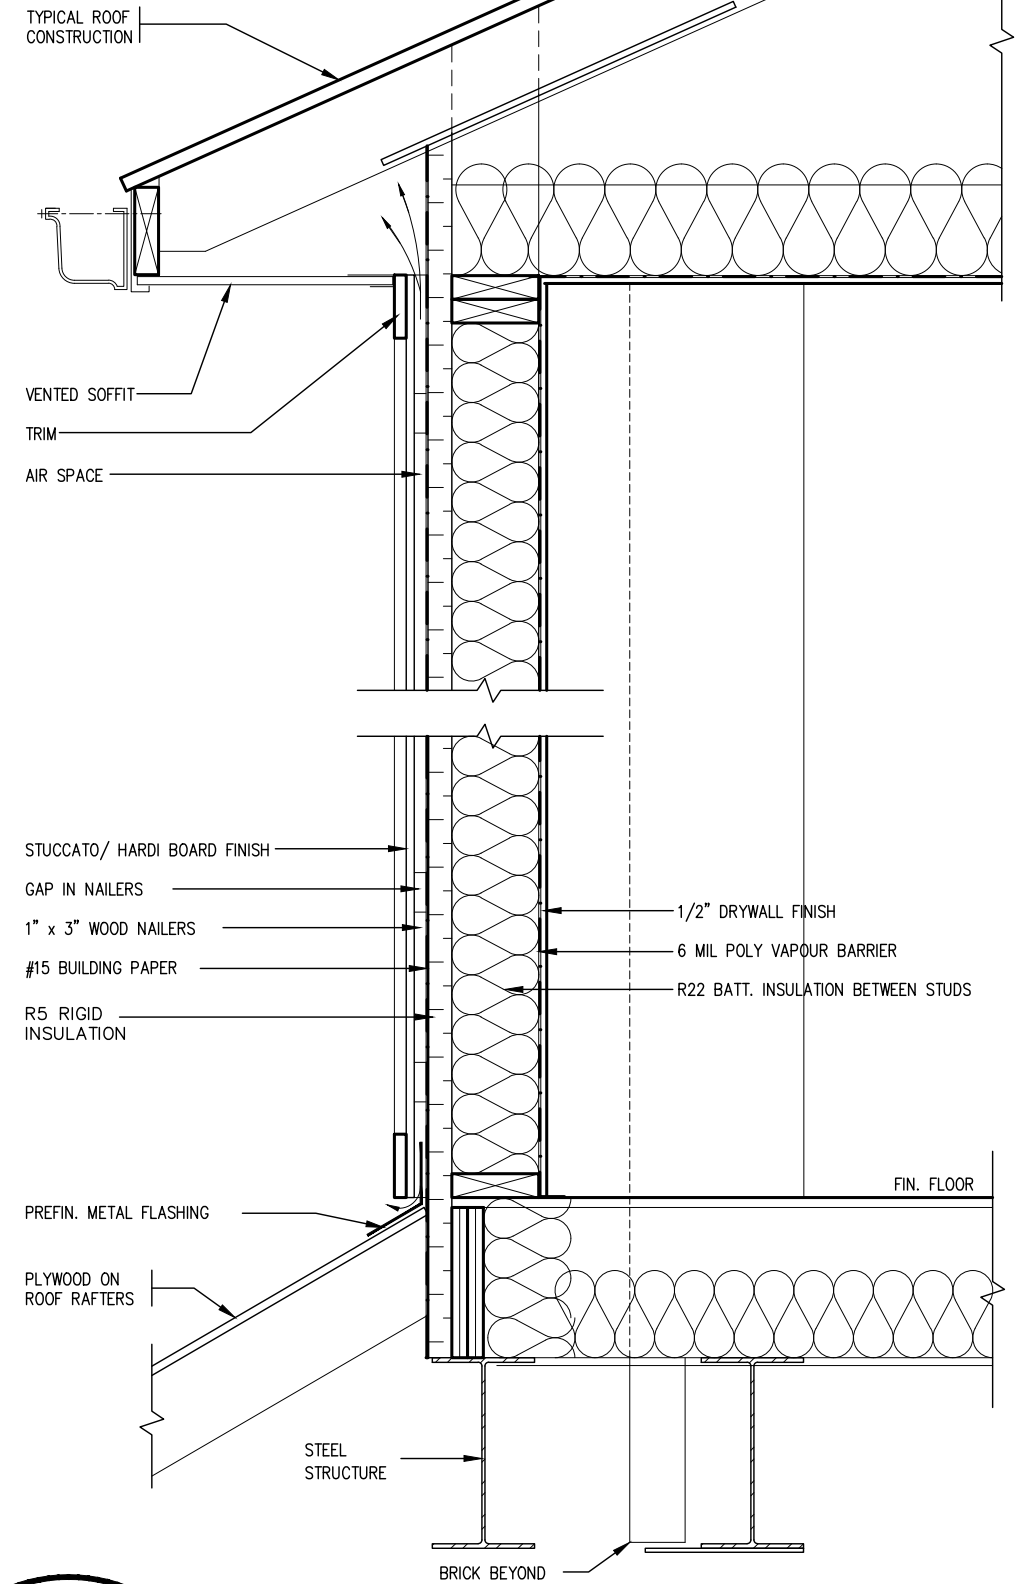
project no.  
17026

drawing no.  
7

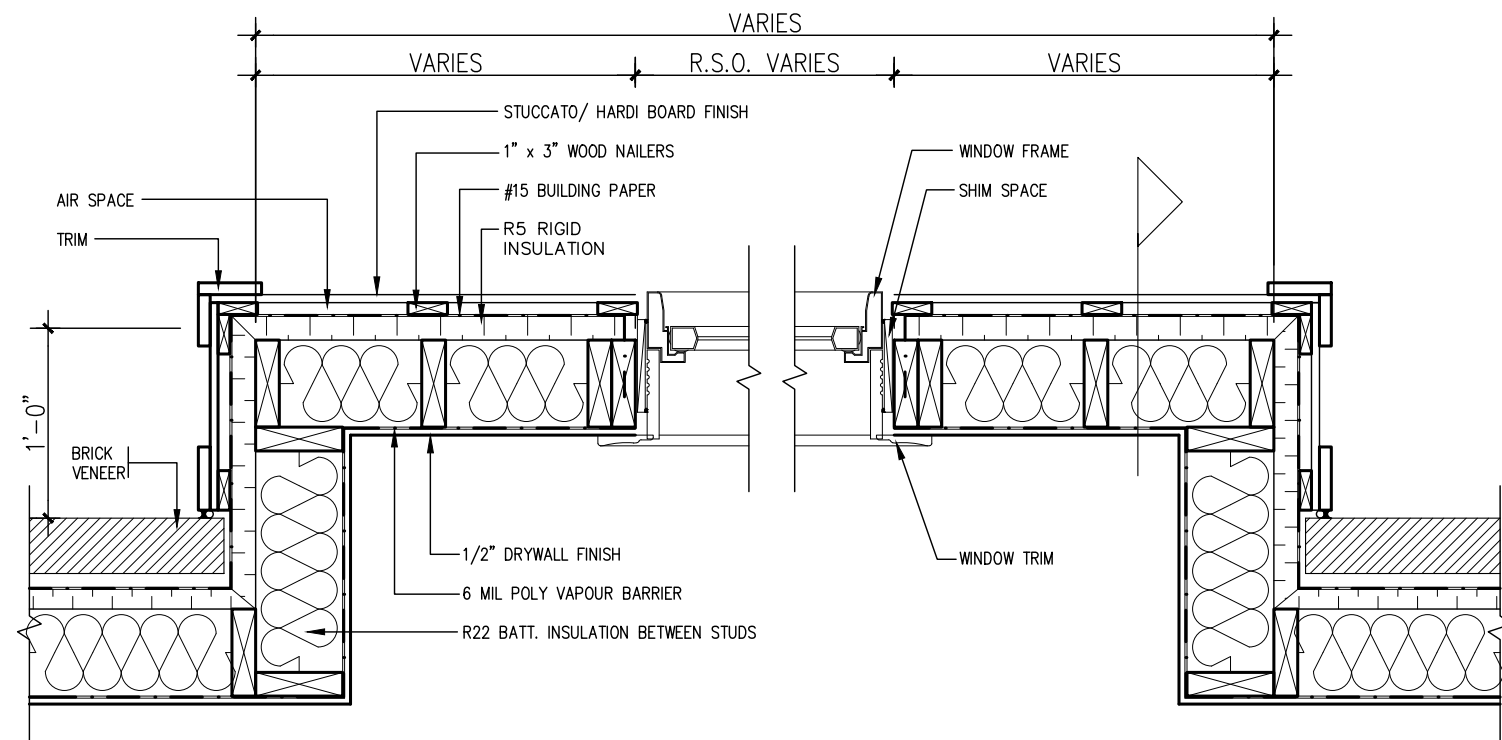

PLAN VIEW

STUCCATO BOARD FINISH CLADDING OR EQUAL (OBC 9.27.)



CROSS SECTION



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Sewage System			
Zoning			



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2012 CODE  
ENERGY STAR

<div> <div>9</div> <div>.</div> <div>.</div> </div>		<div> <div>8</div> <div>.</div> <div>.</div> </div>		<div> <div>7</div> <div>.</div> <div>.</div> </div>		<div> <div>6</div> <div>.</div> <div>.</div> </div>		<div> <div>5</div> <div>.</div> <div>.</div> </div>		<div> <div>4</div> <div>.</div> <div>.</div> </div>		<div> <div>3</div> <div>.</div> <div>.</div> </div>		<div> <div>2</div> <div>INSUL VALUES ADJUSTED PER ESTAR V17</div> <div>JAN 31/19 GW</div> </div>		<div> <div>1</div> <div>ISSUED FOR PERMIT.</div> <div>JAN. 26/18 GW</div> </div>		<div> <div>no.</div> <div>description</div> <div>date</div> <div>by</div> </div>		<div> <div>The undersigned has reviewed and takes responsibility for this design and has the qualifications and meets the requirements set out in the Ontario Building Code to be a Designer.</div> <div>qualification information</div> <div>Richard Vink 24488</div> <div>signature</div> <div>BCIN</div> <div>42658</div> <div>VA3 Design Inc.</div> <div>Contractor must verify all dimensions on the job and report any discrepancy to the Designer before proceeding with the work. All drawings and specifications are instruments of service and the property of the Designer which must be returned at the completion of the work. Drawings are not to be scaled.</div> </div>		<div> <div>VA3 DESIGN</div> <div>255 Consumers Rd Suite 120</div> <div>Toronto ON M2J 1R4</div> <div>t 416.630.2255 f 416.630.4782</div> <div>va3design.com</div> </div>		<div> <div>Greenpark</div> <div>project name</div> <div>TRINAR HALL HOMES INC.</div> <div>municipality</div> <div>EAST GWILLIMBURY</div> <div>date</div> <div>OCT. 2017</div> <div>checked by</div> <div>scale</div> <div>Not to Scale</div> <div>file name</div> <div>17026-GP-STD_DETAILS_ES17</div> <div>GREG - H:\ARCHIVE\WORKING\2017\17026.GRE\DETAILS\17026-GP-STD_DETAILS_ES17.dwg - Thu - Feb 14 2019 - 4:52 PM</div> </div>		<div> <div>project no.</div> <div>17026</div> <div>drawing no.</div> <div>8</div> </div>	
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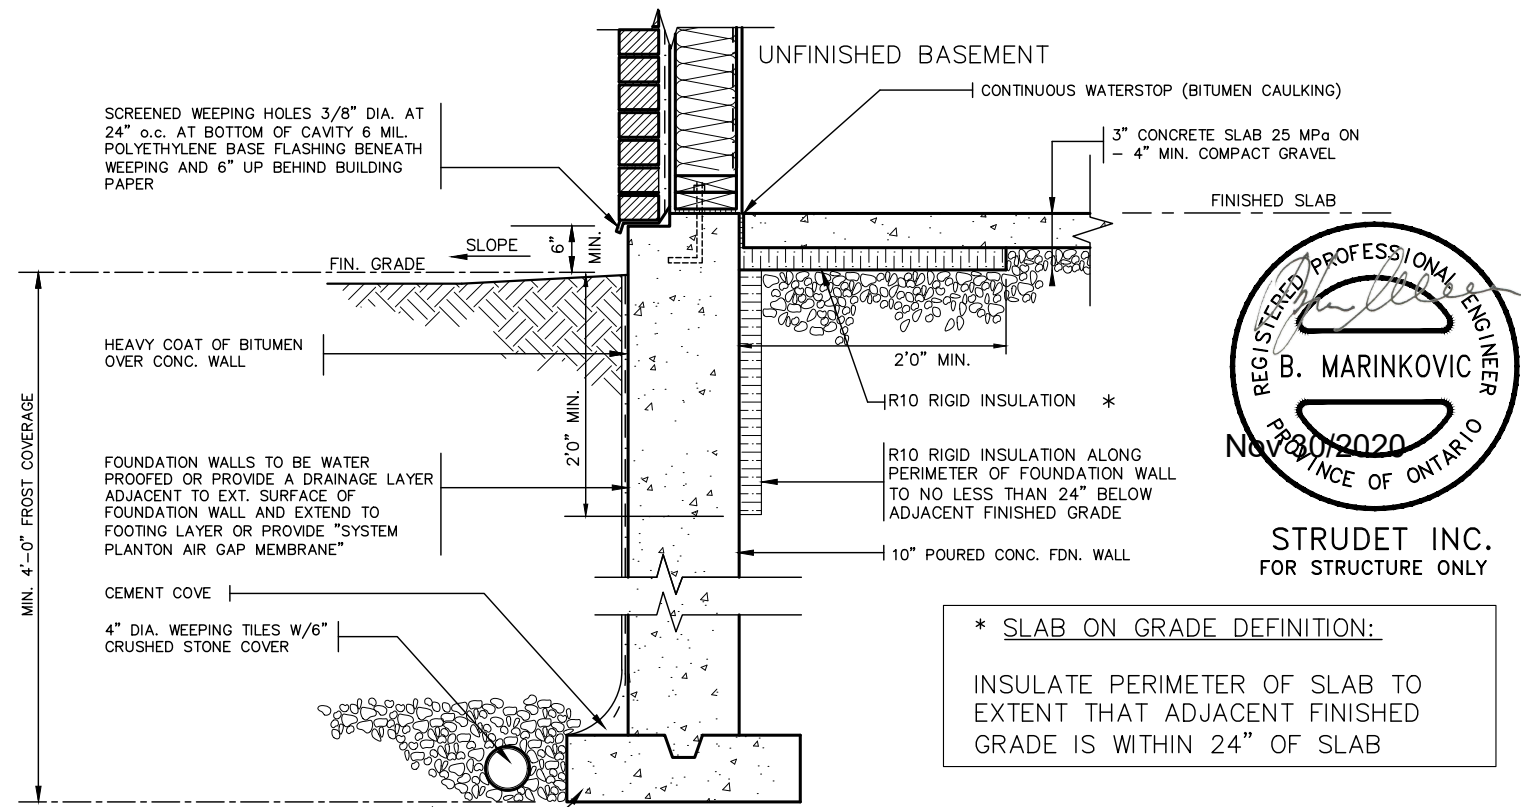
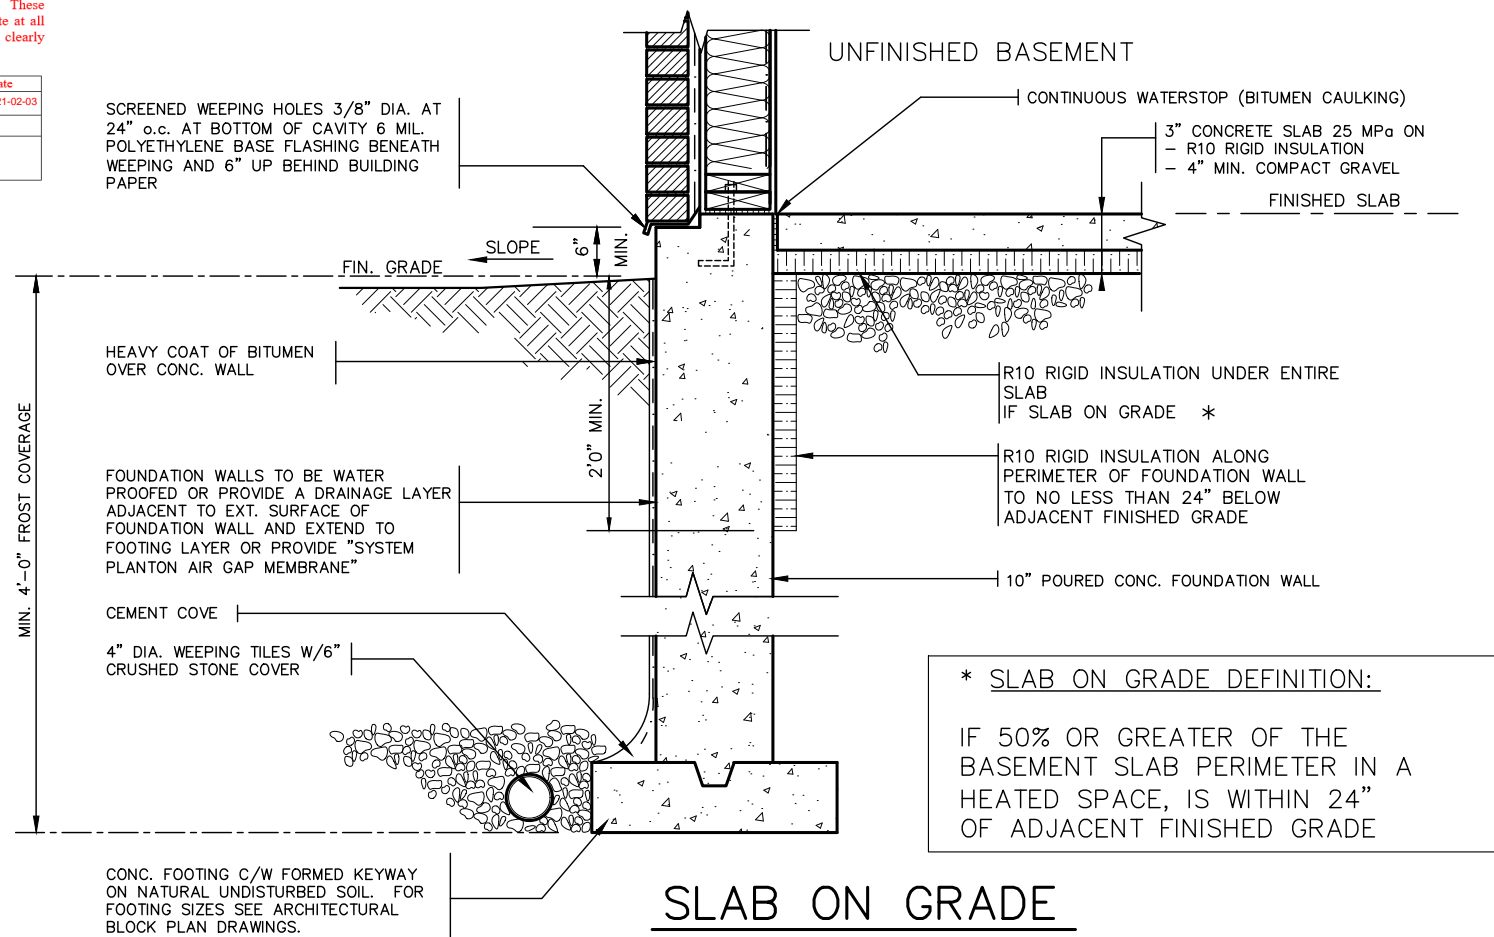
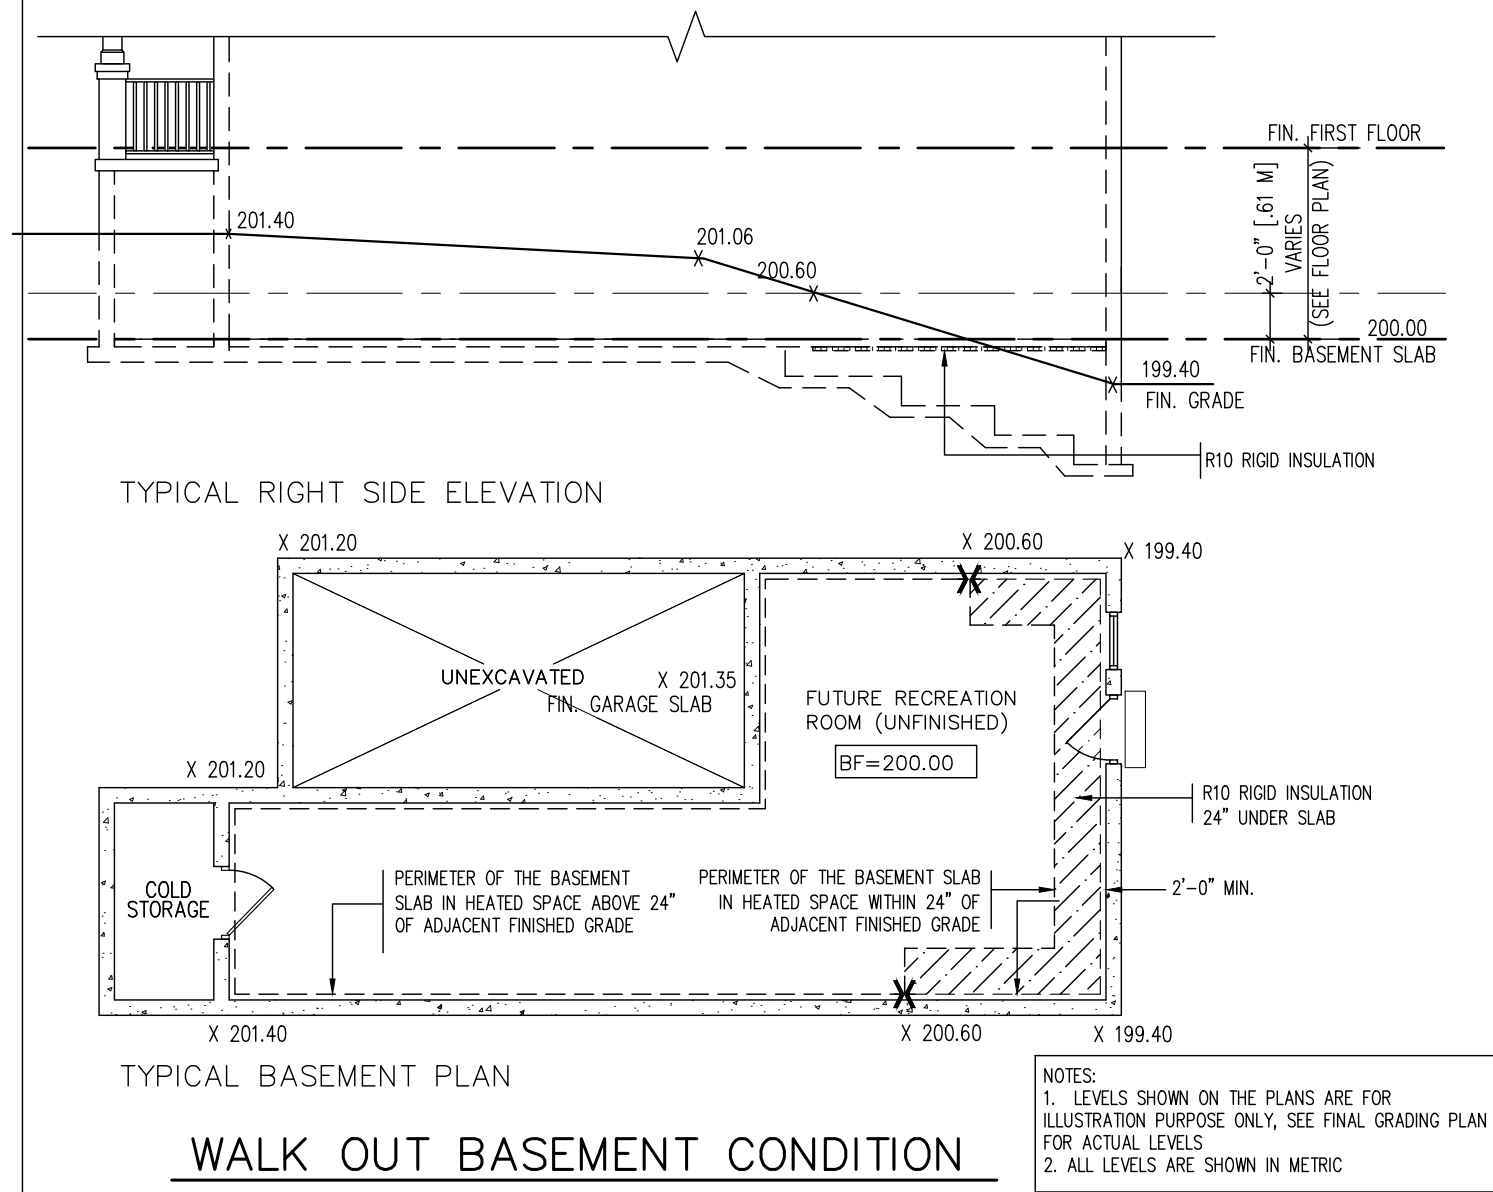
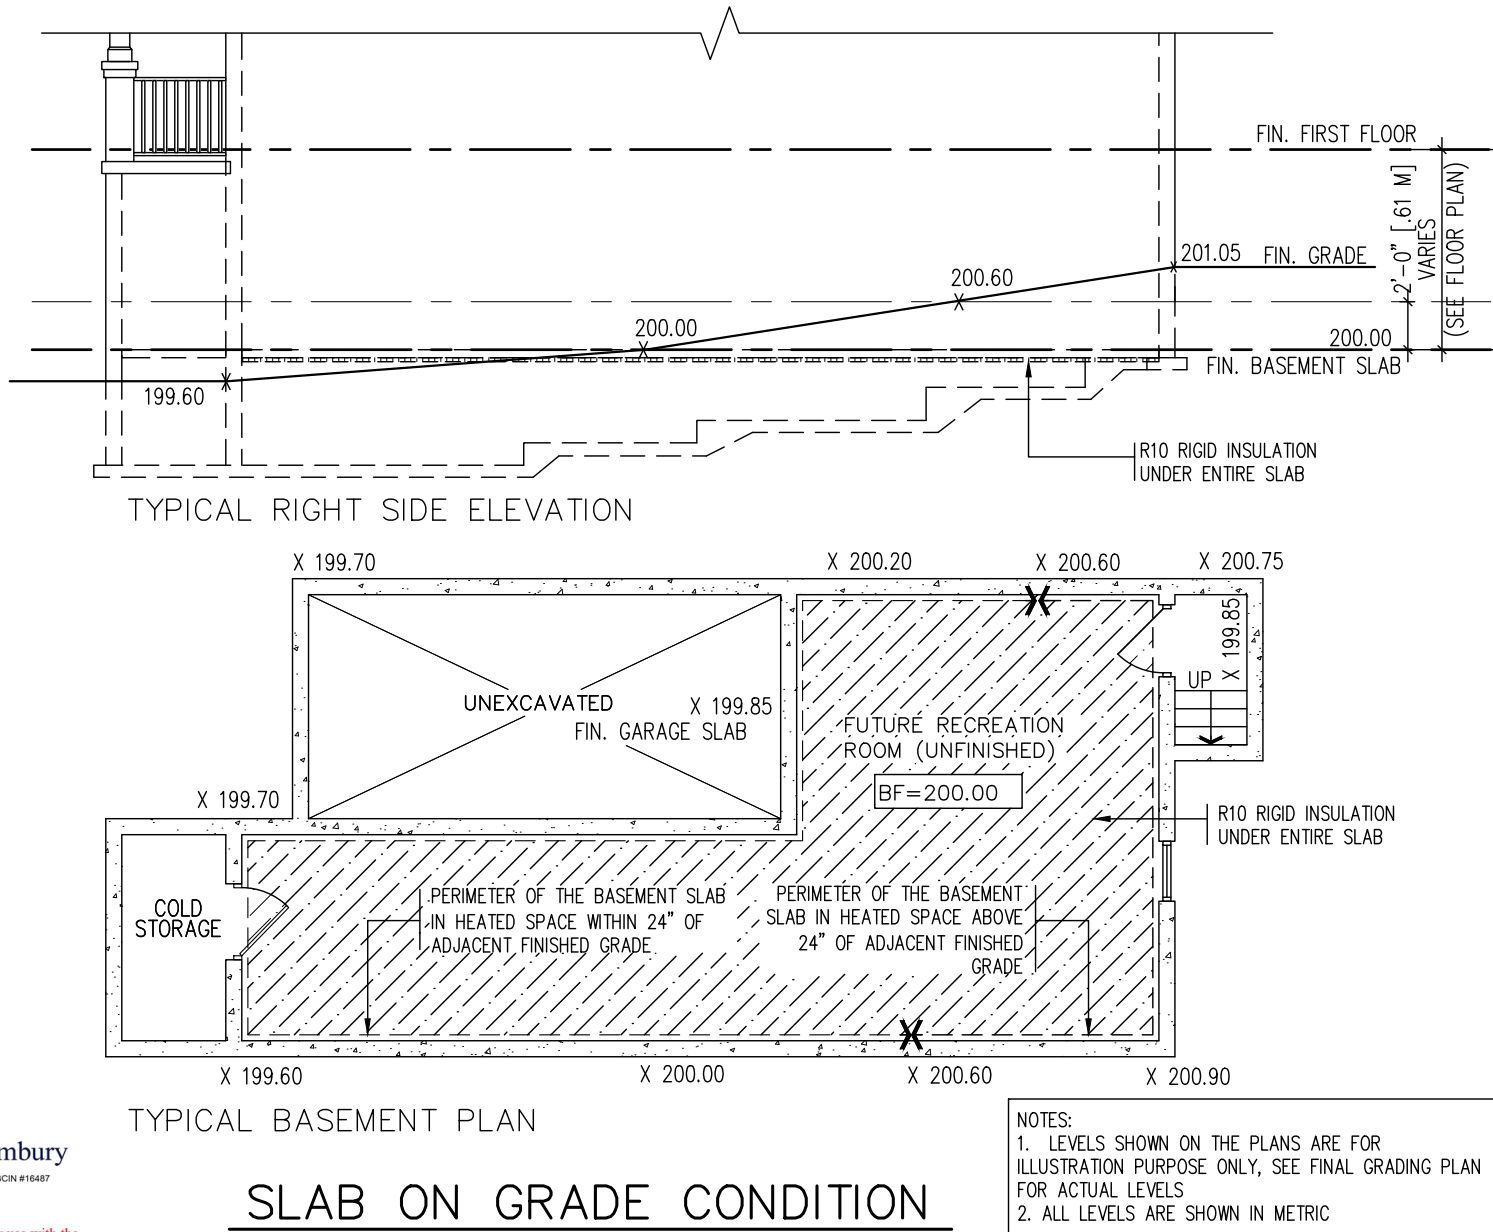
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Building Code	H. Authier	43236	2021-02-03
Sewage System			
Zoning			



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\* SLAB ON GRADE DEFINITION:  
INSULATE PERIMETER OF SLAB TO  
EXTENT THAT ADJACENT FINISHED  
GRADE IS WITHIN 24\"/>

2012 CODE  
ENERGY STAR

9	.	.	.
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5	.	.	.
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2	INSUL VALUES ADJUSTED PER ESTAR V17	JAN 31/19	GW
1	ISSUED FOR PERMIT.	JAN. 26/18	GW
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signature  
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t 416.630.2255 f 416.630.4782  
va3design.com

<b>Greenpark.</b>		-	
project name <b>TRINAR HALL HOMES INC.</b>	municipality <b>EAST GWILLIMBURY</b>	project no. <b>17026</b>	
date <b>OCT. 2017</b>	drawing no. <b>9</b>		
drawn by <b>GW</b>	checked by <b>-</b>	scale <b>Not to Scale</b>	file name <b>17026-GP-STD_DETAILS_ES17</b>
GREG - H:\ARCHIVE\WORKING\2017\17026.GRE\DETAILS\17026-GP-STD_DETAILS_ES17.dwg - Thu - Feb 14 2019 - 4:52 PM			