STRIP FOOTINGS FOR SINGLES AND SEMIS UP TO 2 STOREY

201Y61 CONCRETE STRIP FOOTINGS BELOW FOUNDATION WALLS. 24"x8" CONCRETE STRIP FOOTINGS BELOW PARTY WALLS.

100 KPa NATIVE SOIL

22"x8" CONCRETE STRIP FOOTINGS BELOW FOUNDATION WALLS. 28'x10' CONCRETE STRIP FOOTINGS BELOW PARTY WALLS

28'x8" CONCRETE STRIP FOOTINGS WITH REINFORCING BELOW PARTY WALLS

90 KPa ENGINEERED FILL SOIL

24"x8" CONCRETE STRIP FOOTING RCING BELOW FOUNDATION WALLS 30"x8" CONCRETE STRIP FOOTINGS WITH REINFORCING BELOW PARTY WALLS.

GENERAL NOTE:

100 KPa NATIVE SOIL

ASSUMED 120/100 KPa NATIVE SOIL BEARING CAPACITY OR 90 KPa FOR ENGINEERED FILL, TO BE VERIFIED ON SITE. REFER TO ENGINEERED FILL FOOTING DETAIL FOR REINFORCEMENT

(REFER TO ENG. FILL FOOTING DETAIL)

AREA CALCULATIONS EL-1

FIRST FLOOR AREA SECOND FLOOR AREA	=	1253 Sq. Ft. 1600 Sq. Ft.
TOTAL FLOOR AREA	=	2853 Sq. Ft.
ADD OPEN AREAS ADD FIN. BASEMENT AREA	=	0 Sq. Ft. 2853 Sq. Ft.
GROSS FLOOR AREA	=	2853 Sq. Ft.
GROUND FLOOR COVERAGE GARAGE COVERAGE / AREA PORCH COVERAGE / AREA	= = =	1253 Sq. Ft. 390 Sq. Ft. 116 Sq. Ft.
COVERAGE W/ PORCH	=	1759 Sq. Ft. 163.4 Sq. m.
COVERAGE W/O PORCH	_	1643 Sq. Ft.

= 152.6 Sq. m.

AREA CALCULATIONS EL-2

THIS TEOOR TO LET		1200 04.11
SECOND FLOOR AREA	=	1600 Sq. Ft
TOTAL FLOOR AREA	=	2853 Sq. Ft
ADD OPEN AREAS	=	0 Sq. Ft
ADD FIN. BASEMENT AREA	=	2853 Sq. Ft
GROSS FLOOR AREA	=	2853 Sq. Ft
GROUND FLOOR COVERAGE	=	1253 Sq. Ft
GARAGE COVERAGE / AREA	=	390 Sq. Ft
PORCH COVERAGE / AREA	=	54 Sq. Ft
COVERAGE W/ PORCH	=	1697 Sq. F
	=	157.6 Sq. m.
	TOTAL FLOOR AREA ADD OPEN AREAS ADD FIN. BASEMENT AREA GROSS FLOOR AREA GROUND FLOOR COVERAGE GARAGE COVERAGE / AREA PORCH COVERAGE / AREA	TOTAL FLOOR AREA = ADD OPEN AREAS = ADD FIN. BASEMENT AREA = GROSS FLOOR AREA = GROUND FLOOR COVERAGE = GARAGE COVERAGE / AREA = PORCH COVERAGE / AREA =

COVERAGE W/O PORCH = 1643 Sq. Ft.

152.6 Sq. m

FIRST FLOOR AREA

AREA CALCULATIONS EL-3 FIRST FLOOR AREA

FINST FLOOR AREA	_	1200 oq. 11.
SECOND FLOOR AREA	=	1613 Sq. Ft.
TOTAL FLOOR AREA	=	2866 Sq. Ft.
ADD OPEN AREAS	=	0 Sq. Ft.
ADD FIN. BASEMENT AREA	=	2866 Sq. Ft.
GROSS FLOOR AREA	=	2866 Sq. Ft.
GROUND FLOOR COVERAGE	=	1253 Sq. Ft.
GARAGE COVERAGE / AREA	=	390 Sq. Ft.
PORCH COVERAGE / AREA	=	116 Sq. Ft.
COVERAGE W/ PORCH	=	1759 Sq. Ft.
	=	163.4 Sq. m.

COVERAGE W/O PORCH = 1643 Sq. Ft

KIMBERLY 2 ELEV.-1 **ENERGY EFFICIENCY- A1 PACKAGE** LEVATION WALL FT² OPENING FT² PERCENTAGE 859.00 138.00 16.07 % F" SIDE 1043.00 52.00 4.99 % 1056.00 0.00 0.00 % GHT SIDE 828.00 166.00 20.05 % TOTAL 3786.00 356.00 9.40 %

KIMBERLY 2 ELEV	/2	ENERGY EFF	ICIENCY- A1 PACKAGE
ELEVATION	WALL FT ²	OPENING FT ²	PERCENTAGE
FRONT	869.00	144.00	16.57 %
LEFT SIDE	1045.00	52.00	4.98 %
RIGHT SIDE	1054.00	0.00	0.00 %
REAR	828.00	166.00	20.05 %
TOTAL	3796.00	362.00	9.54 %

KIMBERLY 2 ELEV3		ENERGY EFF	CIENCY- A1 PACKAGE
ELEVATION	WALL FT ²	OPENING FT ²	PERCENTAGE
FRCNT	876.00	147.00	16.78 %
LEF" SIDE	1042.00	52.00	4.99 %
RIGHT SIDE	1042.00	0.00	0.00 %
REAR	828.00	166.00	20.05 %
TOTAL	3788.00	365.00	9.64 %

2853 13.3m LOTS

BUILDING STANDARDS DIVISION

REVIEWED FOR COMPLIANCE WITH THE ONTARIO BUILDING

CODE AND THE APPLICABLE ZONING BY-LAW

20.130062.000.00.CM

ALL CONSTRUCTION SHALL COMPLY WITH

THE ONTARIO BUILDING CODE

NO PERSON SHALL CONSTRUCT OR DEMOLISH A BUILDING OR CAUSE A BUILDING TO BE CONSTRUCTED EXCEPT IN ACCORDANCE

WITH THESE CERTIFIED BUILDING PERMIT DOCUMENTS, THE

NOTE: THE PROPOSED DEVELOPMENT IS SUBJECT TO COMPLIANCE WITH ALL APPLICABLE PROVISIONS OF THE ZONING BY-LAW AND

ALL OTHER APPLICABLE LAWS INCLUDING THE PROVISIONS OF A

SITE PLAN AND / OR SUBDIVISION AGREEMENT WHICH MAY OR MAY

NOT BE REGISTERED ON TITLE

KIMBERLY 2 (GR) **ELEVATION 1,2 & 3**

A1 PACKAGE

O.REG. 332/12

STRUDET INC.



FOR STRUCTURE ONLY

E CONTRACTOR SHALL CHECK AND VERIFY ALL DIVENSIONS AND NOTIONS ON STE BEFORE PROCEEDING MITH CONSTRUCTION. VINSCHEPANIES SHALL SE REPORTED TO JARDIN DESIGN GRO PRIOR TO COMMENCEMENT OF WORK.

CONTROL OF THE ACCURATE ACTION OF THE ACCURATE A CONSTRUCTED INVERTS MUST BE VERIFIED PRIOR TO POURING

FINE THE POPUL OF THE WORK AND ASSUMES NO RESPONSIBILITY
OR THE FAILURE OF THE CONTRACTOR OR SUB-CONTRACTOR TO
ARP OUT THE WORK IN ACCORDANCE WITH THE CONTRACTOR.

HIS DRAWING IS AN INSTRUMENT OF SERVICE. IS PROVIDED BY AND THE PROPERTY OF JARTIN DESIGN CROUP INC. THIS DRAWING IS NO

- 1	TOE	SE SCALED.	
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	2		
	1	JULY 2, 2020	ISSUED FOR BUILDING PERMIT

WORK DESCRIPTION:

64 JARDIN DR. SUITE 3A VAUGHAN ONT. L4K 3P3 TEL: 905 660-3377 FAX: 905 660-371; EMAIL: info@jardindesign.ca

he undersigned has reviewed and takes responsibility for this design and has the qualifications and meets the uirements set out in the Ontario Building Code to b QUALIFICATION INFORMATION

QUALIFICATION INFORMATION
Required unless design is execute upda symston c, subsection
3.2.5 of the buying to the

Walter Botter 21031

SIGNATURE NAME

REGISTRATION INFORMATION

jardin design group inc. IRM NAME

TITLE SHEET LAMPONE INVESTMENTS INC. CITY OF MARKHAM



It is the builder's complete responsibility to ensure that all plans submitted for approval fully comply with the Architectural Guidelines and all applicable regulations and requirements including zoning provisions and any provisions in the subdivision agreement. The Control Architect is not responsible in any way for examining or approving site (lotting) plans or working drawings with respect to any zoning or building code or permit matter or that any house can be properly built or located on its lot.

This is to certify that these plans comply with the applicable Architectural Design Guidelines approved by the City of MARKHAM.

3/16"=1'-0" IOJ. No. 0 20-03

PAD FOOTING

120 KPa NATIVE SOIL

=1 = 42"x42"x18" CONCRETE PAD

F1 = 48"x48"x20" CONCRETE PAD =2 = 36"x36"x16" CONCRETE PAD F3 = 30"x30"x12" CONCRETE PAD

F2 = 40"x40"x46" CONCRETE PAD F3 = 34"x34"y44" CONCRETE PADF4 = 24"x24"x12" CONCRETE PAD F5 = 16"x16"x8" CONCRETE PAD F5 = 18"x18"x8" CONCRETE PAB

90 KPa ENGINEERED FILL SOIL

F1 = 46"x46"x20" CONCRETE PAD F2 = 38"x38 x16" CONCRETE PAD F3 = 32"x32"x14" CONCRETE PAD $F4 = 26' \times 26' \times 12'$ CONCRETE PAD F5 = 17"x17"x8" CONCRETE PAD

(REFER TO FLOOR PLAN FOR UNUSUAL SIZE PADS NOT ON CHART)

NOTE:

WHEN VENEER CUT IS GREATER THAN 26" A 10" POURED CONC. FOUNDATION WALL IS REQUIRED.

NOTE:

ALL GARAGE SLABS, PORCH SLABS, STAIRS (EXPOSED CONC. FLAT WORK) TO BE 32 MPa WITH 5-8% AIR ENTRAITMENT

BRICK VENEER LINTELS:

WI 1 = $3.1 \times 2^{\circ} \times 3.1 \times 2^{\circ} \times 1 \times 4^{\circ} \times (90 \times 90 \times 6) + 2 \times 2^{\circ} \times 8^{\circ} \times 90 \times 6$ $WI.6 = 5^{\circ} \times 3.1 \times 2^{\circ} \times 5 \times 16^{\circ} (125 \times 90 \times 8) - 2 \cdot 2^{\circ} \times 12^{\circ} SPR$ WL2 = $4'' \times 3 \times 2'' \times 5 \times 16'' \times 100 \times 90 \times 8) + 2 - 2'' \times 8'' \text{ SPR}$. WL3 = $5'' \times 3 \times 1/2'' \times 5/16'' \times 125 \times 90 \times 8) + 2 - 2'' \times 10'' \text{ SPR}.$ $WL4 = 6'' \times 3 \times 1/2'' \times 3/8'' (150x90x10) + 2-2'' \times 12'' SPR.$

WL7 = 5° x 3 1\2" x 5\16" (125x90x8) + 3-2" x 10" SPR. WL8 = 5° x 3 1\2" x 5\16" (125x90x8) + 3-2" x12" SPR. $WL9 = 6" \times 4" \times 3 \times 8" (150 \times 100 \times 10) + 3 - 2" \times 12" SPR.$ $WL5 = 6'' \times 4'' \times 3 \times (150 \times 100 \times 10) + 2 - 2'' \times 12'' SPR.$

WOOD LINTELS:

WB1 = 2-2" x 8" SPRUCE BEAM WB2 = 3-2" x 8" SPRUCE BEAM WB3 = 2-2" x 10" SPRUCE BEAM

WB6 = 3-2" x 12" SPRUCE BEAM WB7 = 5-2" x 12" SPRUCE BEAM WB10 = 4- 2" x 8" SPRUCE BEAM WB4 = 3-2" x 10" SPRUCE BEAM WB11 = 4-2" x 10" SPRUCE BEAM WB5 = 2-2" x 12" SPRUCE BEAM

STEEL LINTELS:

 $L1 = 3 \frac{1}{2} \times 3 \frac{1}{2} \times \frac{1}{4} (90 \times 90 \times 6)$ $L4 = 6'' \times 3 \frac{1}{2} \times 3 \frac{1}{2} \times 3 \frac{1}{2} \times 3 \times 90 \times 10$ L2 = 4" x 3 1\2" x 5\16" (100 x 90 x 8) L5 = 6" x 4" x 3\8" (150 x 100 x 10) $L3 = 5" \times 3 \text{ 1/2"} \times 5 \text{ 16"} (125 \times 90 \times 8)$ $L6 = 7" \times 4" \times 3 \text{ 8"} (180 \times 100 \times 10)$

LAMINATED VENEER LUMBER (LVL BEAMS)

LVL1A = 1-1 3/4" x 7 1/4" (1-45x184) = 2-1 3/4" x 7 1/4" (2-45x184) = 3-1 3/4" x 7 1/4" (3-45x184) $LVL3 = 4-13/4" \times 71/4" (4-45x184)$ LVL4A = 1-1 3/4" x 9 1/2" (1-45x240) LVL4 = 2-1 3/4" x 9 1/2" (2-45x240) $LVL5 = 3-1.3/4" \times 9.1/2" (3-45x240)$ LVL5A = 4-1 3/4" x 9 1/2" (4-45x240) LVL6A= 1-1 3/4" x 11 7/8" (1-45x300) LVL6 = 2-1 3/4" x 11 7/8" (2-45x300) LVL7 = 3-1 3/4" x 11 7/8" (3-45x300)

LVL7A= 4-1 3/4" x 11 7/8" (4-45x300)

3-1 3/4" x 14" (3-45x356)

LVL8 = 2-1 3/4" x 14" (2-45x356)

2-2'x6" STUD WALL NAILED TOGETHER AND SPACED @12" O.C. FULL HT C/W SOLID BLOCKING 4'-0" O.C. VERTICAL AND 7/16" EXT. PLYWOOD SHEATHING.


Certified Model reviewed and approved based on

Where site conditions differ, a lot-specific revision

application is required to be submitted and

footing design for 120 kPa native soil.


approved prior to pouring of footings.

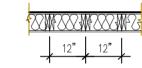

MAXIMUM HEIGHT OF WALL FOR THIS DETAIL IS 18'-0" AND MAXIMUM SUPPORTED LENGTH OF TRUSS IS 40'-0"

TWO STOREY HEIGHT WALL DETAIL

2 - 1 1/2" x 5 1/2" TIMBERSTRAND (LSL) 1.5E STUD WALL GLUED AND NAILED TOGETHER AND SPACED MAX. @10"O.C. FULL HT C/W SOLID BLOCKING MAX. 8'-0"O.C. VERTICAL AND 7/16" EXT. OSB SHEATHING.

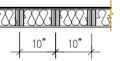

MAXIMUM HEIGHT OF WALL FOR THIS DETAIL IS 20'-2" AND MAXIMUM SUPPORTED LENGTH OF TRUSS IS 40'-0"

TWO STOREY HEIGHT WALL DETAIL

NOTE:

THESE DRAWINGS ARE TO BE READ IN CONJUNCTION WITH ENGINEER APPROVED ROOF TRUSS DRAWINGS BY MANUFACTURER

Door Schedule


NO.	WIDTH	8' T(GHT O 9' LINGS	HEIGH 10' OR CEILIN	MORE	TYPE
1	2'-10"	6'-8"	(865x2033)	8'-0"	(865x2439)	INSULATED ENTRANCE DOOR
1a	2'-8"	6'-8"	(815x2033)	8'-0"	(815x2439)	INSULATED FRONT DOORS
2	2'-8"	6'-8"	(815x2033)	8'-0"	(815x2439)	WOOD & GLASS DOOR
3	2'-8"	6'-8 x 1-3/4"	(815x2033x45)	8'-0" x 1-3/4"	(815x2439x45)	EXTERIOR SLAB DOOR
4	2'-8"	6'-8" x 1-3/8"	(815x2033x35)	8'-0" x 1-3/8"	(815x2439x35)	INTERIOR SLAB DOOR
5	2'-6"	6'-8" x 1-3/8"	(760x2033x35)	8'-0" x 1-3/8"	(760x2439x35)	INTERIOR SLAB DOOR
6	2'-2"	6'-8" x 1-3/8"	(660x2033x35)	8'-0" x 1-3/8"	(660x2439x35)	INTERIOR SLAB DOOR
7	1'-6"	6'-8" x 1-3/8"	(460x2033x35)	8'-0" x 1-3/8"	(460x2439x35)	INTERIOR SLAB DOOR
8	3'-0"	6'-8" x 1-3/8"	(915x2033x35)	8'-0" x 1-3/8"	(915x2439x35)	INTERIOR SLAB DOOR

SPACE CONVENTIONAL FLOOR JOISTS @: 12" O.C. BELOW ALL CERAMIC TILE AREAS. PROVIDE 1 ROW BRIDGING FOR SPANS OF 5'-7', 2 ROWS FOR SPANS GREATER THAN I

THESE DRAWINGS ARE TO BE READ IN CONJUNCTION WITH ENGINEER APPROVED LOOR TRUSS LAYOUT BY MANUFACTURER

NOTE:

PLANS NOT DRAWN TO ACTUAL GRADE. REFER TO FINAL GRADING PLAN.

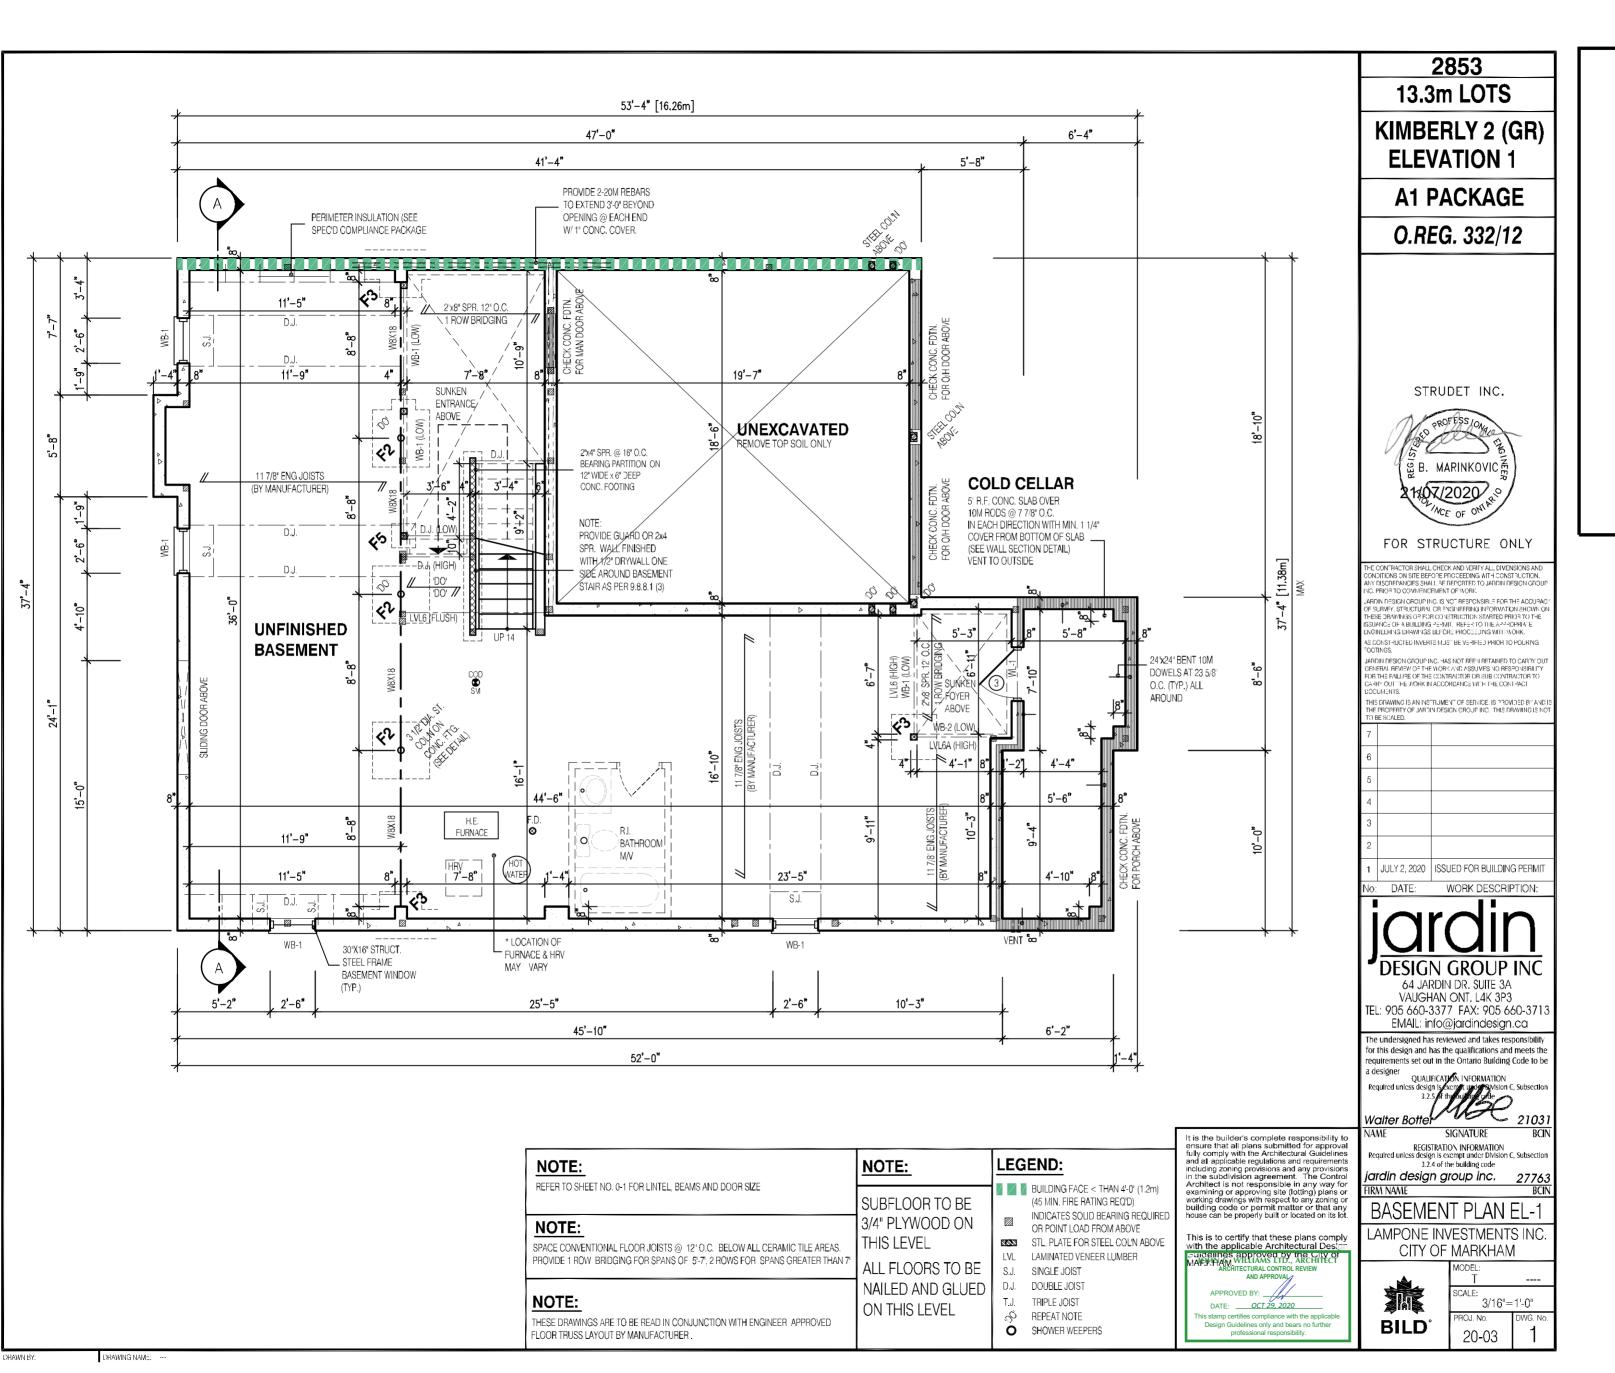




REVIEWED FOR COMPLIANCE WITH THE ONTARIO BUILDING
CODE AND THE APPLICABLE ZONING BY-LAW



Date: 02/05/5

ALL CONSTRUCTION SHALL COMPLY WITH THE ONTARIO BUILDING CODE

NO PERSON SHALL CONSTRUCT OR DEMOLISH A BUILDING OR CAUSE A BUILDING TO BE CONSTRUCTED EXCEPT IN ACCORDANCE WITH THESE CERTIFIED BUILDING PERMIT DOCUMENTS, THE BUILDING CODE ACT AND THE BUILDING CODE.

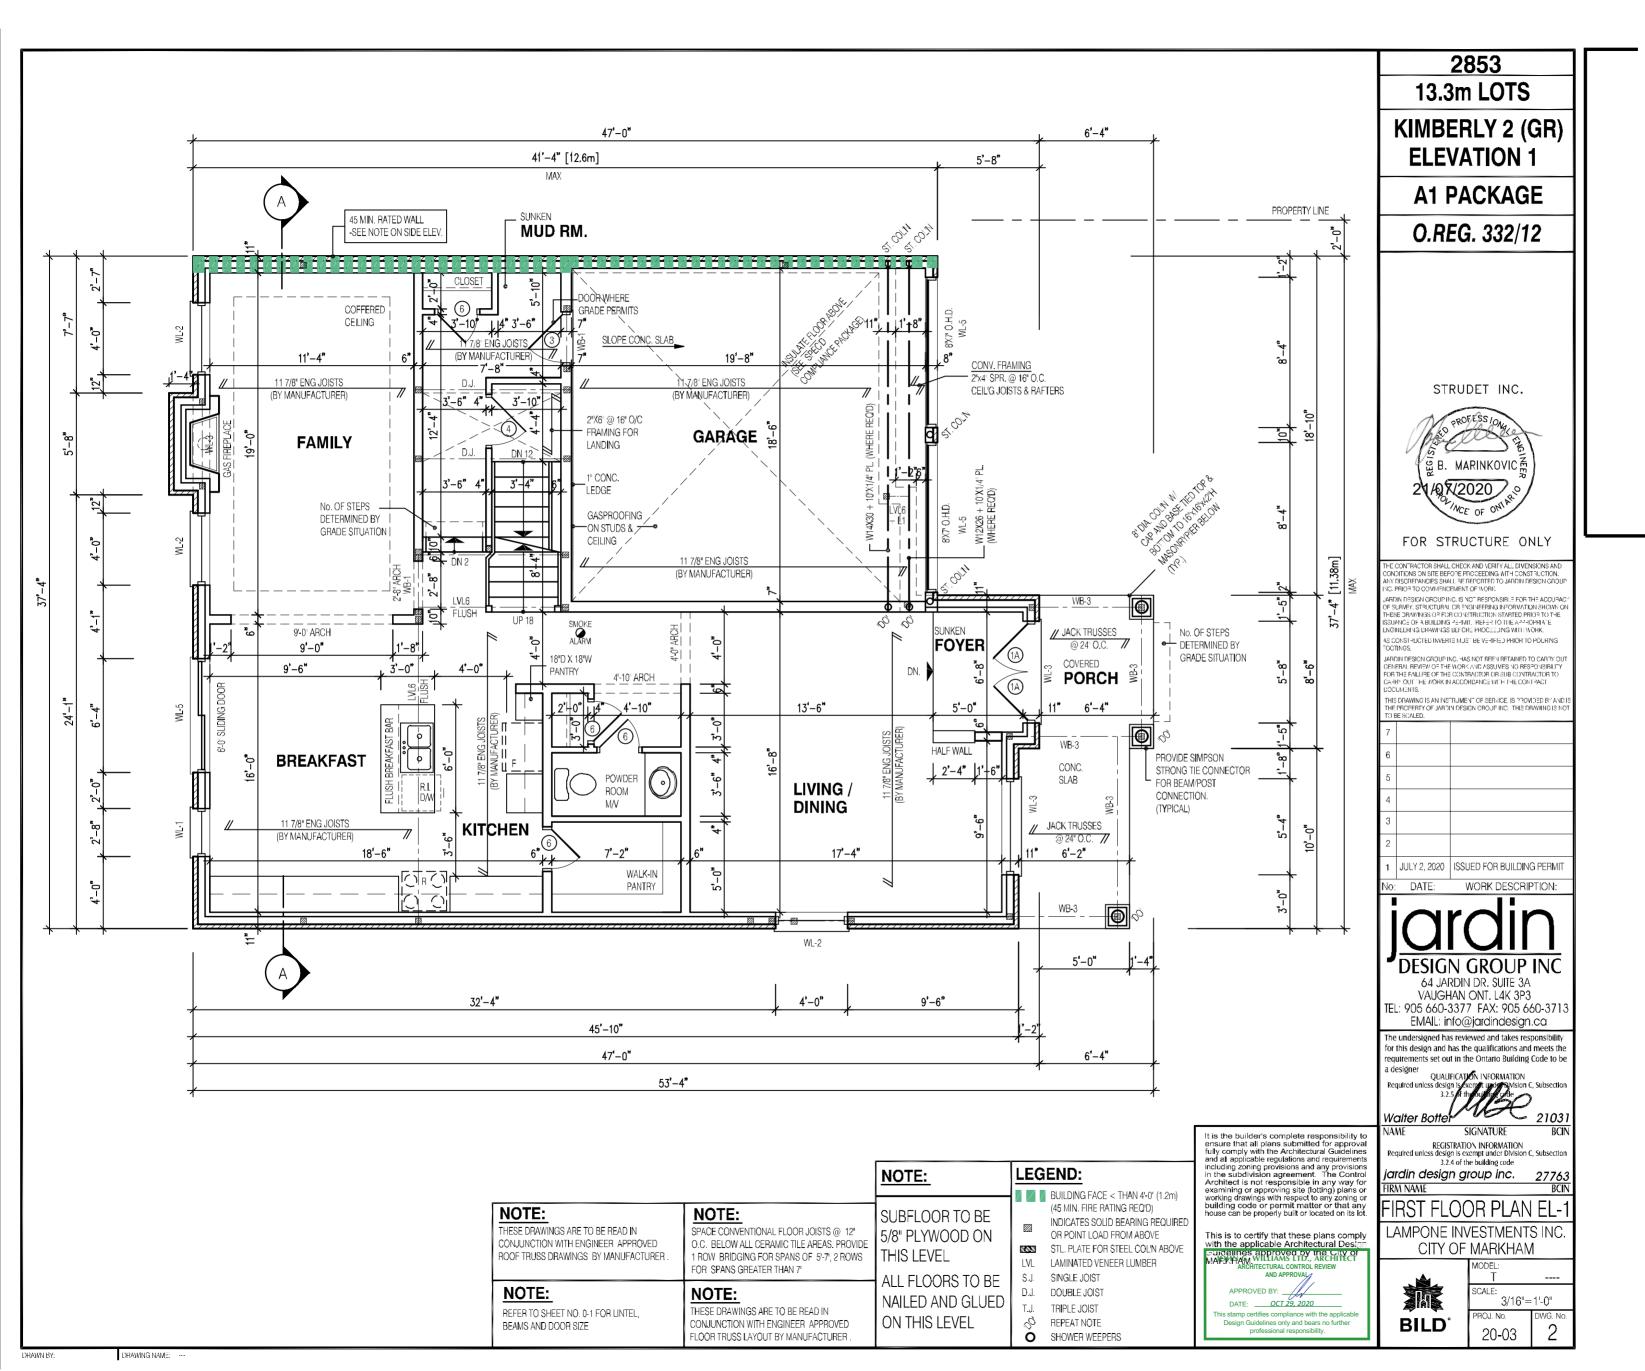




BUILDING STANDARDS DIVISION
REVIEWED FOR COMPLIANCE WITH THE ONTARIO BUILDING



Date: 02/05/

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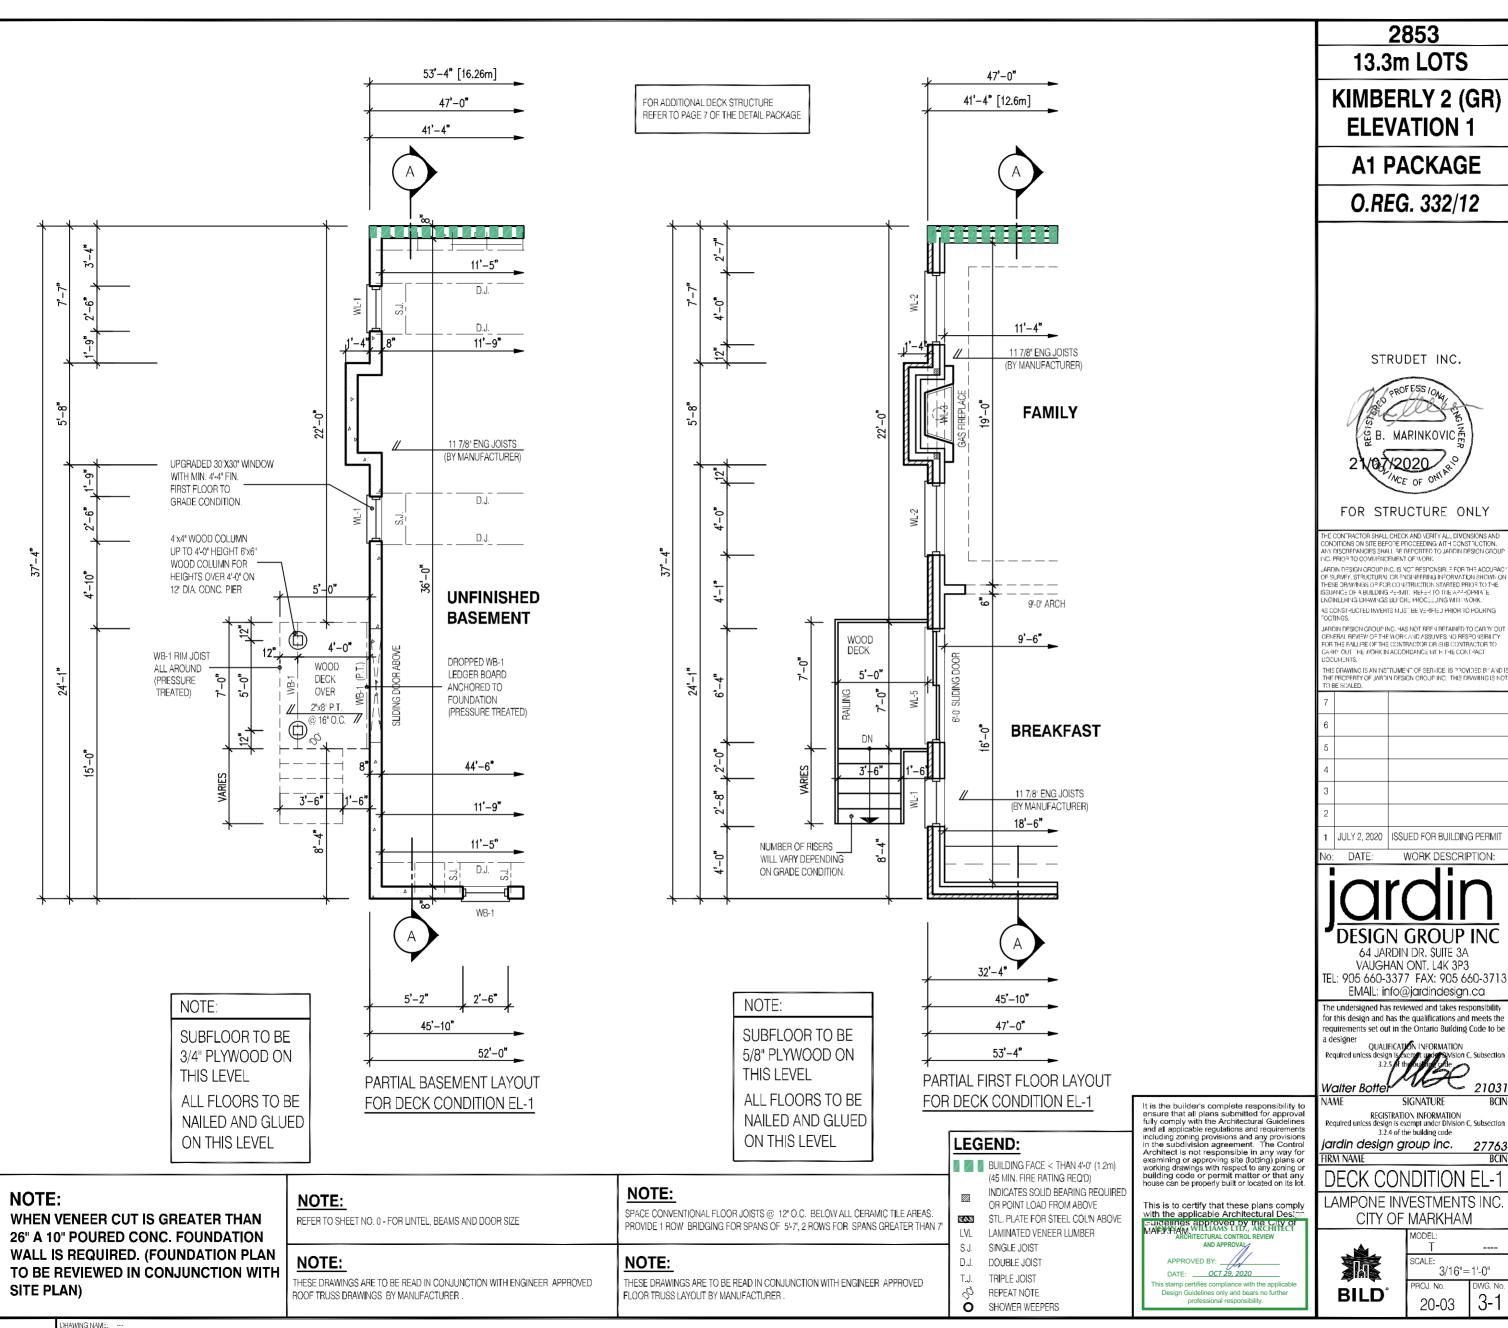


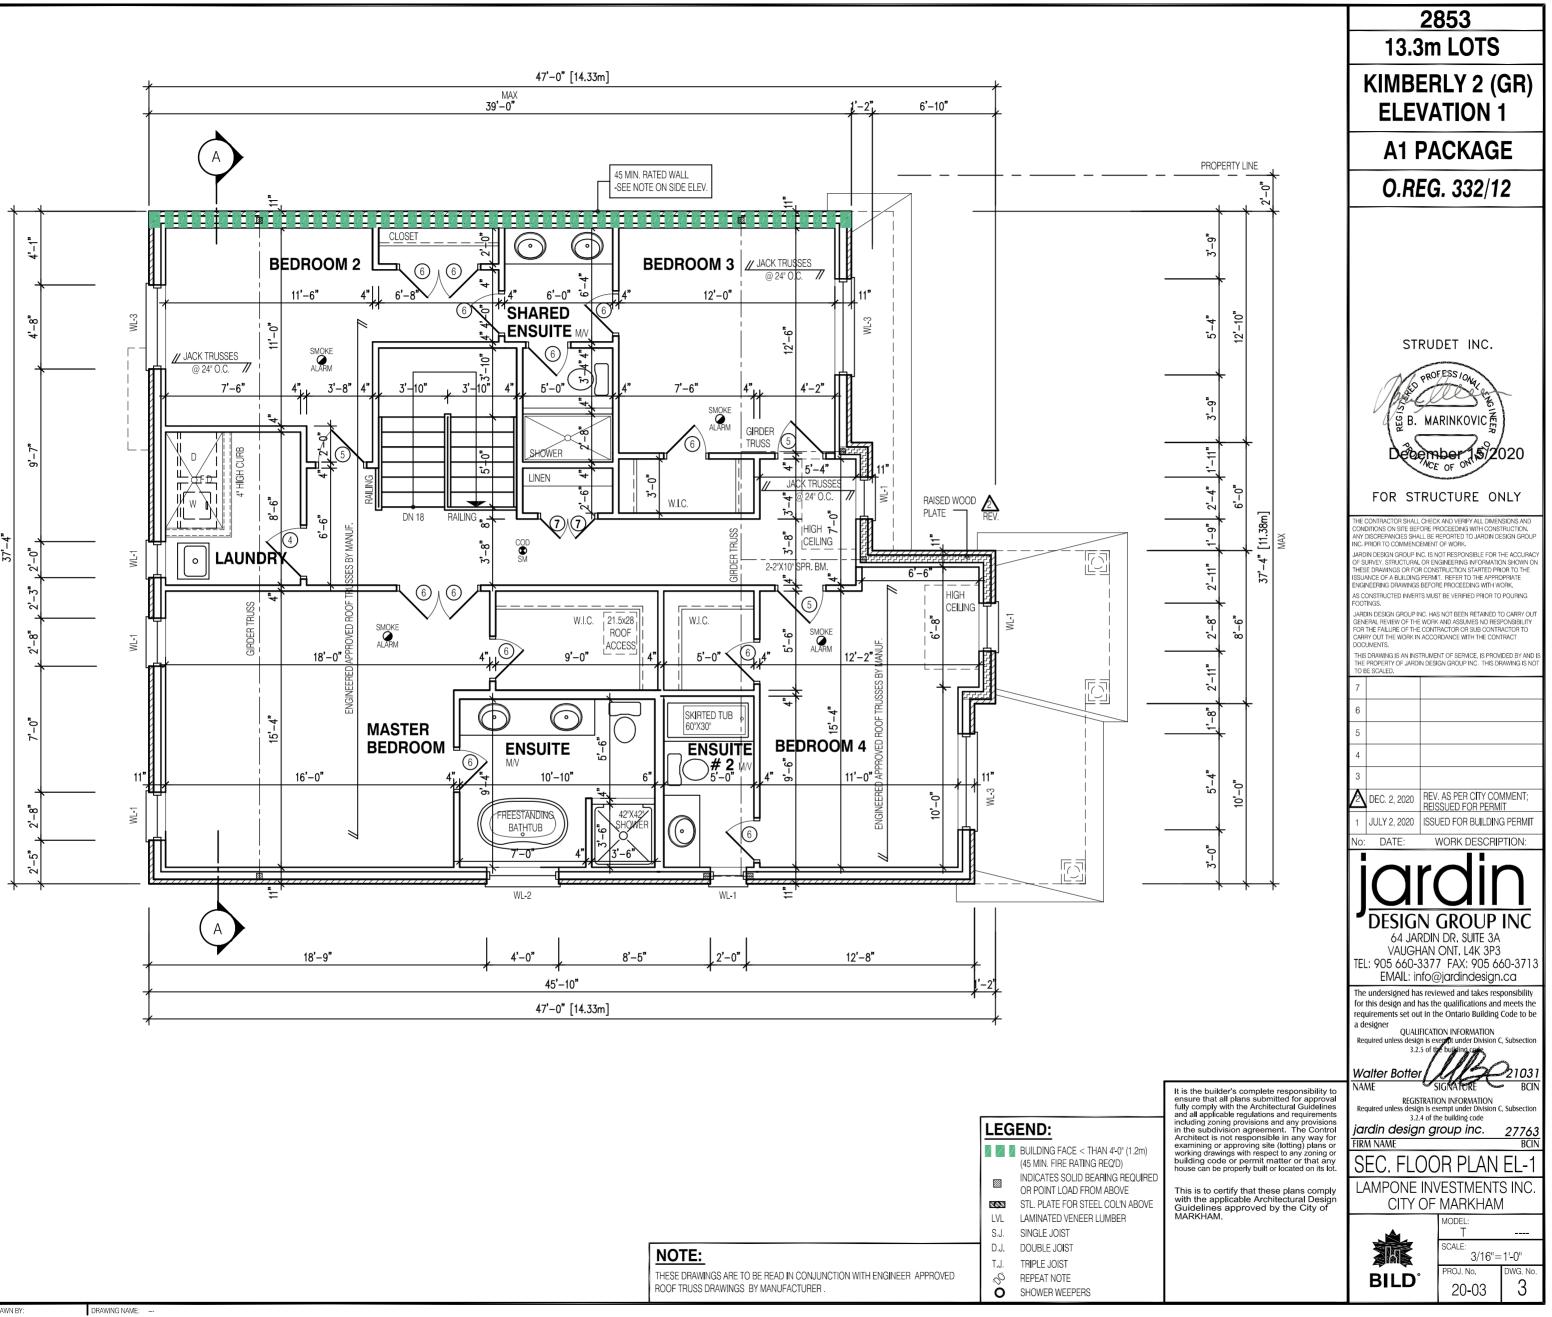

Date: 02/05/

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1	JULY 2, 2020	ISSUED FOR BUILDING PERMIT
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for this design and has the qualifications and meets the irements set out in the Ontario Building Code to b




REVIEWED FOR COMPLIANCE WITH THE ONTARIO BUILDING CODE AND THE APPLICABLE ZONING BY-LAW



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DRAWING NAME:


BUILDING STANDARDS DIVISION REVIEWED FOR COMPLIANCE WITH THE ONTARIO BUILDING

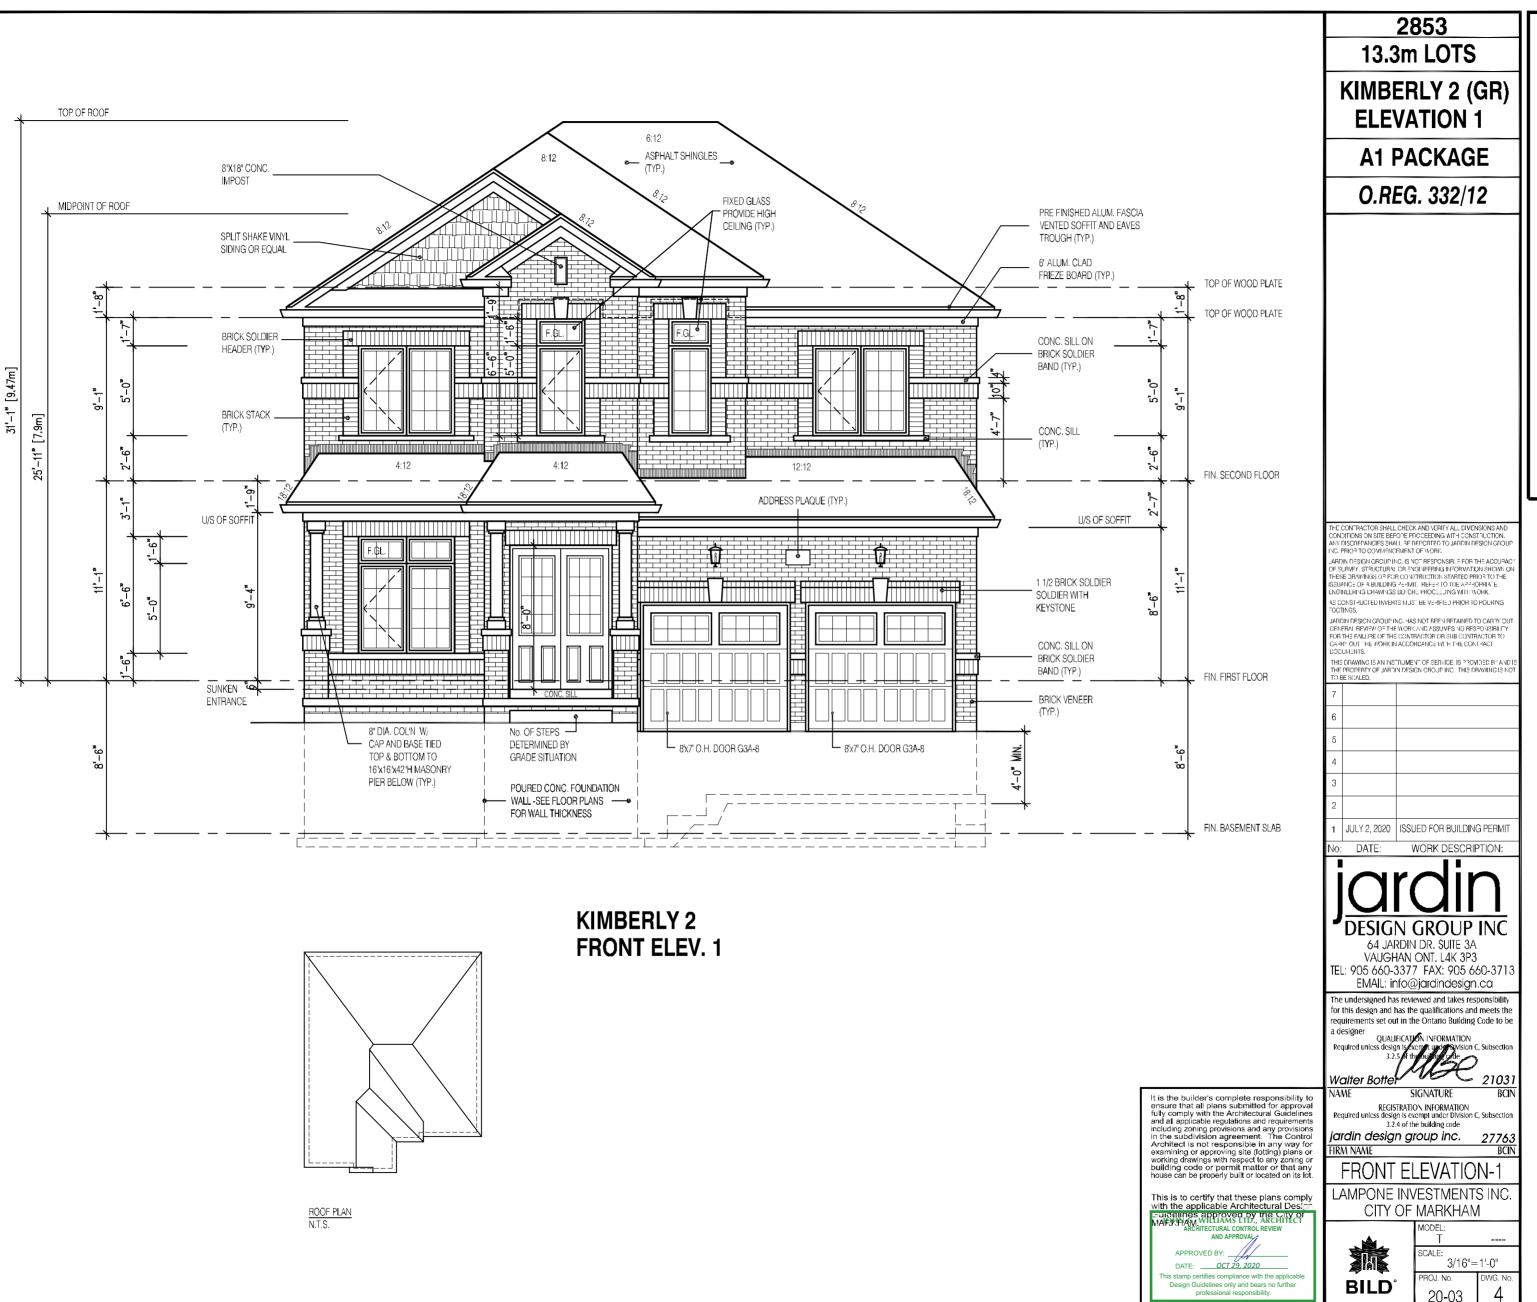CODE AND THE APPLICABLE ZONING BY-LAW 20.130062.000.00.CM


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KIMBERLY 2 FRONT ELEV. 1 (FOR LOT 66)



ROOF PLAN N.T.S.

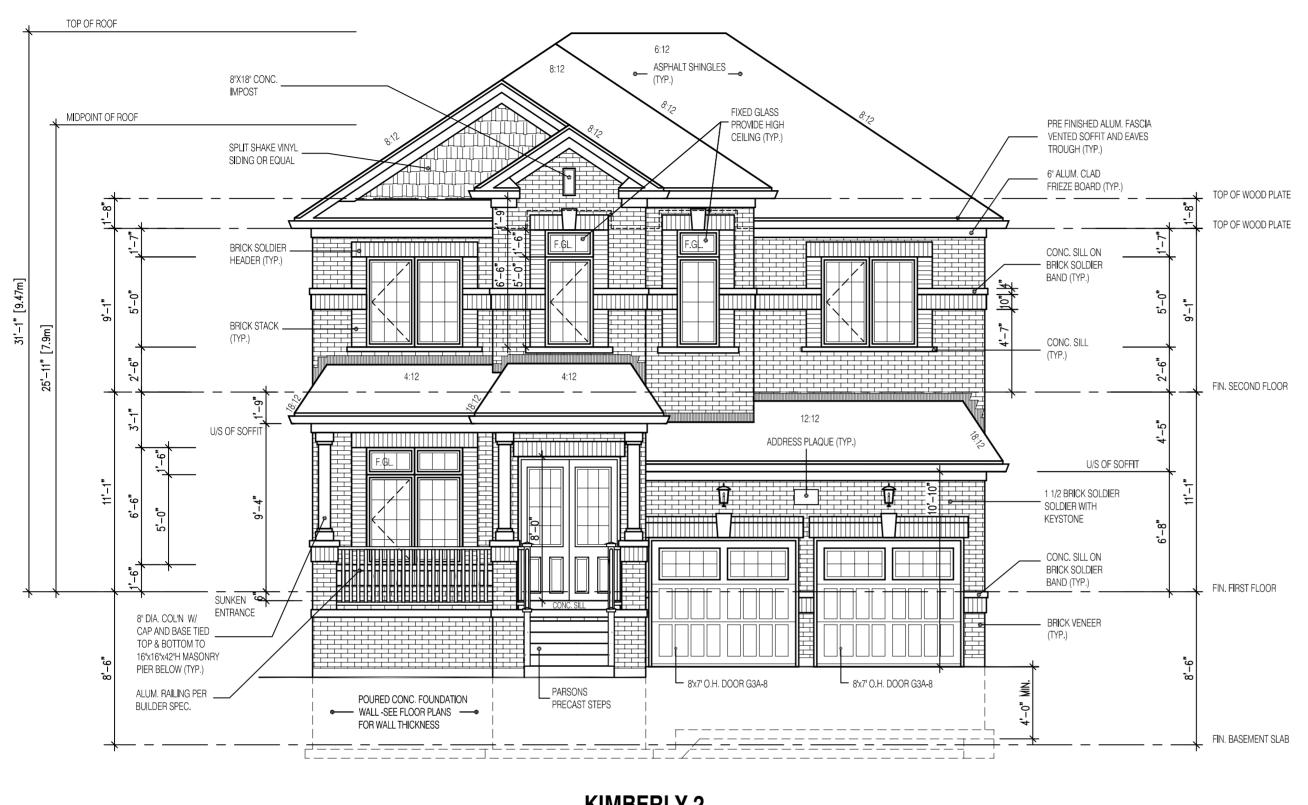KIMBERLY 2 ELEV	1 (FOR LOT 66)	ENERGY EFFI	CIENCY- A1 PACKAGE
ELEVATION	WALL FT ²	OPENING FT ²	PERCENTAGE
FRONT	928.00	138.00	14.87 %
LEFT SIDE	1043.00	52.00	4.99 %
RIGHT SIDE	1056.00	0.00	0.00 %
REAR	828.00	166.00	20.05 %
TOTAL	3855.00	356.00	9.23 %

It is the builder's complete responsibility to ensure that all plans submitted for approval fully comply with the Architectural Guidelines and all applicable regulations and requirements including zoning provisions and any provisions in the subdivision agreement. The Control Architect is not responsible in any way for examining or approving site (lotting) plans or working drawings with respect to any zoning or building code or permit matter or that any house can be properly built or located on its lot.

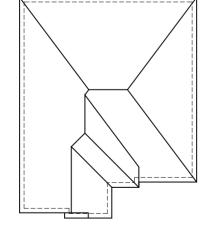This is to certify that these plans comply with the applicable Architectural Design Guidelines approved by the City of MACHITECT ACCURACY CONTROL REVIEW

APPROVED BY: _ DATE: <u>OCT 29, 2020</u>

BILD

BUILDING STANDARDS DIVISION REVIEWED FOR COMPLIANCE WITH THE ONTARIO BUILDING CODE AND THE APPLICABLE ZONING BY-LAW

2853

13.3m LOTS

KIMBERLY 2 (GR)

A1 PACKAGE

O.REG. 332/12

ELEVATION 1

THIS DRAWING IS AN INSTRUMENT OF SERVICE, IS PROVIDED BY AND THE PROPERTY OF JARDIN DESIGN GROUP INC. THIS DRAWING IS N TO BE SCALED.

7		
6		
5		
4		
3		
2	OCT 26, 2020	ADDED DRAWING TO SET; ISSUED TO CLIENT

JULY 2, 2020 ISSUED FOR BUILDING PERMIT

DESIGN GROUP INC

64 JARDIN DR. SUITE 3A VAUGHAN ONT. L4K 3P3 TEL: 905 660-3377 FAX: 905 660-3713 EMAIL: info@jardindesign.ca

The undersigned has reviewed and takes responsibility for this design and has the qualifications and meets the requirements set out in the Ontario Building Code to be a designer

QUALIFICATION_INFORMATION

3.2.5 of the buyding see

Walter Botter
NAME

SIGNATURE

BCIN REGISTRATION INFORMATION Required unless design is exempt under Division C, Subsection 3.2.4 of the building code

3.2.4 of the building code

jardin design group inc. 27763

BCIN FRONT ELEVATION-1

LAMPONE INVESTMENTS INC. CITY OF MARKHAM




3/16"=1'-0" 4-1 20-03





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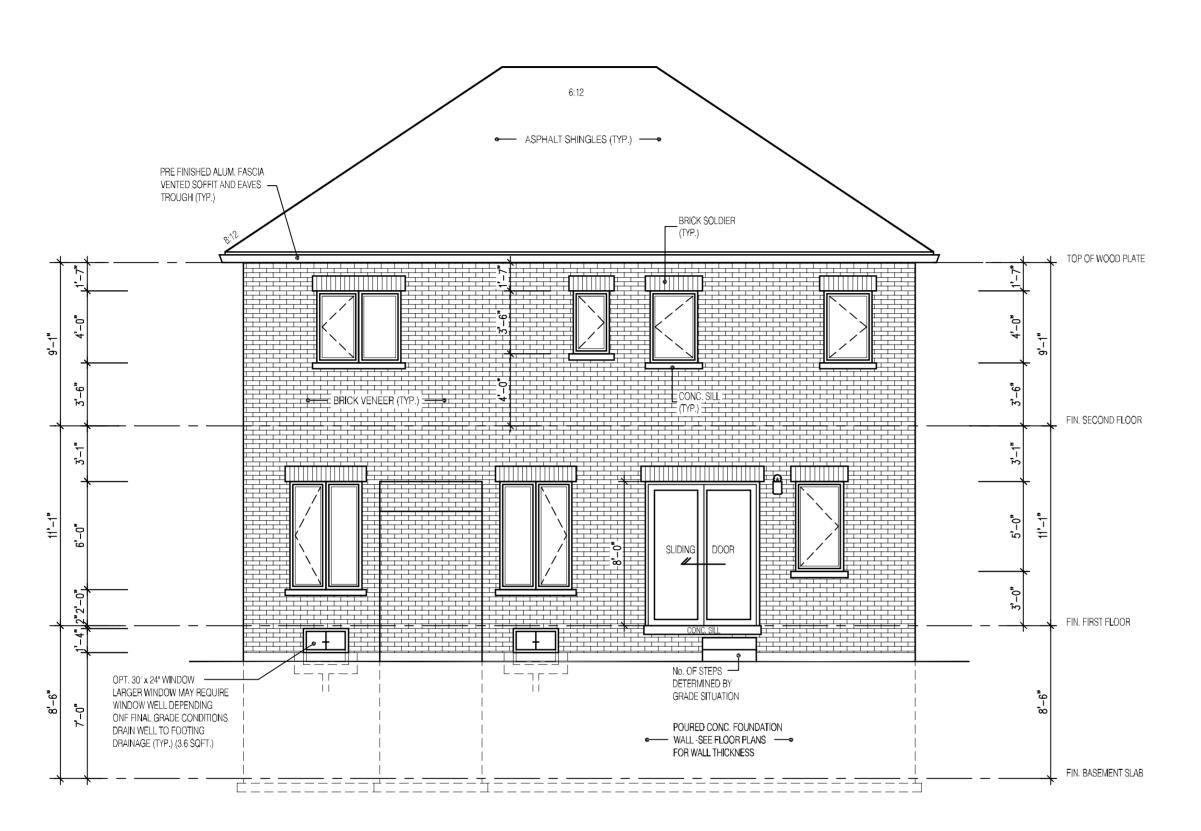
REVIEWED FOR COMPLIANCE WITH THE ONTARIO BUILDING

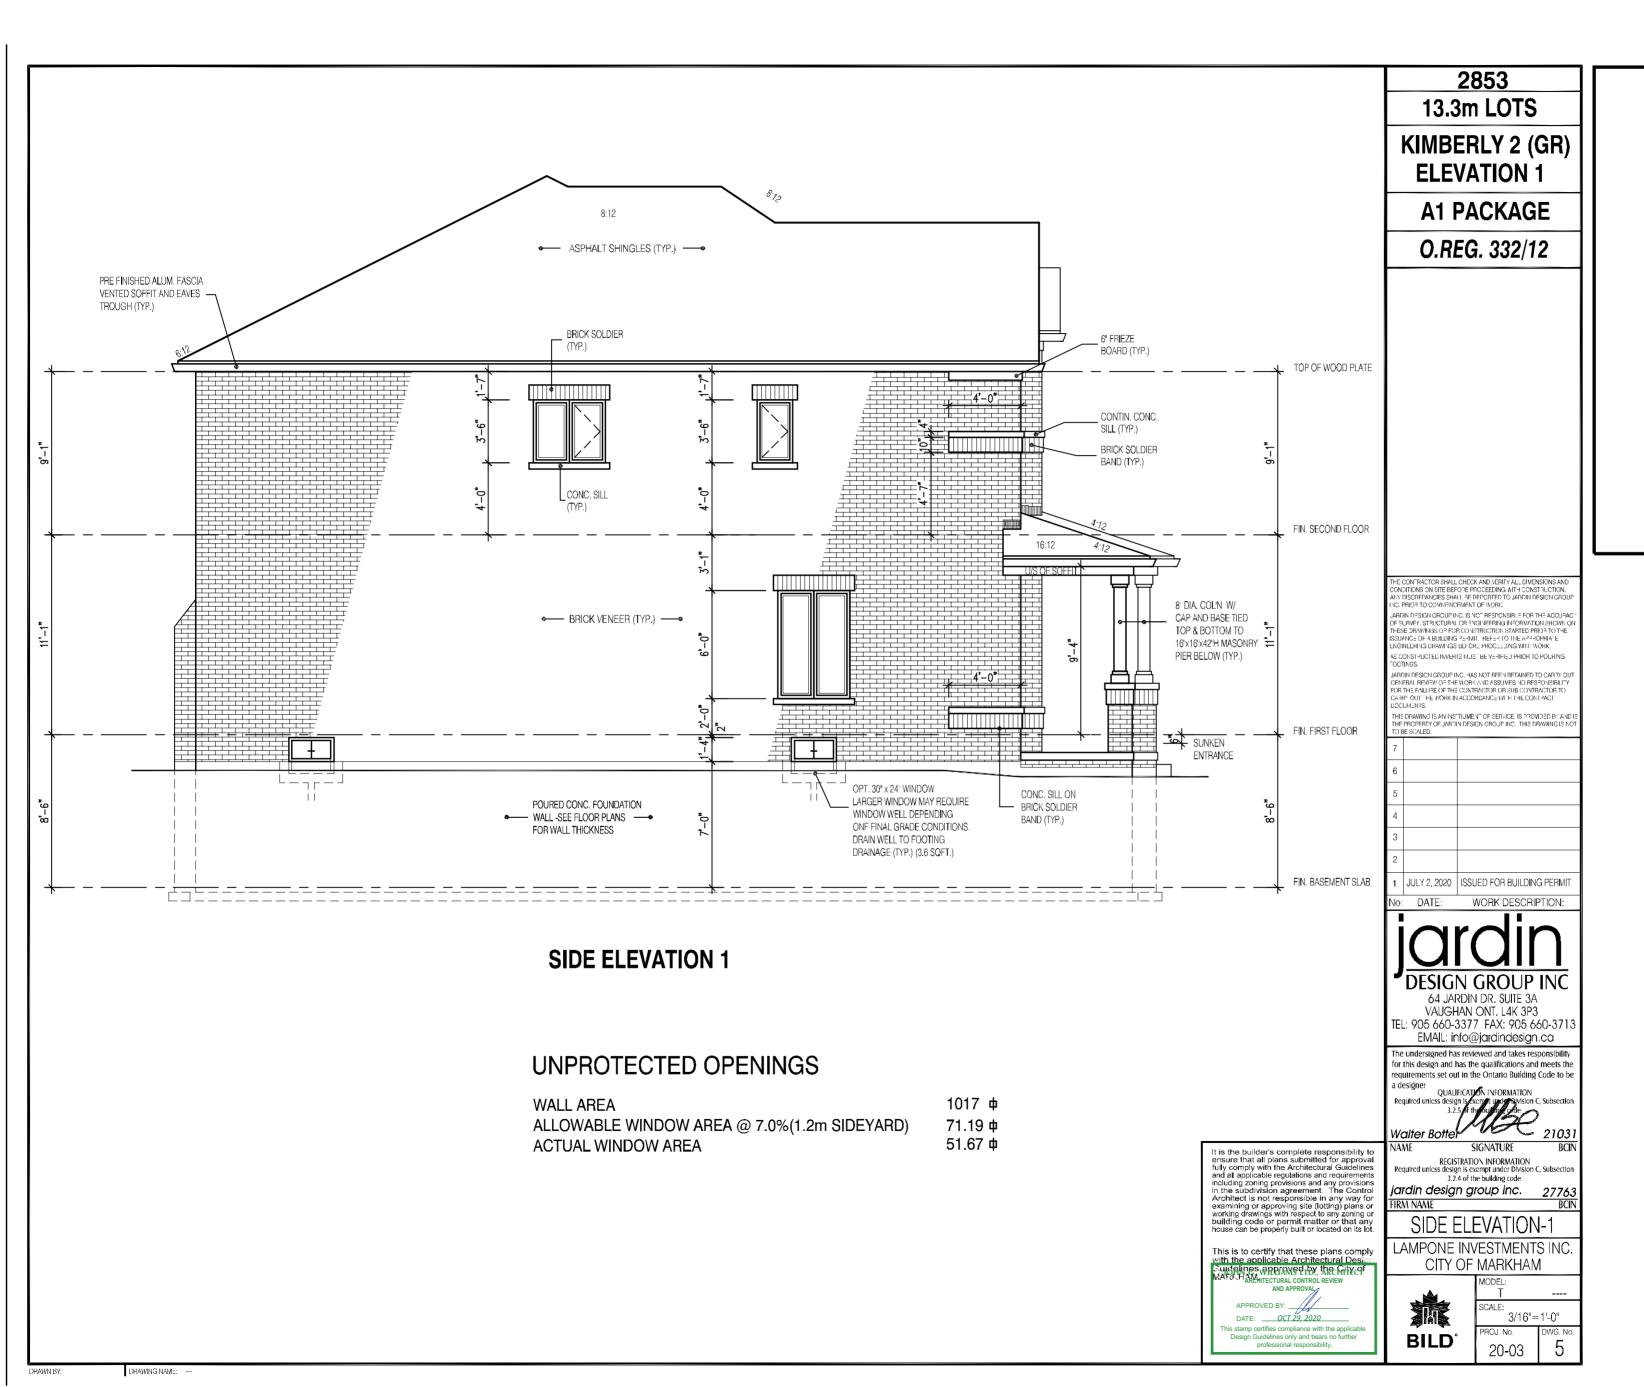


Date: 02/05/2

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REAR ELEVATION 1



O.REG. 332/12

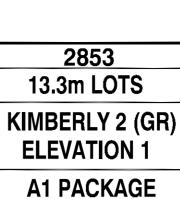

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NOTE: THE PROPOSED DEVELOPMENT IS SUBJECT TO COMPLIANCE WITH ALL APPLICABLE PROVISIONS OF THE ZONING BY-LAW AND ALL OTHER APPLICABLE LAWS INCLUDING THE PROVISIONS OF A SITE PLAN AND / OR SUBDIVISION AGREEMENT WHICH MAY OR MAY NOT BE REGISTERED ON TITLE

DATE: WORK DESCRIPTION: 64 JARDIN DR. SUITE 3A VAUGHAN ONT. L4K 3P3 TEL: 905 660-3377 FAX: 905 660-3713

JULY 2, 2020 | ISSUED FOR BUILDING PERMIT

HE CONTRACTOR SHALL CHECK AND VERIFY ALL DIVENSIONS AND ONDITIONS ON SITE BEFORE PROCEEDING MITH CONSTRUCTION. NY DISCREPANCIES SHALL SE REFORTED TO JAFICHN DESIGN GROU C. PRICE TO COMMENCEMENT OF WORK.

CONTROL OF CONTROL OF THE ACOUS F SURVEY, STEUCTURAL OR EVISINEERING INFORVATION SHOWN ESE DRAWINGS OF FOR CONSTRUCTION STATED PRIOR TO THE SURVEY OF A SULDING 2-BAIL HEEFS TO THE APPROPAILS SURVEY OF A SULDING 2-BAIL HEEFS TO THE APPROPAILS VISINEERING DRAWINGS BEFORE PROCESTING WITH MORK.

CONSTRUCTED INVERTS MUST BE VEHIFIED PRIOR TO POURING DTINGS.

THIS DRAWING IS AN INSTRUMENT OF SERVICE, IS PROVIDED BY AND THE PROPERTY OF JARDIN DESIGN CROUP INC. THIS DRAWING IS NO TO BE SCALED.

The undersigned has reviewed and takes responsibility for this design and has the qualifications and meets the quirements set out in the Ontario Building Code to be

EMAIL: info@jardindesign.ca

a designer
QUALIFICATION INFORMATION
Required unless design is execute under system C, Subsection
3.2.5 of the building under
Walter Botter 21031 SIGNATURE

REGISTRATION INFORMATION ss design is exempt under Division C, Subsection 3.2.4 of the building code

jardin design group inc. IRM NAME


REAR ELEVATION-1 LAMPONE INVESTMENTS INC. CITY OF MARKHAM



3/16"=1'-0" 6 20-03

It is the builder's complete responsibility to ensure that all plans submitted for approval fully comply with the Architectural Guidelines and all applicable regulations and requirements including zoning provisions and any provisions in the subdivision agreement. The Control Architect is not responsible in any way for examining or approving site (lotting) plans or working drawings with respect to any zoning or building code or permit matter or that any house can be properly built or located on its lot. This is to certify that these plans comply with the applicable Architectural Design Sungaines Supproved by the Crity of MARK HARVITECTURAL CONTROL REVIEW

APPROVED BY: DATE: <u>OCT 29, 2020</u> is stamp certifies compliance with the applica Design Guidelines only and bears no further professional responsibility.

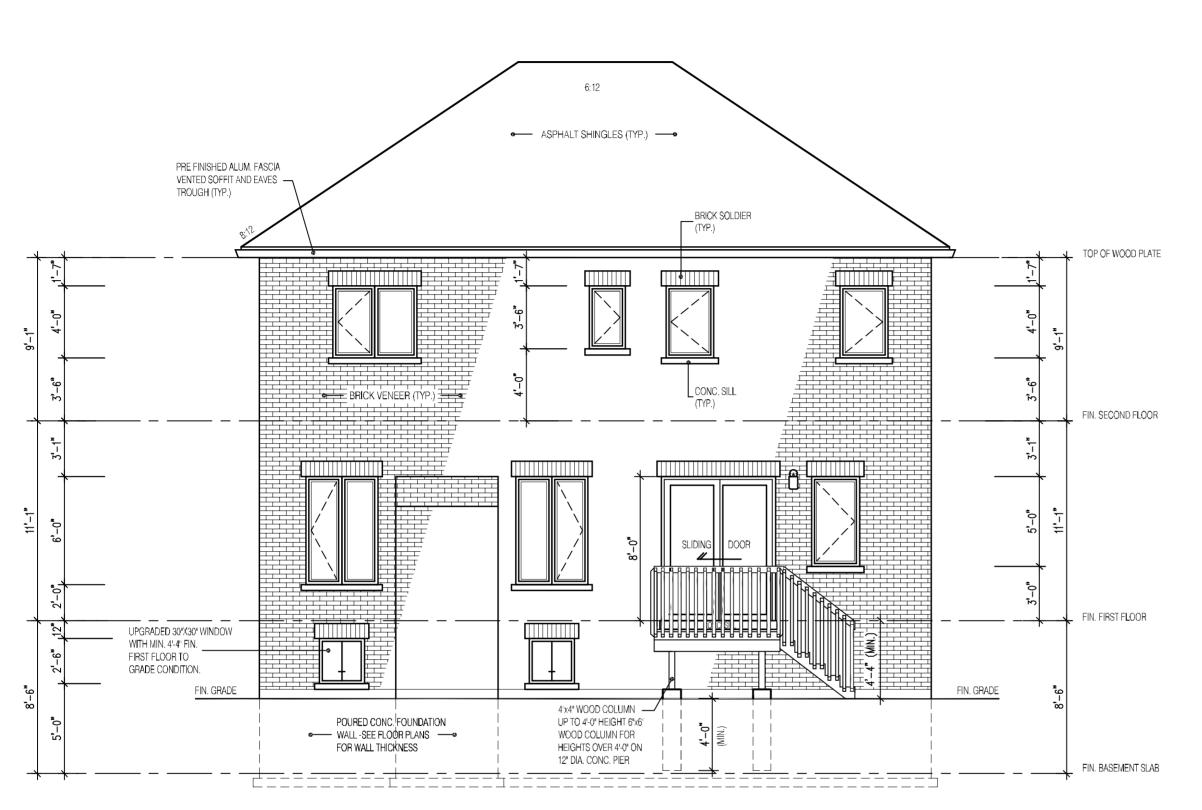

REAR ELEVATION 1 DECK CONDITION

FOR ADDITIONAL DECK STRUCTURE REFER TO PAGE 7 OF THE DETAIL PACKAGE

NOTE:

WHEN VENEER CUT IS GREATER THAN 26" A 10" POURED CONC. FOUNDATION WALL IS REQUIRED.

(FOUNDATION PLAN TO BE REVIEWED IN CONJUNCTION WITH SITE PLAN)

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2853 13.3m LOTS

KIMBERLY 2 (GR) ELEVATION 1

A1 PACKAGE

O.REG. 332/12

THE ONTARIO BUILDING CODE NO PERSON SHALL CONSTRUCT OR DEMOLISH A BUILDING OR CAUSE A BUILDING TO BE CONSTRUCTED EXCEPT IN ACCORDANCE WITH THESE CERTIFIED BUILDING PERMIT DOCUMENTS, THE BUILDING CODE ACT AND THE BUILDING CODE.

ALL CONSTRUCTION SHALL COMPLY WITH

BUILDING STANDARDS DIVISION REVIEWED FOR COMPLIANCE WITH THE ONTARIO BUILDING

CODE AND THE APPLICABLE ZONING BY-LAW

20.130062.000.00.CM

NOTE: THE PROPOSED DEVELOPMENT IS SUBJECT TO COMPLIANCE WITH ALL APPLICABLE PROVISIONS OF THE ZONING BY-LAW AND ALL OTHER APPLICABLE LAWS INCLUDING THE PROVISIONS OF A SITE PLAN AND / OR SUBDIVISION AGREEMENT WHICH MAY OR MAY NOT BE REGISTERED ON TITLE

CONSTRUCTED INVERTS MUST BE VERIFIED PHIOR TO POURING TINGS.

7		
6		
5		
4		
3		
2		
1	JULY 2, 2020	ISSUED FOR BUILDING PERMI

WORK DESCRIPTION:

64 JARDIN DR. SUITE 3A VAUGHAN ONT. L4K 3P3 TEL: 905 660-3377 FAX: 905 660-371 EMAIL: info@jardindesign.ca

he undersigned has reviewed and takes responsibility for this design and has the qualifications and meets the QUALIFICATION INFORMATION

Required unless design is several under symstom c, subsection 3.2.5 if the supply of the Walter Bottel 21031 SIGNATURE

REGISTRATION INFORMATION ss design is exempt under Division C, Subsection 3.2.4 of the building code

jardin design group inc. IRM NAME


DECK CONDITION EL-1 LAMPONE INVESTMENTS INC.

CITY OF MARKHAM



3/16"=1'-0" 20-03

DRAWING NAME:

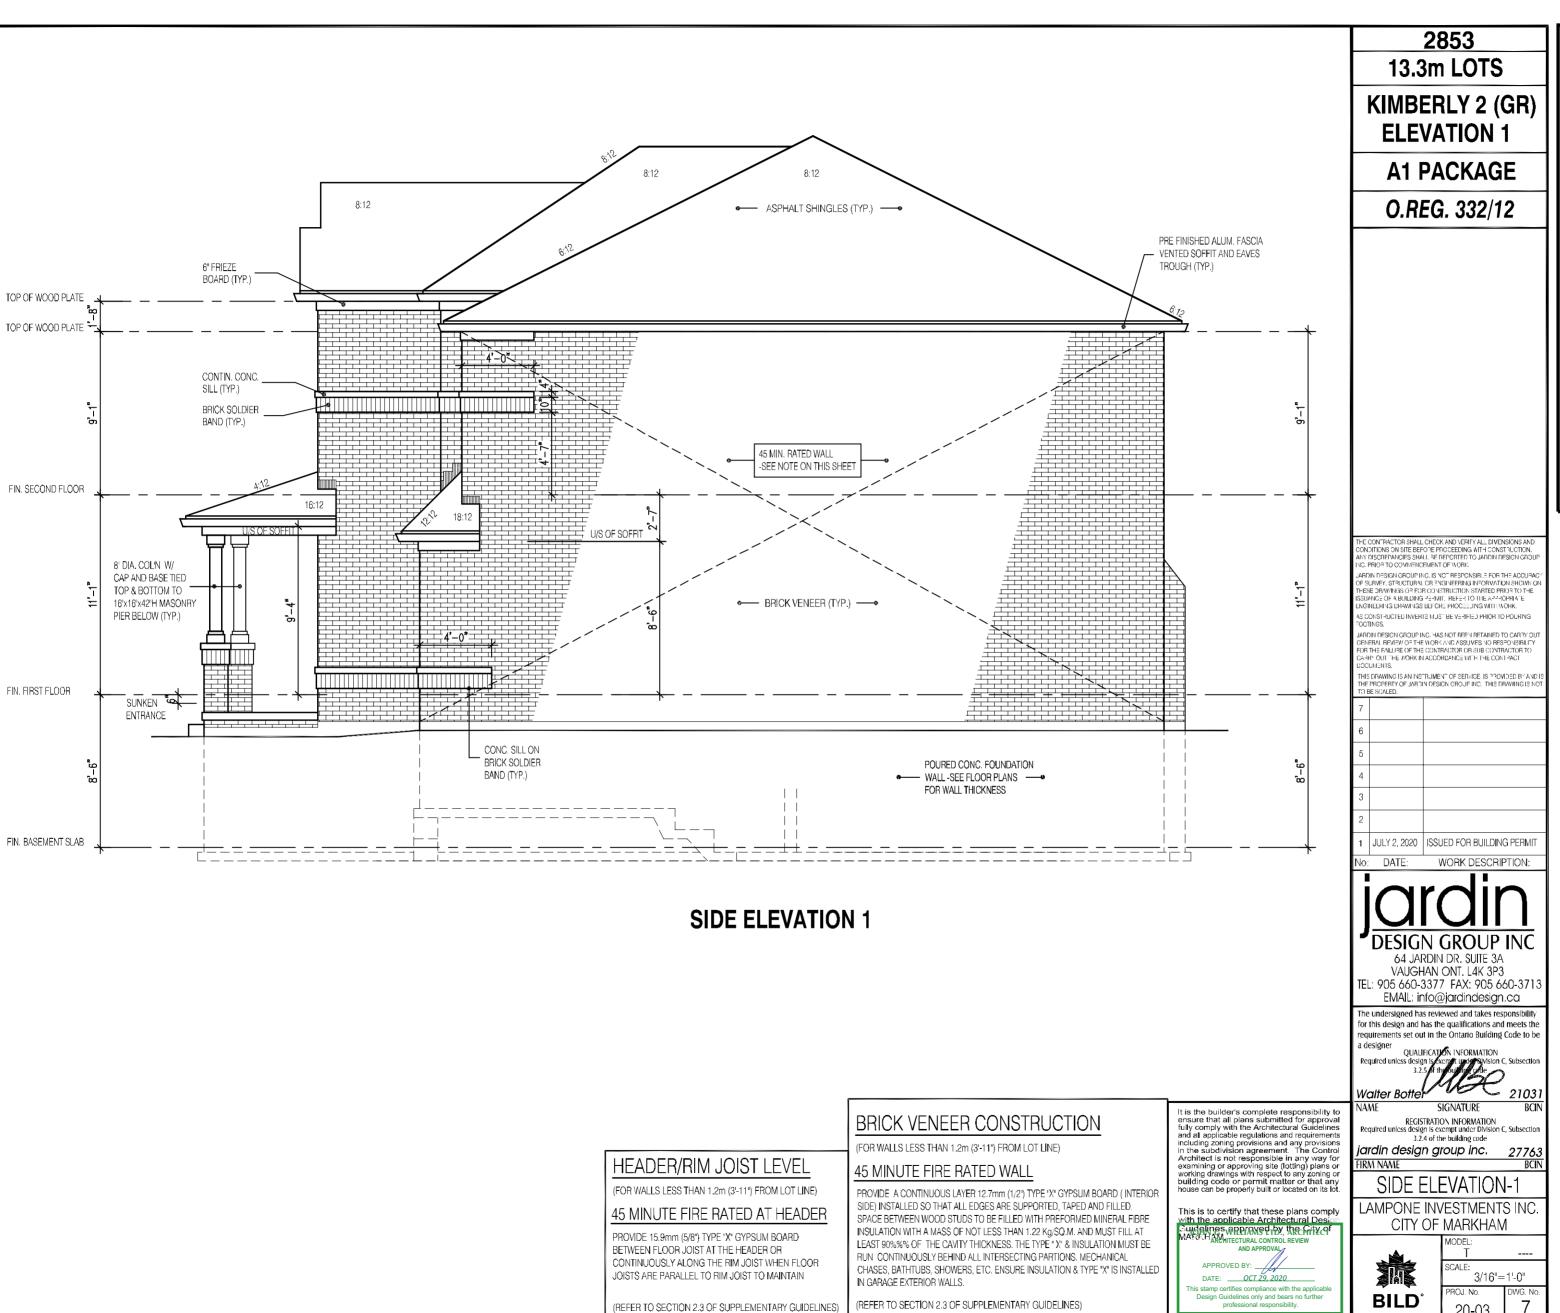

DRAWING NAME:

BUILDING STANDARDS DIVISION

REVIEWED FOR COMPLIANCE WITH THE ONTARIO BUILDING

CODE AND THE APPLICABLE ZONING BY-LAW 20.130062.000.00.CM


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20-03



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This is to certify that these plans comply with the applicable Architectural Design Guidelines approved by the City of MARKHAM.

2853 13.3m LOTS

KIMBERLY 2 (GR) ELEVATION 1

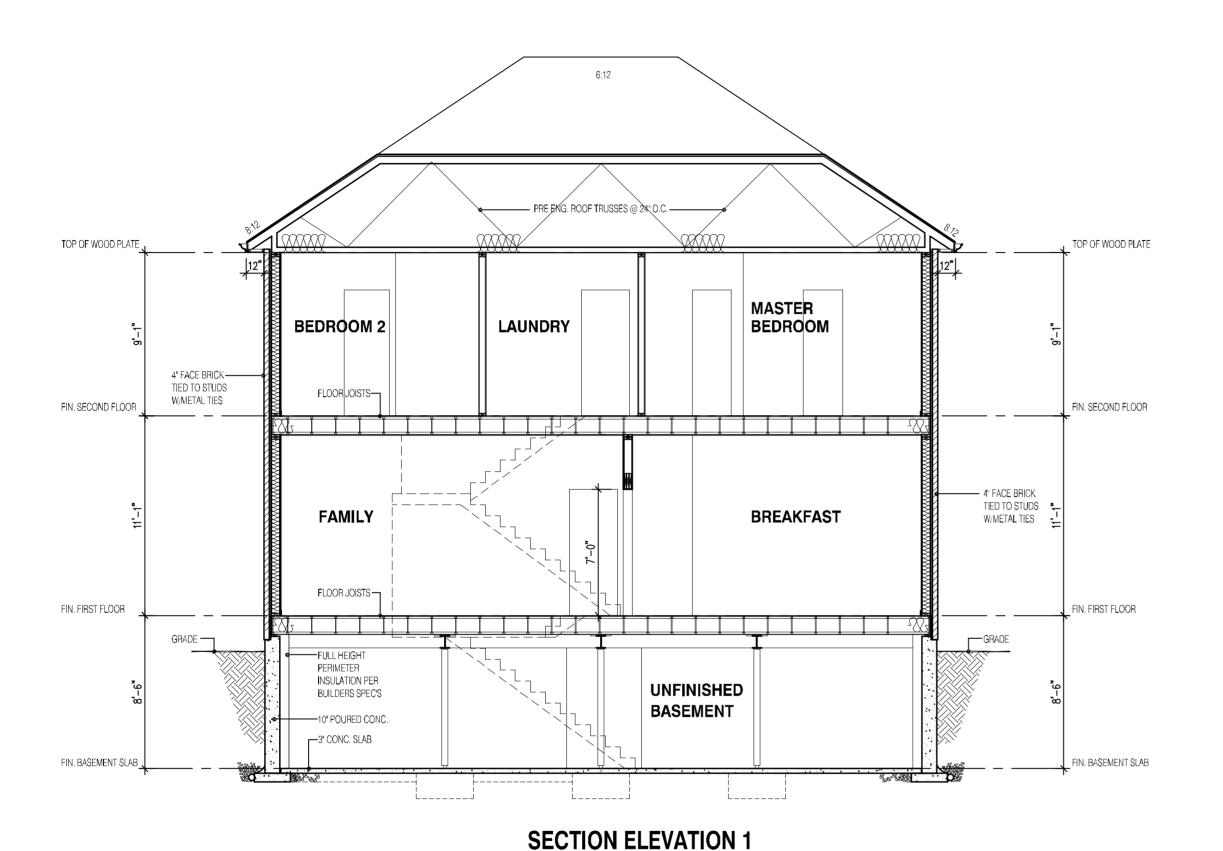A1 PACKAGE

O.REG. 332/12

STRUDET INC.



FOR STRUCTURE ONLY

CONSTRUCTED INVENTS MUST BE VERIFIED PRIOR TO POURING TINGS.

7		
6		
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4		
3		
2		
1	JULY 2, 2020	ISSUED FOR BUILDING PERMIT

WORK DESCRIPTION:



64 JARDIN DR. SUITE 3A VAUGHAN ONT. L4K 3P3 TEL: 905 660-3377 FAX: 905 660-3713 EMAIL: info@jardindesign.ca

The undersigned has reviewed and takes responsibility for this design and has the qualifications and meets the uirements set out in the Ontario Building Code to be

QUALIFICATION INFORMATION Required unless design is several under Sylvation C, Subsection 3.2.5 if the supply of the Walter Bottlet 21031

SIGNATURE

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jardin design group inc. IRM NAME

SECTION ELEV.-1 LAMPONE INVESTMENTS INC. CITY OF MARKHAM



3/16"=1'-0" 8 20-03



REVIEWED FOR COMPLIANCE WITH THE ONTARIO BUILDING

CODE AND THE APPLICABLE ZONING BY-LAW 20.130062.000.00.CM

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