STRIP FOOTINGS FOR SINGLES AND SEMIS UP TO 2 STOREY

201Y61 CONCRETE STRIP FOOTINGS BELOW FOUNDATION WALLS. 24"x8" CONCRETE STRIP FOOTINGS BELOW PARTY WALLS.

100 KPa NATIVE SOIL

22"x8" CONCRETE STRIP FOOTINGS BELOW FOUNDATION WALLS. 28'x10' CONCRETE STRIP FOOTINGS BELOW PARTY WALLS

28'x8" CONCRETE STRIP FOOTINGS WITH REINFORCING BELOW PARTY WALLS

90 KPa ENGINEERED FILL SOIL

CING BELOW FOUNDATION WALLS 24"x8" CONCRETE STRIP FOOTINGS 30"x8" CONCRETE STRIP FOOTINGS WITH REINFORCING BELOW PARTY WALLS.

GENERAL NOTE:

ASSUMED 120/100 KPa NATIVE SOIL BEARING CAPACITY OR 90 KPa FOR ENGINEERED FILL, TO BE VERIFIED ON SITE. REFER TO ENGINEERED FILL FOOTING DETAIL FOR REINFORCEMENT

(REFER TO ENG. FILL FOOTING DETAIL)

AREA CALCULATIONS EL-1

=	1200 04
=	1614 Sq. Ft
=	2900 Sq. Ft
=	8 Sq. Ft
=	0 Sq. Ft
=	2908 Sq. Ft
=	1286 Sq. Ft
=	390 Sq. Ft
=	44 Sq. Ft
=	1720 Sq. Ft
=	159.8 S q. m.
	= = = = = =

1676 Sq. Ft.

= 155.7 Sa. m.

COVERAGE W/O PORCH

AREA CALCULATIONS EL-2 FIRST FLOOR AREA 1286 Sq. Ft. SECOND FLOOR AREA = 1614 Sq. F = 2900 Sq. F TOTAL FLOOR AREA

1676 Sq. Ft

155.7 Sq. m

WALL FT²

867.00

1096.00

1096.00

828.00

3887.00

WALL FT2

874.00

1100.00

1104.00

828.00

3906.00

WALL FT2

866 00

1100.00

1104.00

828.00

3898.00

ADD OPEN AREAS ADD FIN. BASEMENT AREA = 0 Sq. F GROSS FLOOR AREA = 2908 sq. Ft. GROUND FLOOR COVERAGE = 1286 Sq. Ft GARAGE COVERAGE / AREA = 390 Sq. Ft PORCH COVERAGE / AREA = 44 Sq. Ft. 1720 Sq. Ft. 159.8 Sq. m.

KIMBERLY 4 ELEV.-1

KIMBERLY 4 ELEV.-2

KIMBERLY 4 ELEV.-3

COVERAGE W/O PORCH

LEVATION

F" SIDE

GHT SIDE

TOTAL

FVATION

F SIDE

GHT SIDE

OTAL

LEVATION

F SIDE

GHT SIDE

AREA CALCULATIONS EL-3 FIRST FLOOR AREA

SECOND FLOOR AREA	=	1629	Sq. Ft.
TOTAL FLOOR AREA	=	2915	Sq. Ft.
ADD OPEN AREAS ADD FIN. BASEMENT AR	= FΔ =		Sq. Ft. Sq. Ft.
ADD FIN. DAGEMENT AN	LA -	- 0	δų. Γι.
GROSS FLOOR AREA	= Α	2923	Sq. Ft.
GROUND FLOOR COVER	RAGE =	1286	Sq. Ft.
GARAGE COVERAGE / A	REA =	390	Sq. Ft.
GARAGE COVERAGE / A PORCH COVERAGE / AR			Sq. Ft. Sq. Ft.
		50	
PORCH COVERAGE / AR		50 1 72 6	Sq. Ft.

ENERGY EFFICIENCY- A1 PACKAGE

ENERGY EFFICIENCY- A1 PACKAGE

ENERGY EFFICIENCY- A1 PACKAGE

OPENING FT²

147.00

60.00

0.00

147.00

354.00

OPENING FT²

60.00

0.00

147.00

359.00

OPENING FT²

150.00

60.00

0.00

147.00

357.00

155.7 Sa. m

PERCENTAGE

16.96 %

5.47 %

0.00 %

17.75 %

9.11 %

PERCENTAGE

5.45 %

0.00 %

17 75 %

9.19 %

PERCENTAGE

17.32 %

5.45 %

0.00 %

17.75 %

9.16 %

2908 13.3m LOTS

KIMBERLY 4 (GR) **ELEVATION 1,2 & 3**

A1 PACKAGE

O.REG. 332/12

STRUDET INC.

PAD FOOTING

120 KPa NATIVE SOIL

F1 = 48*x48"x20" CONCRETE PAD =1 = 42"x42"x18" CONCRETE PAD =2 = 36"x36"x16" CONCRETE PAD F3 = 30"x30"x12" CONCRETE PAD

F2 = 40"x40"x16" CONCRETE PAD F3 = 34"x34"x14" CONCRETE PADF4 = 24"x24"x12" CONCRETE PAD F5 = 16"x16"x8" CONCRETE PAD

 $F4 = 26 \times 28 \times 12$ " CONCRETE PAD 55 = 18"x18"x8" CONCRETE PAR

(REFER TO FLOOR PLAN FOR UNUSUAL SIZE PADS NOT ON CHART)

98 KPa ENGINEERED FILL SOIL 100 KPa NATIVE SOIL

 $F1 = 46' \times 16' \times 20'$ CONCRETE PAD F2 = 38"x38"x18" CONCRETE PAD F3 = 32"x32"x14" CONCRETE PAD F4 = 26"x26"x12" CONCRESE PAD 5 = 17"x17"x8" CONCRETE PAD

NOTE:

WHEN VENEER CUT IS GREATER THAN 26" A 10" POURED CONC. FOUNDATION WALL IS REQUIRED.

NOTE:

ALL GARAGE SLABS, PORCH SLABS, STAIRS (EXPOSED CONC. FLAT WORK) TO BE 32 MPa WITH 5-8% AIR ENTRAITMENT

BRICK VENEER LINTELS:

WI 1 = $3.1 \cdot 2'' \times 3.1 \cdot 2'' \times 1 \cdot 4'' \cdot (90 \times 90 \times 6) - 2 \cdot 2'' \times 8'' \text{ SPB}$ $WI.6 = 5^{\circ} \times 3.1 \times 2^{\circ} \times 5 \times 16^{\circ} (125 \times 90 \times 8) - 2 \cdot 2^{\circ} \times 12^{\circ} SPR$ WL2 = $4'' \times 3 \times 2'' \times 5 \times 16'' \times 100 \times 90 \times 8) + 2 - 2'' \times 8'' \text{ SPR}$. WL7 = 5° x 3 1\2" x 5\16" (125x90x8) + 3-2" x 10" SPR. $WL3 = 5" \times 3 \ 1 \times 2" \times 5 \times 16" \ (125 \times 90 \times 8) + 2 - 2" \times 10" \ SPR.$ WL8 = 5° x 3 1\2" x 5\16" (125x90x8) + 3-2" x12" SPR. $WL4 = 6'' \times 3 \times 1/2'' \times 3/8'' (150x90x10) + 2-2'' \times 12'' SPR.$ $WL9 = 6" \times 4" \times 3 \times 8" (150 \times 100 \times 10) + 3 - 2" \times 12" SPR.$ $WL5 = 6" \times 4" \times 3 \times (150 \times 100 \times 10) + 2 - 2" \times 12" SPR.$

WOOD LINTELS:

WB1 = 2-2" x 8" SPRUCE BEAM WB6 = 3-2" x 12" SPRUCE BEAM WB2 = 3-2" x 8" SPRUCE BEAM WB7 = 5-2" x 12" SPRUCE BEAM WB10 = 4-2" x 8" SPRUCE BEAM WB3 = 2-2" x 10" SPRUCE BEAM WB4 = 3-2" x 10" SPRUCE BEAM WB11 = 4-2" x 10" SPRUCE BEAM WB5 = 2-2" x 12" SPRUCE BEAM

STEEL LINTELS:

 $L1 = 3 \frac{1}{2} \times 3 \frac{1}{2} \times \frac{1}{4} (90 \times 90 \times 6)$ $L4 = 6'' \times 3 \frac{1}{2} \times 3 \frac{1}{2} \times 3 \frac{1}{2} \times 3 \times 90 \times 10$ $L2 = 4" \times 3 \times 12" \times 5 \times 16" \times (100 \times 90 \times 8)$ $L5 = 6" \times 4" \times 3 \times 8" \times (150 \times 100 \times 10)$ $L3 = 5" \times 3 \text{ 1/2"} \times 5 \text{ 16"} (125 \times 90 \times 8)$ $L6 = 7" \times 4" \times 3 \text{ 8"} (180 \times 100 \times 10)$

LAMINATED VENEER LUMBER (LVL BEAMS)

= 2-1 3/4" x 7 1/4" (2-45x184) = 3-1 3/4" x 7 1/4" (3-45x184) $LVL3 = 4-13/4" \times 71/4" (4-45x184)$ LVL4A = 1-1 3/4" x 9 1/2" (1-45x240) LVL4 = 2-1 3/4" x 9 1/2" (2-45x240) $LVL5 = 3-1.3/4" \times 9.1/2" (3-45x240)$ LVL5A = 4-1 3/4" x 9 1/2" (4-45x240) LVL6A= 1-1 3/4" x 11 7/8" (1-45x300) LVL6 = 2-1 3/4" x 11 7/8" (2-45x300) 3-1 3/4" x 11 7/8" (3-45x300

LVL7A= 4-1 3/4" x 11 7/8" (4-45x300)

3-1 3/4" x 14" (3-45x356)

LVL8 = 2-1 3/4" x 14" (2-45x356)

LVL1A = 1-1 3/4" x 7 1/4" (1-45x184)

2-2'x6" STUD WALL NAILED TOGETHER AND SPACED @12" O.C. FULL HT C/W SOLID BLOCKING 4'-0" O.C. VERTICAL AND 7/16"


Certified Model reviewed and approved based on

Where site conditions differ, a lot-specific revision

footing design for 120 kPa native soil.

approved prior to pouring of footings.

application is required to be submitted and

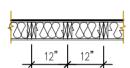


EXT. PLYWOOD SHEATHING.

MAXIMUM HEIGHT OF WALL FOR THIS DETAIL IS 18'-0" AND MAXIMUM SUPPORTED LENGTH OF TRUSS IS 40'-0"

TWO STOREY HEIGHT WALL DETAIL

2 - 1 1/2" x 5 1/2" TIMBERSTRAND (LSL) 1.5E STUD WALL GLUED AND NAILED TOGETHER AND SPACED MAX. @10"O.C. FULL HT C/W SOLID BLOCKING MAX. 8'-0"O.C. VERTICAL AND 7/16" EXT. OSB SHEATHING.

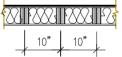

MAXIMUM HEIGHT OF WALL FOR THIS DETAIL IS 20'-2" AND MAXIMUM SUPPORTED LENGTH OF TRUSS IS 40'-0"

TWO STOREY HEIGHT WALL DETAIL

NOTE:

THESE DRAWINGS ARE TO BE READ IN CONJUNCTION WITH ENGINEER APPROVED ROOF TRUSS DRAWINGS BY MANUFACTURER

Door Schedule

NO.	WIDTH	HEI0 8' TC CEII		HEIGH ⁻ 10' OR CEILIN	MORE	TYPE
1	2'-10"	6'-8"	(865x2033)	8'-0"	(865x2439)	INSULATED ENTRANCE DOOR
1a	2'-8'	6'-8"	(815x2033)	8'-0"	(815x2439)	INSULATED FRONT DOORS
2	2'-8"	6'-8"	(815x2033)	8'-0"	(815x2439)	WOOD & GLASS DOOR
3	2'-8'	6'-8 x 1-3/4"	(815x2033x45)	8'-0" x 1-3/4"	(815x2439x45)	EXTERIOR SLAB DOOR
4	2'-8'	6'-8" x 1-3/8"	(815x2033x35)	8'-0" x 1-3/8"	(815x2439x35)	INTERIOR SLAB DOOR
5	2'-6'	6'-8" x 1-3/8"	(760x2033x35)	8'-0" x 1-3/8"	(760x2439x35)	INTERIOR SLAB DOOR
6	2'-2"	6'-8" x 1-3/8"	(660x2033x35)	8'-0" x 1-3/8"	(660x2439x35)	INTERIOR SLAB DOOR
7	1'-6"	6'-8" x 1-3/8"	(460x2033x35)	8'-0" x 1-3/8"	(460x2439x35)	INTERIOR SLAB DOOR
8	3'-0"	6'-8" x 1-3/8"	(915x2033x35)	8'-0" x 1-3/8"	(915x2439x35)	INTERIOR SLAB DOOR

SPACE CONVENTIONAL FLOOR JOISTS @: 12" O.C. BELOW ALL CERAMIC TILE AREAS. PROVIDE 1 ROW BRIDGING FOR SPANS OF 5'-7', 2 ROWS FOR SPANS GREATER THAN I

THESE DRAWINGS ARE TO BE READ IN CONJUNCTION WITH ENGINEER APPROVED LOOR TRUSS LAYOUT BY MANUFACTURER

NOTE:

PLANS NOT DRAWN TO ACTUAL GRADE. REFER TO FINAL GRADING PLAN

It is the builder's complete responsibility to ensure that all plans submitted for approval fully comply with the Architectural Guidelines and all applicable regulations and requirements including zoning provisions and any provisions in the subdivision agreement. The Control Architect is not responsible in any way for examining or approving site (lotting) plans or working drawings with respect to any zoning or building code or permit matter or that any house can be properly built or located on its lot.

This is to certify that these plans comply with the applicable Architectural Design Guidelines approved by the City of MARKHAM.

B. MARINKOVICE 21\07\2020 NCE OF ON

FOR STRUCTURE ONLY

E CONTRACTOR SHALL CHECK AND VERIFY ALL DIVENSIONS AND NOTIONS ON STE BEFORE PROCEEDING MITH CONSTRUCTION. V DISCHERANCES SHALL SE REPORTED TO JARDIN DESIGN GRO PRIOR TO COMMENCEMENT OF WORK.

ARIN DISCONDENDENEN OF WEST STATES FOR THE ACQUIRENCE SURVEY, STRUCTURAL OR EVIGINEERING INFORMATION SHOW ESE DRAWINGS OF FOR CONSTRUCTION STARTED PRIOR TO TO SURVEY OF STRUCTURE STRUCTURE THE STRUCTURE OF THE STRUCTURE STRUCT CONSTITUCTED INVERTS MUST BE VEHIFIED PHIOR TO POURING TINGS.

ARDIN DESIGN CROUP INC. HAS NOT REEN RETAINED TO CARRY O RENERAL REVIEW OF THE WORK AND ASSUVES NO RESPONSIBILIT OR THE FAULLED OF THE CONTRACTOR OR SUB-CONTRACTOR TO A-APP OUT: HE MORK IN ACCORDANCE WITH THE CONT-ACT

HIS DRAWING IS AN INSTRUMENT OF SERVICE. IS PROVIDED BY AND THE PROPERTY OF JARTIN DESIGN CROUP INC. THIS DRAWING IS NO

1	TOE	SE SCALED.	
ı	7		
ı	6		
ı	5		
	4		
	3		
	2		
	1	JULY 2, 2020	ISSUED FOR BUILDING PERMIT

WORK DESCRIPTION:

64 JARDIN DR. SUITE 3A VAUGHAN ONT. L4K 3P3 TEL: 905 660-3377 FAX: 905 660-371 EMAIL: info@jardindesign.ca

he undersigned has reviewed and takes responsibility for this design and has the qualifications and meets the irements set out in the Ontario Building Code to b QUALIFICATION INFORMATION

Required unless design is exempt, upda applicant C, Subsection 3.2.5 of the bulliary crite

Walter Botter 21031 SIGNATURE NAME

REGISTRATION INFORMATION


jardin design group inc. IRM NAME TITLE SHEET

LAMPONE INVESTMENTS INC. CITY OF MARKHAM



3/16"=1'-0" 0 20-03


BUILDING STANDARDS DIVISION REVIEWED FOR COMPLIANCE WITH THE ONTARIO BUILDING

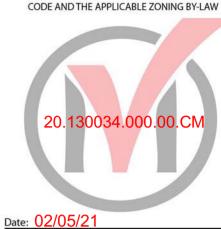

ALL CONSTRUCTION SHALL COMPLY WITH

NO PERSON SHALL CONSTRUCT OR DEMOLISH A BUILDING OR CAUSE A BUILDING TO BE CONSTRUCTED EXCEPT IN ACCORDANCE WITH THESE CERTIFIED BUILDING PERMIT DOCUMENTS, THE BUILDING CODE ACT AND THE BUILDING CODE.

THE ONTARIO BUILDING CODE

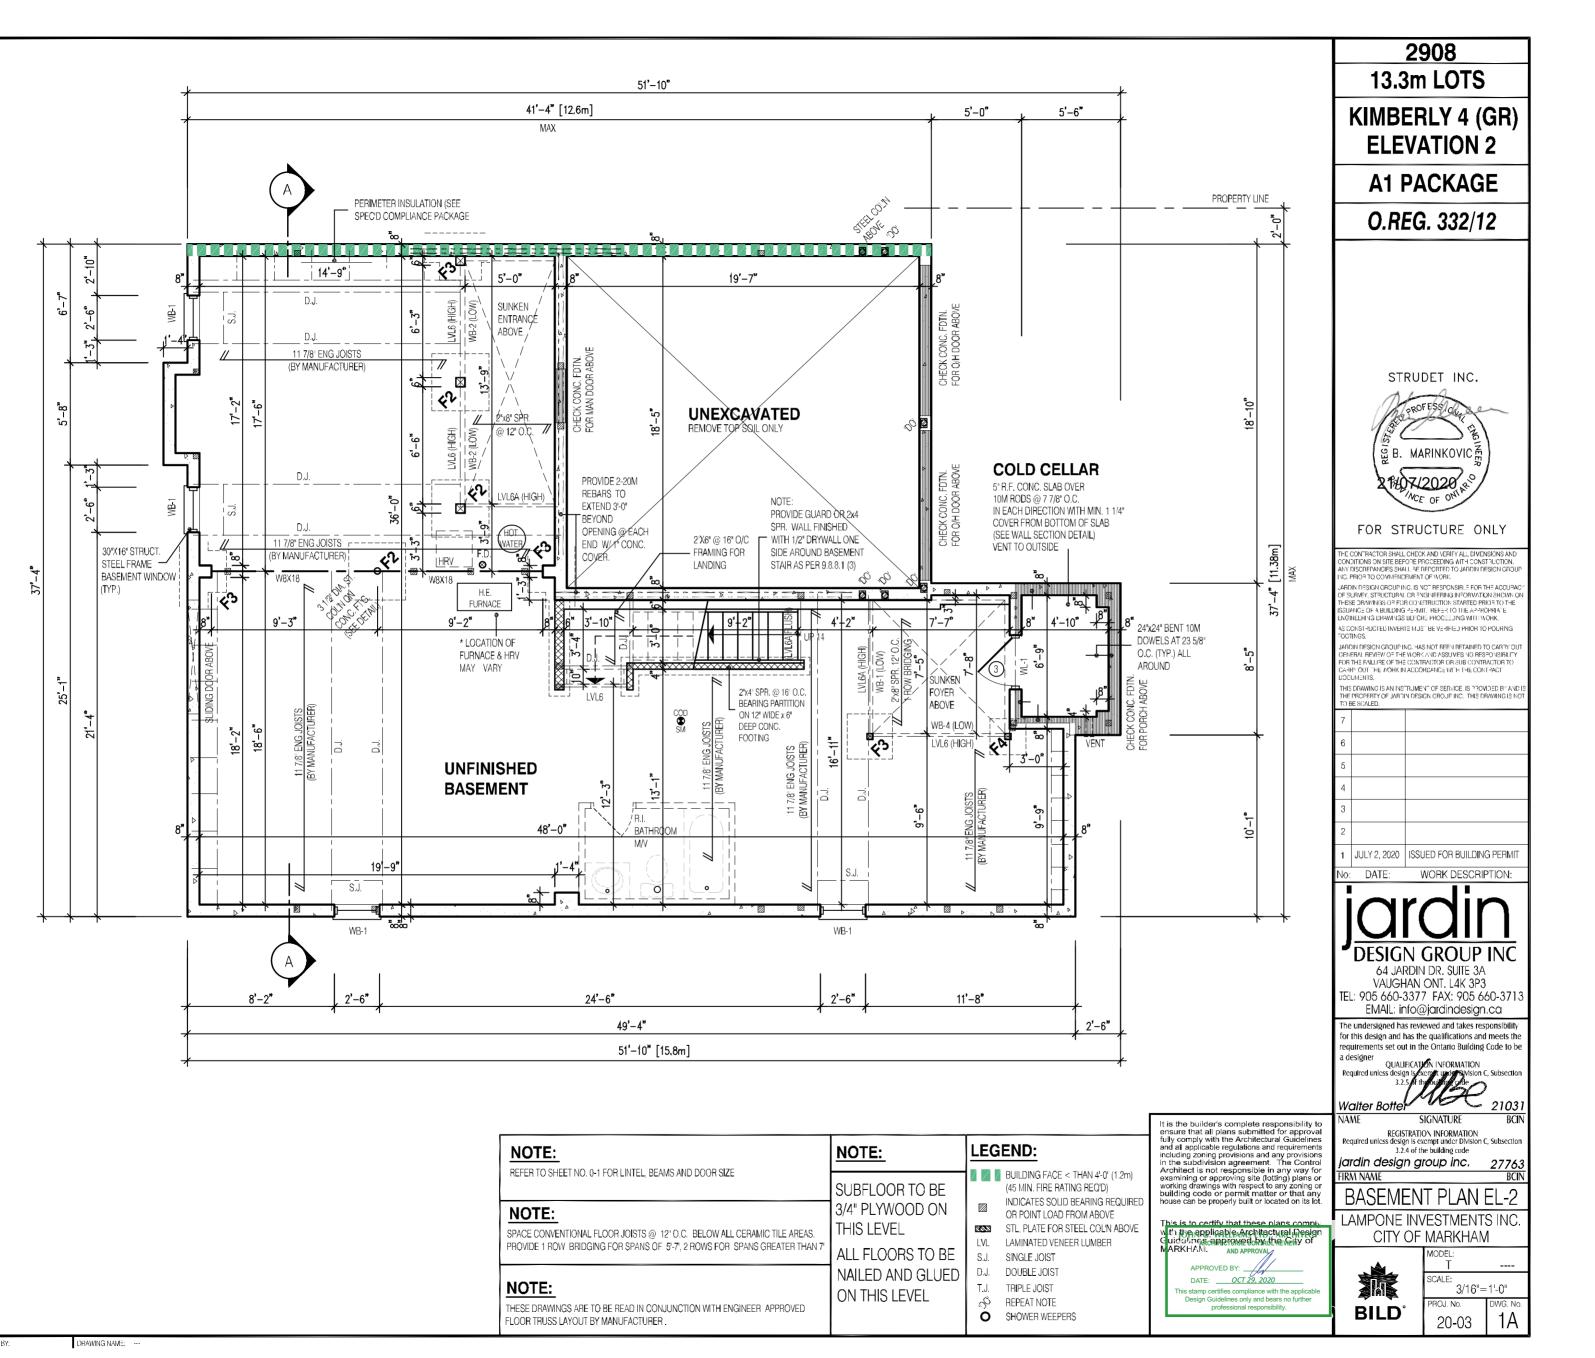






Date: 02/05/

ALL CONSTRUCTION SHALL COMPLY WITH THE ONTARIO BUILDING CODE

NO PERSON SHALL CONSTRUCT OR DEMOLISH A BUILDING OR CAUSE A BUILDING TO BE CONSTRUCTED EXCEPT IN ACCORDANCE WITH THESE CERTIFIED BUILDING PERMIT DOCUMENTS, THE BUILDING CODE ACT AND THE BUILDING CODE.

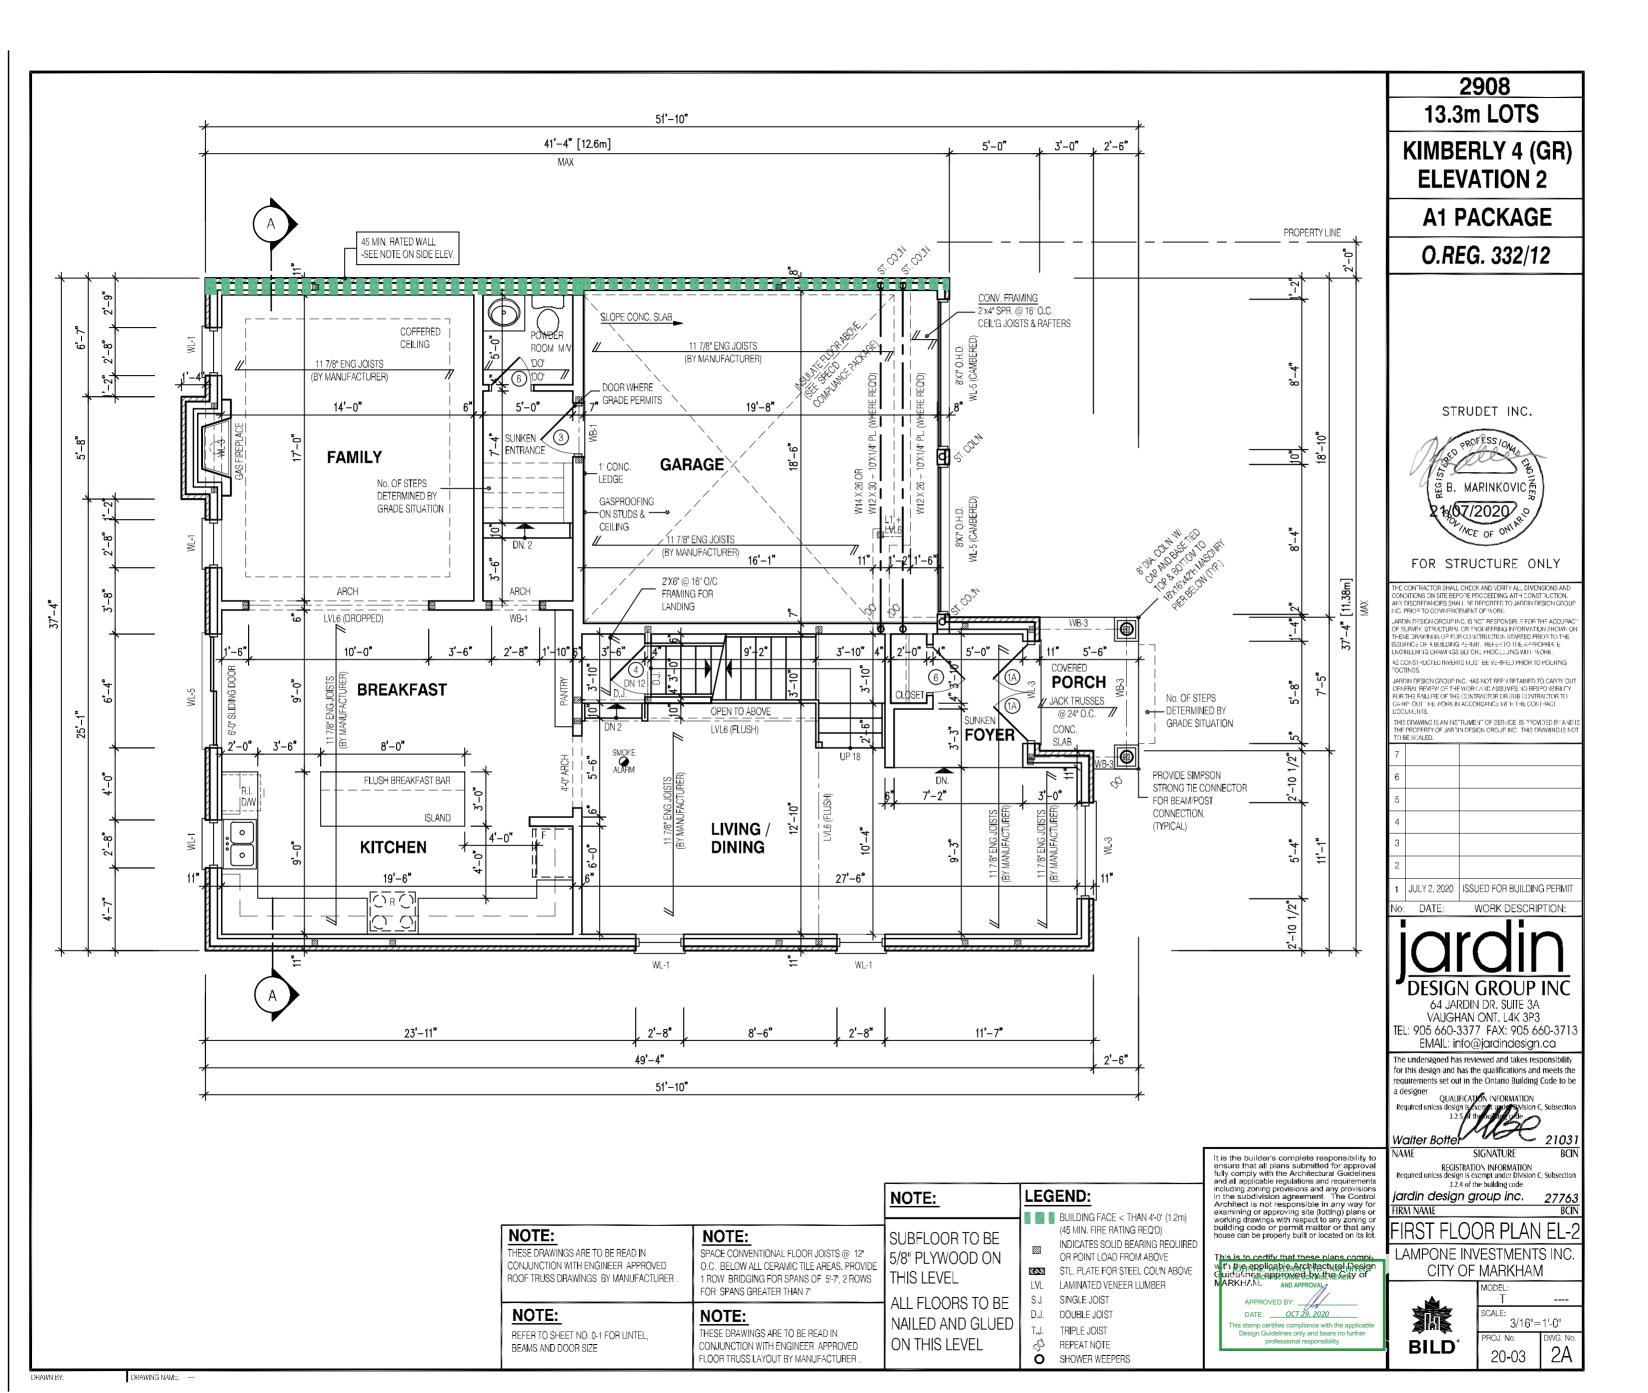







Date: 02/05/2

ALL CONSTRUCTION SHALL COMPLY WITH THE ONTARIO BUILDING CODE

NO PERSON SHALL CONSTRUCT OR DEMOLISH A BUILDING OR CAUSE A BUILDING TO BE CONSTRUCTED EXCEPT IN ACCORDANCE WITH THESE CERTIFIED BUILDING PERMIT DOCUMENTS, THE BUILDING CODE ACT AND THE BUILDING CODE.

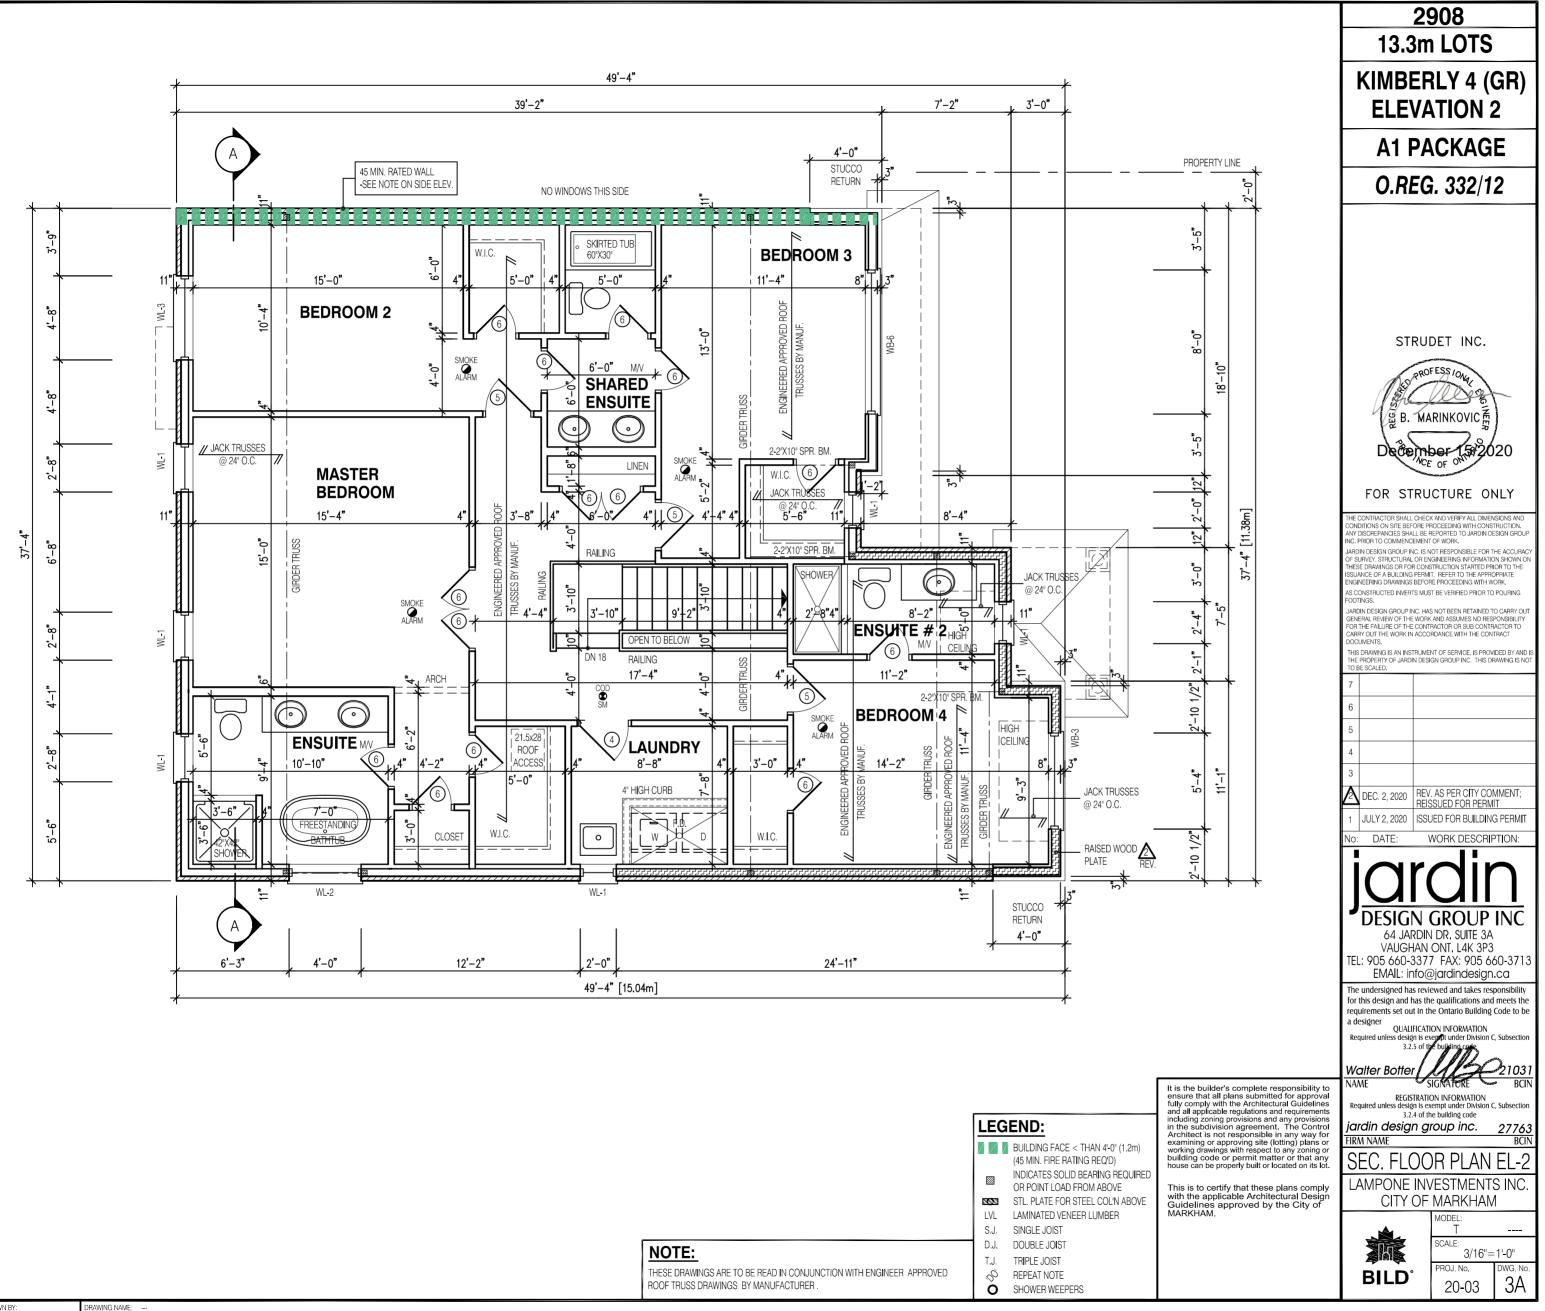


BUILDING STANDARDS DIVISION REVIEWED FOR COMPLIANCE WITH THE ONTARIO BUILDING

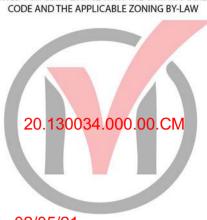

ALL CONSTRUCTION SHALL COMPLY WITH THE ONTARIO BUILDING CODE

NO PERSON SHALL CONSTRUCT OR DEMOLISH A BUILDING OR CAUSE A BUILDING TO BE CONSTRUCTED EXCEPT IN ACCORDANCE WITH THESE CERTIFIED BUILDING PERMIT DOCUMENTS, THE BUILDING CODE ACT AND THE BUILDING CODE.

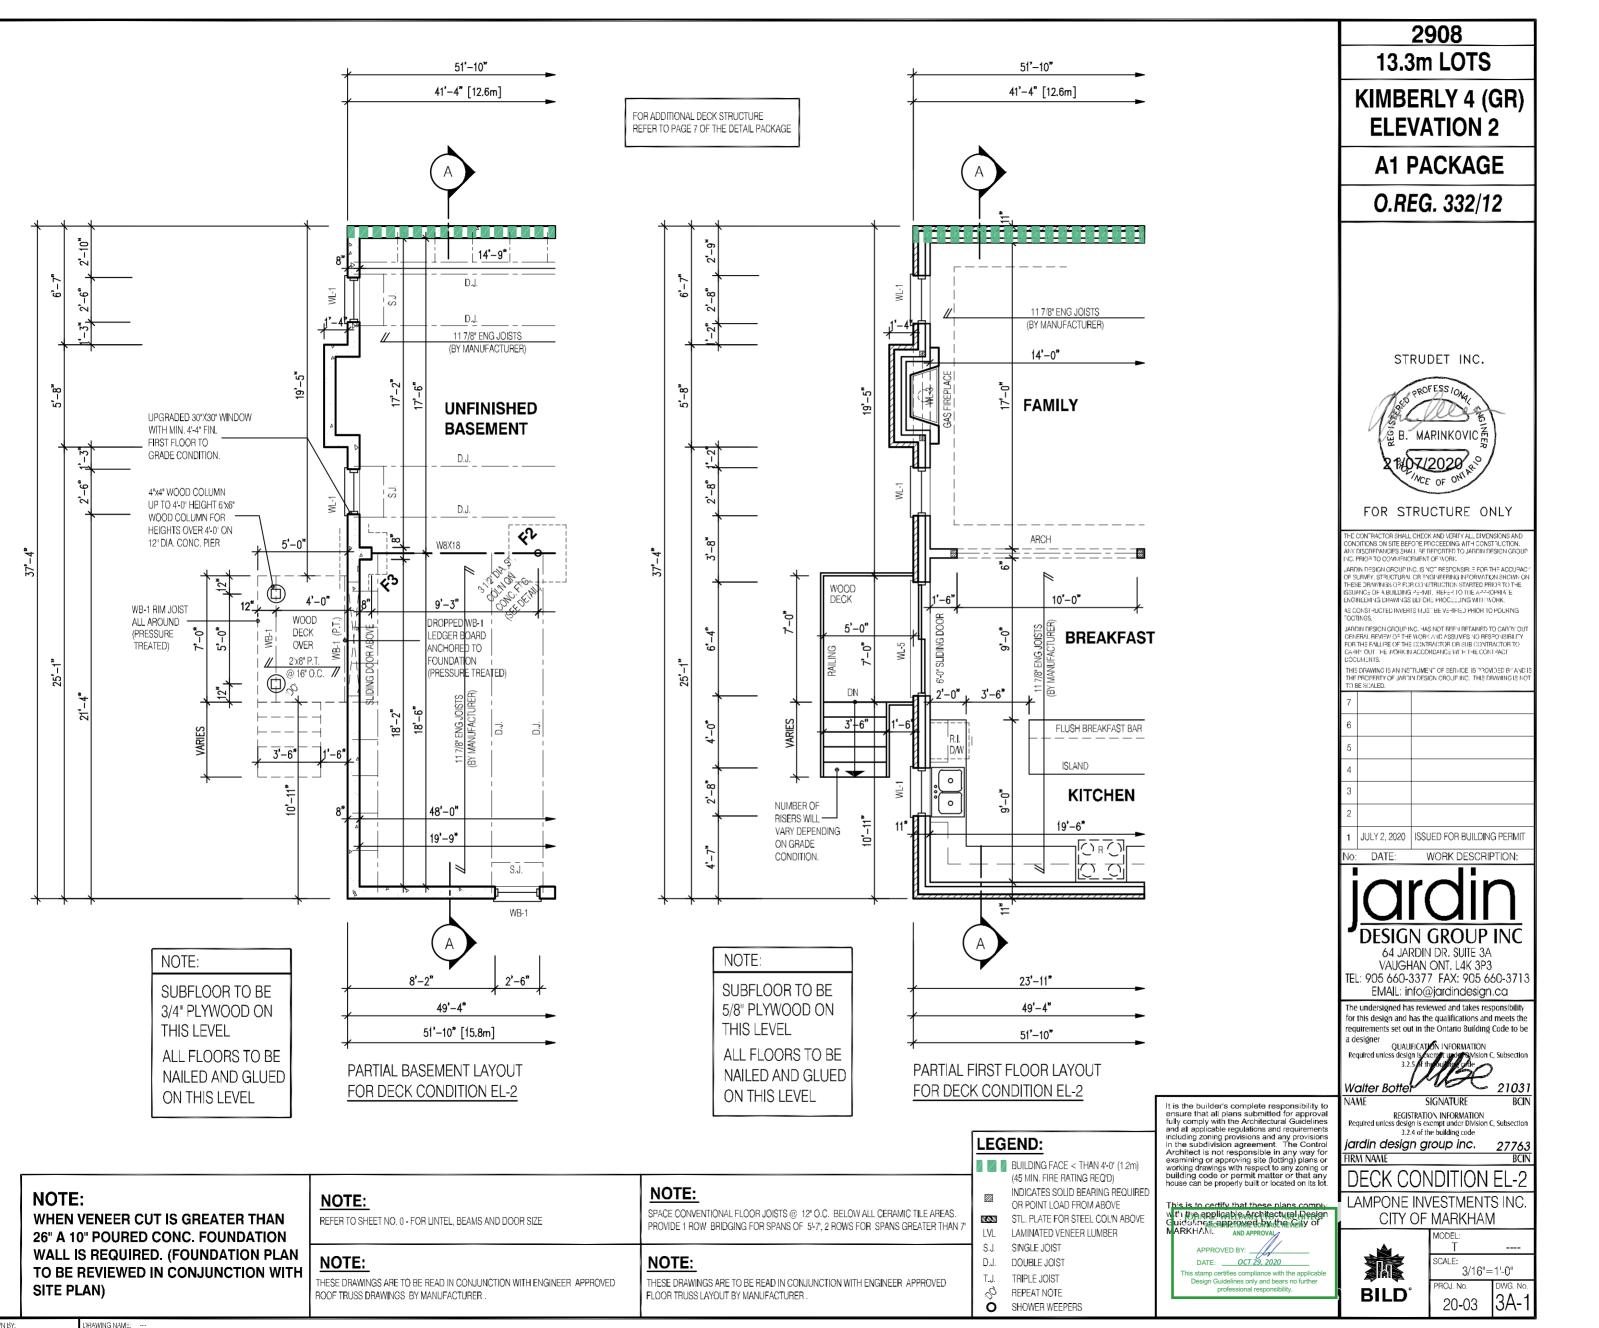






Date: 02/05/2

ALL CONSTRUCTION SHALL COMPLY WITH THE ONTARIO BUILDING CODE

NO PERSON SHALL CONSTRUCT OR DEMOLISH A BUILDING OR CAUSE A BUILDING TO BE CONSTRUCTED EXCEPT IN ACCORDANCE WITH THESE CERTIFIED BUILDING PERMIT DOCUMENTS, THE BUILDING CODE ACT AND THE BUILDING CODE.

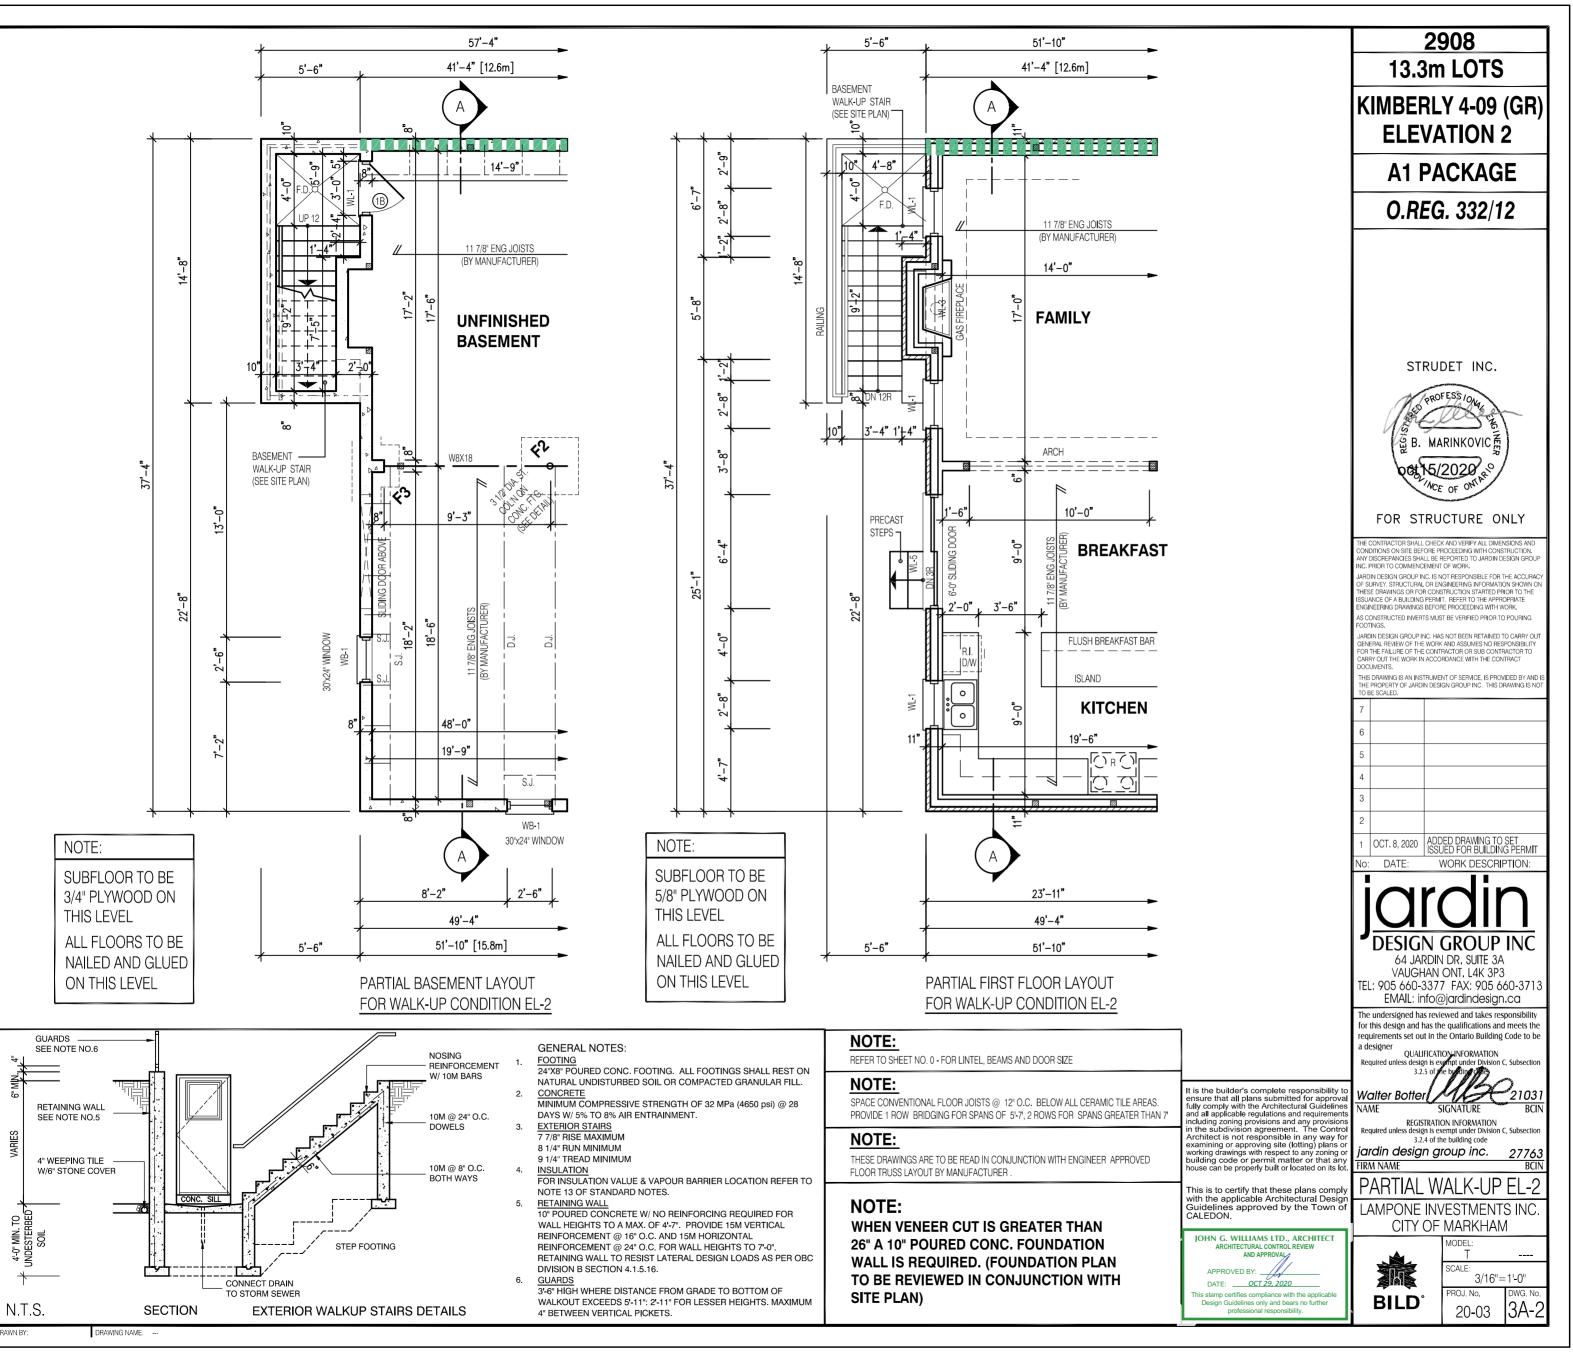






Date: 02/05/2

ALL CONSTRUCTION SHALL COMPLY WITH THE ONTARIO BUILDING CODE

NO PERSON SHALL CONSTRUCT OR DEMOLISH A BUILDING OR CAUSE A BUILDING TO BE CONSTRUCTED EXCEPT IN ACCORDANCE WITH THESE CERTIFIED BUILDING PERMIT DOCUMENTS, THE BUILDING CODE ACT AND THE BUILDING CODE.

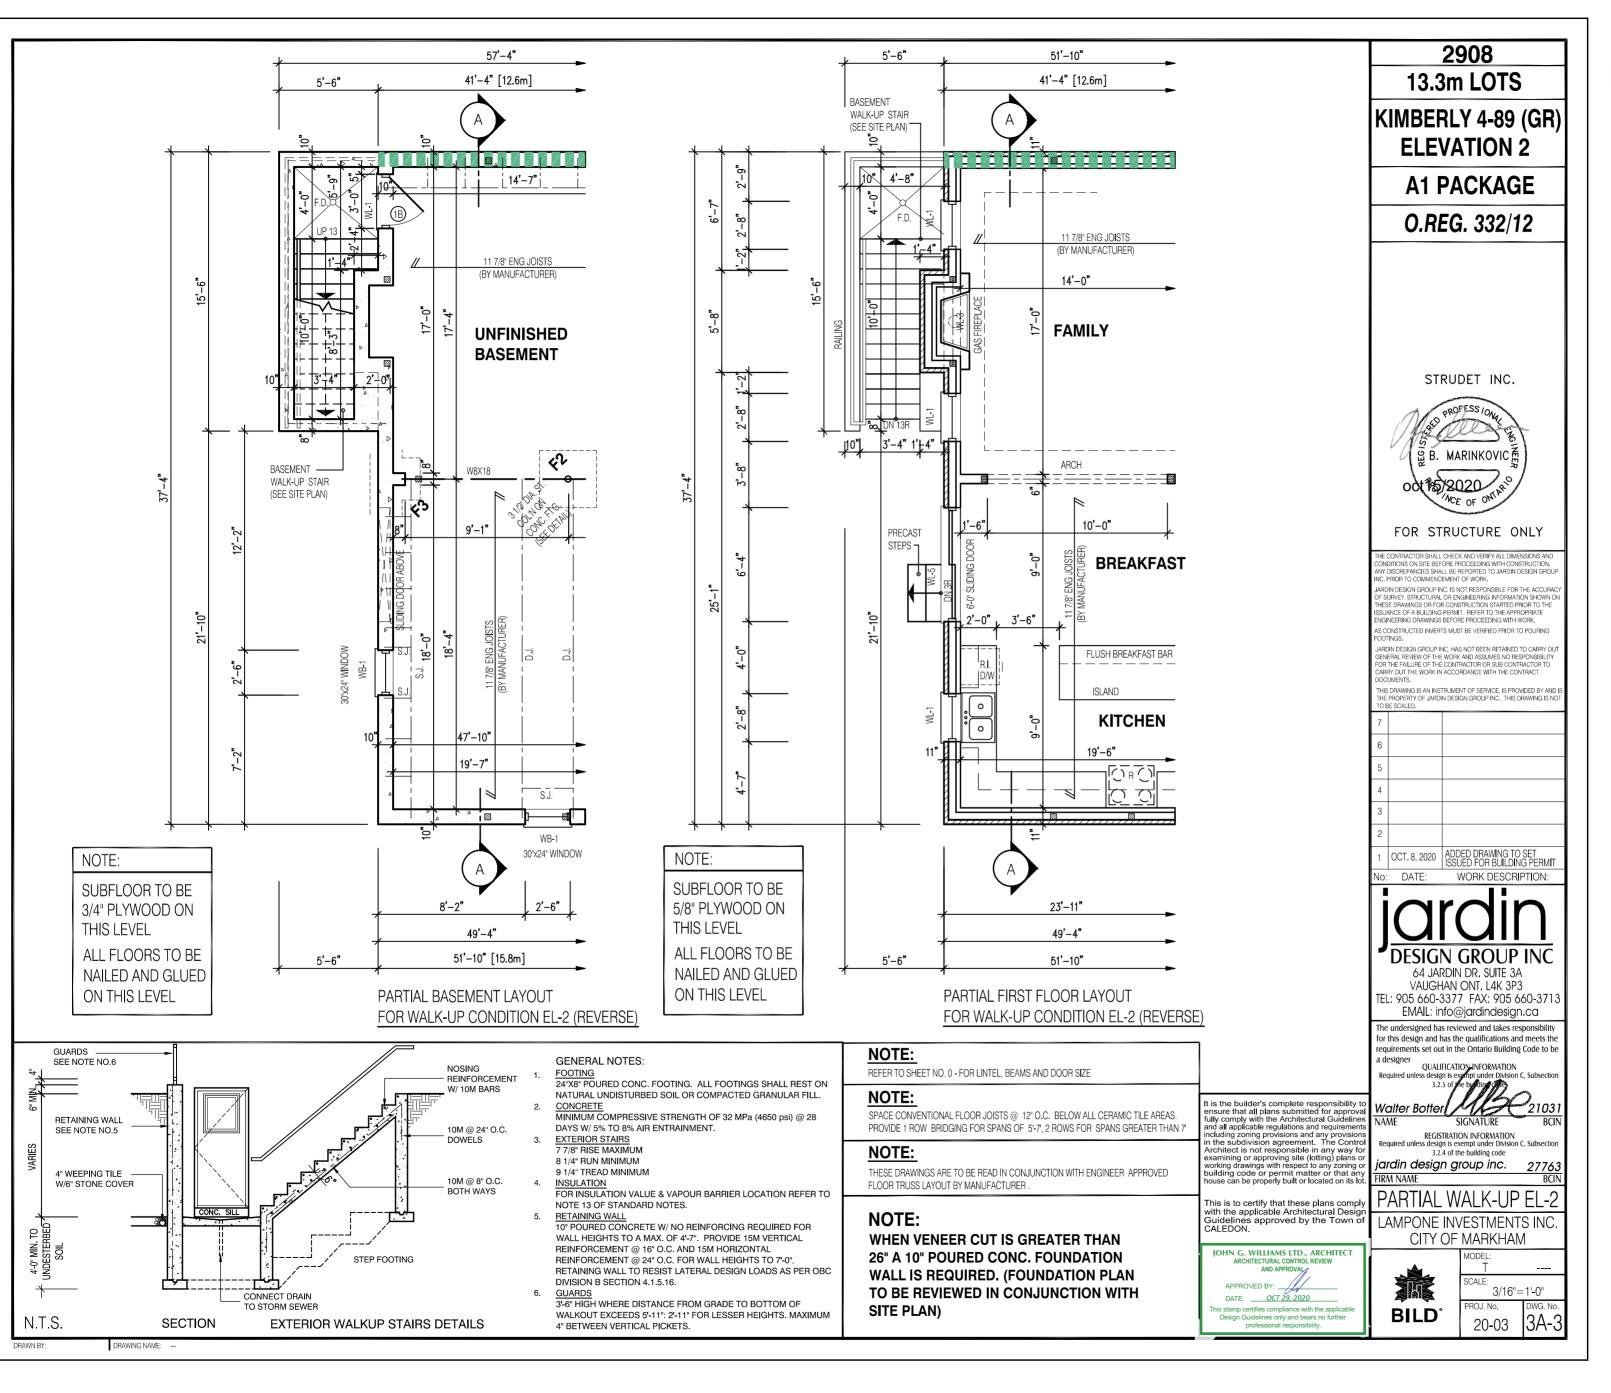






Date: 02/05/2

ALL CONSTRUCTION SHALL COMPLY WITH THE ONTARIO BUILDING CODE

NO PERSON SHALL CONSTRUCT OR DEMOLISH A BUILDING OR CAUSE A BUILDING TO BE CONSTRUCTED EXCEPT IN ACCORDANCE WITH THESE CERTIFIED BUILDING PERMIT DOCUMENTS, THE BUILDING CODE ACT AND THE BUILDING CODE.

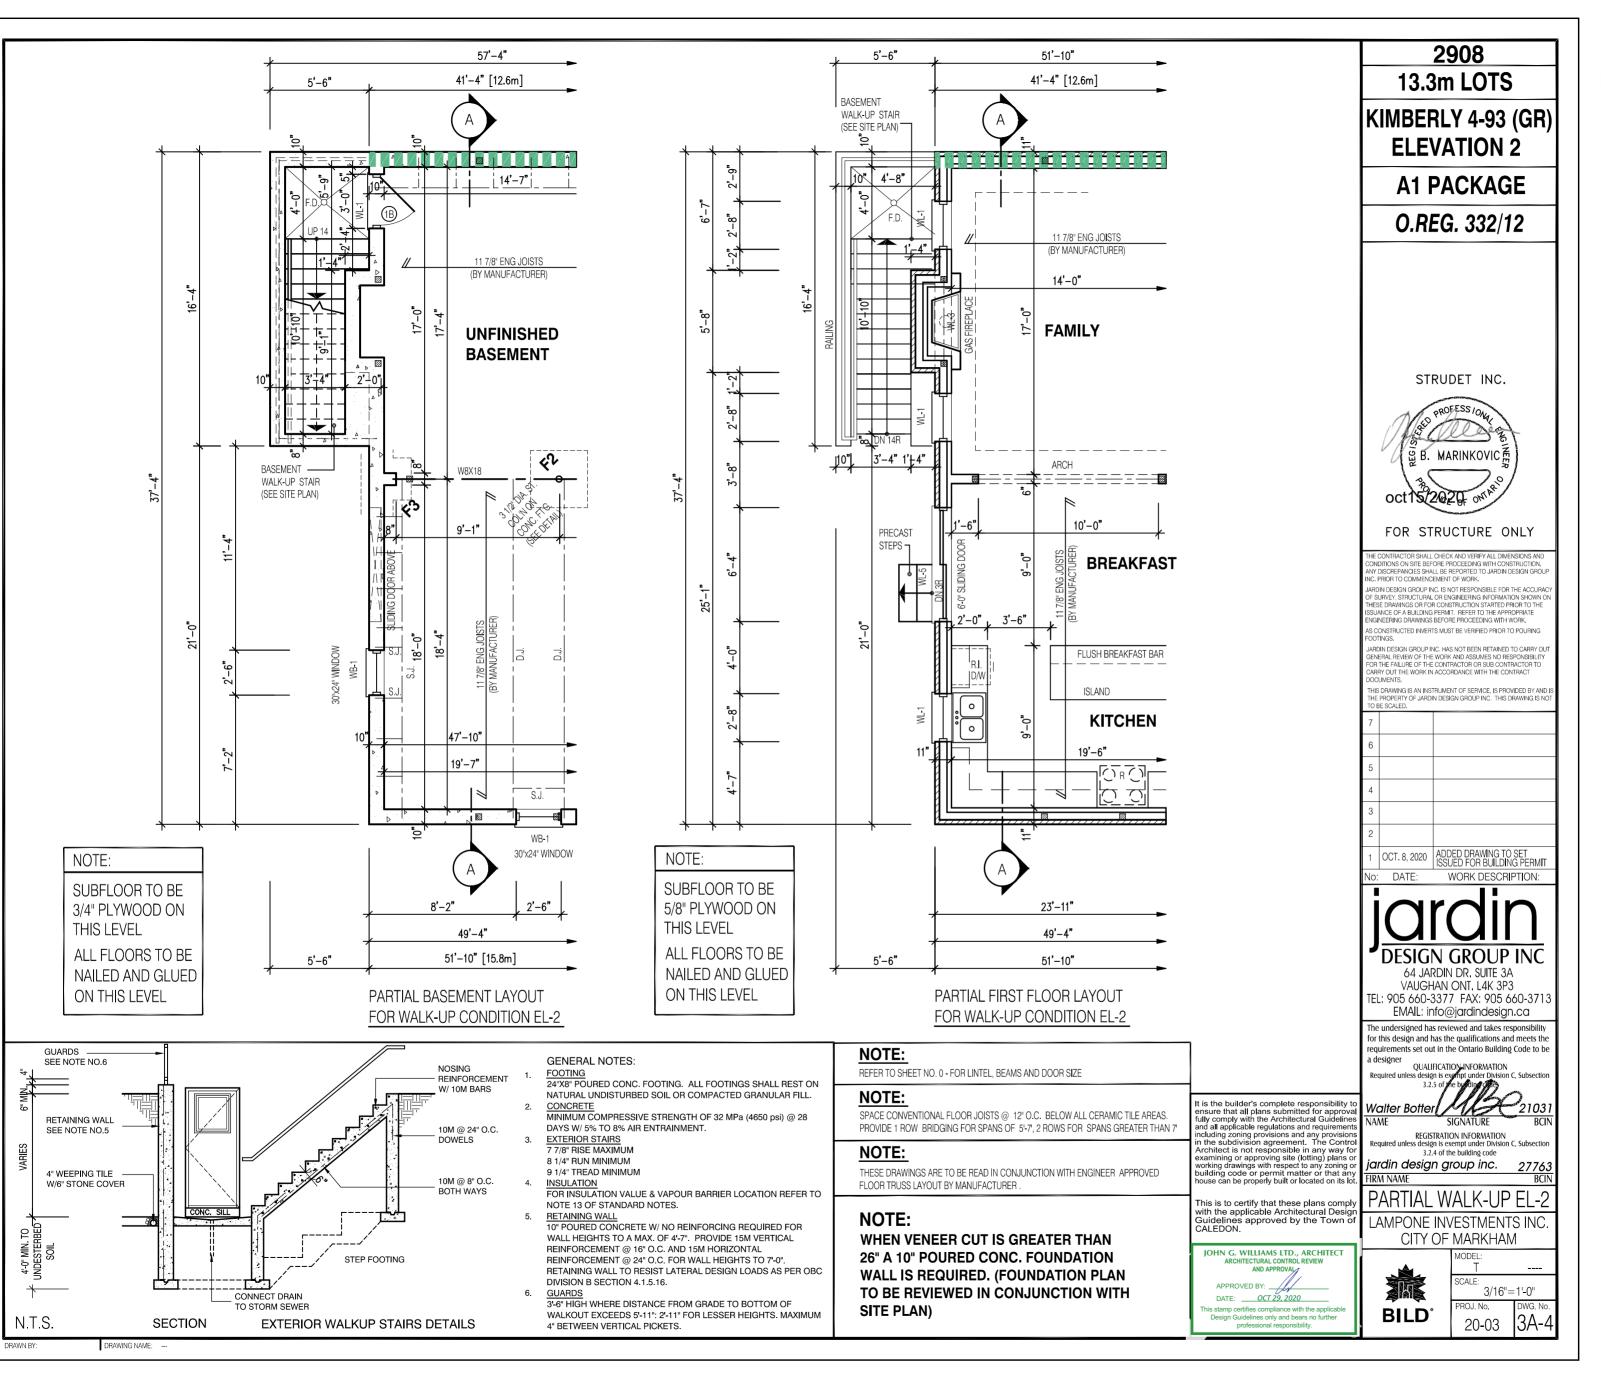






Date: 02/05/2

ALL CONSTRUCTION SHALL COMPLY WITH THE ONTARIO BUILDING CODE

NO PERSON SHALL CONSTRUCT OR DEMOLISH A BUILDING OR CAUSE A BUILDING TO BE CONSTRUCTED EXCEPT IN ACCORDANCE WITH THESE CERTIFIED BUILDING PERMIT DOCUMENTS, THE BUILDING CODE ACT AND THE BUILDING CODE.

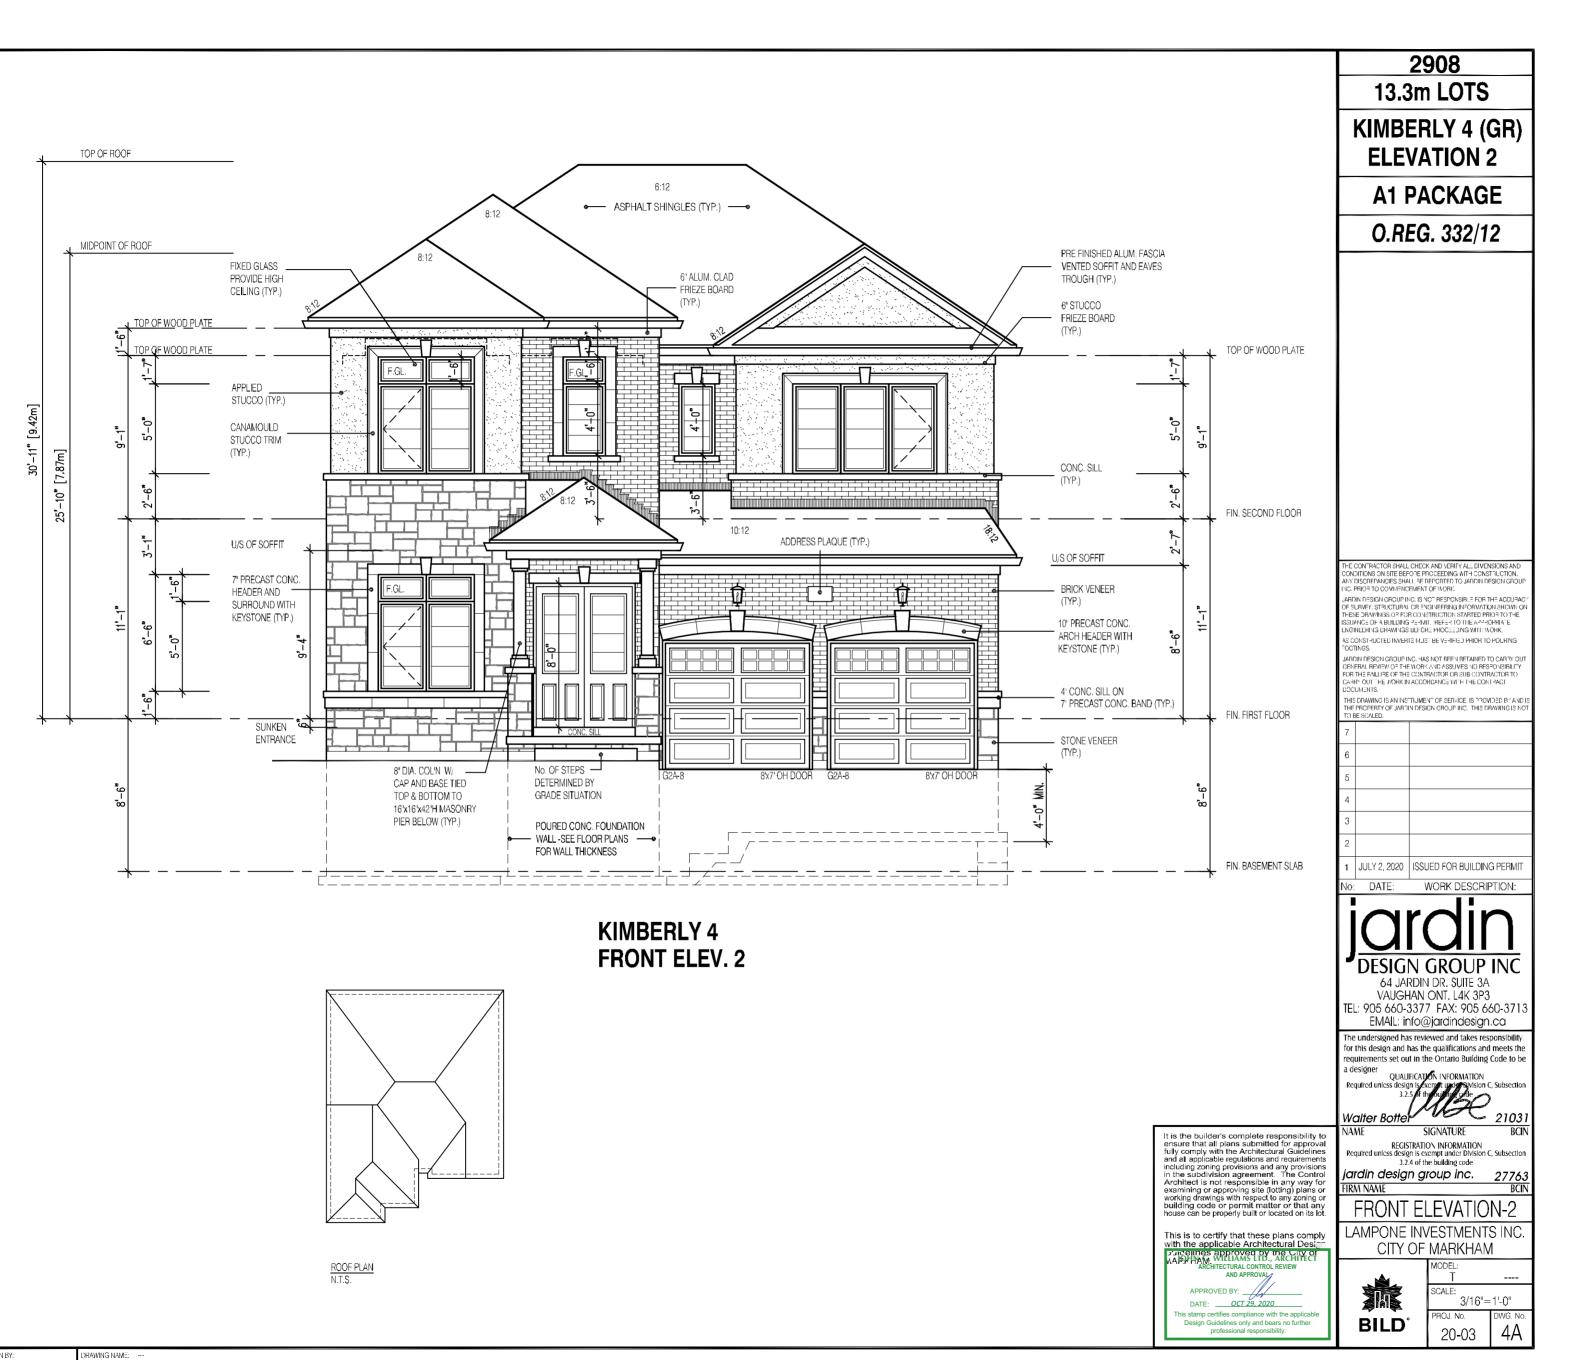






Date: 02/05/2

ALL CONSTRUCTION SHALL COMPLY WITH THE ONTARIO BUILDING CODE

NO PERSON SHALL CONSTRUCT OR DEMOLISH A BUILDING OR CAUSE A BUILDING TO BE CONSTRUCTED EXCEPT IN ACCORDANCE WITH THESE CERTIFIED BUILDING PERMIT DOCUMENTS, THE BUILDING CODE ACT AND THE BUILDING CODE.

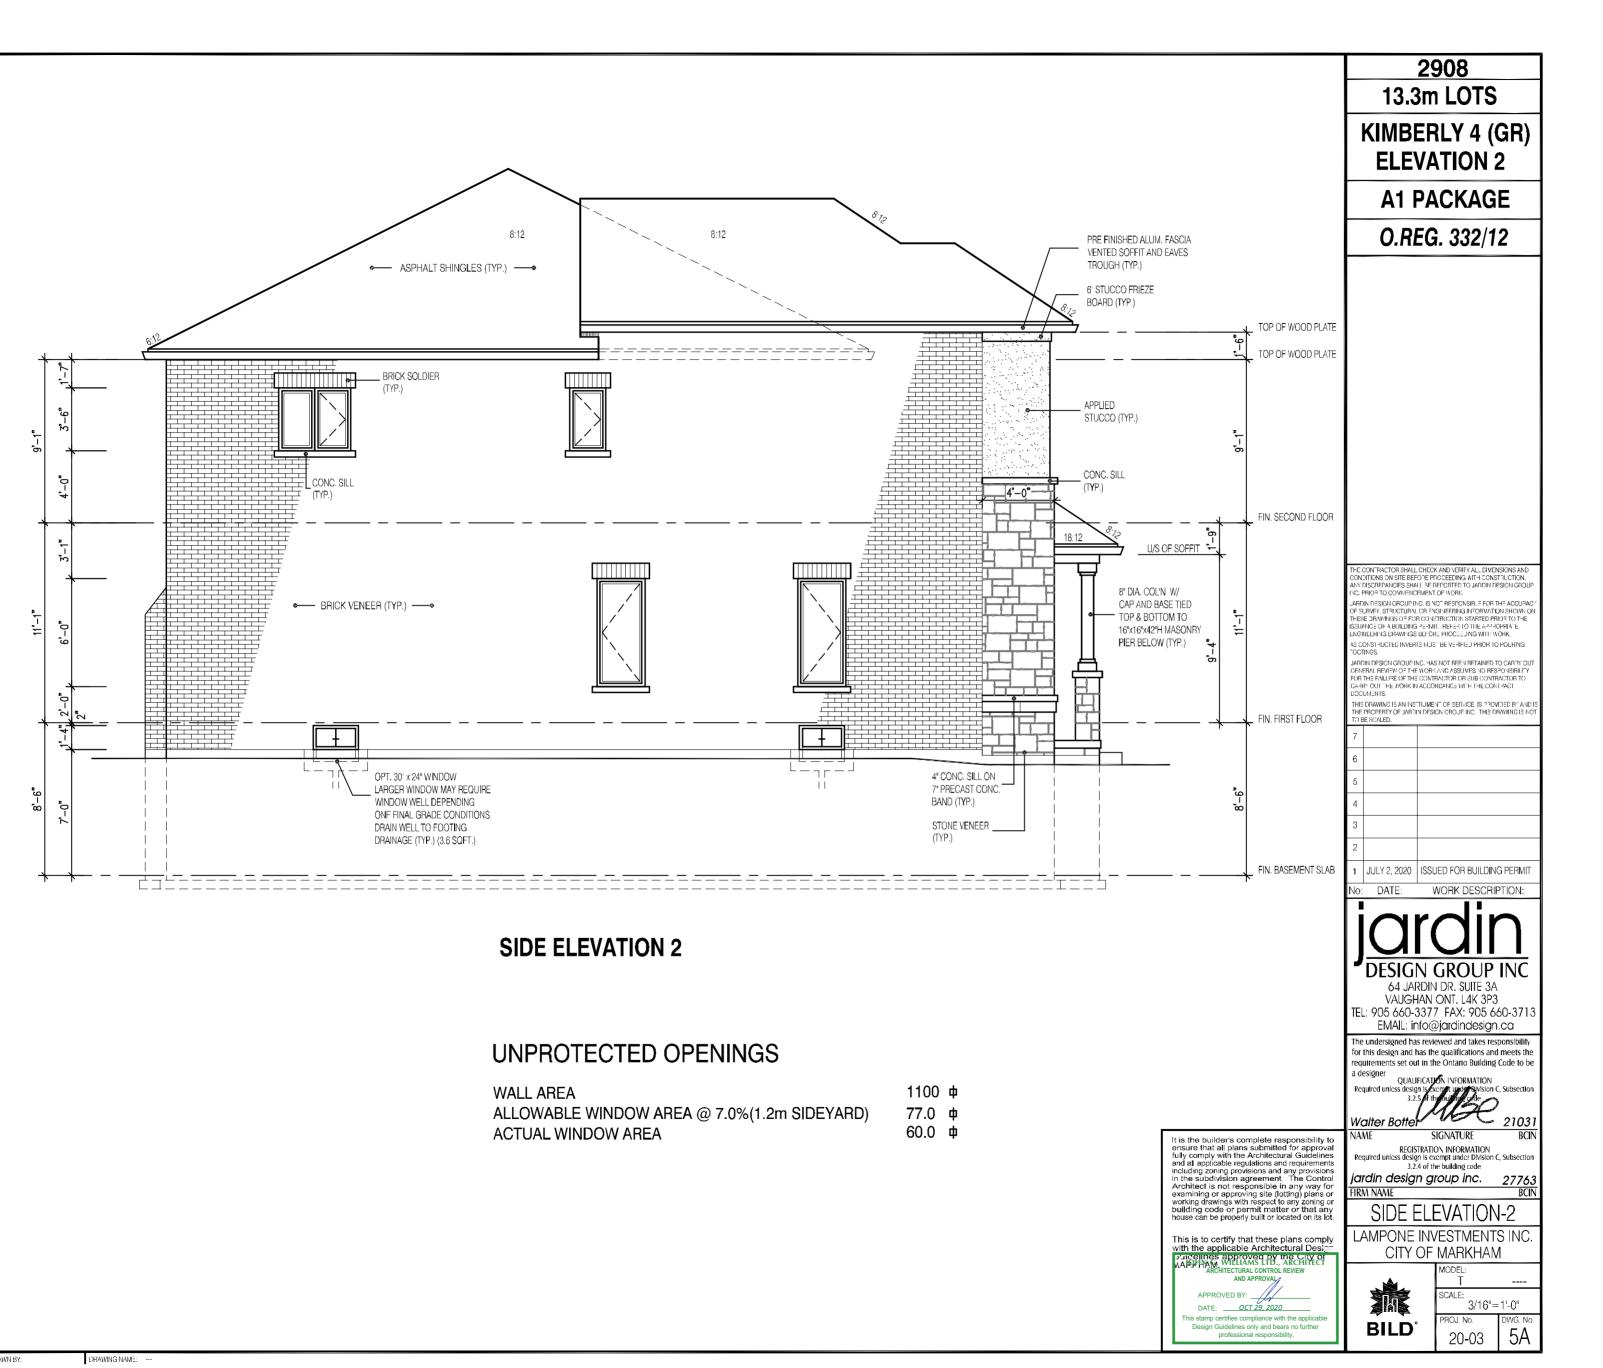






Date: 02/05/

ALL CONSTRUCTION SHALL COMPLY WITH THE ONTARIO BUILDING CODE

NO PERSON SHALL CONSTRUCT OR DEMOLISH A BUILDING OR CAUSE A BUILDING TO BE CONSTRUCTED EXCEPT IN ACCORDANCE WITH THESE CERTIFIED BUILDING PERMIT DOCUMENTS, THE BUILDING CODE ACT AND THE BUILDING CODE.

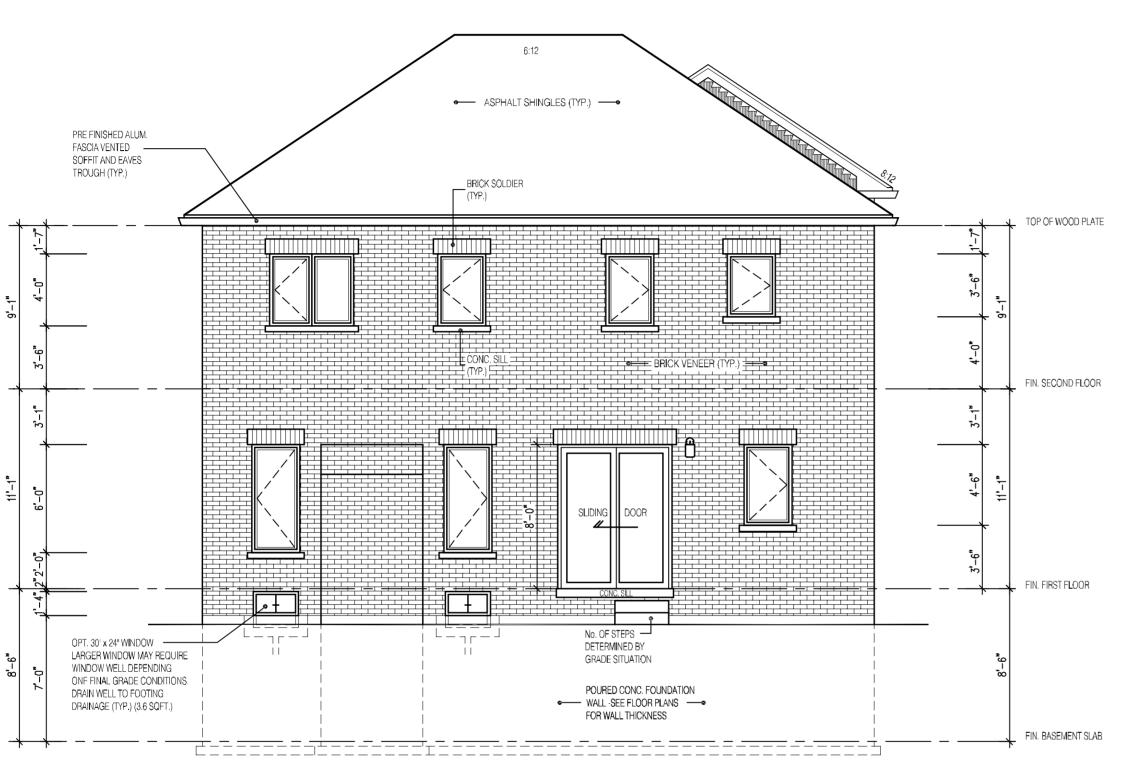

REAR ELEVATION 2

HIS DRAWING IS AN INSTRUMENT OF SERVICE, IS PROVIDED BY AND HE PROPERTY OF JARDIN DESIGN CROUP INC. THIS DRAWING IS NO JULY 2, 2020 ISSUED FOR BUILDING PERMIT DATE: WORK DESCRIPTION: 64 JARDIN DR. SUITE 3A VAUGHAN ONT. L4K 3P3 TEL: 905 660-3377 FAX: 905 660-3713 EMAIL: info@jardindesign.ca The undersigned has reviewed and takes responsibility for this design and has the qualifications and meets the quirements set out in the Ontario Building Code to be a designer
QUALIFICATION INFORMATION
Required unless design is execute under system C, subsection
3.2.5 of the building orde

Walter Botter 21031 SIGNATURE It is the builder's complete responsibility to ensure that all plans submitted for approval fully comply with the Architectural Guidelines and all applicable regulations and requirements including zoning provisions and any provisions in the subdivision agreement. The Control Architect is not responsible in any way for examining or approving site (lotting) plans or working drawings with respect to any zoning or building code or permit matter or that any house can be properly built or located on its lot. REGISTRATION INFORMATION ss design is exempt under Division C, Subsection 3.2.4 of the building code jardin design group inc. IRM NAME REAR ELEVATION-2 LAMPONE INVESTMENTS INC. This is to certify that these plans comply with the applicable Architectural Design participation of the Architectural Design participation of the Architectural Control Review CITY OF MARKHAM DATE: OCT 29, 2020 **BILD** 20-03

2908 13.3m LOTS **KIMBERLY 4 (GR) ELEVATION 2 A1 PACKAGE** O.REG. 332/12 HE CONTRACTOR SHALL CHECK AND VERIFY ALL DIVENSIONS AND CONDITIONS ON SITE BEFORE PROCEEDING AITH CONSTRUCTION. BY DISCREPANCIES SHALL SE REPORTED TO JARDIN DESIGN GRO C. PRICE TO COVENCEMENT OF WORK. CONSTRUCTED INVERTS MUST BE VERIFIED PRIOR TO POURING DTINGS.


BUILDING STANDARDS DIVISION REVIEWED FOR COMPLIANCE WITH THE ONTARIO BUILDING CODE AND THE APPLICABLE ZONING BY-LAW

ALL CONSTRUCTION SHALL COMPLY WITH THE ONTARIO BUILDING CODE

NO PERSON SHALL CONSTRUCT OR DEMOLISH A BUILDING OR CAUSE A BUILDING TO BE CONSTRUCTED EXCEPT IN ACCORDANCE WITH THESE CERTIFIED BUILDING PERMIT DOCUMENTS, THE BUILDING CODE ACT AND THE BUILDING CODE.

NOTE: THE PROPOSED DEVELOPMENT IS SUBJECT TO COMPLIANCE WITH ALL APPLICABLE PROVISIONS OF THE ZONING BY-LAW AND ALL OTHER APPLICABLE LAWS INCLUDING THE PROVISIONS OF A SITE PLAN AND / OR SUBDIVISION AGREEMENT WHICH MAY OR MAY NOT BE REGISTERED ON TITLE

3/16"=1'-0"

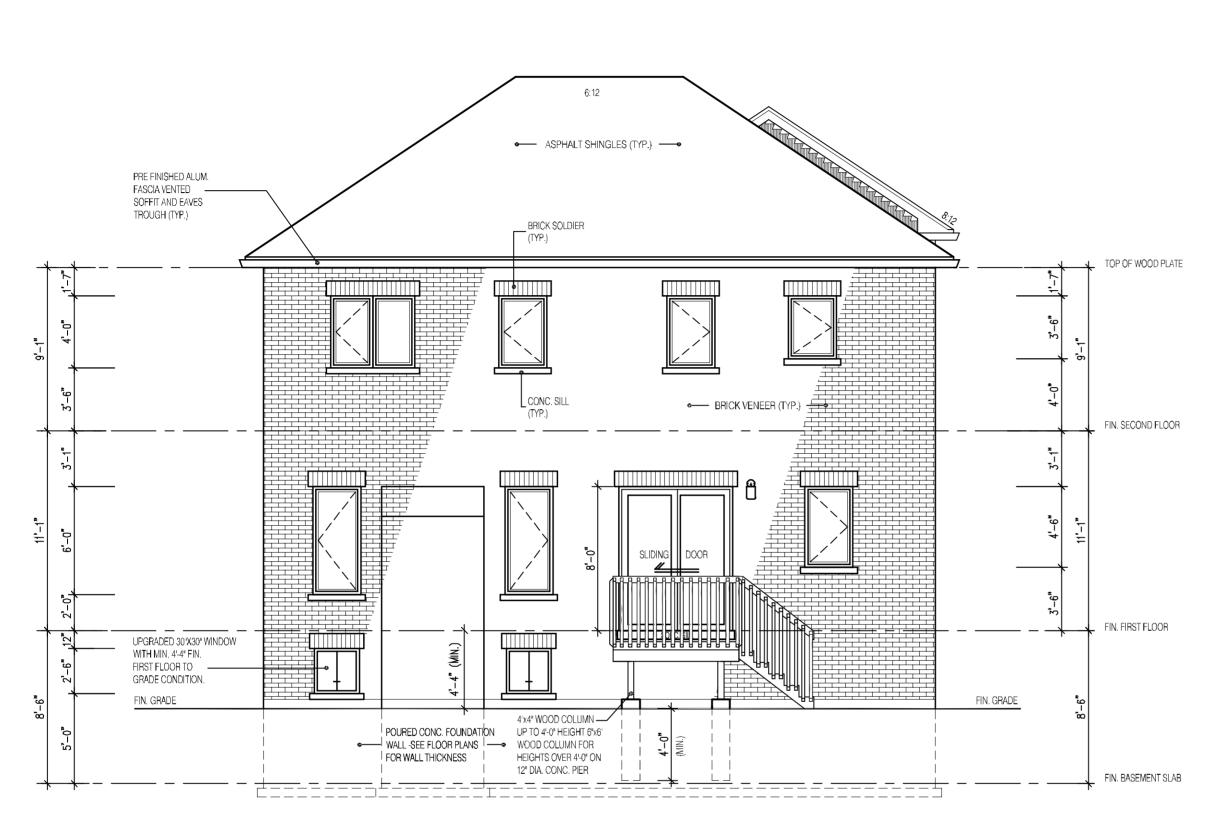

REAR ELEVATION 2 DECK CONDITION

FOR ADDITIONAL DECK STRUCTURE REFER TO PAGE 7 OF THE DETAIL PACKAGE

DRAWING NAME:

NOTE:

WHEN VENEER CUT IS GREATER THAN 26" A 10" POURED CONC. FOUNDATION WALL IS REQUIRED.


(FOUNDATION PLAN TO BE REVIEWED IN CONJUNCTION WITH SITE PLAN)

This is to certify that these plans comply with the applicable Architectural Designation of the Architectural Designation of the Architectural Course Review DATE: OCT 29, 2020

It is the builder's complete responsibility to ensure that all plans submitted for approval fully comply with the Architectural Guidelines and all applicable regulations and requirements including zoning provisions and any provisions in the subdivision agreement. The Control Architect is not responsible in any way for examining or approving site (lotting) plans or working drawings with respect to any zoning or building code or permit matter or that any house can be properly built or located on its lot.

jardin design group inc. IRM NAME DECK CONDITION EL-2 LAMPONE INVESTMENTS INC. CITY OF MARKHAM **BILD**

DATE

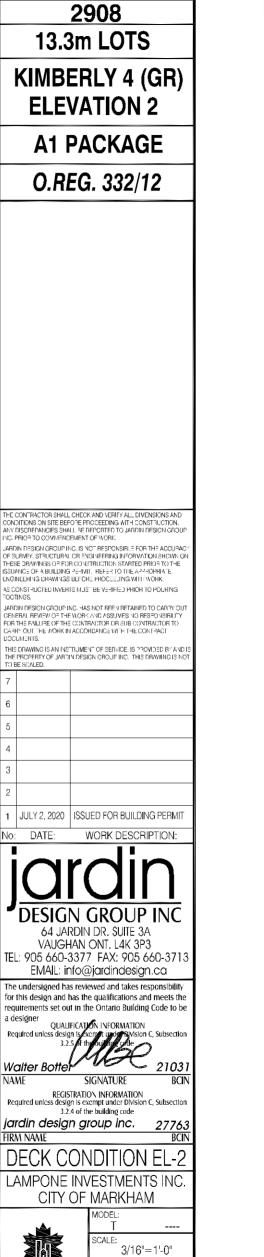

2908

13.3m LOTS

ELEVATION 2

A1 PACKAGE

O.REG. 332/12

CONSTRUCTED INVERTS MUST BE VERIFIED PRIOR TO POURING TINGS.

64 JARDIN DR. SUITE 3A VAUGHAN ONT. L4K 3P3

EMAIL: info@jardindesign.ca

QUALIFICATION INFORMATION

SIGNATURE

3/16"=1'-0"

20-03

6A-1




REVIEWED FOR COMPLIANCE WITH THE ONTARIO BUILDING CODE AND THE APPLICABLE ZONING BY-LAW



ALL CONSTRUCTION SHALL COMPLY WITH THE ONTARIO BUILDING CODE

NO PERSON SHALL CONSTRUCT OR DEMOLISH A BUILDING OR CAUSE A BUILDING TO BE CONSTRUCTED EXCEPT IN ACCORDANCE WITH THESE CERTIFIED BUILDING PERMIT DOCUMENTS, THE BUILDING CODE ACT AND THE BUILDING CODE.

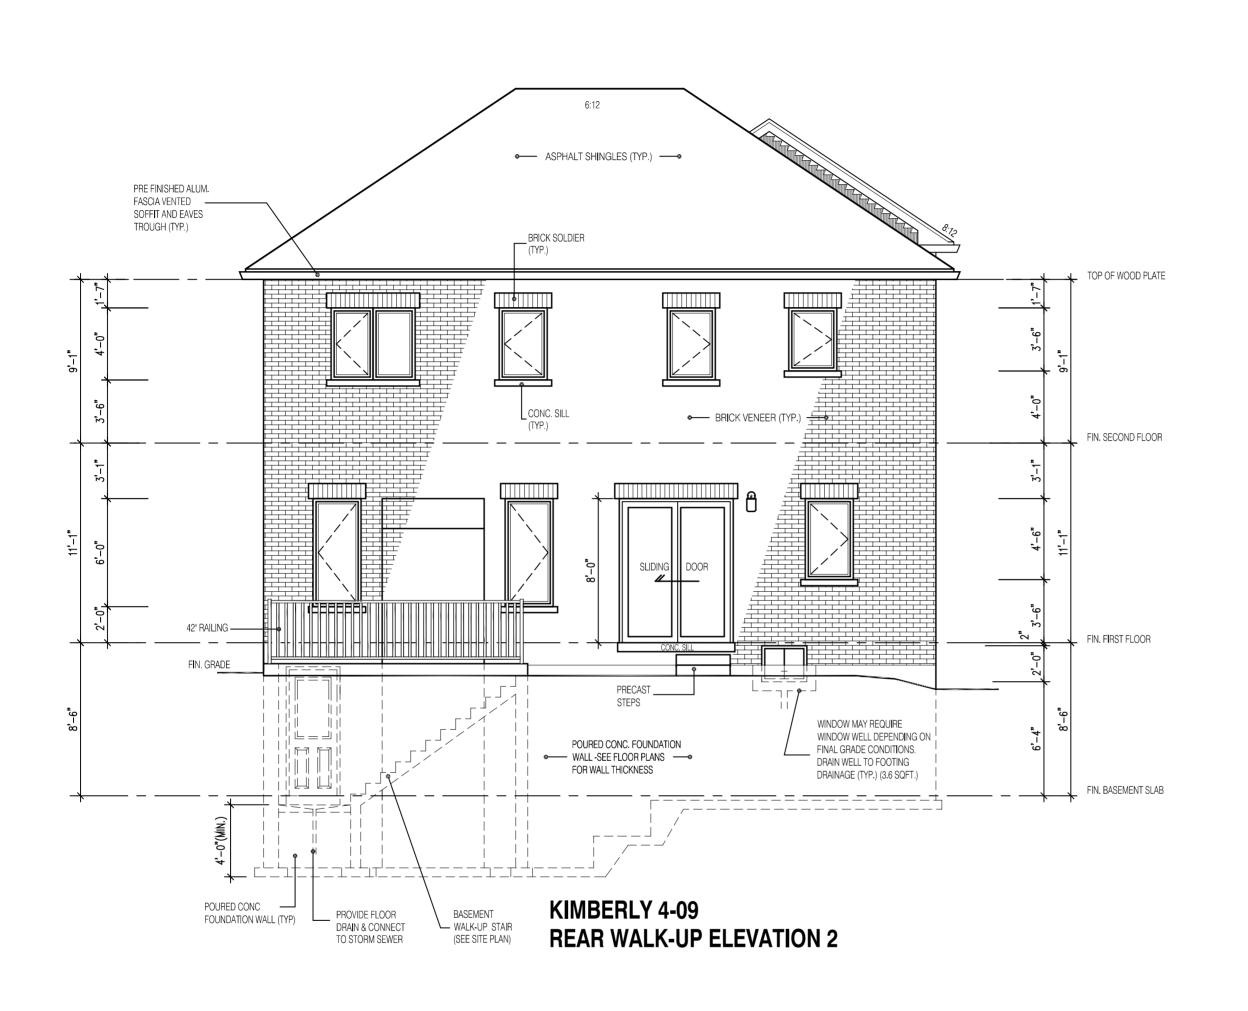

KIMBERLY 4-09 ELEV2		ENERGY EFFICIENCY- A1 PACKAGE	
ELEVATION	WALL FT ²	OPENING FT ²	PERCENTAGE
FRONT	874.00	152.00	17.39 %
LEFT SIDE	1100.00	60.00	5.45 %
RIGHT SIDE	1104.00	0.00	0.00 %
REAR	891.00	171.00	19.19 %
TOTAL	3969.00	383.00	9.65 %

It is the builder's complete responsibility to ensure that all plans submitted for approval fully comply with the Architectural Guidelines and all applicable regulations and requirements including zoning provisions and any provisions in the subdivision agreement. The Control Architect is not responsible in any way for examining or approving site (lotting) plans or working drawings with respect to any zoning or building code or permit matter or that any house can be properly built or located on its lot.

This is to certify that these plans comply with the applicable Architectural Design Guidolines approved by the City of MARKHAM. WILLIAMS LTD., ARCHITECT ARCHITECTURAL CONTROL REVIEW

APPROVED BY:

DATE: OCT 29, 2020

stamp certifies compliance with the applicable Design Guidelines only and bears no further professional responsibility.

2908 13.3m LOTS KIMBERLY 4-09 (GR) ELEVATION 2 A1 PACKAGE

O.REG. 332/12

CONDITIONS ON SITE BEFORE PROCEEDING WITH CONSTRUCTION.
ANY DISCREPANCIES SHALL BE REPORTED TO JARDIN DESIGN GROUP
INC. PRIOR TO COMMENCEMENT OF WORK.

JARDIN DESIGN GROUP INC. IS NOT RESPONSIBLE FOR THE ACCURACY
OF SURVEY, STRUCTURAL OR ENGINEERING INFORMATION SHOWN ON
THESE DRAWINGS OR FOR CONSTRUCTION STARTED PRIOR TO THE
ISSUANCE OF A BUILDING PERMIT. REFER TO THE APPROPRIATE
ENGINEERING DRAWINGS BEFORE PROCEEDING WITH WORK.
AS CONSTRUCTED INVERTS MUST BE VERIFIED PRIOR TO POURING
FOOTINGS.

JARDIN DESIGN GROUP INC. HAS NOT BEEN RETAINED TO CARRY OUT
GENERAL REVIEW OF THE WORK AND ASSUMES NO RESPONSIBILITY
FOR THE FAILURE OF THE CONTRACTOR OR SUB CONTRACTOR TO
CARRY OUT THE WORK IN ACCORDANCE WITH THE CONTRACT
DOCUMENTS.

THIS DRAWING IS AN INSTRUMENT OF SERVICE, IS PROVIDED BY AND I
THE PROPERTY OF JARDIN DESIGN GROUP INC. THIS DRAWING IS NO
TO BE SCALED.

ADDED DRAWING TO SET
ISSUED FOR BUILDING TO SET
ISSUED FOR BUILDING PERMIT.

DESIGN GROUP INC

64 JARDIN DR. SUITE 3A

VAUGHAN ONT. L4K 3P3

TEL: 905 660-3377 FAX: 905 660-3713

The undersigned has reviewed and takes responsibility for this design and has the qualifications and meets the requirements set out in the Ontario Building Code to be a designer

QUALIFICATION INFORMATION

Required unless design is exampt under Division C, Subsection

EMAIL: info@jardindesign.ca

a designer

QUALIFICATION INFORMATION
Required unless design is exempt under Division C, Subsection
3.2.5 of the building code

REGISTRATION INFORMATION
Required unless design is exempt under Division C, Subsection
3.2.4 of the building code

jardin design group inc. 27763

BCIN

REAR WALK-UP EL-2

LAMPONE INVESTMENTS INC. CITY OF MARKHAM




SCALE: 3/16"=1'-0"
PROJ. No. DWG. No. 20-03 6A-2





ALL CONSTRUCTION SHALL COMPLY WITH THE ONTARIO BUILDING CODE

NO PERSON SHALL CONSTRUCT OR DEMOLISH A BUILDING OR CAUSE A BUILDING TO BE CONSTRUCTED EXCEPT IN ACCORDANCE WITH THESE CERTIFIED BUILDING PERMIT DOCUMENTS, THE BUILDING CODE ACT AND THE BUILDING CODE.

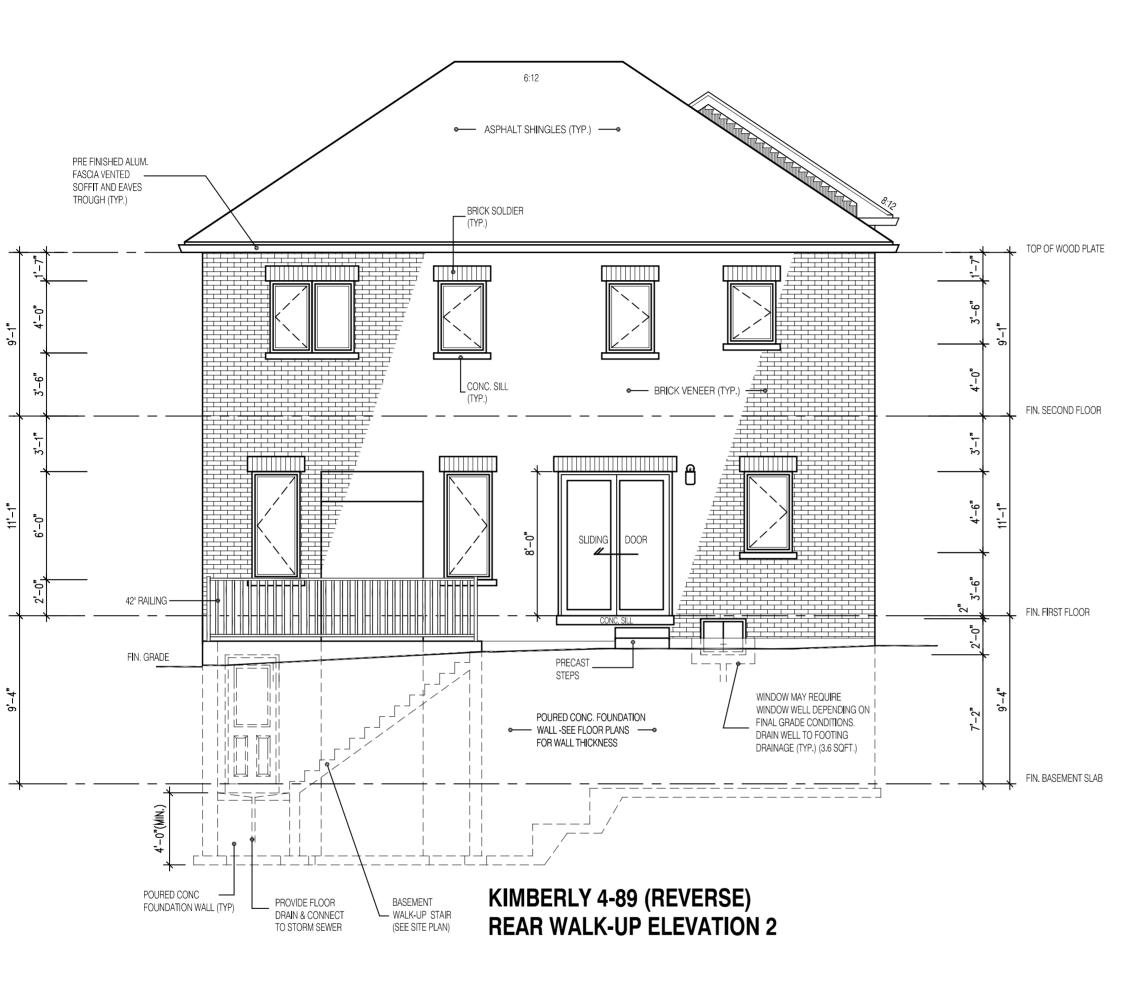

DRAWING NAME:

KIMBERLY 4-89 ELE	V2	ENERGY EFFICIENCY- A1 PACKAGE		
ELEVATION	WALL FT ²	OPENING FT ²	PERCENTAGE	
FRONT	874.00	152.00	17.39 %	
LEFT SIDE	1100.00	60.00	5.45 %	
RIGHT SIDE	1104.00	0.00	0.00 %	
REAR	901.00	171.00	18.98 %	
TOTAL	3979.00	383.00	9.63 %	

ARCHITECT

DATE: OCT 29, 2020

equirements set out in the a designer QUALIFICATION INFORMATION QUALIFICATION UNFORMATION QUALIFICATION UNIVERSITY OF THE AMERICAN CONTROL OF THE AMER Walter Botter 21031

NAME SIGNATURE BCIN It is the builder's complete responsibility to ensure that all plans submitted for approval fully comply with the Architectural Guidelines and all applicable regulations and requirements including zoning provisions and any provisions in the subdivision agreement. The Control Architect is not responsible in any way for examining or approving site (lotting) plans or working drawings with respect to any zoning or building code or permit matter or that any house can be properly built or located on its lot. REGISTRATION INFORMATION Required unless design is exempt under Division C, Subsection 3.2.4 of the building code 3.2.4 of the building code
jardin design group inc. 27763
BCIN

REAR WALK-UP EL-2 LAMPONE INVESTMENTS INC. CITY OF MARKHAM



3/16"=1'-0" 6A-3 20-03

BUILDING STANDARDS DIVISION REVIEWED FOR COMPLIANCE WITH THE ONTARIO BUILDING CODE AND THE APPLICABLE ZONING BY-LAW



2908

13.3m LOTS

KIMBERLY 4-89 (GR)

ELEVATION 2

A1 PACKAGE

O.REG. 332/12

HIS DRAWING IS AN INSTRUMENT OF SERVICE, IS PROVIDED BY AN HE PROPERTY OF JARDIN DESIGN GROUP INC. THIS DRAWING IS N

OCT. 8, 2020 ADDED DRAWING TO SET ISSUED FOR BUILDING PERMIT

64 JARDIN DR. SUITE 3A VAUGHAN ONT. L4K 3P3


TEL: 905 660-3377 FAX: 905 660-3713

The undersigned has reviewed and takes responsibility for this design and has the qualifications and meets the

EMAIL: info@jardindesign.ca

ALL CONSTRUCTION SHALL COMPLY WITH THE ONTARIO BUILDING CODE

NO PERSON SHALL CONSTRUCT OR DEMOLISH A BUILDING OR CAUSE A BUILDING TO BE CONSTRUCTED EXCEPT IN ACCORDANCE WITH THESE CERTIFIED BUILDING PERMIT DOCUMENTS, THE BUILDING CODE ACT AND THE BUILDING CODE.

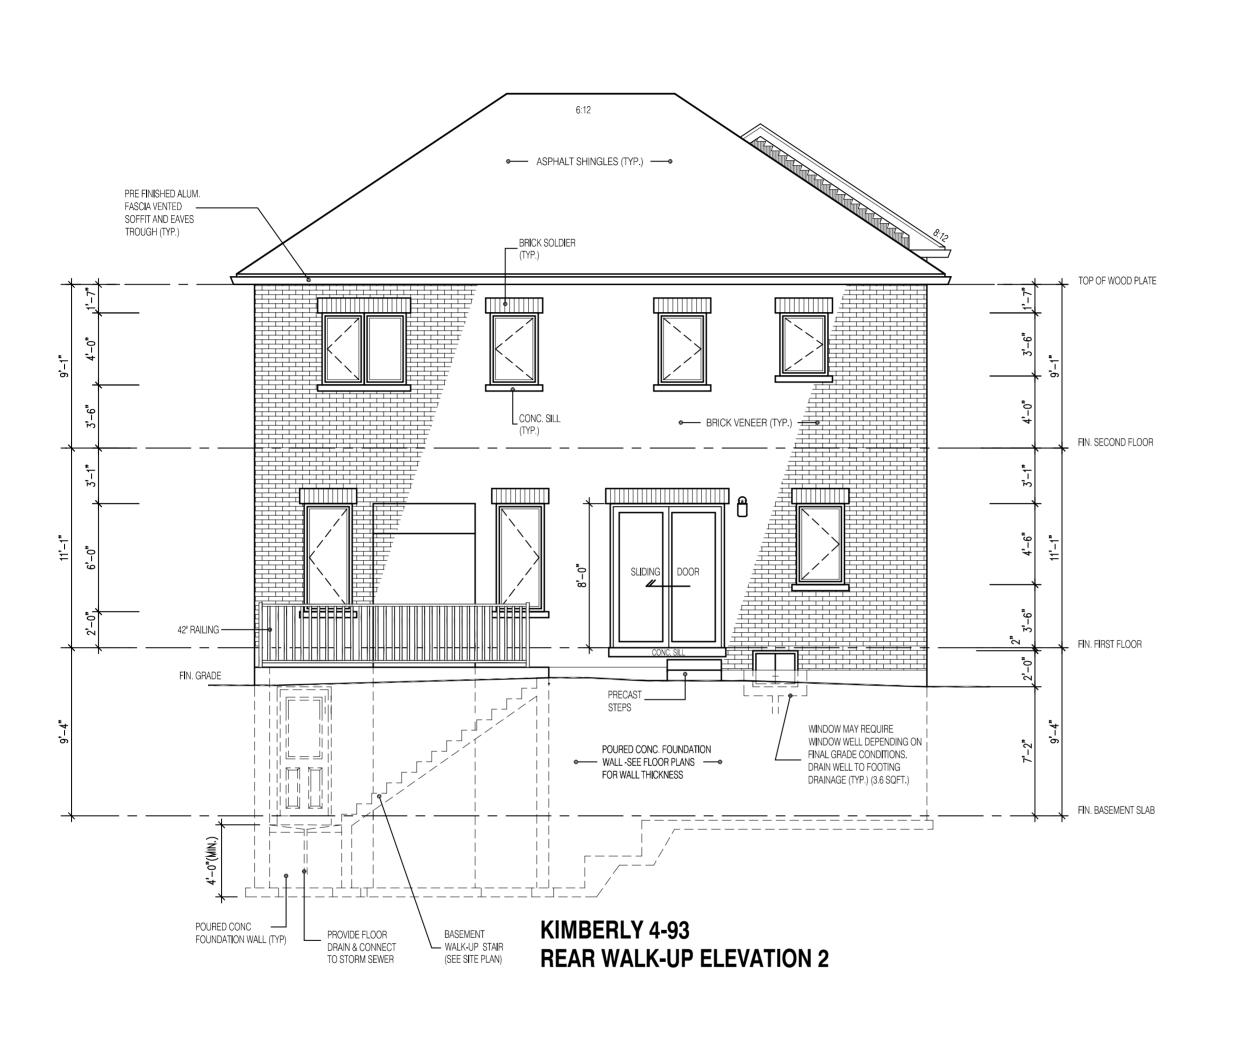

KIMBERLY 4-93 ELEV2		ENERGY EFFICIENCY- A1 PACKAGE	
ELEVATION	WALL FT ²	OPENING FT ²	PERCENTAGE
FRONT	874.00	152.00	17.39 %
LEFT SIDE	1100.00	60.00	5.45 %
RIGHT SIDE	1104.00	0.00	0.00 %
REAR	903.00	171.00	18.94 %
TOTAL	3981.00	383.00	9.62 %

It is the builder's complete responsibility to ensure that all plans submitted for approval fully comply with the Architectural Guidelines and all applicable regulations and requirements including zoning provisions and any provisions in the subdivision agreement. The Control Architect is not responsible in any way for examining or approving site (lotting) plans or working drawings with respect to any zoning or building code or permit matter or that any house can be properly built or located on its lot.

REHAM. WILLIAMS LTD., ARCHITECT

DATE: OCT 29, 2020

13.3m LOTS KIMBERLY 4-93 (GR) **ELEVATION 2** A1 PACKAGE O.REG. 332/12

2908

HIS DRAWING IS AN INSTRUMENT OF SERVICE, IS PROVIDED BY AND HE PROPERTY OF JARDIN DESIGN GROUP INC. THIS DRAWING IS N

7	
6	
5	
4	
3	
2	

OCT. 8, 2020 ADDED DRAWING TO SET ISSUED FOR BUILDING PERMIT

64 JARDIN DR. SUITE 3A VAUGHAN ONT, L4K 3P3 TEL: 905 660-3377 FAX: 905 660-3713 EMAIL: info@jardindesign.ca

The undersigned has reviewed and takes responsibility for this design and has the qualifications and meets the requirements set out in the Ontario Building Code to be a designer

QUALIFICATION INFORMATION

Walter Botter 21031

NAME SIGNATURE BCIN REGISTRATION INFORMATION Required unless design is exempt under Division C, Subsection 3.2.4 of the building code

3.2.4 of the building code

jardin design group inc. 27763

BCIN REAR WALK-UP EL-2

LAMPONE INVESTMENTS INC. CITY OF MARKHAM



3/16"=1'-0" 20-03


16A-4





ALL CONSTRUCTION SHALL COMPLY WITH THE ONTARIO BUILDING CODE

NO PERSON SHALL CONSTRUCT OR DEMOLISH A BUILDING OR CAUSE A BUILDING TO BE CONSTRUCTED EXCEPT IN ACCORDANCE WITH THESE CERTIFIED BUILDING PERMIT DOCUMENTS, THE BUILDING CODE ACT AND THE BUILDING CODE.

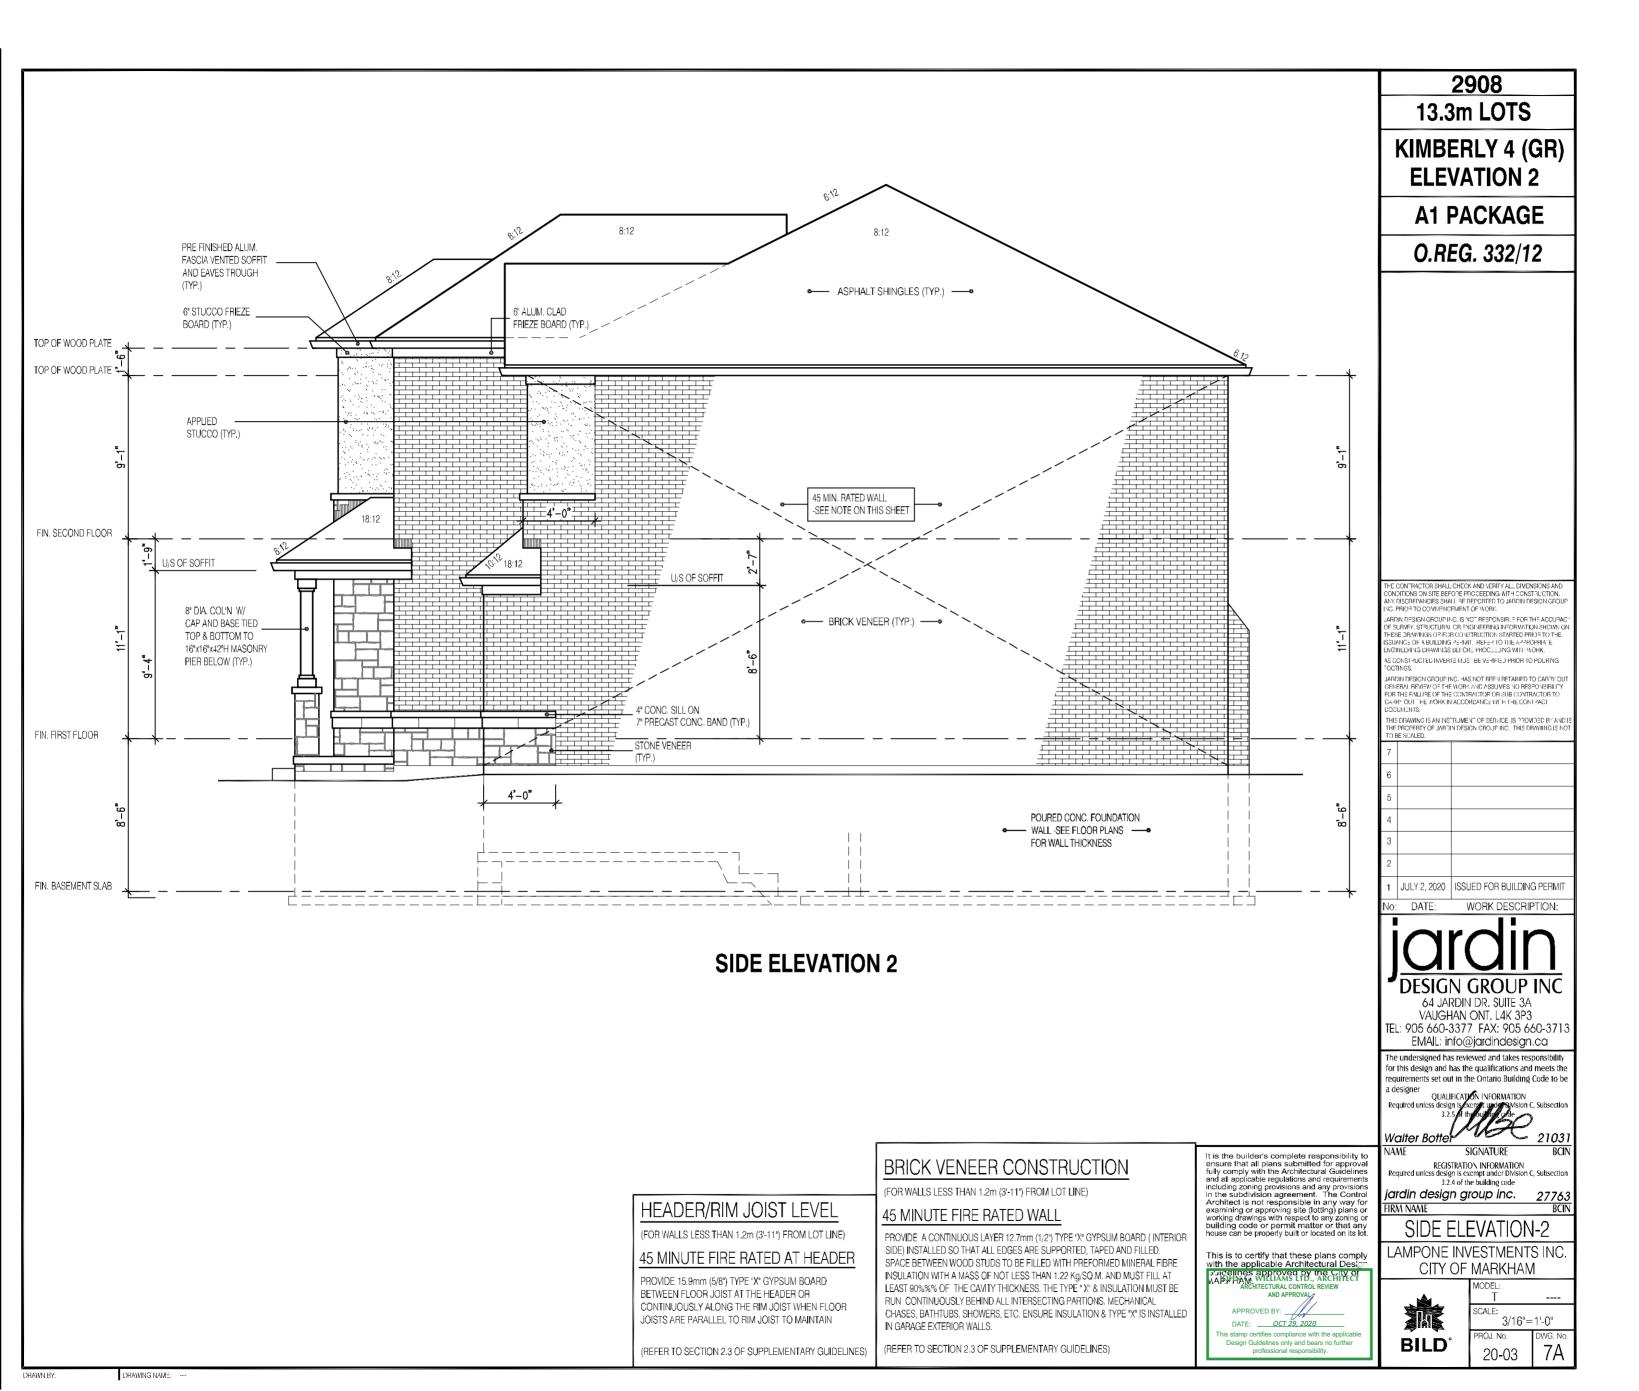




BUILDING STANDARDS DIVISION
REVIEWED FOR COMPLIANCE WITH THE ONTARIO BUILDING



Date: 02/05/

ALL CONSTRUCTION SHALL COMPLY WITH THE ONTARIO BUILDING CODE

NO PERSON SHALL CONSTRUCT OR DEMOLISH A BUILDING OR CAUSE A BUILDING TO BE CONSTRUCTED EXCEPT IN ACCORDANCE WITH THESE CERTIFIED BUILDING PERMIT DOCUMENTS, THE BUILDING CODE ACT AND THE BUILDING CODE.

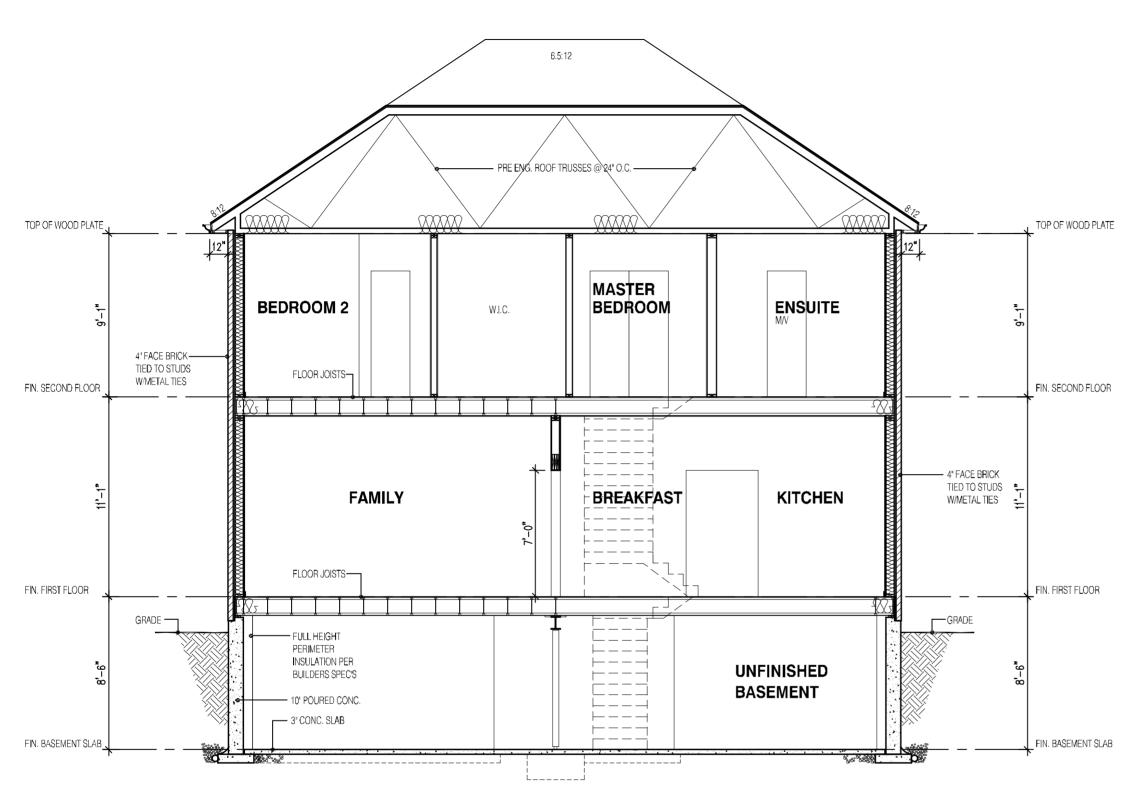

SECTION ELEVATION 2

2908 13.3m LOTS KIMBERLY 4 (GR) ELEVATION 2 A1 PACKAGE

O.REG. 332/12

STRUDET INC.



FOR STRUCTURE ONLY

THE CONTRACTOR SHALL CHECK AND VERIFY ALL DIVENSIONS AND CONDITIONS ON SITE BEFORE PROCEEDING WITH CONSTRUCTION. ANY DISCREPANCIES SHALL BE REPORTED TO JAIDIN DESIGN GROUNG PRIOR TO COMMENCEMENT OF WORK.

JABRIN DESIGN ORGULPING, IS NOT RESPONSIBLE FOR THE ACQUEA OF SURVEY, STRUCTURAL OR ENGINEERING INFORMATION SHOWN THESE DRAWINGS OF FOR CONSTRUCTION STARTED PRICE TO THE ISSUANCE OF A BUILDING FEMAL. HEFER TO THE APPACHMATE LAGRICHMAG DRAWINGS BEFORE PROCEEDING WITH MORK, AS CONSTRUCTED INVERTS MUST BE VEHIFIED PRICH TO POURING FOOTINGS.

JARDIN DESIGN GROUP INC. HAS NOT REFE RETAINED TO CARRY SUIT CENERAL REPUY OF THE WORK AND ASSUES NO RESPONSIBILITY FOR THE FAILURE OF THE CONTRACTOR OR SUB-CONTRACTOR TO CARRY OUT THE MORK IN ACCORDANCE VITH THE CONTRACT

7 6 5 4 3 2 2 1 JULY 2, 2020 ISSUED FOR BUILDING PERMIT

o: DATE: WORK DESCRIPTION:



64 JARDIN DR. SUITE 3A VAUGHAN ONT. L4K 3P3 TEL: 905 660-3377 FAX: 905 660-3713 EMAIL: info@jardindesign.ca

The undersigned has reviewed and takes responsibility for this design and has the qualifications and meets the requirements set out in the Ontario Building Code to be a designer

a designer
QUALIFICATION INFORMATION
Required unless design is exempt under Stylsion C, Subsection
3.2.5 of the outline of the
Walter Botter 21031

NAME SIGNATURE BCI

REGISTRATION INFORMATION
Required unless design is exempt under Division C, Subsection
3.2.4 of the building code

jardin design group inc. 27763 FIRM NAME BCIN

SECTION ELEV.-2 LAMPONE INVESTMENTS INC. CITY OF MARKHAM

BILD

MODEL: T ----SCALE: 3/16"=1'-0" PROJ. No. DWG. No. 20-03 8A



Date: 02/05/

ALL CONSTRUCTION SHALL COMPLY WITH THE ONTARIO BUILDING CODE

NO PERSON SHALL CONSTRUCT OR DEMOLISH A BUILDING OR CAUSE A BUILDING TO BE CONSTRUCTED EXCEPT IN ACCORDANCE WITH THESE CERTIFIED BUILDING PERMIT DOCUMENTS, THE BUILDING CODE ACT AND THE BUILDING CODE.