STRIP FOOTINGS FOR SINGLES AND SEMIS UP TO 2 STOREY

201Y61 CONCRETE STRIP FOOTINGS BELOW FOUNDATION WALLS. 24"x8" CONCRETE STRIP FOOTINGS BELOW PARTY WALLS.

100 KPa NATIVE SOIL

22'x8" CONCRETE STRIP FOOTINGS BELOW FOUNDATION WALLS. 28'x10' CONCRETE STRIP FOOTINGS BELOW PARTY WALLS

28'x8" CONCRETE STRIP FOOTINGS WITH REINFORCING BELOW PARTY WALLS

90 KPa ENGINEERED FILL SOIL

CING BELOW FOUNDATION WALLS 24"x8" CONCRETE STRIP FOOTINGS 30"x8" CONCRETE STRIP FOOTINGS WITH REINFORCING BELOW PARTY WALLS.

GENERAL NOTE:

100 KPa NATIVE SOIL

 $F1 = 46' \times 16' \times 20'$ CONCRETE PAD

F2 = 38"x38"x18" CONCRETE PAD

F3 = 32"x32"x14" CONCRETE PAD

F4 = 26"x26"x12" CONCRESE PAD

5 = 17"x17"x8" CONCRETE PAD

ASSUMED 120/100 KPa NATIVE SOIL BEARING CAPACITY OR 90 KPa FOR ENGINEERED FILL, TO BE VERIFIED ON SITE. REFER TO ENGINEERED FILL FOOTING DETAIL FOR REINFORCEMENT

(REFER TO ENG. FILL FOOTING DETAIL)

AREA CALCULATIONS EL-1

FIRST FLOOR AREA SECOND FLOOR AREA	=	
TOTAL FLOOR AREA	=	2900 Sq. Fi
ADD OPEN AREAS ADD FIN. BASEMENT AREA	=	8 Sq. Ft 0 Sq. Ft
GROSS FLOOR AREA	=	2908 Sq. Fi
GROUND FLOOR COVERAGE	=	1286 Sq. Ft
GARAGE COVERAGE / AREA	=	390 Sq. Ft
PORCH COVERAGE / AREA	=	44 Sq. Ft
COVERAGE W/ PORCH	=	1720 Sq. Fr

COVERAGE W/O PORCH

= 159.8 Sq. m.

= 155.7 **S**q. m.

= 1676 Sq. Ft.

AREA CALCULATIONS EL-2 FIRST FLOOR AREA 1286 Sq. Ft. SECOND FLOOR AREA = 1614 Sq. F

= 2900 Sq. F TOTAL FLOOR AREA ADD OPEN AREAS ADD FIN. BASEMENT AREA = 0 Sq. F GROSS FLOOR AREA = 2908 sq. Ft. GROUND FLOOR COVERAGE = 1286 Sq. Ft GARAGE COVERAGE / AREA = 390 Sq. Ft PORCH COVERAGE / AREA = 44 Sq. Ft. 1720 Sq. Ft. 159.8 Sq. m. 1676 Sq. Ft

KIMBERLY 4 ELEV.-1

KIMBERLY 4 ELEV.-2

KIMBERLY 4 ELEV.-3

LEVATION

F" SIDE

GHT SIDE

TOTAL

I FVATION

F SIDE

GHT SIDE

OTAL

LEVATION

F SIDE

GHT SIDE

155.7 Sq. m

WALL FT²

867.00

1096.00

1096.00

828.00

3887.00

WALL FT2

874.00

1100.00

1104.00

828.00

3906.00

WALL FT2

866 00

1100.00

1104.00

828.00

3898.00

AREA CALCULATIONS EL-3 FIRST FLOOR AREA

SECOND FLOOR AREA	=	1629 Sq. Ft.
TOTAL FLOOR AREA	=	2915 Sq. Ft.
ADD OPEN AREAS	=	8 Sq. Ft.
ADD FIN. BASEMENT AREA	=	0 Sq. Ft.
GROSS FLOOR AREA	=	2923 Sq. Ft.
GROUND FLOOR COVERAGE	=	1286 Sq. Ft.
GARAGE COVERAGE / AREA	=	390 Sq. Ft.
PORCH COVERAGE / AREA	=	50 Sq. Ft.
COVERAGE W/ PORCH	=	1726 Sq. Ft.
	=	160.3 Sq. m.
COVERAGE W/O PORCH	=	1676 Sq. Ft.

ENERGY EFFICIENCY- A1 PACKAGE

ENERGY EFFICIENCY- A1 PACKAGE

ENERGY EFFICIENCY- A1 PACKAGE

OPENING FT²

147.00

60.00

0.00

147.00

354.00

OPENING FT²

60.00

0.00

147.00

359.00

OPENING FT²

150.00

60.00

0.00

147.00

357.00

155.7 Sa. m.

PERCENTAGE

16.96 %

5.47 %

0.00 %

17.75 %

9.11 %

PERCENTAGE

5.45 %

0.00 %

17 75 %

9.19 %

PERCENTAGE

17.32 %

5.45 %

0.00 %

17.75 %

9.16 %

2908 13.3m LOTS KIMBERLY 4 (GR) **ELEVATION 1,2 & 3** A1 PACKAGE

O.REG. 332/12

20.130034.000.00.CM

BUILDING STANDARDS DIVISION

REVIEWED FOR COMPLIANCE WITH THE ONTARIO BUILDING

CODE AND THE APPLICABLE ZONING BY-LAW

ALL CONSTRUCTION SHALL COMPLY WITH THE ONTARIO BUILDING CODE

NO PERSON SHALL CONSTRUCT OR DEMOLISH A BUILDING OR CAUSE A BUILDING TO BE CONSTRUCTED EXCEPT IN ACCORDANCE WITH THESE CERTIFIED BUILDING PERMIT DOCUMENTS, THE

NOTE: THE PROPOSED DEVELOPMENT IS SUBJECT TO COMPLIANCE WITH ALL APPLICABLE PROVISIONS OF THE ZONING BY-LAW AND ALL OTHER APPLICABLE LAWS INCLUDING THE PROVISIONS OF A SITE PLAN AND / OR SUBDIVISION AGREEMENT WHICH MAY OR MAY NOT BE REGISTERED ON TITLE

PAD FOOTING

120 KPa NATIVE SOIL

=1 = 42"x42"x18" CONCRETE PAD

=2 = 36"x36"x16" CONCRETE PAD F3 = 30"x30"x12" CONCRETE PAD

F2 = 40"x40"x16" CONCRETE PAD F4 = 24"x24"x12" CONCRETE PAD F5 = 16"x16"x8" CONCRETE PAD

F3 = 34"x34"x14" CONCRETE PAD $F4 = 26 \times 28 \times 12$ " CONCRETE PAD 55 = 18"x18"x8" CONCRETE PAR

98 KPa ENGINEERED FILL SOIL

F1 = 48*x48"x20" CONCRETE PAD

(REFER TO FLOOR PLAN FOR UNUSUAL SIZE PADS NOT ON CHART)

NOTE:

WHEN VENEER CUT IS GREATER THAN 26" A 10" POURED CONC. FOUNDATION WALL IS REQUIRED.

NOTE:

ALL GARAGE SLABS, PORCH SLABS, STAIRS (EXPOSED CONC. FLAT WORK) TO BE 32 MPa WITH 5-8% AIR ENTRAITMENT

BRICK VENEER LINTELS:

 $WL5 = 6" \times 4" \times 3 \times (150 \times 100 \times 10) + 2 - 2" \times 12" SPR.$

WI 1 = $3.1 \cdot 2'' \times 3.1 \cdot 2'' \times 1 \cdot 4'' \cdot (90 \times 90 \times 6) - 2 \cdot 2'' \times 8'' \text{ SPB}$ $WI.6 = 5^{\circ} \times 3.1 \times 2^{\circ} \times 5 \times 16^{\circ} (125 \times 90 \times 8) - 2 \cdot 2^{\circ} \times 12^{\circ} SPR$ WL2 = $4'' \times 3 \times 2'' \times 5 \times 6'' \times (100 \times 90 \times 8) + 2 - 2'' \times 8'' \text{ SPR}$. $WL3 = 5" \times 3 \times 1/2" \times 5/16" (125x90x8) + 2-2" \times 10" SPR.$ $WL4 = 6'' \times 3 \times 1/2'' \times 3/8'' (150x90x10) + 2-2'' \times 12'' SPR.$

WL7 = 5° x 3 1\2" x 5\16" (125x90x8) + 3-2" x 10" SPR. WL8 = 5° x 3 1\2" x 5\16" (125x90x8) + 3-2" x12" SPR. $WL9 = 6" \times 4" \times 3 \times 8" (150 \times 100 \times 10) + 3 - 2" \times 12" SPR.$

WOOD LINTELS:

WB1 = 2-2" x 8" SPRUCE BEAM WB6 = 3-2" x 12" SPRUCE BEAM WB2 = 3-2" x 8" SPRUCE BEAM WB7 = 5-2" x 12" SPRUCE BEAM

WB10 = 4-2" x 8" SPRUCE BEAM WB3 = 2-2" x 10" SPRUCE BEAM WB4 = 3-2" x 10" SPRUCE BEAM WB11 = 4-2" x 10" SPRUCE BEAM WB5 = 2-2" x 12" SPRUCE BEAM

STEEL LINTELS:

 $L1 = 3 \frac{1}{2} \times 3 \frac{1}{2} \times \frac{1}{4} (90 \times 90 \times 6)$ $L4 = 6'' \times 3 \frac{1}{2} \times 3 \frac{1}{2} \times 3 \frac{1}{2} \times 3 \times 90 \times 10$ L2 = 4" x 3 1\2" x 5\16" (100 x 90 x 8) L5 = 6" x 4" x 3\8" (150 x 100 x 10) $L3 = 5" \times 3 \text{ 1/2"} \times 5 \text{ 16"} (125 \times 90 \times 8)$ $L6 = 7" \times 4" \times 3 \text{ 8"} (180 \times 100 \times 10)$

LAMINATED VENEER LUMBER (LVL BEAMS)

= 2-1 3/4" x 7 1/4" (2-45x184) = 3-1 3/4" x 7 1/4" (3-45x184) $LVL3 = 4-13/4" \times 71/4" (4-45x184)$ LVL4A = 1-1 3/4" x 9 1/2" (1-45x240) LVL4 = 2-1 3/4" x 9 1/2" (2-45x240) $LVL5 = 3-1.3/4" \times 9.1/2" (3-45x240)$ LVL5A = 4-1 3/4" x 9 1/2" (4-45x240) LVL6A= 1-1 3/4" x 11 7/8" (1-45x300 2-1 3/4" x 11 7/8" (2-45x300)

LVL7A= 4-1 3/4" x 11 7/8" (4-45x300)

LVL8 = 2-1 3/4" x 14" (2-45x356)

3-1 3/4" x 11 7/8" (3-45x300

3-1 3/4" x 14" (3-45x356)

LVL1A = 1-1 3/4" x 7 1/4" (1-45x184)

2-2'x6" STUD WALL NAILED TOGETHER AND SPACED @12" O.C. FULL HT C/W SOLID BLOCKING 4'-0" O.C. VERTICAL AND 7/16" EXT. PLYWOOD SHEATHING.


Certified Model reviewed and approved based on

Where site conditions differ, a lot-specific revision

footing design for 120 kPa native soil.

approved prior to pouring of footings.


application is required to be submitted and

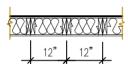

MAXIMUM HEIGHT OF WALL FOR THIS DETAIL IS 18'-0" AND MAXIMUM SUPPORTED LENGTH OF TRUSS IS 40'-0"

TWO STOREY HEIGHT WALL DETAIL

2 - 1 1/2" x 5 1/2" TIMBERSTRAND (LSL) 1.5E STUD WALL GLUED AND NAILED TOGETHER AND SPACED MAX. @10"O.C. FULL HT C/W SOLID BLOCKING MAX. 8'-0"O.C. VERTICAL AND 7/16" EXT. OSB SHEATHING.

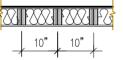

MAXIMUM HEIGHT OF WALL FOR THIS DETAIL IS 20'-2" AND MAXIMUM SUPPORTED LENGTH OF TRUSS IS 40'-0"

TWO STOREY HEIGHT WALL DETAIL

NOTE:

THESE DRAWINGS ARE TO BE READ IN CONJUNCTION WITH ENGINEER APPROVED ROOF TRUSS DRAWINGS BY MANUFACTURER

Door Schedule

NO.	WIDTH	HEI0 8' TC CEII		HEIGH ⁻ 10' OR CEILING	MORE	TYPE
1	2'-10"	6'-8"	(865x2033)	8'-0"	(865x2439)	INSULATED ENTRANCE DOOR
1a	2'-8"	6'-8"	(815x2033)	8'-0"	(815x2439)	INSULATED FRONT DOORS
2	2'-8'	6'-8"	(815x2033)	8'-0"	(815x2439)	WOOD & GLASS DOOR
3	2'-8'	6'-8 x 1-3/4"	(815x2033x45)	8'-0" x 1-3/4"	(815x2439x45)	EXTERIOR SLAB DOOR
4	2'-8'	6'-8" x 1-3/8"	(815x2033x35)	8'-0" x 1-3/8"	(815x2439x35)	INTERIOR SLAB DOOR
5	2'-6'	6'-8" x 1-3/8"	(760x2033x35)	8'-0" x 1-3/8"	(760x2439x35)	INTERIOR SLAB DOOR
6	2'-2"	6'-8" x 1-3/8"	(660x2033x35)	8'-0" x 1-3/8"	(660x2439x35)	INTERIOR SLAB DOOR
7	1'-6"	6'-8" x 1-3/8"	(460x2033x35)	8'-0" x 1-3/8"	(460x2439x35)	INTERIOR SLAB DOOR
8	3'-0"	6'-8" x 1-3/8"	(915x2033x35)	8'-0" x 1-3/8"	(915x2439x35)	INTERIOR SLAB DOOR

SPACE CONVENTIONAL FLOOR JOISTS @: 12" O.C. BELOW ALL CERAMIC TILE AREAS. PROVIDE 1 ROW BRIDGING FOR SPANS OF 5'-7', 2 ROWS FOR SPANS GREATER THAN I

THESE DRAWINGS ARE TO BE READ IN CONJUNCTION WITH ENGINEER APPROVED LOOR TRUSS LAYOUT BY MANUFACTURER

NOTE:

PLANS NOT DRAWN TO ACTUAL GRADE. REFER TO FINAL GRADING PLAN

It is the builder's complete responsibility to ensure that all plans submitted for approval fully comply with the Architectural Guidelines and all applicable regulations and requirements including zoning provisions and any provisions in the subdivision agreement. The Control Architect is not responsible in any way for examining or approving site (lotting) plans or working drawings with respect to any zoning or building code or permit matter or that any house can be properly built or located on its lot.

This is to certify that these plans comply with the applicable Architectural Design Guidelines approved by the City of MARKHAM.





FOR STRUCTURE ONLY

/ DISCREPANCIES SHALL BE REPORTED T PRIOR TO COMMENCEMENT OF WORK.

INININ PSIKO GRCUPINO, IS NOT RESPONSIRI. E FOR THE ACQUISIN PSIKO GRCUPINO, IS NOT RESPONSIRI. E FOR THE ACQUISINE PSIKO STRUCTURAL OR ENGINEERING INFORMATION SHOW BEE DRAWINGS OF EUR CONSTRUCTION STARTED PRIOR TO TURNOS OF A BUILDING 2-3-MILL REFE 21TO THE A-PROPHATE GINEEHING DRAWINGS BEFORE PHOCES JING WITH WORK. CONSTITUCTED INVERTS MUST BE VEHIFIED PHIOR TO POURING TINGS.

IERAL FRYEW OF THE WORK AND ASSUMES NO RESPONSIBILITIES.

ITHE FAILURE OF THE CONTRACTOR OR SUB-CONTRACTOR TO RY OUT THE WORK IN ACCORDANCE WITH THE CONTRACT

AND DECIVOR'S REPRESENCE AND SERVICE. IS PROVIDED BY AND THE PROPERTY OF JACKLEY INC. THIS DRAWING IS NO

TO BE SCALED.			
7			
6			
5			
4			
3			
2			
1	JULY 2, 2020	ISSUED FOR BUILDING PERMIT	

WORK DESCRIPTION:


64 JARDIN DR. SUITE 3A VAUGHAN ONT. L4K 3P3 TEL: 905 660-3377 FAX: 905 660-371 EMAIL: info@jardindesign.ca

he undersigned has reviewed and takes responsibility for this design and has the qualifications and meets the irements set out in the Ontario Building Code to b QUALIFICATION INFORMATION

Required unless design is exempt, upda application C, Subsection 3.2.5 of the building crite

Walter Botter 21031 SIGNATURE NAME

REGISTRATION INFORMATION

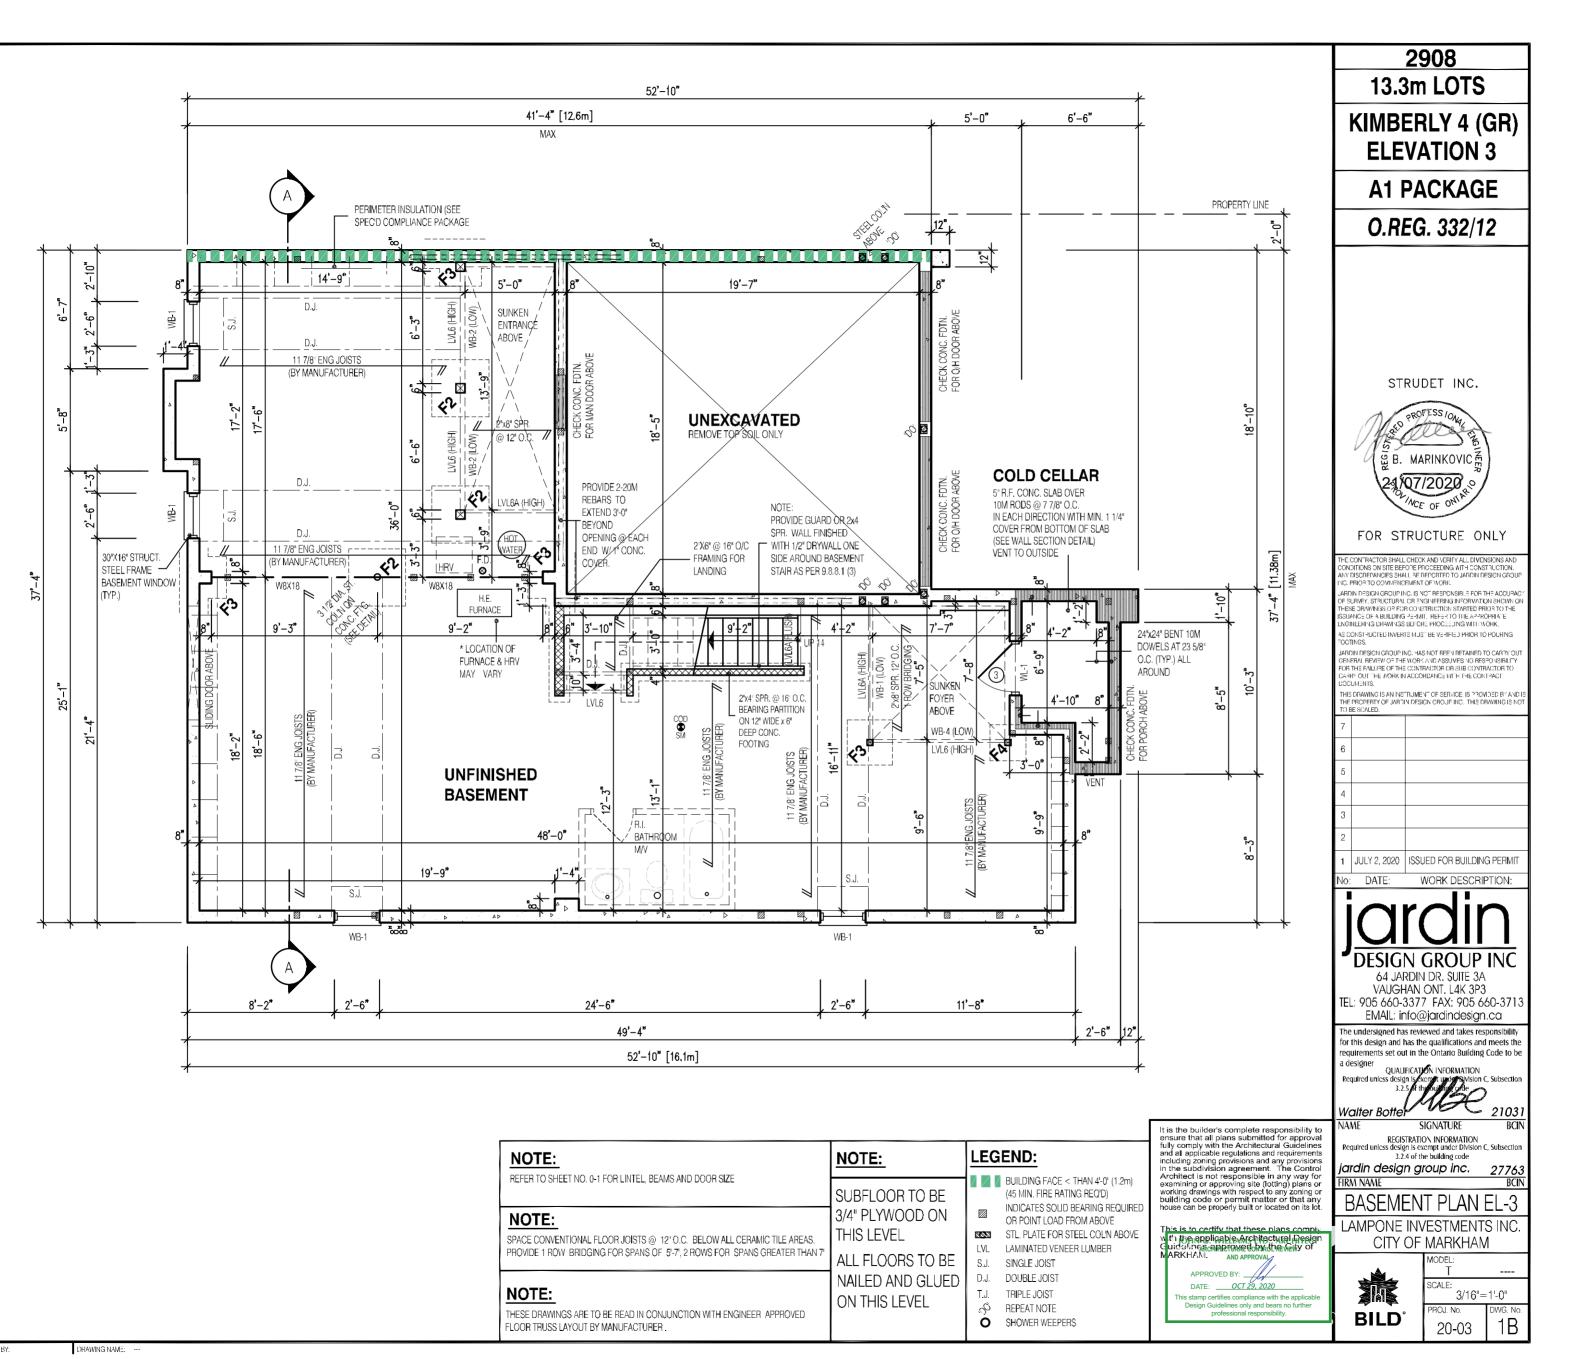




REVIEWED FOR COMPLIANCE WITH THE ONTARIO BUILDING



Date: 02/05/2

ALL CONSTRUCTION SHALL COMPLY WITH THE ONTARIO BUILDING CODE

NO PERSON SHALL CONSTRUCT OR DEMOLISH A BUILDING OR CAUSE A BUILDING TO BE CONSTRUCTED EXCEPT IN ACCORDANCE WITH THESE CERTIFIED BUILDING PERMIT DOCUMENTS, THE BUILDING CODE ACT AND THE BUILDING CODE.

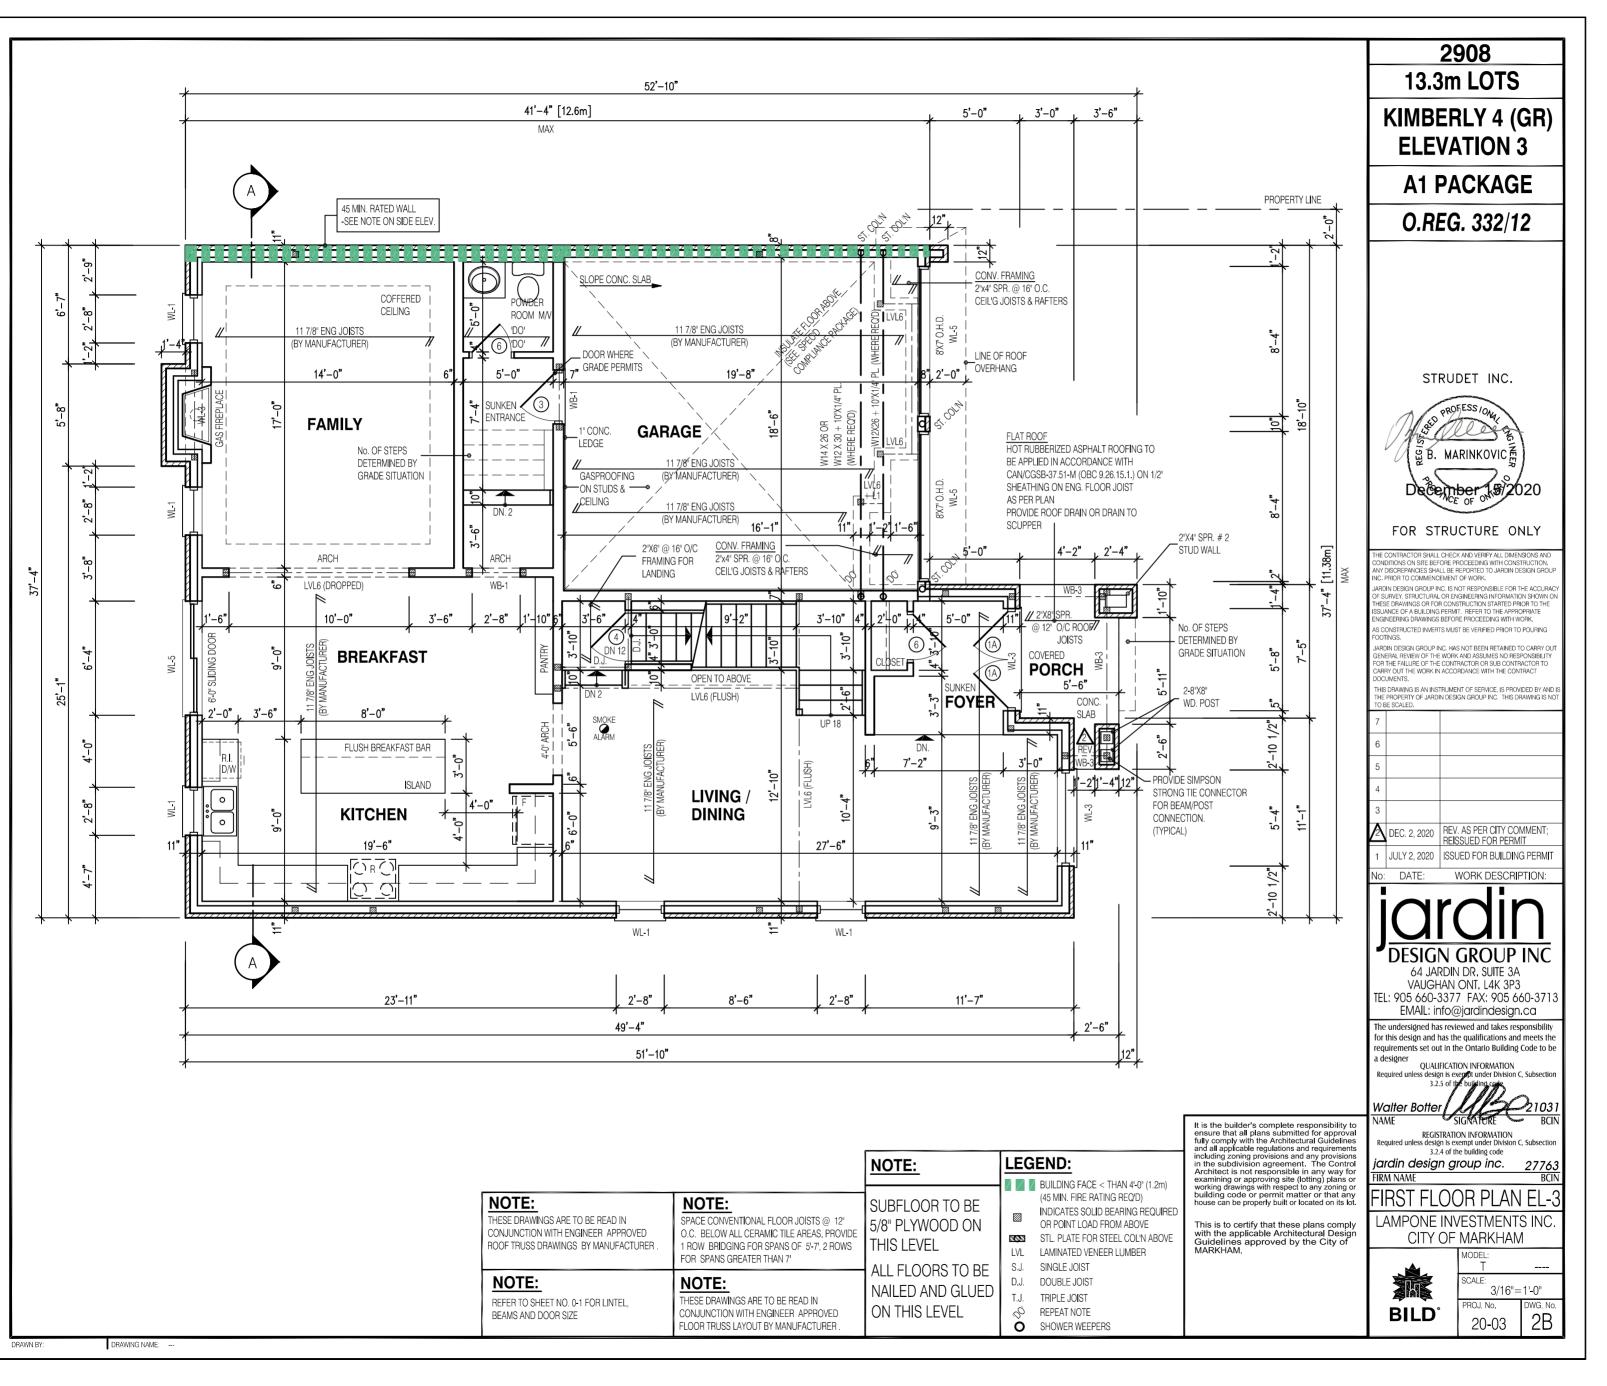




REVIEWED FOR COMPLIANCE WITH THE ONTARIO BUILDING CODE AND THE APPLICABLE ZONING BY-LAW



Date: 02/05/2

ALL CONSTRUCTION SHALL COMPLY WITH THE ONTARIO BUILDING CODE

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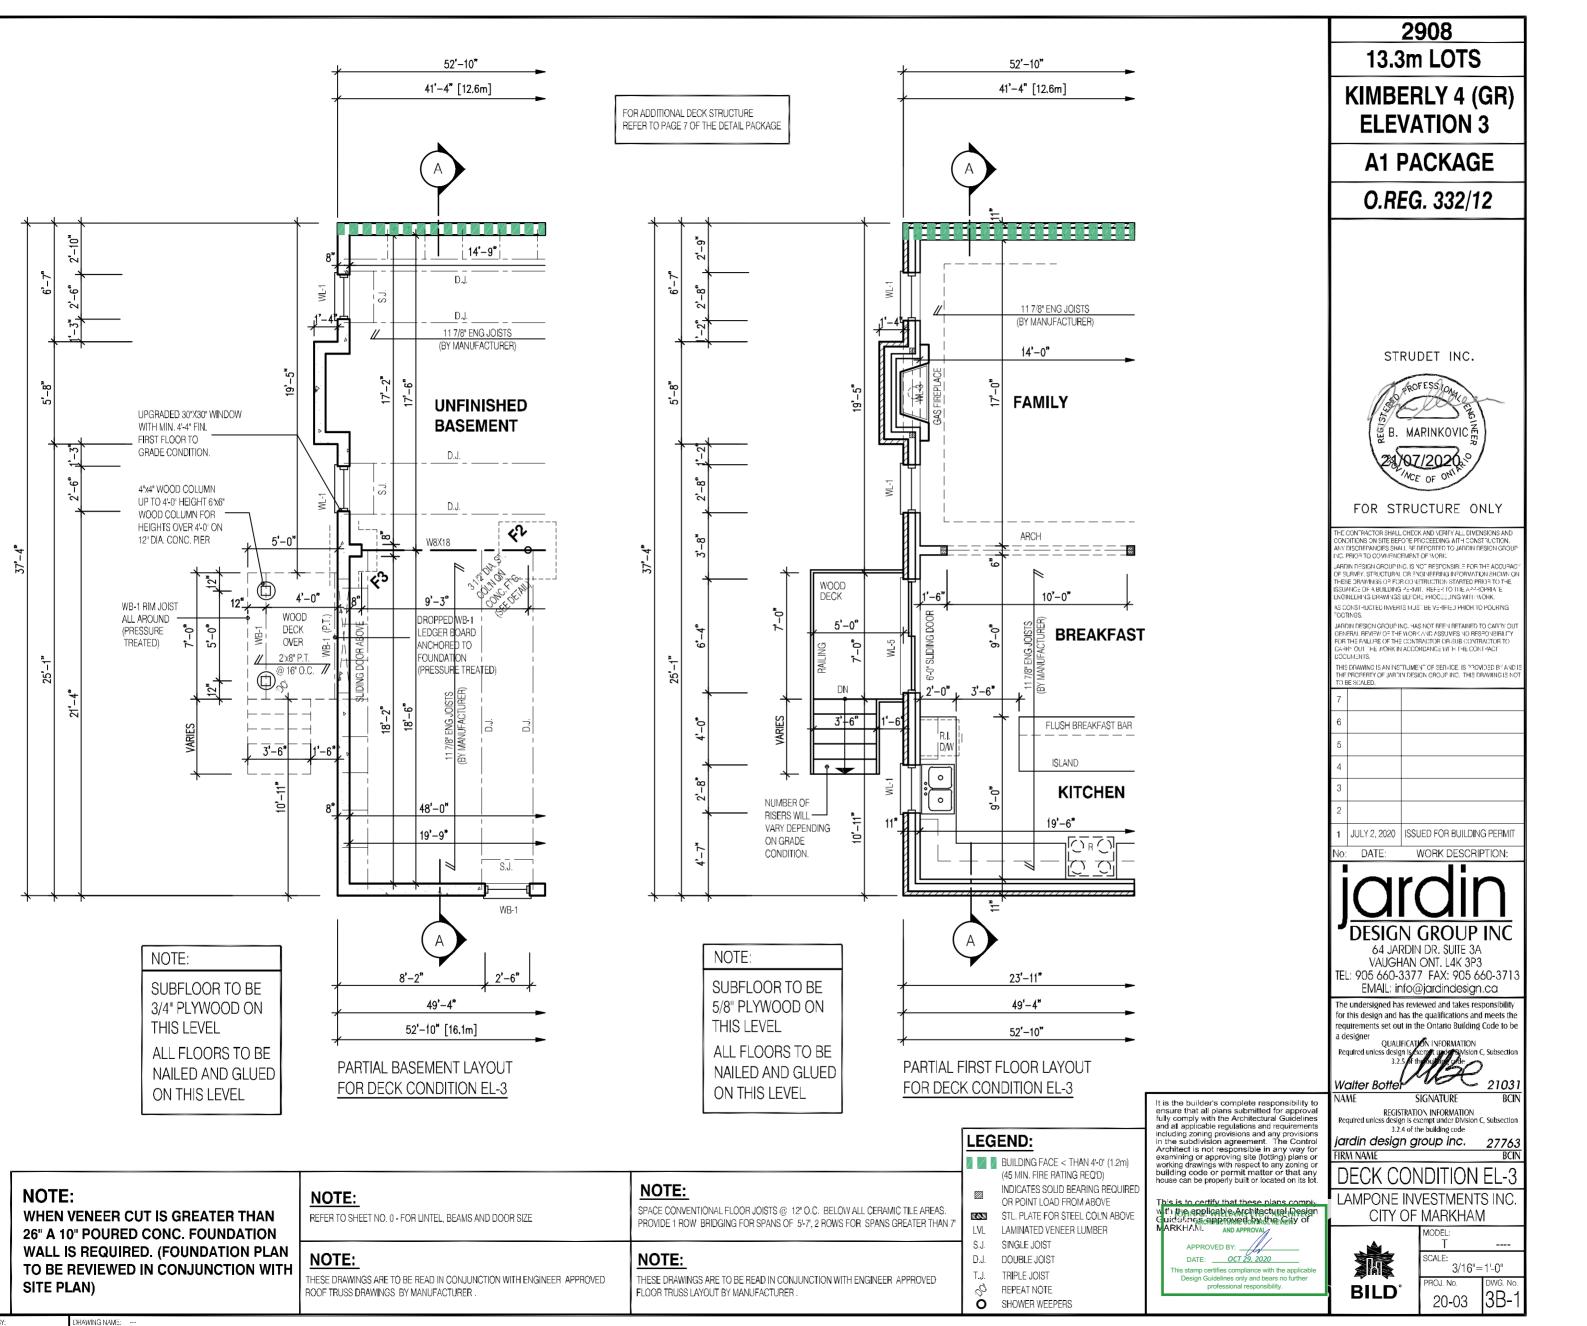


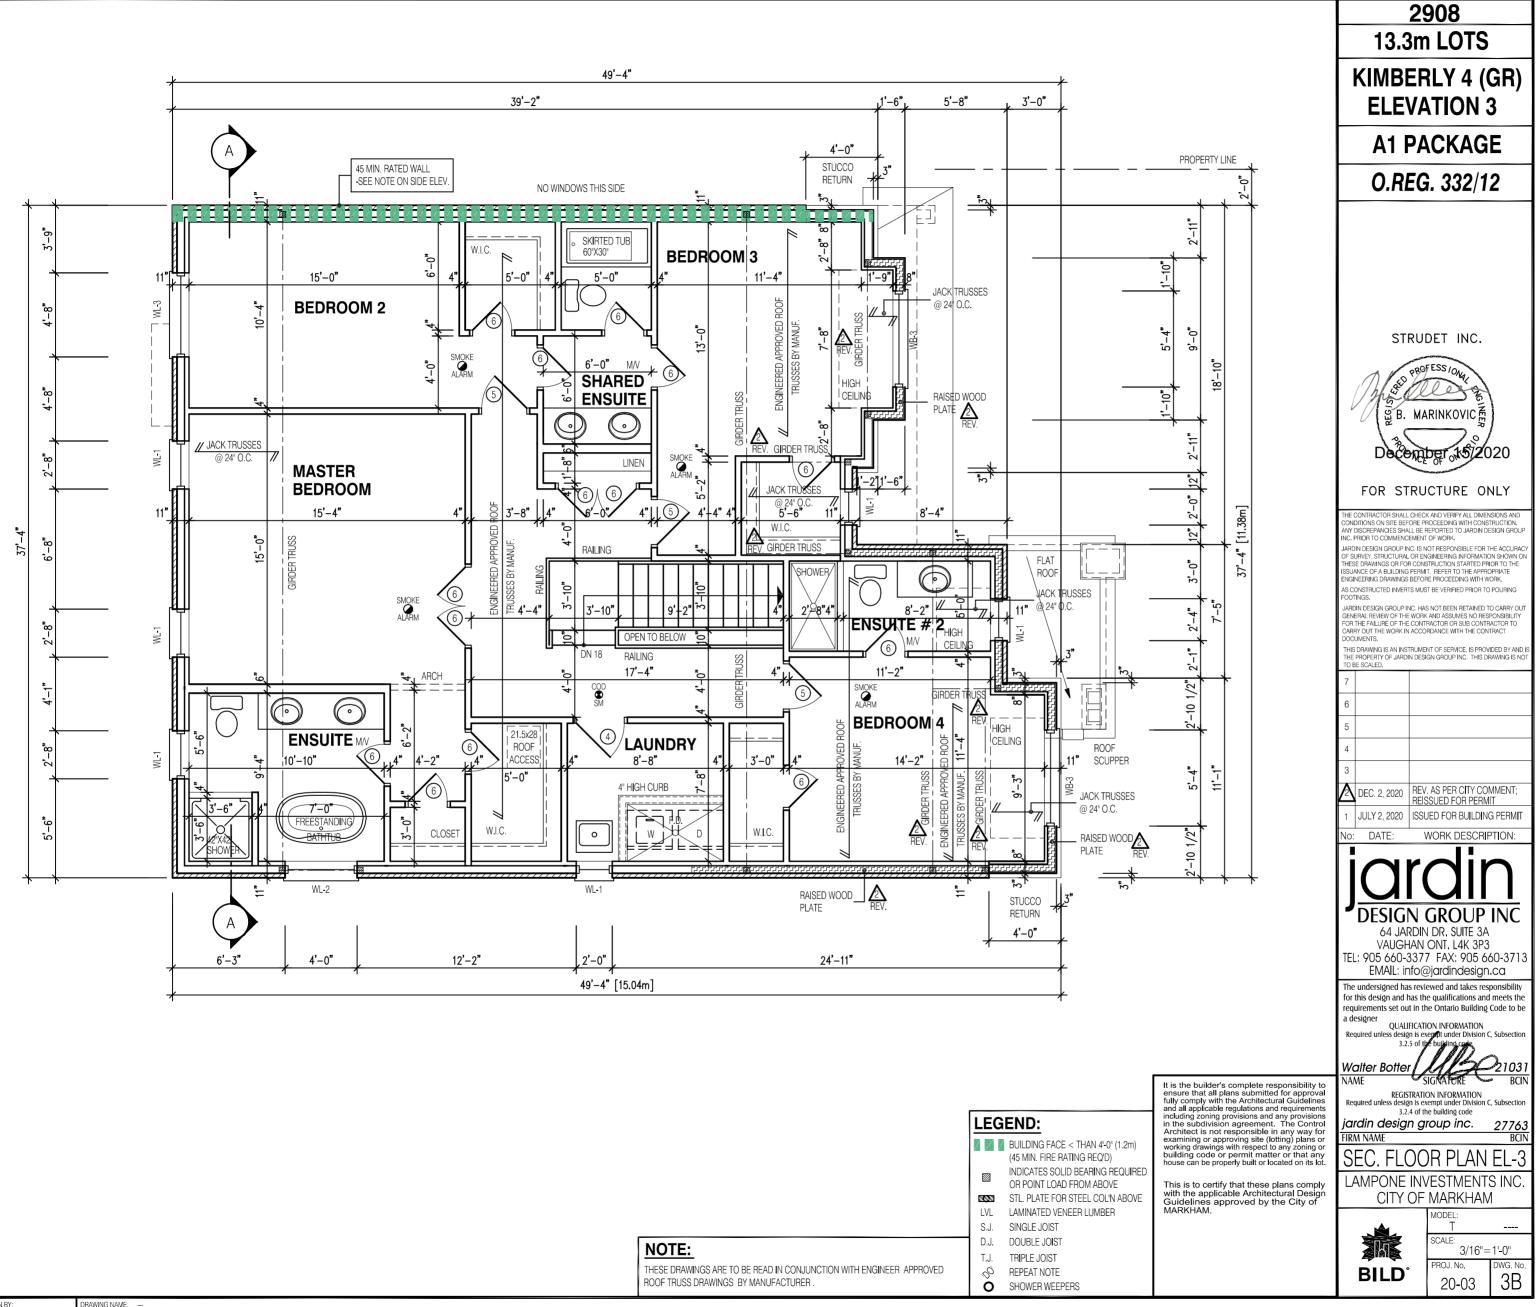REVIEWED FOR COMPLIANCE WITH THE ONTARIO BUILDING CODE AND THE APPLICABLE ZONING BY-LAW



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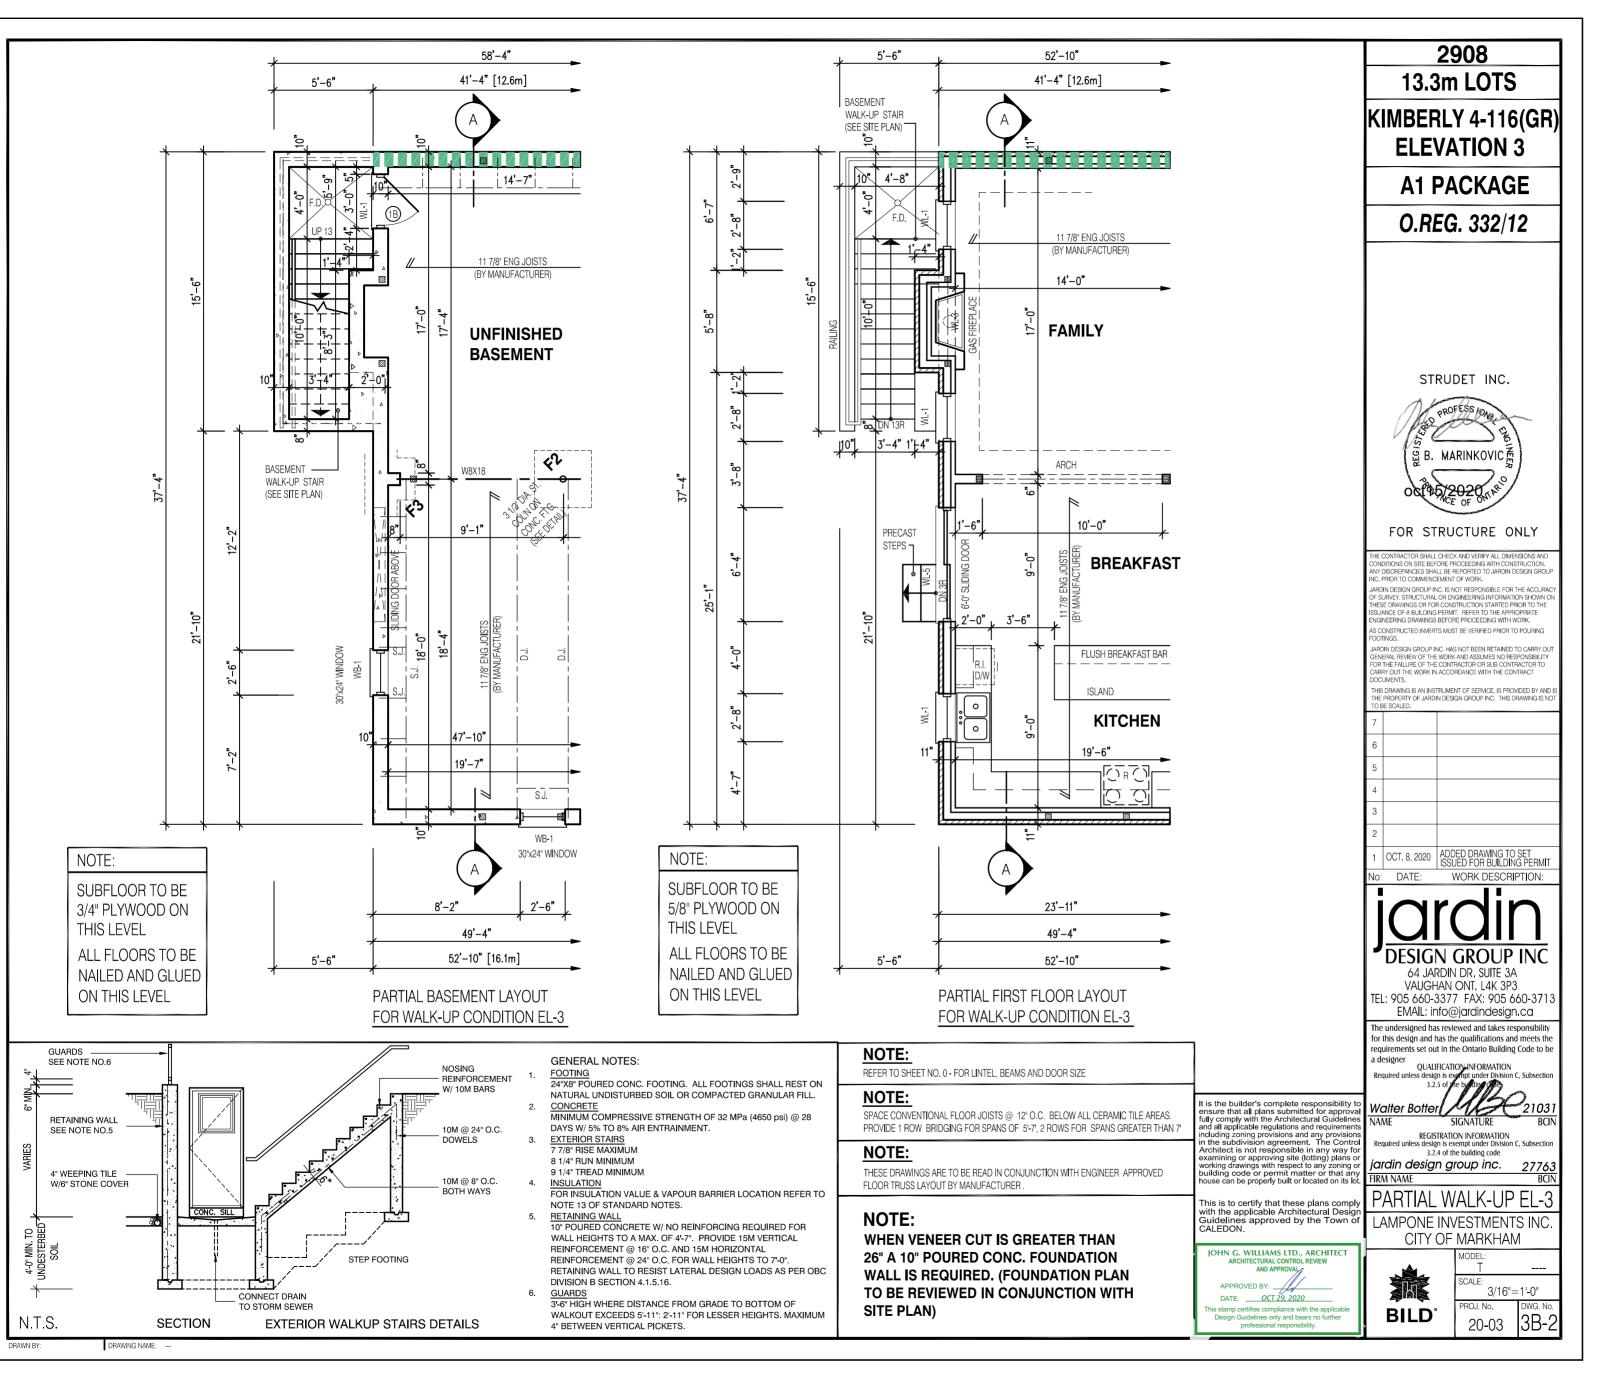
CITY OF WARKHAM
BUILDING STANDARDS DIVISION



Date: 02/05/2

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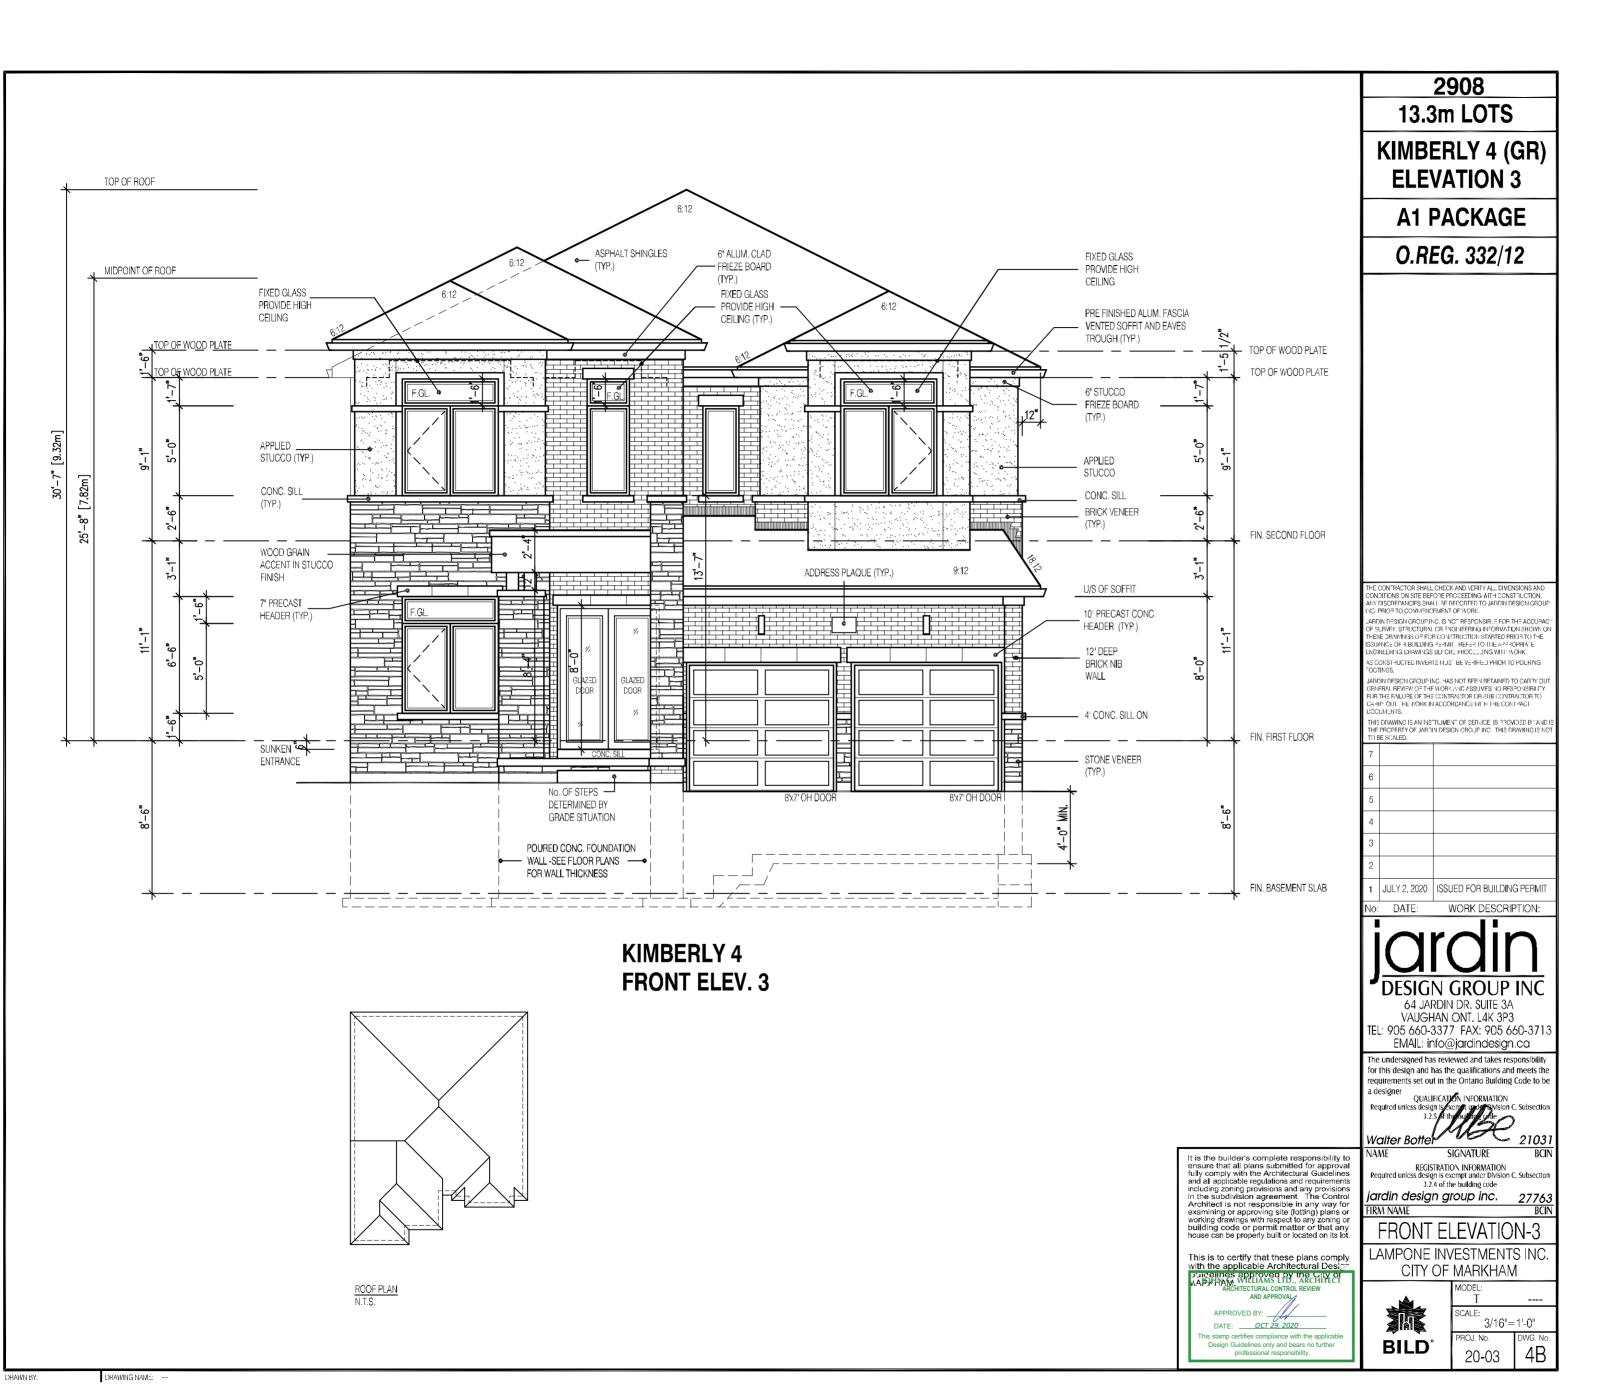


CODE AND THE APPLICABLE ZONING BY-LAW



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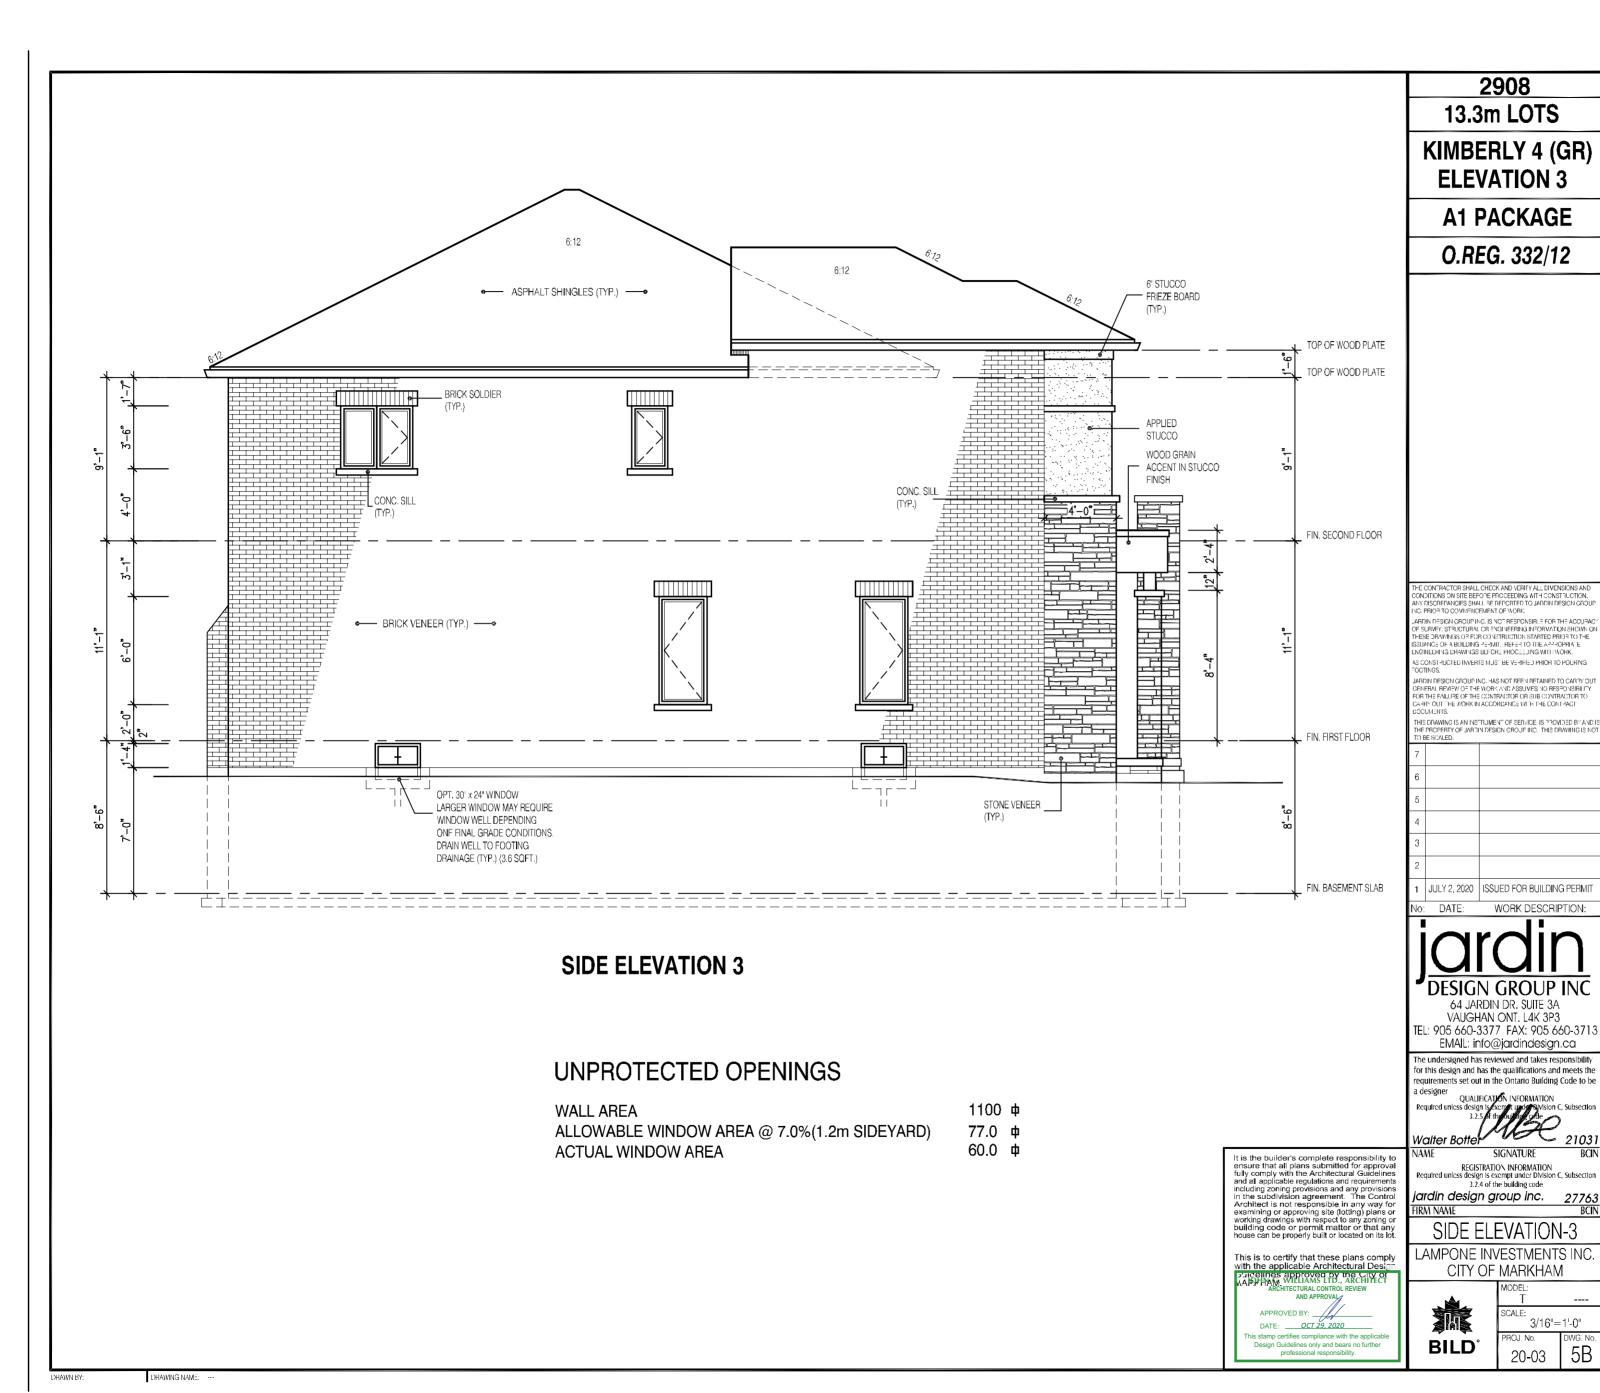
REVIEWED FOR COMPLIANCE WITH THE ONTARIO BUILDING CODE AND THE APPLICABLE ZONING BY-LAW



Date: 02/05

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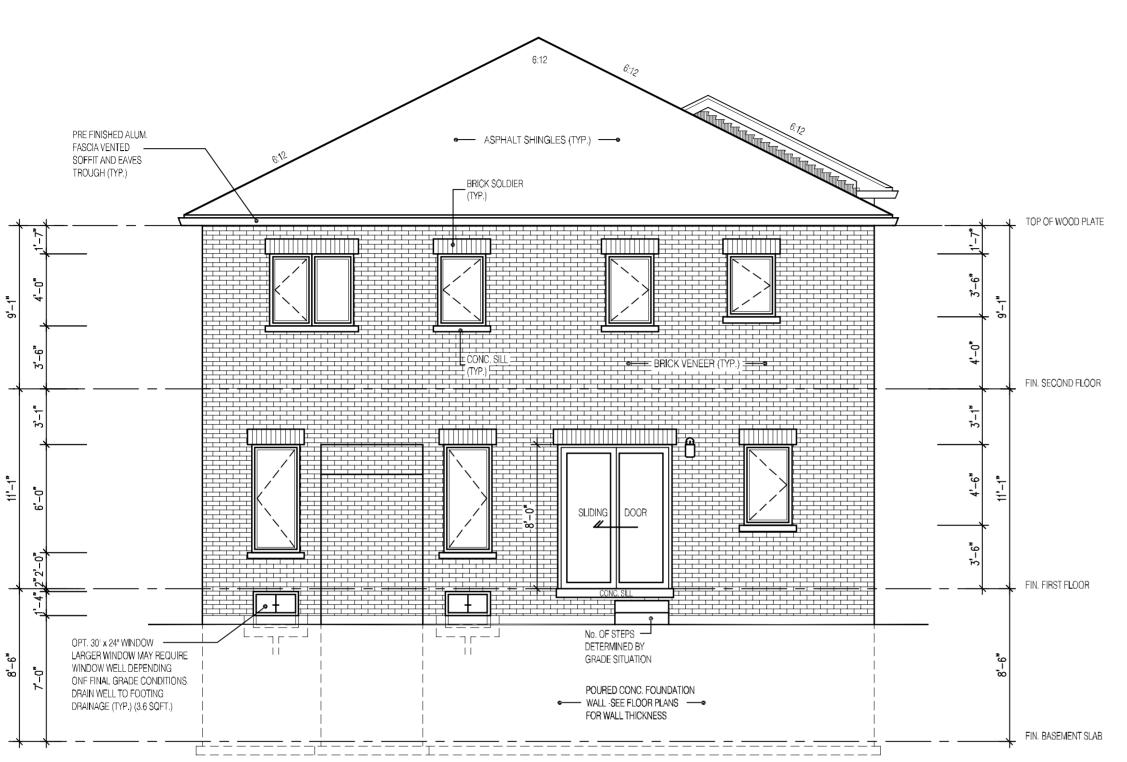
REVIEWED FOR COMPLIANCE WITH THE ONTARIO BUILDING



Date: 02/05/

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REAR ELEVATION 3

E CONTRACTOR SHALL CHECK AND VERIFY ALL DIVENSIONS AND DNDITIONS ON SITE BEFORE PROCEEDING MITH CONSTRUCTION. VY DISCIPEDANCES SHALL 3 ERFORTED TO JARDIN DESIGN CRO C. PRIOR TO COVERNOEMENT OF WORK. CONSTRUCTED INVERTS MUST BE VERIFIED PRIOR TO POURING DTINGS. HIS DRAWING IS AN INSTRUMENT OF SERVICE, IS PROVIDED BY AND HE PROPERTY OF JARDIN DESIGN CROUP INC. THIS DRAWING IS NO JULY 2, 2020 ISSUED FOR BUILDING PERMIT DATE: WORK DESCRIPTION: 64 JARDIN DR. SUITE 3A VAUGHAN ONT. L4K 3P3 TEL: 905 660-3377 FAX: 905 660-3713 EMAIL: info@jardindesign.ca The undersigned has reviewed and takes responsibility for this design and has the qualifications and meets the quirements set out in the Ontario Building Code to be a designer
QUALIFICATION INFORMATION
Required unless design is execute under system C, subsection
3.2.5 of the building orde

Walter Botter 21031 SIGNATURE It is the builder's complete responsibility to ensure that all plans submitted for approval fully comply with the Architectural Guidelines and all applicable regulations and requirements including zoning provisions and any provisions in the subdivision agreement. The Control Architect is not responsible in any way for examining or approving site (lotting) plans or working drawings with respect to any zoning or building code or permit matter or that any house can be properly built or located on its lot. REGISTRATION INFORMATION ss design is exempt under Division C, Subsection 3.2.4 of the building code jardin design group inc. IRM NAME REAR ELEVATION-3 LAMPONE INVESTMENTS INC. This is to certify that these plans comply with the applicable Architectural Design participation of the Architectural Design participation of the Architectural Control Review CITY OF MARKHAM DATE: OCT 29, 2020 **BILD** 20-03

BUILDING STANDARDS DIVISION REVIEWED FOR COMPLIANCE WITH THE ONTARIO BUILDING **KIMBERLY 4 (GR)** CODE AND THE APPLICABLE ZONING BY-LAW **ELEVATION 3 A1 PACKAGE**

2908


13.3m LOTS

O.REG. 332/12



NO PERSON SHALL CONSTRUCT OR DEMOLISH A BUILDING OR CAUSE A BUILDING TO BE CONSTRUCTED EXCEPT IN ACCORDANCE WITH THESE CERTIFIED BUILDING PERMIT DOCUMENTS, THE BUILDING CODE ACT AND THE BUILDING CODE.

NOTE: THE PROPOSED DEVELOPMENT IS SUBJECT TO COMPLIANCE WITH ALL APPLICABLE PROVISIONS OF THE ZONING BY-LAW AND ALL OTHER APPLICABLE LAWS INCLUDING THE PROVISIONS OF A SITE PLAN AND / OR SUBDIVISION AGREEMENT WHICH MAY OR MAY NOT BE REGISTERED ON TITLE

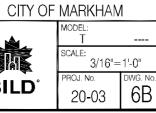

DRAWING NAME:



REAR ELEVATION 3 DECK CONDITION

FOR ADDITIONAL DECK STRUCTURE REFER TO PAGE 7 OF THE DETAIL PACKAGE

DRAWING NAME:

NOTE:

WHEN VENEER CUT IS GREATER THAN 26" A 10" POURED CONC. FOUNDATION WALL IS REQUIRED.

(FOUNDATION PLAN TO BE REVIEWED IN CONJUNCTION WITH SITE PLAN)

This is to certify that these plans comply with the applicable Architectural Designation of the Architectural Designation of the Architectural Course Review DATE: OCT 29, 2020

It is the builder's complete responsibility to ensure that all plans submitted for approval fully comply with the Architectural Guidelines and all applicable regulations and requirements including zoning provisions and any provisions in the subdivision agreement. The Control Architect is not responsible in any way for examining or approving site (lotting) plans or working drawings with respect to any zoning or building code or permit matter or that any house can be properly built or located on its lot.

jardin design group inc. IRM NAME DECK CONDITION EL-3 LAMPONE INVESTMENTS INC. CITY OF MARKHAM 3/16"=1'-0" **BILD** 20-03

BUILDING STANDARDS DIVISION REVIEWED FOR COMPLIANCE WITH THE ONTARIO BUILDING CODE AND THE APPLICABLE ZONING BY-LAW

2908

KIMBERLY 4 (GR)

ELEVATION 3

A1 PACKAGE

O.REG. 332/12

CONSTRUCTED INVERTS MUST BE VERIFIED PRIOR TO POURING TINGS.

JULY 2, 2020 ISSUED FOR BUILDING PERMIT

64 JARDIN DR. SUITE 3A VAUGHAN ONT. L4K 3P3 TEL: 905 660-3377 FAX: 905 660-371

EMAIL: info@jardindesign.ca

he undersigned has reviewed and takes responsibility for this design and has the qualifications and meets the

QUALIFICATION INFORMATION

Required unless design is several under symstom c, subsection 3.2.5 if the supply of the Walter Bottel 21031

SIGNATURE


REGISTRATION INFORMATION ss design is exempt under Division C, Subsection 3.2.4 of the building code

13.3m LOTS



ALL CONSTRUCTION SHALL COMPLY WITH THE ONTARIO BUILDING CODE

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DRAWING NAME:

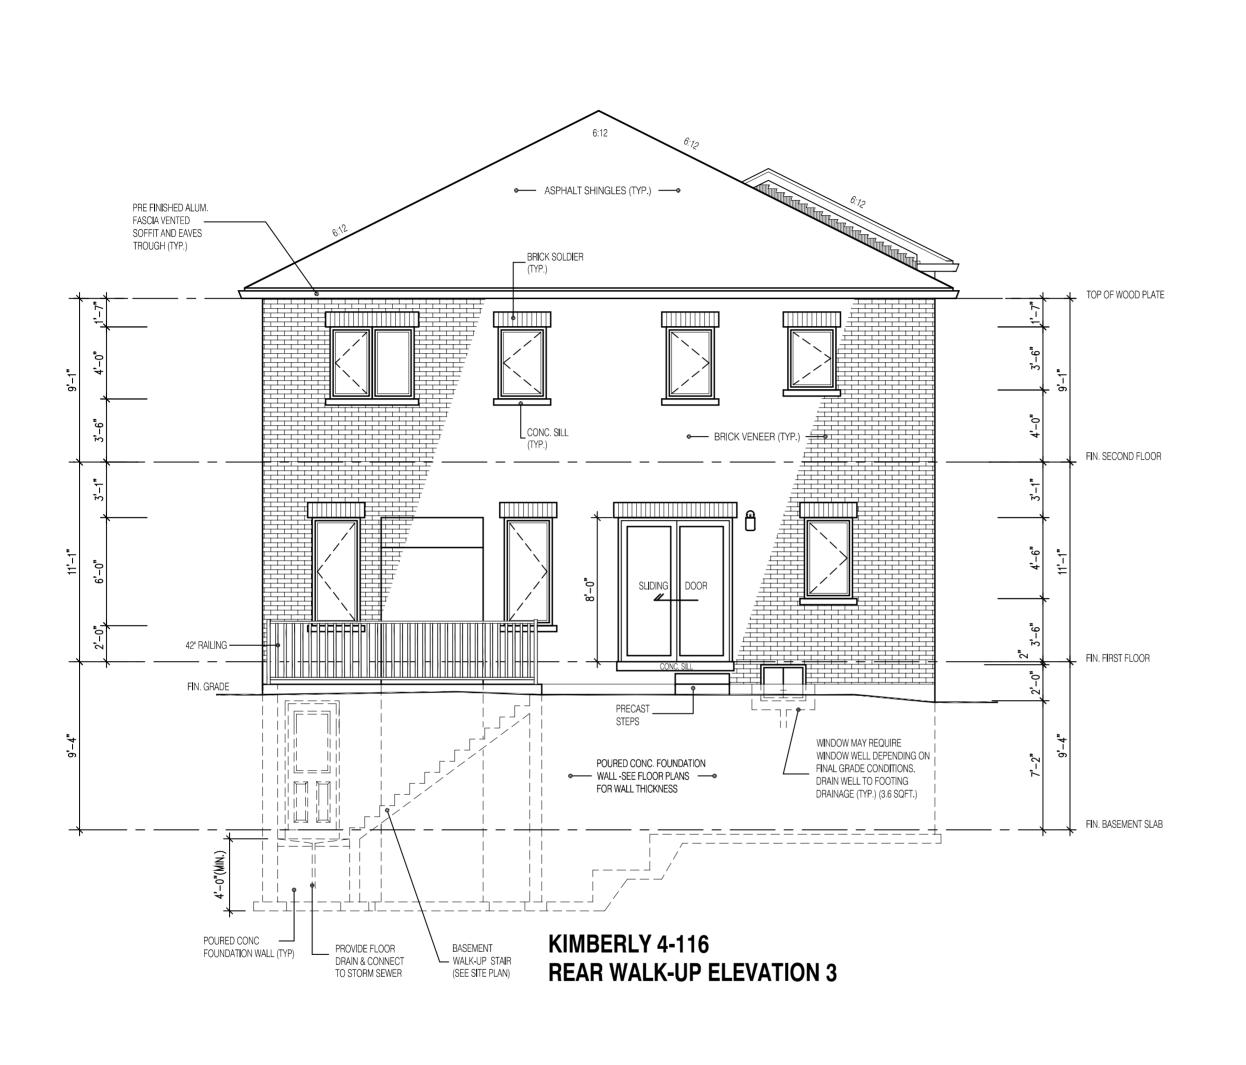KIMBERLY 4-116 ELEV3		ENERGY EFFICIENCY- A1 PACKAGE		
ELEVATION	WALL FT ²	OPENING FT ²	PERCENTAGE	
FRONT	866.00	150.00	17.32 %	
EFT SIDE	1100.00	60.00	5.45 %	
RIGHT SIDE	1104.00	0.00	0.00 %	
REAR	901.00	171.00	18.98 %	
TOTAL	3971.00	381.00	9.59 %	

JOHN G. WILLIAMS LTD., ARCHITECT DATE: <u>OCT 29, 2020</u>

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LAMPONE INVESTMENTS INC. This is to certify that these plans comply with the applicable Architectural Design Guidelines approved by the City of

BILD°

2908

13.3m LOTS

KIMBERLY 4-116(GR)

ELEVATION 3

A1 PACKAGE

O.REG. 332/12

HIS DRAWING IS AN INSTRUMENT OF SERVICE, IS PROVIDED BY AN HE PROPERTY OF JARDIN DESIGN GROUP INC. THIS DRAWING IS N

OCT. 8, 2020 ADDED DRAWING TO SET ISSUED FOR BUILDING PERMIT

64 JARDIN DR. SUITE 3A VAUGHAN ONT, L4K 3P3

TEL: 905 660-3377 FAX: 905 660-3713

The undersigned has reviewed and takes responsibility for this design and has the qualifications and meets the requirements set out in the Ontario Building Code to be a designer

QUALIFICATION INFORMATION

Walter Botter 21031

NAME SIGNATURE BCIN

REGISTRATION INFORMATION Required unless design is exempt under Division C, Subsection 3.2.4 of the building code 3.2.4 of the building code

jardin design group inc. 27763

BCIN

REAR WALK-UP EL-3

CITY OF MARKHAM

3/16"=1'-0"

20-03

6B-2

EMAIL: info@jardindesign.ca




REVIEWED FOR COMPLIANCE WITH THE ONTARIO BUILDING CODE AND THE APPLICABLE ZONING BY-LAW



ALL CONSTRUCTION SHALL COMPLY WITH THE ONTARIO BUILDING CODE

NO PERSON SHALL CONSTRUCT OR DEMOLISH A BUILDING OR CAUSE A BUILDING TO BE CONSTRUCTED EXCEPT IN ACCORDANCE WITH THESE CERTIFIED BUILDING PERMIT DOCUMENTS, THE BUILDING CODE ACT AND THE BUILDING CODE.

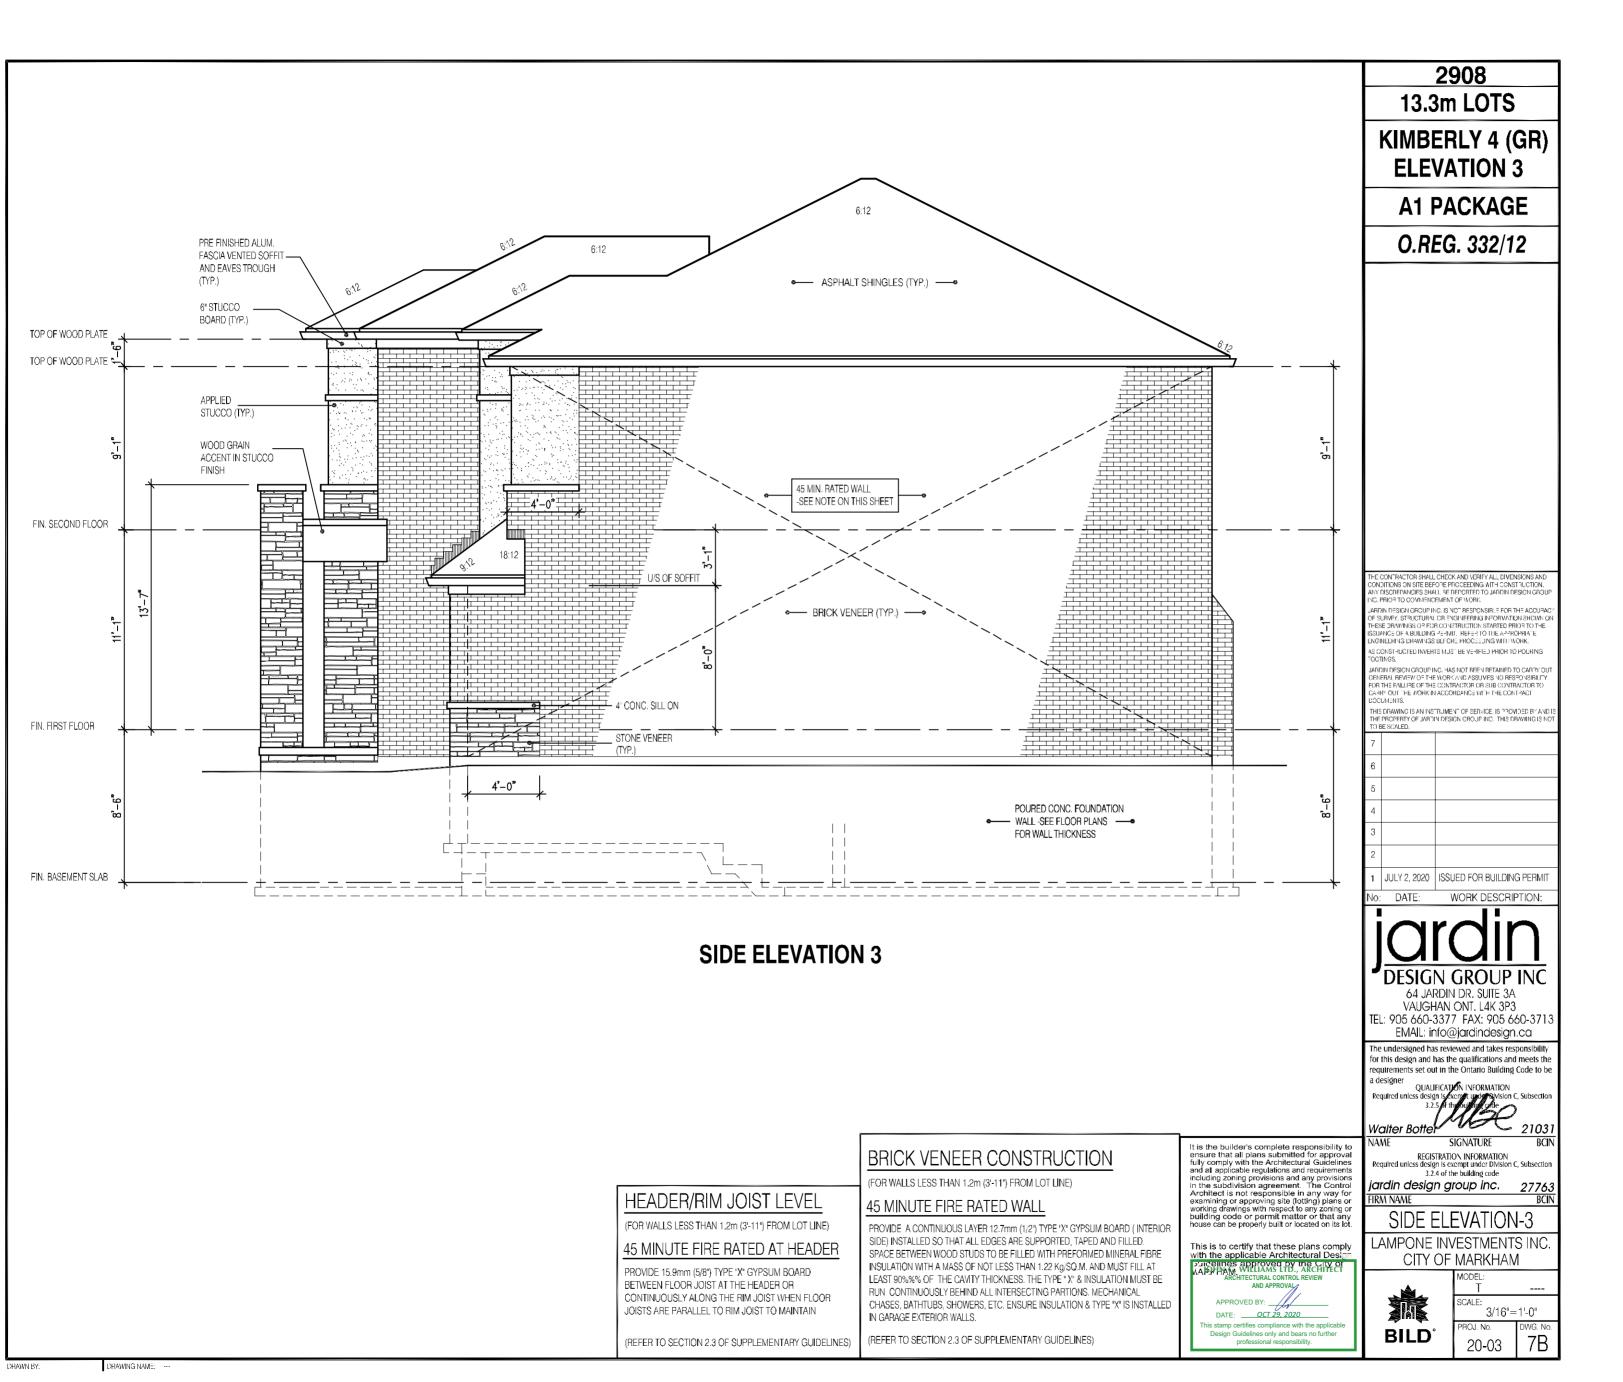

CITY OF WARKHAM
BUILDING STANDARDS DIVISION


REVIEWED FOR COMPLIANCE WITH THE ONTARIO BUILDING CODE AND THE APPLICABLE ZONING BY-LAW



Date: 02/05/5

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SECTION ELEVATION 3

2908 13.3m LOTS **KIMBERLY 4 (GR) ELEVATION 3 A1 PACKAGE** O.REG. 332/12

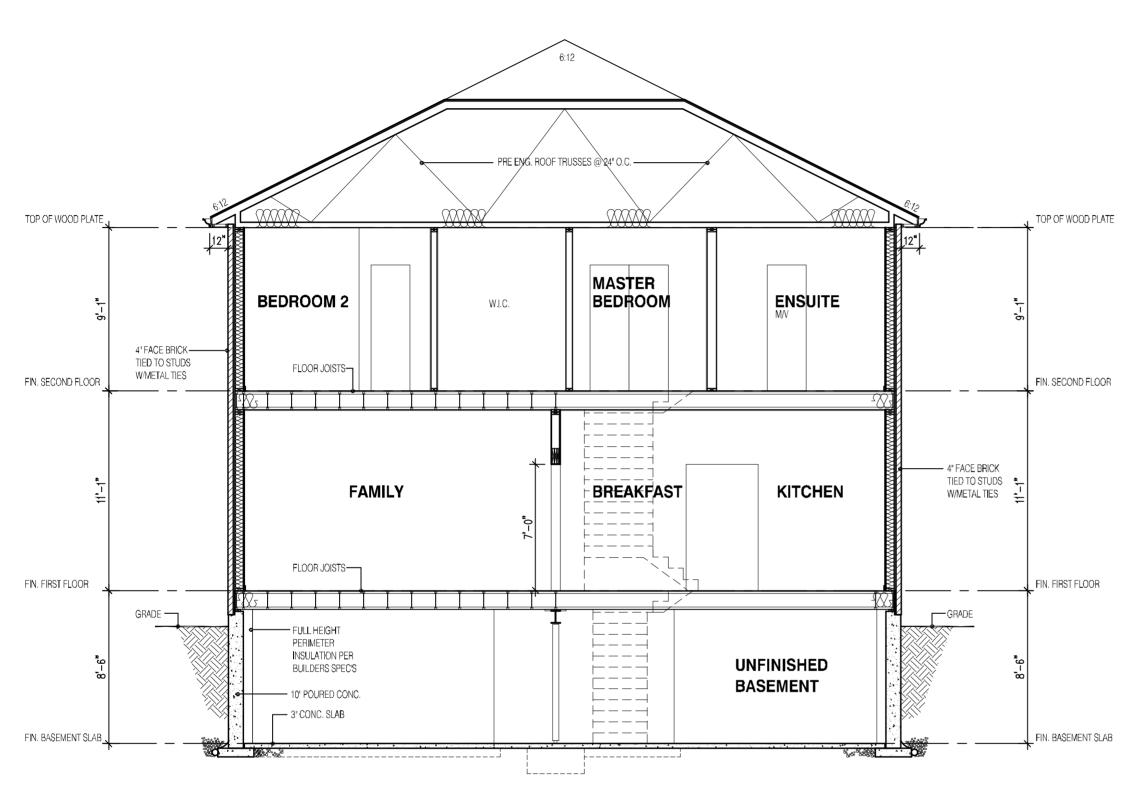STRUDET INC.



FOR STRUCTURE ONLY

CONSTRUCTED INVENTS MUST BE VERIFIED PRIOR TO POURING TINGS.

7		
6		
5		
4		
3		
2		
1	JULY 2, 2020	ISSUED FOR BUILDING PERMIT

WORK DESCRIPTION:



64 JARDIN DR. SUITE 3A VAUGHAN ONT. L4K 3P3 TEL: 905 660-3377 FAX: 905 660-3713 EMAIL: info@jardindesign.ca

The undersigned has reviewed and takes responsibility for this design and has the qualifications and meets the

QUALIFICATION INFORMATION QUALIFICATION INFORMATION
Required unless design is secret, upon system c, subsection
3.2.5 of the outling of the
Walter Botter 21031

SIGNATURE NAME

REGISTRATION INFORMATION
Required unless design is exempt under Division C, Subsection
3.2.4 of the building code

jardin design group inc. IRM NAME

SECTION ELEV.-3

LAMPONE INVESTMENTS INC. CITY OF MARKHAM



3/16"=1'-0" 8B 20-03





ALL CONSTRUCTION SHALL COMPLY WITH

THE ONTARIO BUILDING CODE

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NOTE: THE PROPOSED DEVELOPMENT IS SUBJECT TO COMPLIANCE WITH ALL APPLICABLE PROVISIONS OF THE ZONING BY-LAW AND ALL OTHER APPLICABLE LAWS INCLUDING THE PROVISIONS OF A SITE PLAN AND / OR SUBDIVISION AGREEMENT WHICH MAY OR MAY NOT BE REGISTERED ON TITLE

DRAWING NAME: