ALL CONSTRUCTION TO ADHERE TO THESE PLANS AND SPEC'S AND TO CONFORM TO THE ONTARIO BUILDING CODE AND ALL OTHER APPLICABE CODES AND AUTHORITIES HAVING JURISDICTION. THESE REQUIREMENTS TAKEN AS MINIMUM SPECIFICATIONS. ONT. REG. 332/12

ROOF CONSTRUCTION

(*SEE OBC 9.19.)

NO. 210 (10.25kg/m2) ASHPHALT SHINGLES. 10mm (3/8") PLYWOOD SHEATHING WITH "H" CLIPS. APPROVED WOOD TRUSSES \$600mm 24" o.c. MAX. APPROVED EAVE PROTECTION TO EXTEND 900mm (3'-0") FROM EDGE OF ROOF AND MIN. 300mm (12") BEYOND INNER FACE OF EXTERIOR WALL, 38x89 (2"x4") TRUSS BRACING \$1830mm (6'-0") o.c. AT BOTTOM CHORD. PREFIN. ALUM. EAVESTROUGH, FASCIA, RWL & VENTED SOFFIT. PROVIDE ICE & WATER SHIELD TO ALL ROOF / WALL SURFACES SUSCEPTIBLE TO DAMMING, ROOF SHEATHING TO BE FASTENED 150 (6") o.c. ALONG FORES & INSTERNED HAVE SUPPORTS WHEN TRUSSES 150 (6") c.c. ALONG EDGES & INTERNEDIATE SUPPORTS WHEN TRUSSES SPACED GREATER THAN 406 (16"). ATTIC VENTILATION 1:300 OF INSULATED CEILING AREA WITH 50% AT EAVES.

FRAME WALL CONSTRUCTION (2"x6")

SIDING, HARDIE BOARD, STUCCATO BOARD OR EQUAL AS PER ELEVATION, 19X64 (1"x3") VERTICAL WOOD FURRING, APPROVED SHEATHING PAPER, 7/16" O.S.B. EXTERIOR SHEATHING. 38X140 (2"X6") STUDS @ 400MM (16") O.C. W/APPROVED DIAGONAL WALL BRACING, RSI 3.87 (R22) INSULATION AND APPROVED VAPOUR BARRIER AND APPROVED CONT. AIR BARRIER, 13mm (1/2") INT. DRYWALL FINISH.

BRICK VENEER CONSTRUCTION (2"x6")

90mm (4") FACE BRICK 25mm (1") AIR SPACE, 22x180x0.76mm 90mm (4") FACE BRICK 25mm (1") AIR SPACE, 22x180x0.76mm (7/8"x7"x0.03") GALV. METAL TIES © 400mm (16") o.c. HORIZONTAL 600mm (24") o.c. VERTICAL. APPROVED SHEATHING PAPER, 7/16" O.S.B. EXTERIOR SHEATHING. 38x140 (2"x6") STUDS © 400mm (16") o.c. W/APPROVED DIAGONAL WALL BRACING, RSI 3.87 (R22) INSUL. APPROVED VAPOUR BARRIER AND APPROVED CONT. AIR BARRIER, 13mm (1/2") INT. DRYWALL FINISH. PROVIDE WEEP HOLES © 800mm (32") o.c. BOTTOM COURSE AND OVER OPENINGS. PROVIDE BASE FLASHING UP MIN. 150mm (6") BEHIND BUILDING PAPER.

STUCCO WALL CONSTRUCTION (2"x6")

STUCCO CLADDING SYSTEM CONFIRMING TO OBC9.27.1.1.(2) & 9.28 THAT STUCCO CLADDING SYSTEM CONFIRMING TO OBC9.27.1.1.(2) & 9.28 THAT EMPLOY A MINIMUM 6mm (1/4") DRAINAGE CAVITY BEHIND THE CLADDING WITH POSITIVE DRAINAGE TO THE EXTERIOR AND APPLIED AS PER MANUFACTURERS SPECIFICATION ON 25mm (1") MINIMUM EXTRUDED OR EXPANDED RIGID INSULATION, APPROVED SHEATHING PAPER, 7/16" O.S.B. EXTERIOR SHEATHING. 38x140 (2"x6") STUDS @ 400mm (16") o.c. W/APPROVED DIAGONAL WALL BRACING, RSI 3.87 (R22) INSUL. APPROVED VAPOUR BARRIER AND APPROVED CONT. AIR BARRIER, 13mm (1/2") INT. DRYWALL FINISH. STUCCO TO BE MIN.200mm (8") ABOVE FINISH GRADE.

INTERIOR STUD PARTITIONS

(*SEE OBC 9.23.10.&9.23.11.)

BEARING PARTITION 38x89 (2"x4") ● 400mm (16") o.c. FOR 2 STOREYS AND 300mm (12") o.c. FOR 3 STOREYS. NON-BEARING PARTITIONS 38x89 (2"x4") ● 600mm (24") o.c.. PROVIDE 38x89 (2"x4") BOTTOM PLATE AND 2/38x89 (2-2"x4") TOP PLATE. 13mm (1/2") INTERIOR DRYWALL BOTH SIDES OF STUD, PROVIDE 38x140 (2"x6") STUDS/PLATES WHERE NOTED.

NON-LOADBEARING WALLS PARALLEL TO FLOOR JOISTS SHALL BE SUPPORTED BY JOIST BENEATH OR ON BLOCKING BETWEEN THE JOISTS, AS PER 9.23.9.8

(*SEE OBC 9.15.3 & 9.15.4.)

FOUNDATION WALL/FOOTINGS:

MIN. 200mm (8") POURED CONC. FDTN. WALL 15MPa (2200psi) WITH BITUMENOUS DAMPROOFING AND DRAINAGE LAYER. MIN. 480x155 (19"x6") CONTIN. KEYED CONC. FTG. BRACE FOUNDATION WALL PRIOR TO BACKFILLING. ALL FOOTINGS SHALL REST ON NATURAL UNDIVIDED SOIL WITH MINIMUM BEARING CAPACITY OF 120kPa (17.4 psi) OR GREATER.

DEC. 2, 2020 REV. AS PER CITY COMMENT

JULY 2, 2020

AUG. 17, 2018

DATE

REISSUED FOR PERMIT
ISSUED FOR BUILDING PERMI

PREPARED TO PACKAGE 'A1

WORK DESCRIPTION

ISSUED TO CLIENT

WEEPING TILE (* SEE OBC 9.14.3.)

100mm (4") DIA. WEEPING TILE 150mm (6") CRUSHED STONE OVER AND AROUND WEEPING TILES.

BASEMENT SLAB

80mm (3") MIN. 25MPa (3600psi) CONC. SLAB ON 100mm (4") COARSE GRANULAR FILL, OR 15MPa (2200psi) CONC. WITH DAMPROOFING BELOW SLAB.

(*SEE OBC 9.23.14. & 9.30.2.)

19mm (3/4") T&G SUBFLOOR UNDER GROUND FLOOR FINISH FLOOR.
16mm (5/8") T&G SUBFLOOR UNDER SECOND FLOOR FINISH FLOOR.
16mm (5/8") PANEL-TYPE UNDERLAY FOR CERAMIC TILE APPLICATION.
6mm (1/4") PANEL-TYPE UNDERLAY UNDER RESILIENT & PARQUET FLOORING.

ROOF INSULATION (*SEE SB12 - 2.1.1.2.A & 2.1.1.7)

(*SEE OBC 9.16.-)

(*SEE OBC 9.8.-)

RSI 10.57 (R60) ROOF INSULATION AND APPROVED VAPOUR BARRIER, 16mm (5/8") INT. DRYWALL FINISH OR APPROVED EQUAL.

ALL STAIRS/EXTERIOR STAIRS

=200 =210 =235 =25 =1950 =900 =865 =860 (7-7/8") (8-1/4")

(8-1/4") (9-1/4") (1") (6'-5") (2'-11") TO 965 (3'-2") (2'-10")

FOR CURVED STAIRS MIN. AVG. RUN MIN. RUN = 200 (8") = 150 (6")

RAILING

MAX. RISE
MIN. RUN
MIN. TREAD
MAX. NOSING
MIN. HEADROOM
RAIL @ LANDING
RAIL @ STAIR
MIN. STAIR WIDTH

(*SEE OBC 9.8.8.)

FINISHED RAILING ON PICKETS SPACED MAXIMUM 100mm (4") BETWEEN PICKETS.

= 900mm (2'-11") MIN = 1070mm (3'-6") MIN. INTERIOR GUARDS: EXTERIOR GUARDS:

SILL PLATE

(*SEE OBC 9.23.6 & 9.23.7.)

38x89 (2"x4") SILL PLATE WITH 13mm (1/2") DIA. ANCHOR BOLTS
200mm (8") LONG, EMBEDDED MIN. 100mm (4") INTO CONC. © 2400mm
(7'-10") o.c. CAULKING OR 25 (1") MIN. MINERAL WOOL BETWEEN PLATE
AND TOP OF FDTN. WALL. USE MORTAR TO LEVEL SILL PLATE WHEN

BASEMENT INSULATION

(*SEE DBC 12.3.)

FOUNDATION WALLS ENCLOSING HEATED SPACE SHALL BE INSULATED FROM THE UNDERSIDE OF THE SUBFLOOR TO NOT MORE THAN 152mm FROM THE UNDERSIDE OF THE SUBFLOOR TO NOT MORE THAN 152mm (6") ABOVE THE FINISHED FLOOR OF THE BASEMENT AND NOT LESS THAN 50mm (2") TO THE SLAB.
FOUNDATION WALL INSULATION SHALL BE MINIMUM RSI. 3.52 (R20) BLANKET INSULATION, APPROVED VAPOUR BARRIER, DAMPROOFING W/BLDG. PAPER BETWEEN THE FDTN. AND INSUL.

BASEMENT BEARING STUD PARTITION

(*SEE OBC 9.23.10.)

38x89 (2"x4") STUDS \$\infty\$400mm (16") o.c. 38x89 (2"x4") SILL PLATE ON DAMPROOFING MATERIAL, 13mm (1/2") DIA. ANCHOR BOLTS 200mm (8") LONG, EMBEDDED MIN. 100mm (4") INTO CONC. \$\infty\$ 2400mm (7"−10") o.c. (4") HIGH CONC. CURB ON 305x155 (12"x6") CONC. FOOTING. ADD HORIZ. BLOCKING AT MID−HEIGHT IF WALL IS UNFINISHED.

STEEL BASEMENT COLUMN

90mm (3-1/2") DIA. x 4.78mm (.188) STL. COL. WITH 150x150x9.5mm (6"x6"x3/8") STL. TOP & BOTTOM PLATE.

STEEL COLUMN (* SEE OBC 9.17.3.) 90mm (3-1/2") DIA. x 4.78mm (.188) STL. COLUMN WITH 100x100x6.4mm (4"x4"x1/4") STEEL TOP & BOTTOM PLATE. FIELD WELD BOTTOM PLATE TO 250x100x12.5mm (10"x4"x1/2") BASE PLATE C/W 2-13mm (1/2") DIA. x 300mm (12") LONG x 50mm (2") HOOK ANCHORS.

NIB WALLS

(* SEE OBC 9.23.8.)

(* SEE OBC 9.17.3.)

BEAM POCKET OR 200x200 (8"x8") POURED CONCRETE NIB WALLS. MINIMUM BEARING 90mm (3-1/2")

STEEL BEAM STRAPPING (* SEE OBC 9.23.4.3.(3)(c)) 19x38 (1"x2") CONTINUOUS WOOD STRAPPING BOTH SIDES OF STEEL

GARAGE SLAB

(*SEE DBC 9.16.-)

100mm (4") 32MPa (4640psi) CONC. SLAB WITH 5-8% AIR ENTRAINMENT ON OPT. 100 (4") COARSE GRANULAR FILL WITH COMPACTED SUB-BASE OR COMPACTED NATIVE FILL. SLOPE TO FRONT 1% MIN.

INTERIOR GARAGE WALLS & CEILING (*SEE OBC 9.10.9.16.)

13mm (1/2") GYPSUM BOARD ON WALL AND CEILING BETWEEN HOUSE AND GARAGE, RSI 3.87 (R22) IN WALLS, RSI 5.46 (R31) IN CEILING. TAPE AND SEAL ALL JOINTS GAS TIGHT.

GARAGE DOOR GASPROOFING

DOOR AND FRAME GASPROOFING, DOOR EQUIPPED WITH SELF CLOSING DEVICE AND WEATHER STRIPPING.

EXTERIOR STEP

(*SEE OBC 9.8.9.2, 9.8.9.3 & 9.8.10.)

PRECAST CONCRETE STEP OR WD. STEP WHERE NOT EXPOSED TO WEATHER MAX. RISE 200mm (7-7/8"); MINIMUM TREAD 250mm

DRYER VENT

(*SEE DBC 6.2.3.8.(7)

CAPPED DRYER EXHAUST VENTED TO EXTERIOR. USE 1000mm (4") DIA. SMOOTH WALL VENT PIPE.

ATTIC ACCESS ATTIC ACCESS HATCH 545x700 (22"x28") WITH WEATHERSTRIPPING. RSI 5.46 (R31) RIGID INSULATION BACKING.

(*SEE OBC 9.19.2.)

FIREPLACE CHIMNEYS (*OBC 9.21.-) TOP OF FIREPLACE CHIMNEY SHALL BE 915mm (3-0") ABOVE THE HIGHEST POINT AT WHICH IT COMES IN CONTACT WITH THE ROOF AND 610mm (2'-0") ABOVE THE ROOF SURFACE WITHIN A HORIZ. DISTANCE

LINEN CLOSET

4 SHELVES MIN. 350mm (14") DEEP.

OF 3050mm (10'-0") FROM THE CHIMNEY.

MECHANICAL EXHAUST

(*SEE DBC 9.32.3.5, 9.32.3.10.) MECHANICAL EXHAUST FAN VENTED TO EXTERIOR.

STEEL BEARING PLATE FOR MASONRY WALLS

280x280x16 (11"x11"x5/8") STL. PLATE FOR STL BEAMS AND 280x280x12 (11"x11"x1/2") STL. PLATE FOR WOOD BEAMS BEARING ON CONC. BLOCK PARTYWALL, ANCHORED \(\psi / 2-19mm (3/4") x200mm (8") LONG GALV. ANCHORS \(\psi \) ITHIN SOLID BLOCK COURSE. LEVEL \(\psi \) ITH NON-SHRINK GROUT.

CLASS "B" VENT

U.L.C. RATED CLASS "B" VENT 610mm (2'-0") ABOVE THE POINT IN CONTACT WITH THE ROOF FOR SLOPES UP TO 9/12, REFER TO THE ONTARIO GAS UTILIZATION CODE.

WOOD BASEMENT POST

3-38x140 (3-2"x6") BUILT-UP POST ON METAL BASE SHOE ANCHORED TO CONC. WITH 12.7 (1/2") DIA. BOLT ON 406x406x203 (16"x16"x8") CONC. FOOTING.

STEP FOOTINGS

(*OBC 9.15.3.9.) MIN. HORIZ. STEP = 610mm (24"), MAX. VERT. STEP = 610mm (24")

SLAB ON GRADE (*SEE OBC 9.16.-) 100mm (4") 32MPa (4640psi) CONC. SLAB WITH 5-8% AIR ENTRAINMENT ON OPT. 100 (4") COARSE GRANULAR FILL WITH COMPACTED SUB-BASE OR COMPACTED NATIVE FILL. REINFORCED W/ 6x6-W2.9xW2.9 MESH PLACED NEAR MID-DEPTH OF SLAB.

DIRECT VENT FURNACE •

DIRECT VENT FURNACE TERMINAL MIN. 900mm (36") FROM A GAS REGULATOR. MIN 300mm (12") ABOVE FIN. GRADE, FROM ALL OPENINGS, EXHAUST & INTAKE VENTS. HRY INTAKE TO BE A MIN. OF 1830mm (6"-0") FROM ALL EXHAUST TERMINALS. REFER TO GAS UTILIZATION CODE. ALL AIR INTAKES SHALL BE LOCATED SO THAT THEY ARE SEPARATED FROM KITCHEN EXHAUST BY 3.0m IN COMPLIANCE WITH O.B.C. DIV.-B TABLE 6.2.3.12..

DIRECT VENT GAS FIREPLACE

DIRECT VENT GAS FIREPLACE. VENT TO BE A MINIMUM 300mm (12") FROM ANY OPENING AND ABOVE FIN. GRADE. REFER TO GAS UTILIZATION CODE

JOIST STRAPPING & BRIDGING

(*SEE OBC 23.9.4.)

ALL FLOOR JOISTS TO BE BRIDGED WITH 38x38 (2"x2") CROSS BRACING OR SOLID BLOCKING @2100mm (6'-11") o.c. MAX. 19x64 (1"x3") @2100mm (6'-11") o.c. UNLESS A PANEL TYPE CEILING FINISH IS APPLIED.

EXPOSED BUILDING FACE

(* SEE OBC 9.10.15.)

EXTERIOR WALLS TO HAVE A FIRE RESISTANCE RATING OF NOT LESS THAN 45min. WHERE LIMITING DISTANCE IS LESS THAN 1.2M (3'-11") WHERE THE LIMITING DISTANCE IS LESS THAN 600mm (1'-11") THE EXPOSING FACE SHALL BE CLAD IN NON-COMBUSTABLE MATERIAL.

COLD CELLAR PORCH SLAB

FOR MAX. 2500mm (8'-2") PORCH DEPTH, 125mm (5") 32Mpg (4640 psi) CONC. SLAB WITH 5-8% AIR ENTRAINMENT. REINF. WITH 10M BARS \$200mm (8") o.c. EACH WAY IN BOTTOM THIRD OF SLAB, ANCHORED IN PERIMETER FDTN. WALLS W/ 610x610 (24"x24") 10M \$6600mm (24") o.c. DOWELS. SLOPE SLAB MIN. 1.0% FROM DOOR. SLAB TO HAVE A MIN. 75mm (3") BEARING ON FDTN. WALLS. PROVIDE (WL1) LINTELS OVER CELLAR DOOR.

FDTN. WALL REDUCTION IN THICKNESS

(*SEE OBC 9.15.4.7.)

PACKAGE 'A1'

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FDTN. WALL SHALL NOT BE REDUCED TO LESS THAN 90mm (3-1/2") THICK TO A MAX. DEPTH OF 660mm (26") FOR 8" FDTN. WALL. 10" FDTN. WALL WHEN REDUCTION IN THICNESS IS GREATER THAN 26". FDTN. WALL SHALL BE TIED TO THE FACING MATERIAL WITH METAL TIES SPACED 200mm (8")o.c. VERTICALLY AND 900mm (36")o.c. HORIZONTALLY. FILL SPACE BETWEEN WALL AND FACING SOLID WITH

CONVENTIONAL ROOF FRAMING

(*SEE OBC 9.23.4.2.(1))

FOR MAX. 2240mm (7'-4") SPAN, 38x89 (2"x4") RAFTERS @400mm (16") o.c.. FOR MAX. 3530mm (11'-7") SPAN, 38x140 (2"x6") RAFTERS @400mm (16") o.c.. RIDGE BOARD TO BE 51mm (2") DEEPER. 38x39 (2"x4") COLLAR TIES AT MIDSPANS. CEILING JOISTS TO BE 38x89 (2"x4") @400mm (16") o.c. FOR MAX. 2830mm (9'-3") SPAN & 38x140 (2"x6") @ 400 (16") o.c. FOR MAX. 4450mm (14'-7") SPAN. RAFTERS FOR BUILT-UP ROOF TO BE 38x89 (2"x4") @600mm (24") o.c. WITH A 38x89 (2"x4") CENTER POST TO THE TRUSS BELOW, LATERALLY BRACED @1800mm (6'-0") o.c. VERTICALLY.

TWO STOREY VOLUME SPACES

FOR A MAXIMUM 5490mm (18'-0") HEIGHT, PROVIDE 2-38x140 (2-2"x6") CONTINUOUS STUDS @300mm (12") o.c. FOR BRICK AND 400mm (16") o.c. FOR SIDING. PROVIDE SOLID WOOD BLOCKING BETWEEN STUDS @1220mm (4'-0") o.c. VERT. 7/16" EXT. PLYWOOD.

EXPOSED FLOOR TO EXTERIOR

(*SB12 - 2.1.1.2.A)

PROVIDE RSI 5.46 (R31) INSULATION, APPROVED VAPOUR BARRIER AND CONTINUOUS AIR BARRIER, FINISHED SOFFIT.

PARTYWALLS

TYPICAL 1 HOUR RATED PARTYWALL. REFER TO DETAILS FOR TYPE AND SPECIFICATIONS.

EXTERIOR WALLS FOR WALK-OUT CONDITION

THE EXTERIOR BASEMENT STUD WALL TO BE 38x140mm (2"x6") STUDS \$\infty\$400mm (16") o.c. WATCH FLOOR JOIST SPACING WHEN PARALEL WITH FLOOR JOISTS.

SMOKE ALARM 6

(9.10.19.3.(3)).

PROVIDE 1 PER FLOOR, NEAR THE STAIRS CONNECTING THE FLOOR LEVEL AND ALSO 1 IN EACH BEDROOM NEAR HALL DOOR. ALARMS TO BE CONNECTED TO AN ELECTRICAL CIRCUIT AND INTERCONNECTED TO ACTIVATE ALL ALARMS IF ONE SOUNDS. BATTERY BACK-UP REQUIRED. SMOKE ALARMS TO INCORPORATE VISUAL SIGNALLING COMPONENT.


CARBON MONOXIDE ALARM

WHERE A FUEL-BURNING APPLIANCE IS INSTALLED IN A DWELLING UNIT, A BARBON MONOXIDE DETECTOR CONFORMING TO CAN./CGA-6.19, CSA 6.19 OR UL2034 SHALL BE INSTALLED ADJACENT TO EACH SLEEPING AREA. CARBON MONOXIDE DETECTOR(S) SHALL BE PERMANENTLY WIRED SO THAT IT IS ACTIVATION WILL ACTIVATE ALL CARBON MONOXIDE DETECTORS AND BE EQUIPPED WITH AN ALARM THAT IS AUDIBLE WITHIN BEDROOMS WHEN THE INTERVENING DOORS ARE CLOSED

SOIL GAS CONTROL

(*OBC 9.13.4.)

PROVIDE CONSTRUCTION TO PREVENT LEAKAGE OF SOIL GAS INTO THE BUILDING AS REQUIRED.

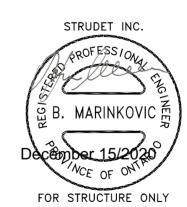

2012 CODE

for this design and has the qualifications and meets the requirements set out in the Ontario Building Code to be a designer OUALIFICATION INFORMATION Required unless design is exempt under Division C, 3.2.5 of the building code... 3.2.5 of thy bulling costs

Walter Botter 21031

NAME SIGNATURE BCIN REGISTRATION INFORMATION design is exempt under Divis
3.2.4 of the building code

jardin design group inc.

FIRM NAME

The undersioned has reviewed and takes responsibili

DESIGN GROUP INC 64 JARDIN DR. SUITE 3A VAUGHAN ONT, L4K 3P3 TEL: 905 660-3377 FAX: 905 660-371

EMAIL: info@jardindesign.ca

GENERAL NOTES

LAMPONE INVESTMENTS INC CITY OF MARKHAM



CALE: N.T.S. ROJ. No. 20-03

DRAWING NAME: GENERAL NOTE

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CONSTRUCTED INVERTS MUST BE VERIFIED PRIOR TO POURING

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ONDITIONS ON SITE BEFORE PROCEEDING NY DISCREPANCIES SHALL BE REPORTED T IC. PRIOR TO COMMENCEMENT OF WORK.

BUILDING STANDARDS DIVISION REVIEWED FOR COMPLIANCE WITH THE ONTARIO BUILDING CODE AND THE APPLICABLE ZONING BY-LAW



ALL CONSTRUCTION SHALL COMPLY WITH THE ONTARIO BUILDING CODE

Date: 02/10/21

NO PERSON SHALL CONSTRUCT OR DEMOLISH A BUILDING OR CAUSE A BUILDING TO BE CONSTRUCTED EXCEPT IN ACCORDANCE WITH THESE CERTIFIED BUILDING PERMIT DOCUMENTS, THE

2012

WINDOWS . CANADA ZONE C

(1) MINIMUM BEDROOM WINDOW (*OBC 9.9.10.1.)

AT LEAST ONE BEDROOM WINDOW ON A GIVEN FLOOR IS TO HAVE MIN. 0.35m2 (3.8 SQ.FT.) UNOBSTRUCTED GLAZED OPENABLE AREA WITH MIN. CLEAR WIDTH OF 380mm (1"-3")

GLASS AREA NOT MORE THAN 17% OF GROSS PERIPHERAL WALL AREA. MAXIMUM U-VALUE 0.28

(2) WINDOW GUARDS

(*OBC 9.8.8.1(6)

(*□BC 9.5.2.3.) •

A GUARD IS REQUIRED WHERE THE TOP OF THE WINDOW SILL IS LOCATED LESS THAN 480mm (1'-6") ABOVE FIN. FLOOR AND THE DISTANCE FROM THE FIN. FLOOR TO THE ADJACENT GRADE IS GREATER THAN 1800mm (5'-11")

GENERAL:

(1) MECHANICAL VENTILATION

MECHANICAL VENTILATION IS REQUIRED TO PROVIDE 0.3 AIR CHANGES PER HOUR AVERAGED OVER 24 HOURS.
SEE MECHANICAL DRAWINGS.

(2) DUTDOOR AIR INTAKE ●

ALL OUTDOOR AIR INTAKES SHALL BE LOCATED SO THAT THEY ARE SEPARATED FROM SOURCES OF CONTAMINATION (EXHAUST VENTS) IN COMPLIANCE WITH O.B.C. DIV.-B 6.2.3.12. AND TABLE 6.2.3.12.

(3) RAINFORCEMENT FOR GRAB BARS

RAINFORCEMENT OF STUD WALLS SHALL BE INSTALLED ADJACENT TO WATER CLOSETS AND SHOWER OR BATHTUB IN MAIN BATHROOM. REFER TO O.B.C. 9.5.2.3, 3.8.3.8.(3)(a), 3.8.3.8.(3)(c), 3.8.3.13.(2)(g) & 3.8.3.13.(4)(e). SEE DETAIL ON PAGE 11.

LUMBER:

STEEL:

1.)ALL LUMBER SHALL BE SPRUCE-PINE-FIR No.1&2 GRADE, UNLESS NOTED OTHERWISE.

2.)LUMBER EXPOSED TO THE EXTERIOR TO BE SPRUCE-PINE-FIR No.1&2 GRADE PRESSURE TREATED OR CEDAR, UNLESS NOTED OTHERWISE.

ALL BEAMS, GIRDER TRUSSES, AND METAL HANGER CONNECTIONS SUPPORTING ROOF FRAMING TO BE DESIGNED & CERTIFIED BY TRUSS 3.) MANUFACTURER.

LVL BEAMS SHALL BE 2.0E (Fb=2800psi Min.). NAIL EACH PLY OF LVL WITH 89mm (3-1/2") LONG COMMON WIRE NAILS @300mm (12") o.c. 4.)STAGGERED IN 2 ROWS FOR 184, 240, & 300mm (7-1/4",9-1/2",11-7/8") DEPTHS AND STAGGERED IN 3 ROWS FOR GREATER DEPTHS AND FOR 4 PLY MEMBERS ADD 1/2" (13mm) DIA. GALVANIZED BOLTS BOLTED AT MID-DEPTH OF BEAM @ 915mm

5.) PROVIDE TOP MOUNT BEAM HANGERS FOR ALL LYL BEAM TO BEAM CONNECTIONS UNLESS NOTED OTHERWISE.

6.)PROVIDE METAL JOIST HANGERS FOR ALL JOISTS AND BULIT-UP WOOD MEMBERS INTERSECTING FLUSH BUILT-UP WOOD MEMBERS.

7.) WOOD FRAMING NOT TREATED WITH A WOOD PRESERVATIVE, IN CONTACT WITH CONCRETE, SHALL BE SEPARATED FROM THE CONC. BY AT LEAST 2mil. POLYETHYLENE FILM, No.50 (45lbs) ROLL ROOFING OR OTHER DAMPROOFING MATERIAL, EXCEPT WHERE THE WOOD MEMBER IS AT LEAST 150mm (6") ABOVE THE GROUND.

STRUCTURAL STEEL AND HOLLOW STRUCTURAL SECTIONS SHALL CONFORM TO CAN/CSA-G40-21 GRADE 350W. REINFORCING STEEL SHALL CONFORM TO CSA-G30-18M GRADE 400R.

ONT. REG. 332/12-2012 OBC AMENDMENT O. REG. 88/19 JAN. 01, 2020

STABILITY OF NARROW (20-25) & TALL (±30') Houses

BUILDER TO PROVIDE SUFFICIENT TEMPORARY BRACING TO RESIST WIND LOADING WHEN UNDER CONSTRUCTION. FURTHER RECOMMENDATIONS:

1.)REDUCE THE FOUNDATION WALL SILL PLATE ANCHOR BOLT SPACING FROM 2400mm o.c. (7'-10") TO 1220mm o.c. (4'-0") FOR STANDARD CONDITIONS.

 $_{\rm 2.)} {\rm USE~9.5mm~(3/8")}$ THICK PLYWOOD OR WAFERBOARD FOR THE EXTERIOR WALL SHEATHING.

TO STIFFEN THE STRUCTURE IN TRANSVERSE DIRECTION USE 9.5mm 3.)(3/8") THICK PLYWOOD NAILED TO THE INTERIOR PARTITIONS ON EACH FLOOR FOR A MINIMUM 2 INTERIOR PARTITION WALLS ON BOTH SIDES AND PERPENDICULAR TO THE LONG WALLS.

BRICK VENEER LINTELS

WL1 = 3-1/2"x3-1/2"x1/4"L (90x90x6.0L) + 2-2"x8" SPR. No.2

WOOD LINTELS AND BEAMS

WB1 = 2-2"x8" SPR. No.2 (2-38x184 SPR. No.2) WB2 = 3-2"x8" SPR. No.2 (3-38x184 SPR. No.2) WB3 = 2-2"x10" SPR. No.2 (2-38x235 SPR. No.2) WB4 = 3-2"x10" SPR. No.2 (3-38x235 SPR. No.2) WB5 = 2-2"x12" SPR. No.2 (2-38x286 SPR. No.2) WB6 = 3-2"x12" SPR. No.2 (3-38x286 SPR. No.2) WB7 = 5-2"x12" SPR. No.2 (5-38x286 SPR. No.2) WB11 = 4-2"x10" SPR. No.2 (4-38x235 SPR. No.2) WB12= 4-2"x12" SPR. No.2 (4-38x286 SPR. No.2)

LOOSE STEEL LINTELS

LAMINATED VENEER LUMBER (LVL) BEAMS

LVL1A = 1-1 3/4" x 7 1/4" (1-45x184)
LVL1 = 2-1 3/4" x 7 1/4" (2-45x184)
LVL2 = 3-1 3/4" x 7 1/4" (2-45x184)
LVL3 = 4-1 3/4" x 7 1/4" (3-45x184)
LVL4A = 1-1 3/4" x 9 1/2" (1-45x240)
LVL4 = 2-1 3/4" x 9 1/2" (2-45x240)
LVL5 = 3-1 3/4" x 9 1/2" (2-45x240)
LVL5A = 4-1 3/4" x 9 1/2" (3-45x240)
LVL6A = 1-1 3/4" x 9 1/2" (4-45x240)
LVL6A = 1-1 3/4" x 11 7/8" (1-45x300)
LVL6 = 2-1 3/4" x 11 7/8" (3-45x300)
LVL7 = 3-1 3/4" x 11 7/8" (3-45x300)
LVL7A = 4-1 3/4" x 11 7/8" (3-45x300)
LVL7B = 2-1 3/4" x 14" (2-46x356)
LVL9 = 3-1 3/4" x 14" (3-45x356)
LVL10 = 2-1 3/4" x 18" (2-45x456)

LEGEND DJ DOUBLE JOIST TRIPLE JOIST TJ GIRDER TRUSS GT POINT LOAD

SOLID WOOD BEARING.
SOLID BEARING TO BE WIDE AT LEAST AS SUPPORTED MEMBER. MIN. 3 PIECES.

LOAD-BEARING WALL

TWO-STOREY WALL. SEE NOTE

TTTTTTTTTT RAISED WOOD PLATE

FLAT ARCH

FLOOR DRAIN

SMOKE ALARM, SEE NOTE

EXTERIOR LIGHTING OUTLET WITH A FIXTURE CONTROLLED BY A WALL SWITCH LOCATED WITHIN THE BUILDING SHALL BE PROVIDED AT EVERY ENTRANCE TO THE BUILDING OF RESIDENTIAL OCCUPANCY AS PER 9.34.2.1.(1)

(43)

(44)

Door Schedule

NO.	WIDTH	HEIGHT 8' TO 9' CEILINGS		HEIGHT 10' OR MORE CEILINGS		TYPE
1	2'-10"	6'-8"	(865x2033)	8'-0"	(865x2439)	INSULATED ENTRANCE DOOR
1a	2'-8"	6'-8"	(815x2033)	8'-0"	(815x2439)	INSULATED FRONT DOORS
2	2'-8"	6'-8"	(815x2033)	8'-0"	(815x2439)	WOOD & GLASS DOOR
3	2'-8"	6'-8 x 1-3/4"	(815x2033x45)	8'-0" x 1-3/4"	(815x2439x45)	EXTERIOR SLAB DOOR
4	2'-8"	6'-8" x 1-3/8"	(815x2033x35)	8'-0" x 1-3/8"	(815x2439x35)	INTERIOR SLAB DOOR
5	2'-6"	6'-8" x 1-3/8"	(760x2033x35)	8'-0" x 1-3/8"	(760x2439x35)	INTERIOR SLAB DOOR
6	2'-2"	6'-8" x 1-3/8"	(660x2033x35)	8'-0" x 1-3/8"	(660x2439x35)	INTERIOR SLAB DOOR
7	1'-6"	6'-8" x 1-3/8"	(460×2033×35)	8'-0" x 1-3/8"	(460x2439x35)	INTERIOR SLAB DOOR
8	3'-0"	6'-8" x 1-3/8"	(915x2033x35)	8'-0" x 1-3/8"	(915x2439x35)	INTERIOR SLAB DOOR



2012 CODE

HE CONTRACTOR SHALL CHECK AND VERIFY ALL DIMENSIONS AND DNDITIONS ON SITE BEFORE PROCEEDING NY DISCREPANCIES SHALL BE REPORTED T C. PRIOR TO COMMENCEMENT OF WORK. RDIN DESIGN GROUP INC. IS NOT RESPONSIBLE FOR THE ACCURA SURVEY, STRUCTURAL OR ENGINEERING INFORMATION SHOWN (CONSTRUCTED INVERTS MUST BE VERIFIED PRIOR TO POURING DOTINGS. DEC. 2, 2020 REV. AS PER CITY COMMENT; ARDIN DESIGN GROUP INC. HAS NOT BEEN RETAINED TO CARRY C REISSUED FOR PERMIT
ISSUED FOR BUILDING PERMI DEBUERAL REVIEW OF THE WORK AND ASSUMES NO RESPONSIBILITY OF THE FAILURE OF THE CONTRACTOR OR SUB-CONTRACTOR TO ARRY OUT THE WORK IN ACCORDANCE WITH THE CONTRACT OCCUMENTS. JULY 2, 2020 AUG. 17, 2018 PREPARED TO PACKAGE 'A1 THIS DRAWING IS AN INSTRUMENT OF SERVICE, IS PROVIDED BY AND I THE PROPERTY OF JARDIN DESIGN GROUP INC. THIS DRAWING IS NO TO BE SCALED. ISSUED TO CLIENT DATE WORK DESCRIPTION

for this design and has the qualifications and meets the quirements set out in the Ontario Building Code to be a designer OUALIFICATION INFORMATION Walter Botter SIGNATURE BCIN REGISTRATION INFORMATION design is exempt under Divis 3.2.4 of the building code

27763

jardin design group inc.

FIRM NAME

The undersioned has reviewed and takes responsibil

DESIGN GROUP INC 64 JARDIN DR. SUITE 3A VAUGHAN ONT, L4K 3P3 TEL: 905 660-3377 FAX: 905 660-371 EMAIL: info@jardindesign.ca

GENERAL NOTES

LAMPONE INVESTMENTS INC CITY OF MARKHAM




CALE: N.T.S. ROJ. No. 20-03


PACKAGE 'A1'

BUILDING STANDARDS DIVISION REVIEWED FOR COMPLIANCE WITH THE ONTARIO BUILDING CODE AND THE APPLICABLE ZONING BY-LAW 20.130096.000.00.CM

ALL CONSTRUCTION SHALL COMPLY WITH THE ONTARIO BUILDING CODE


NO PERSON SHALL CONSTRUCT OR DEMOLISH A BUILDING OR CAUSE A BUILDING TO BE CONSTRUCTED EXCEPT IN ACCORDANCE WITH THESE CERTIFIED BUILDING PERMIT DOCUMENTS, THE

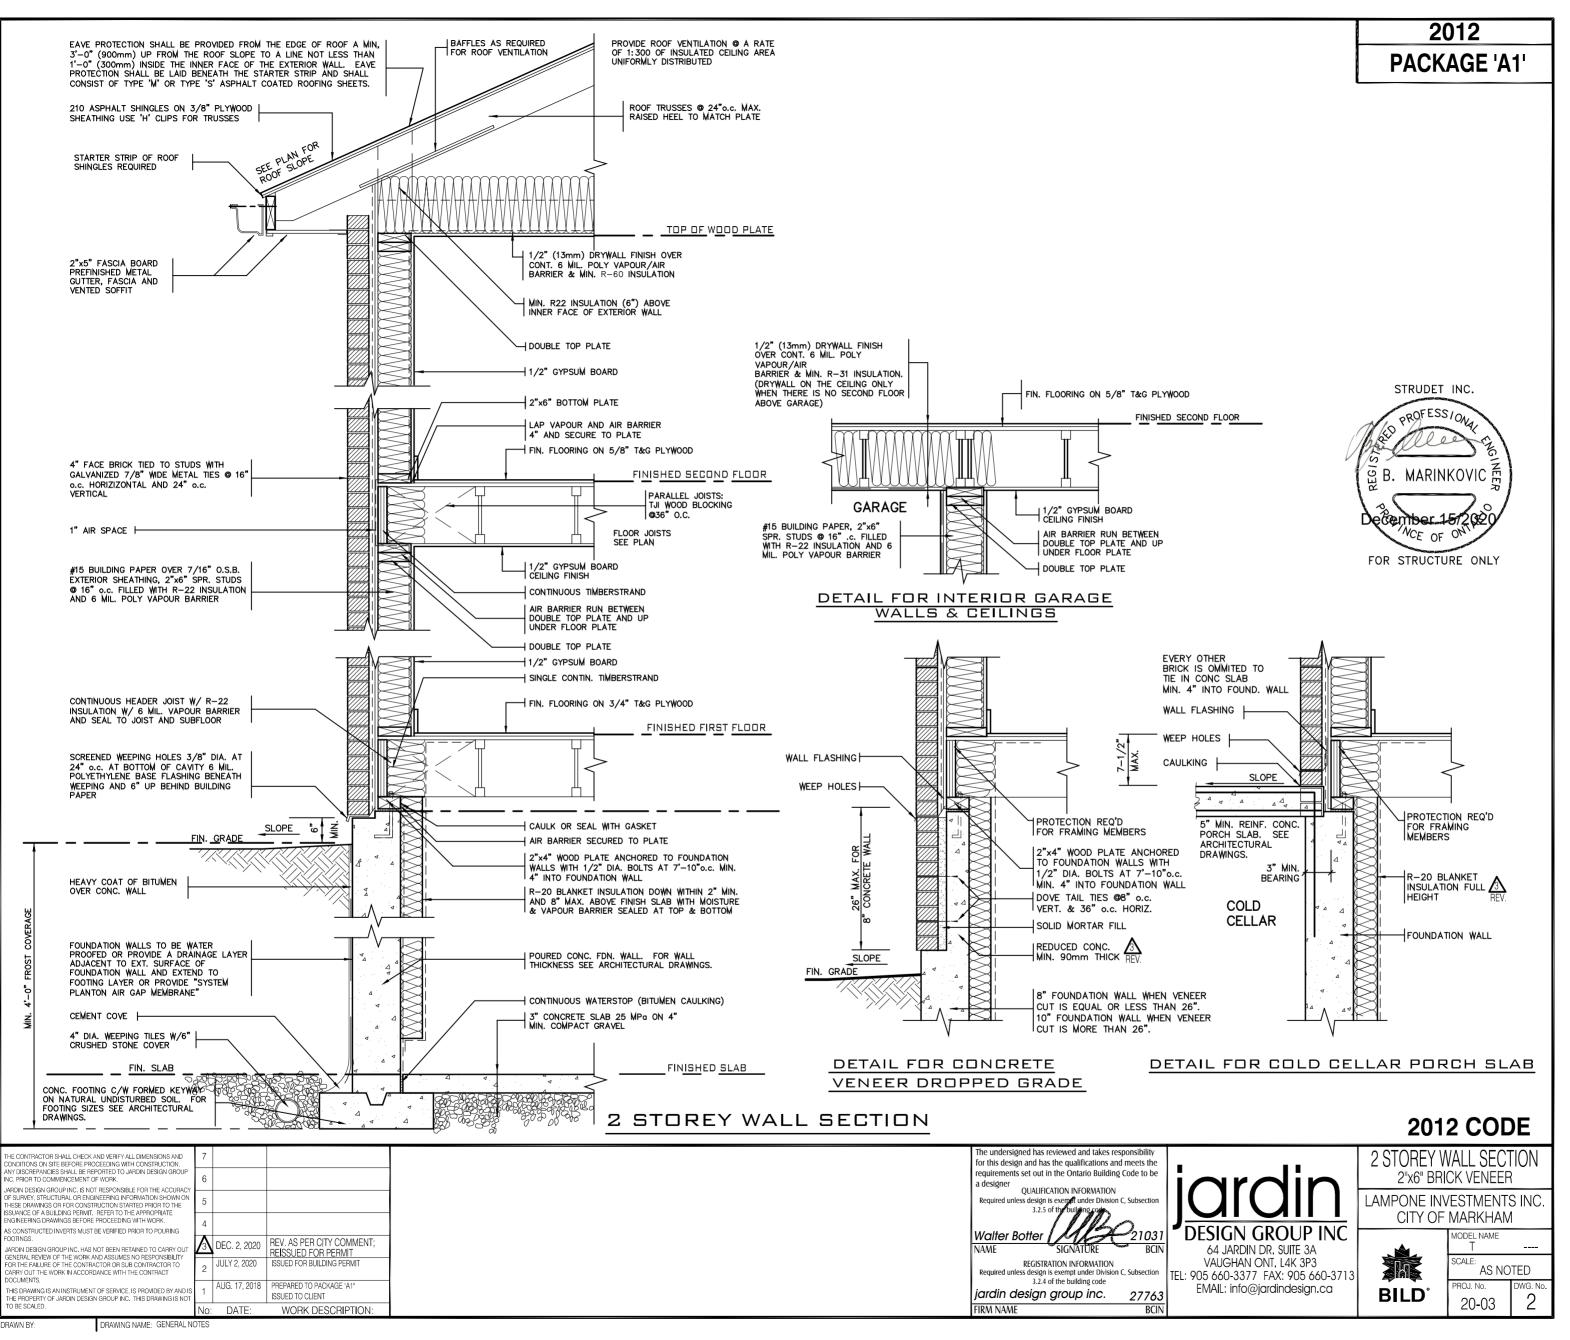

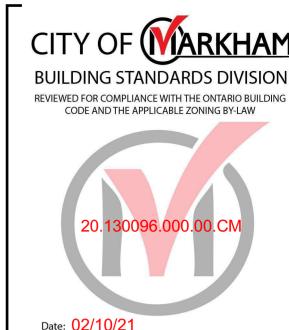

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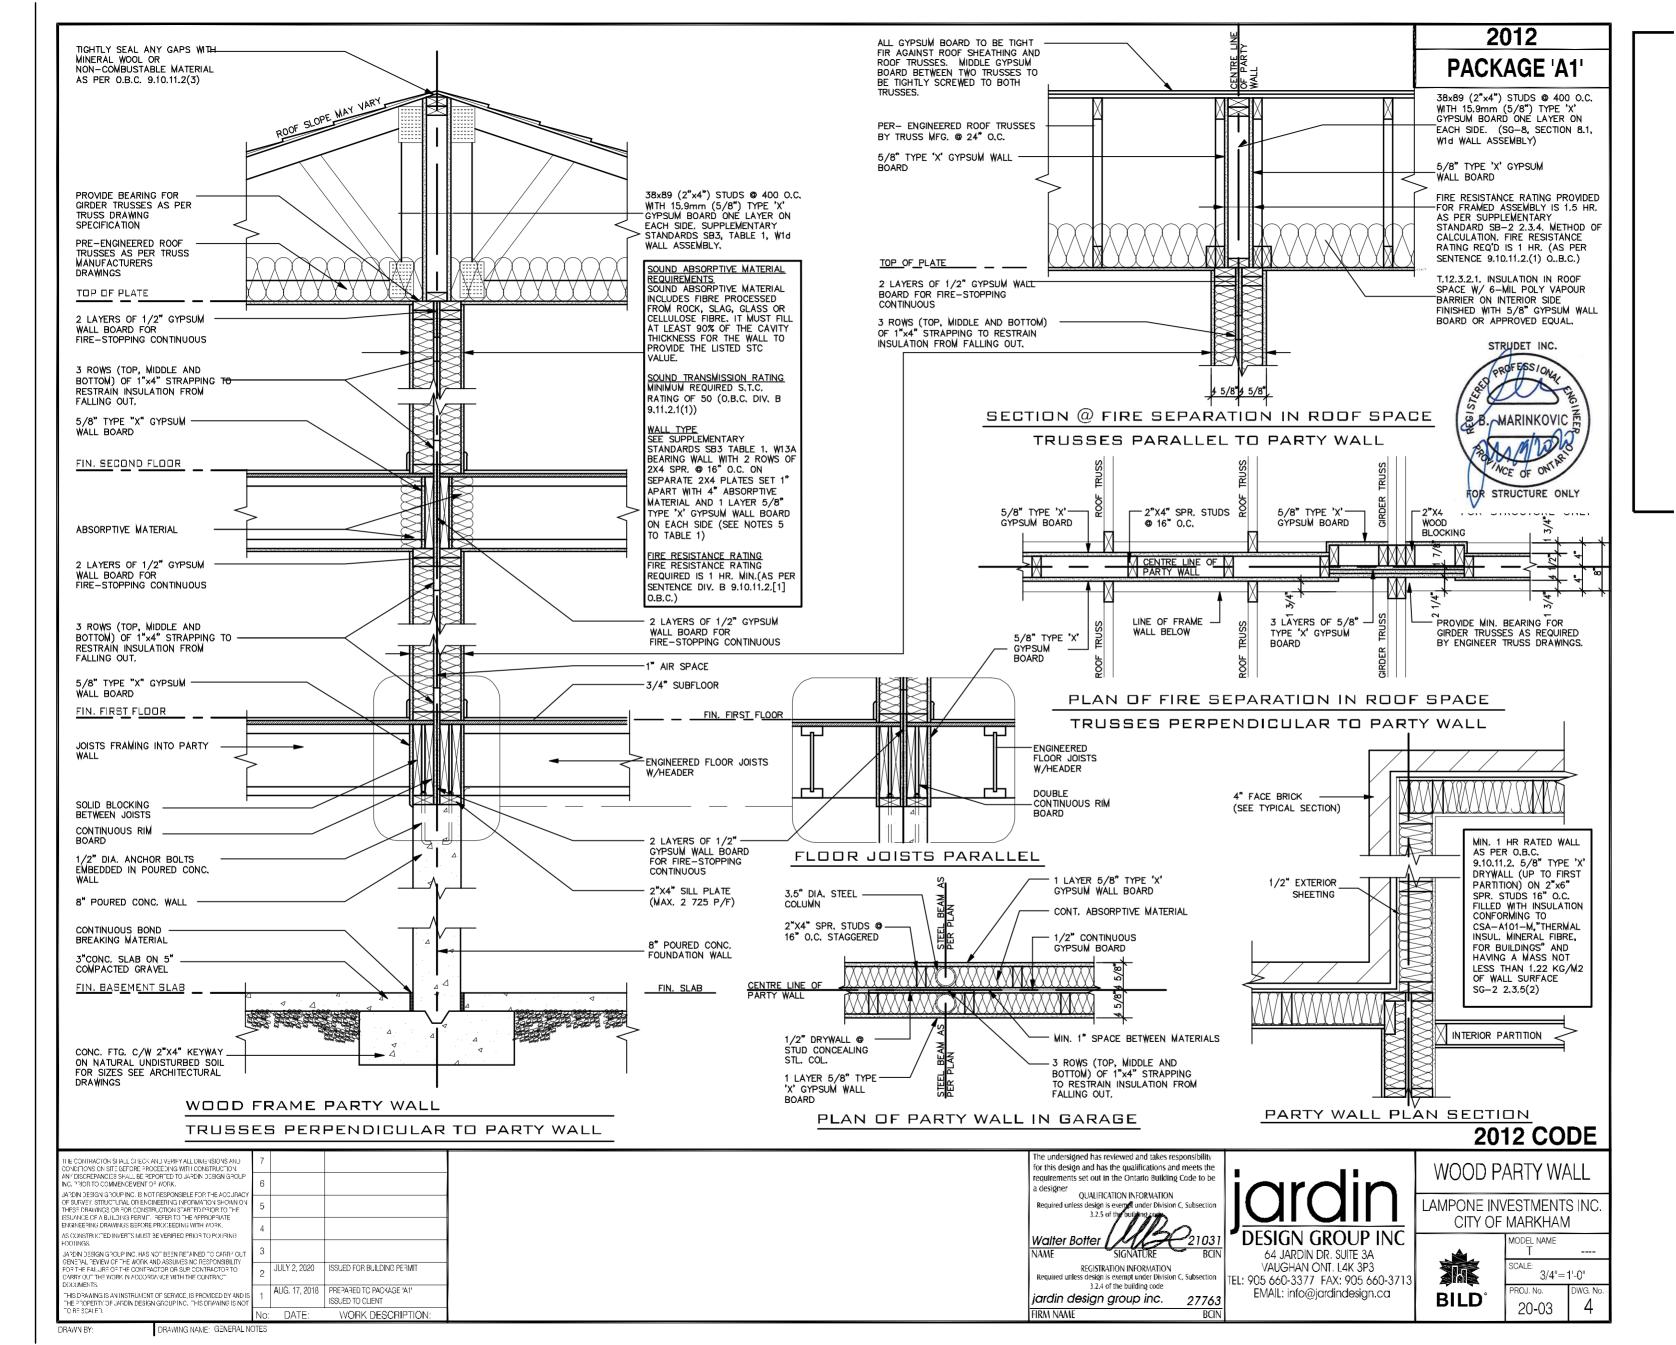


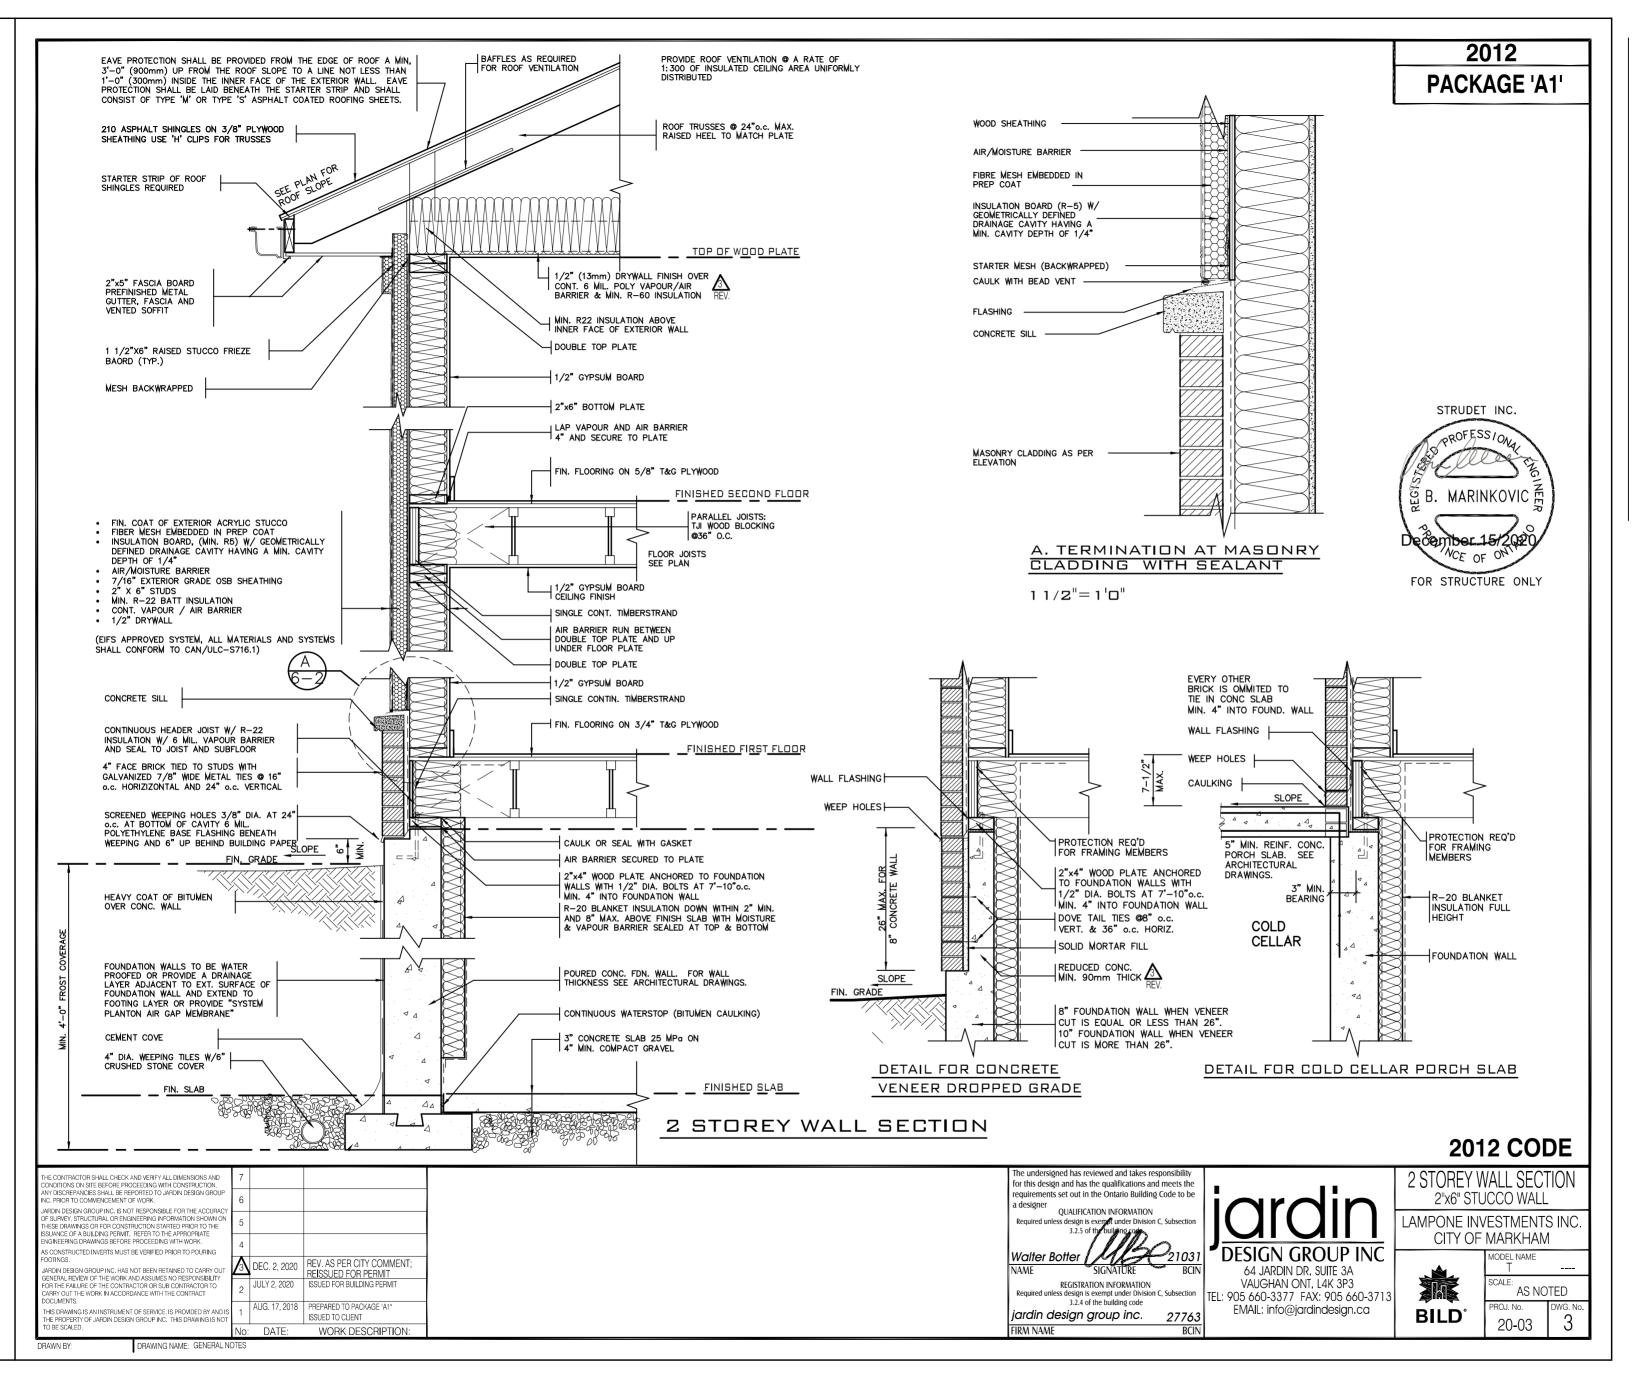

Date: 02/10/2

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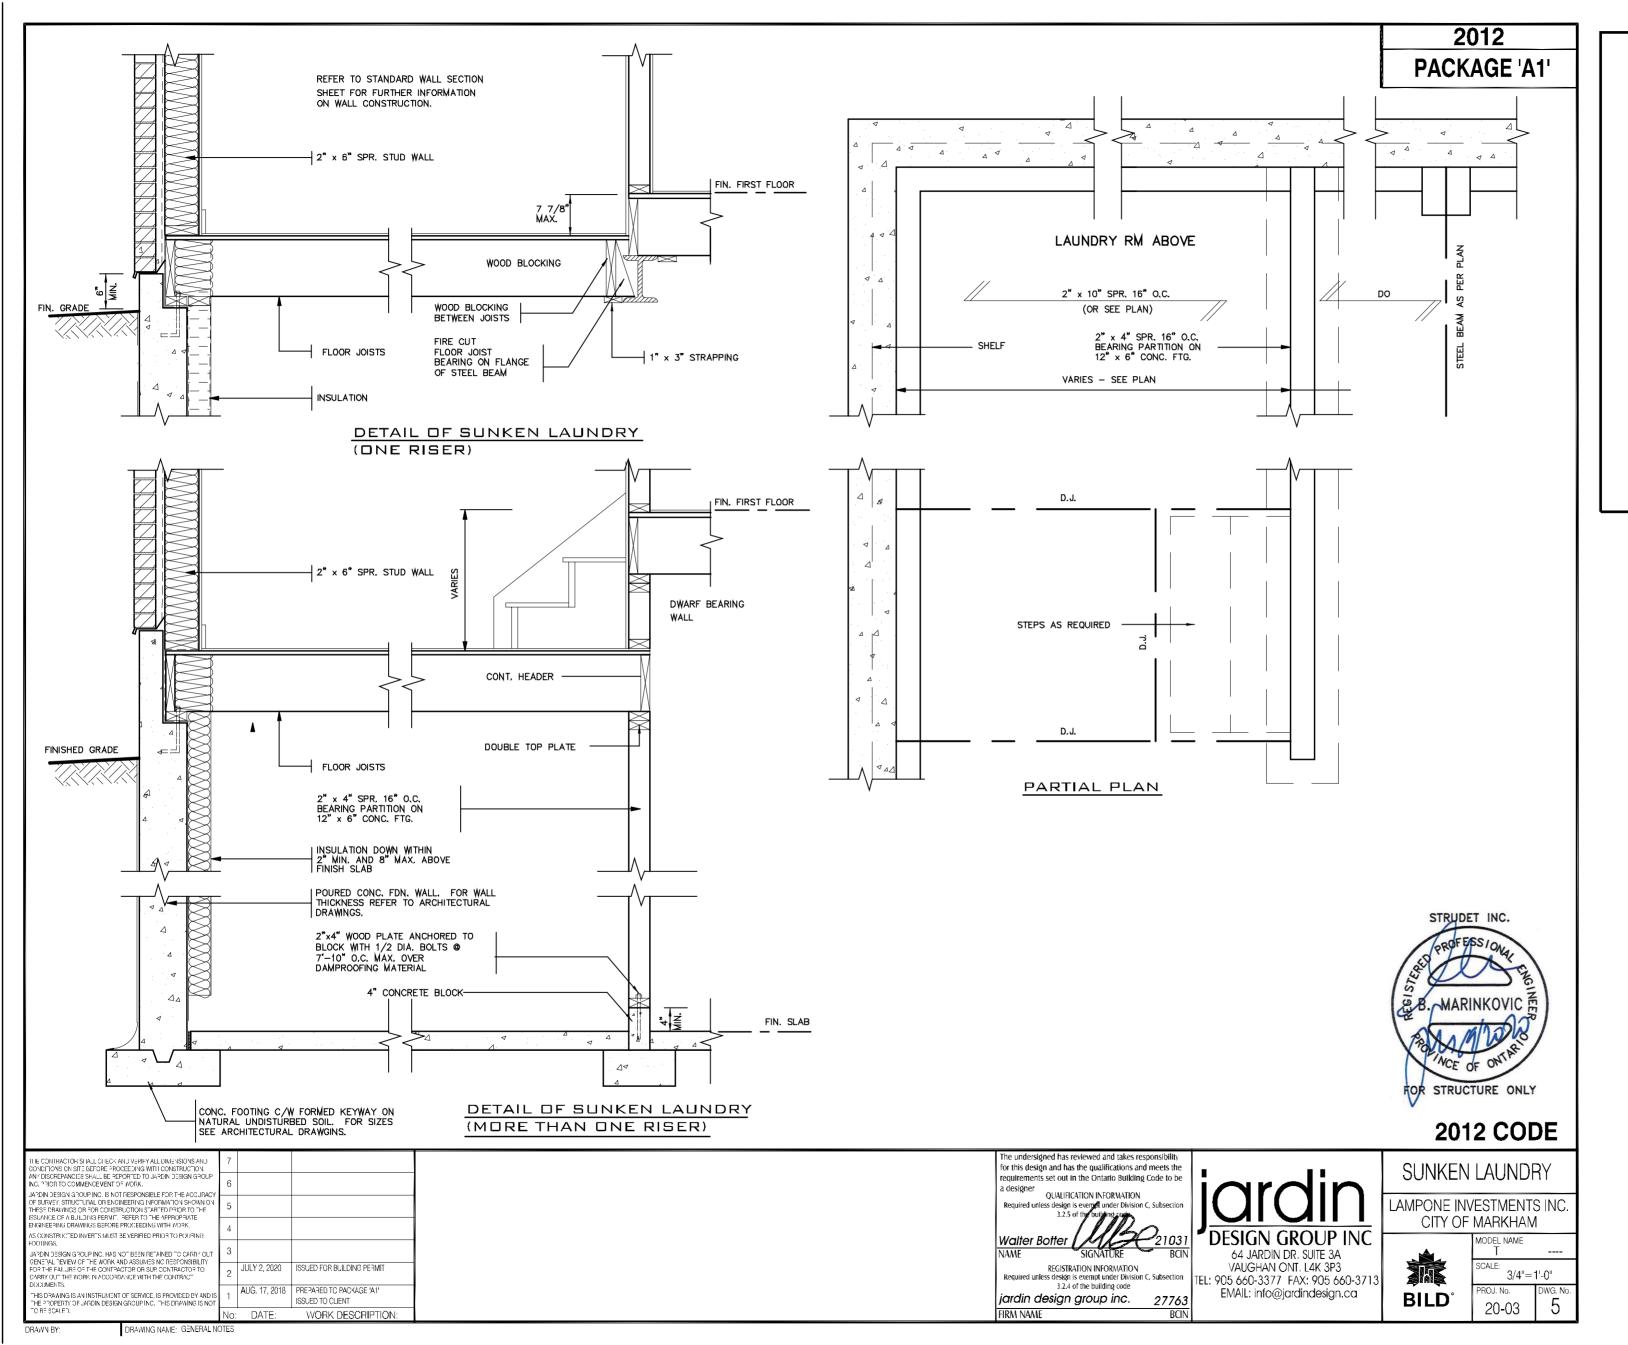






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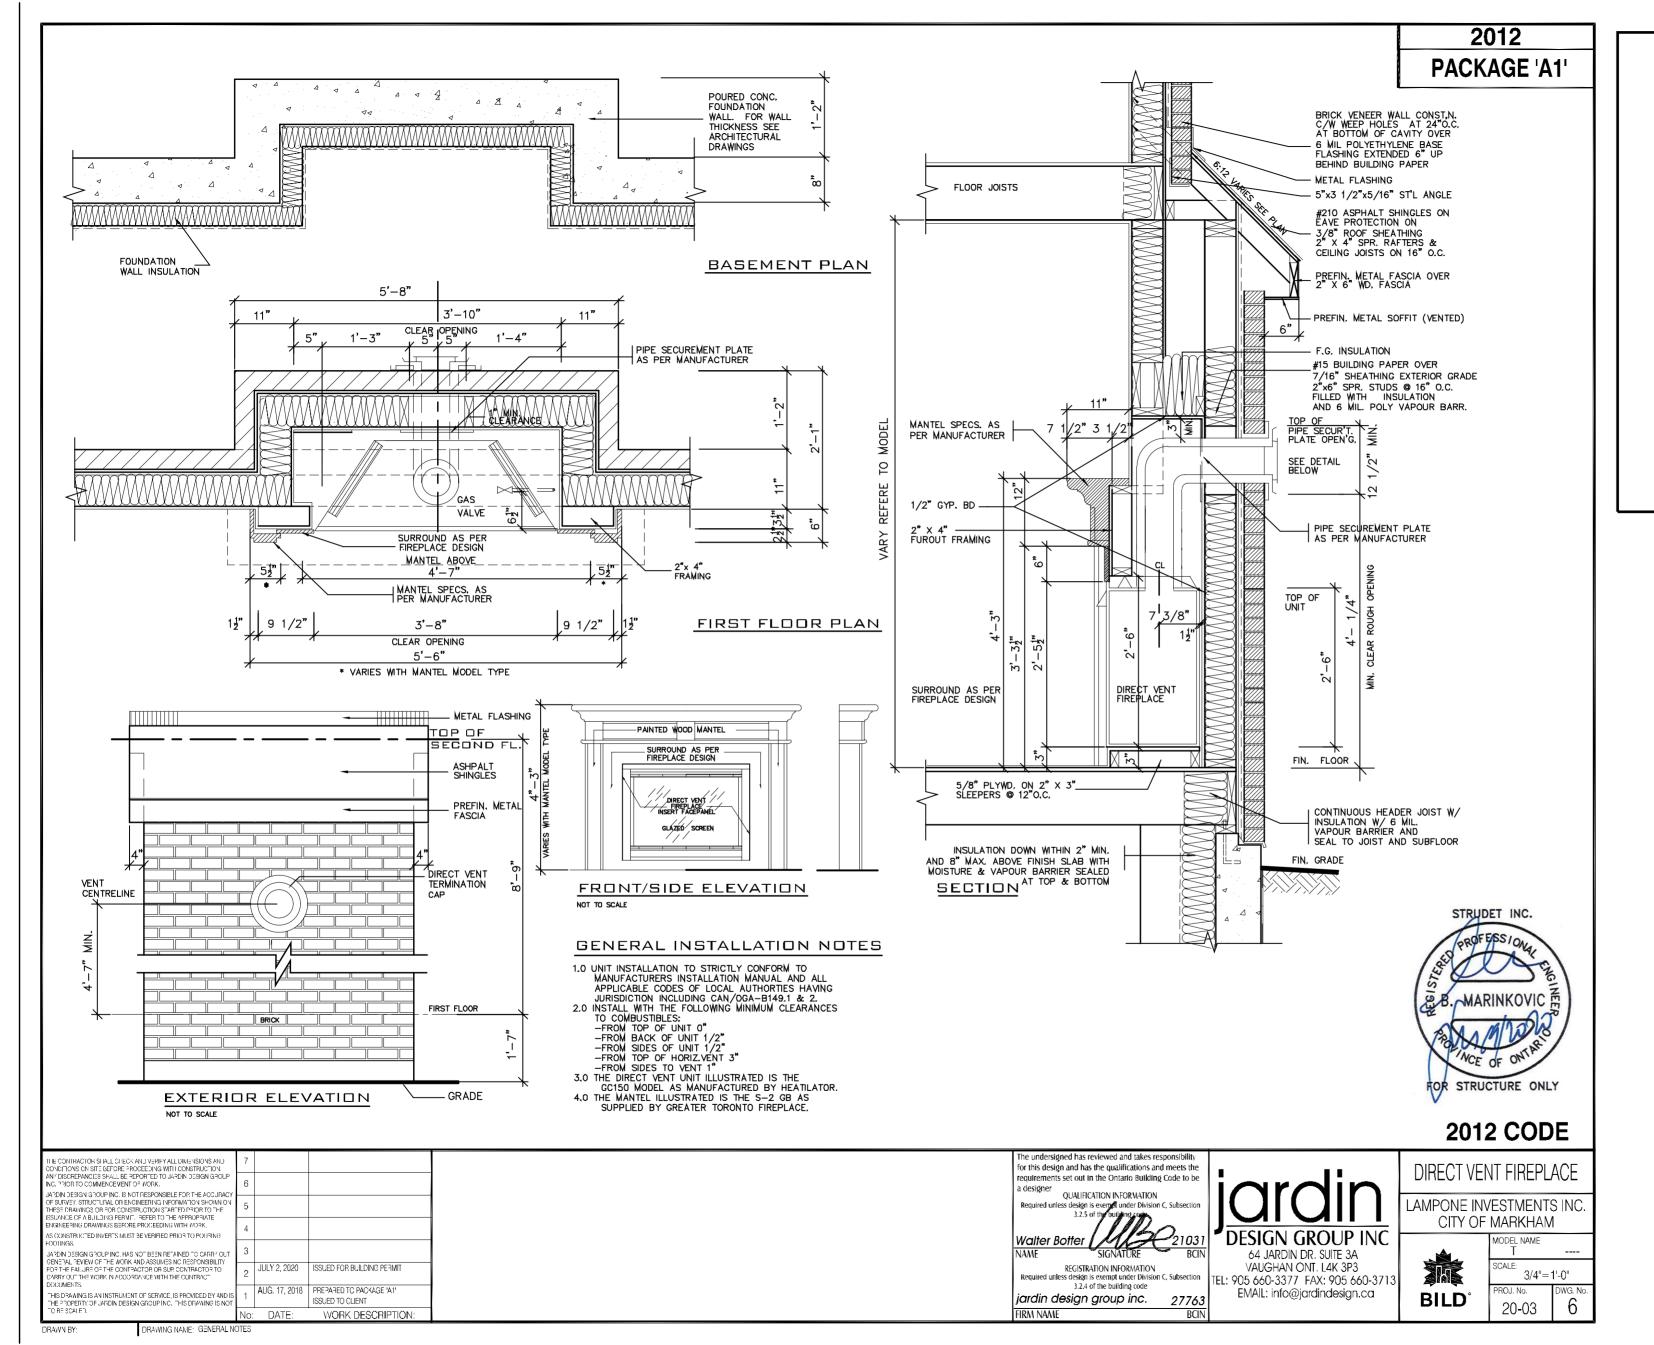
REVIEWED FOR COMPLIANCE WITH THE ONTARIO BUILDING CODE AND THE APPLICABLE ZONING BY-LAW




Date: 02/10/

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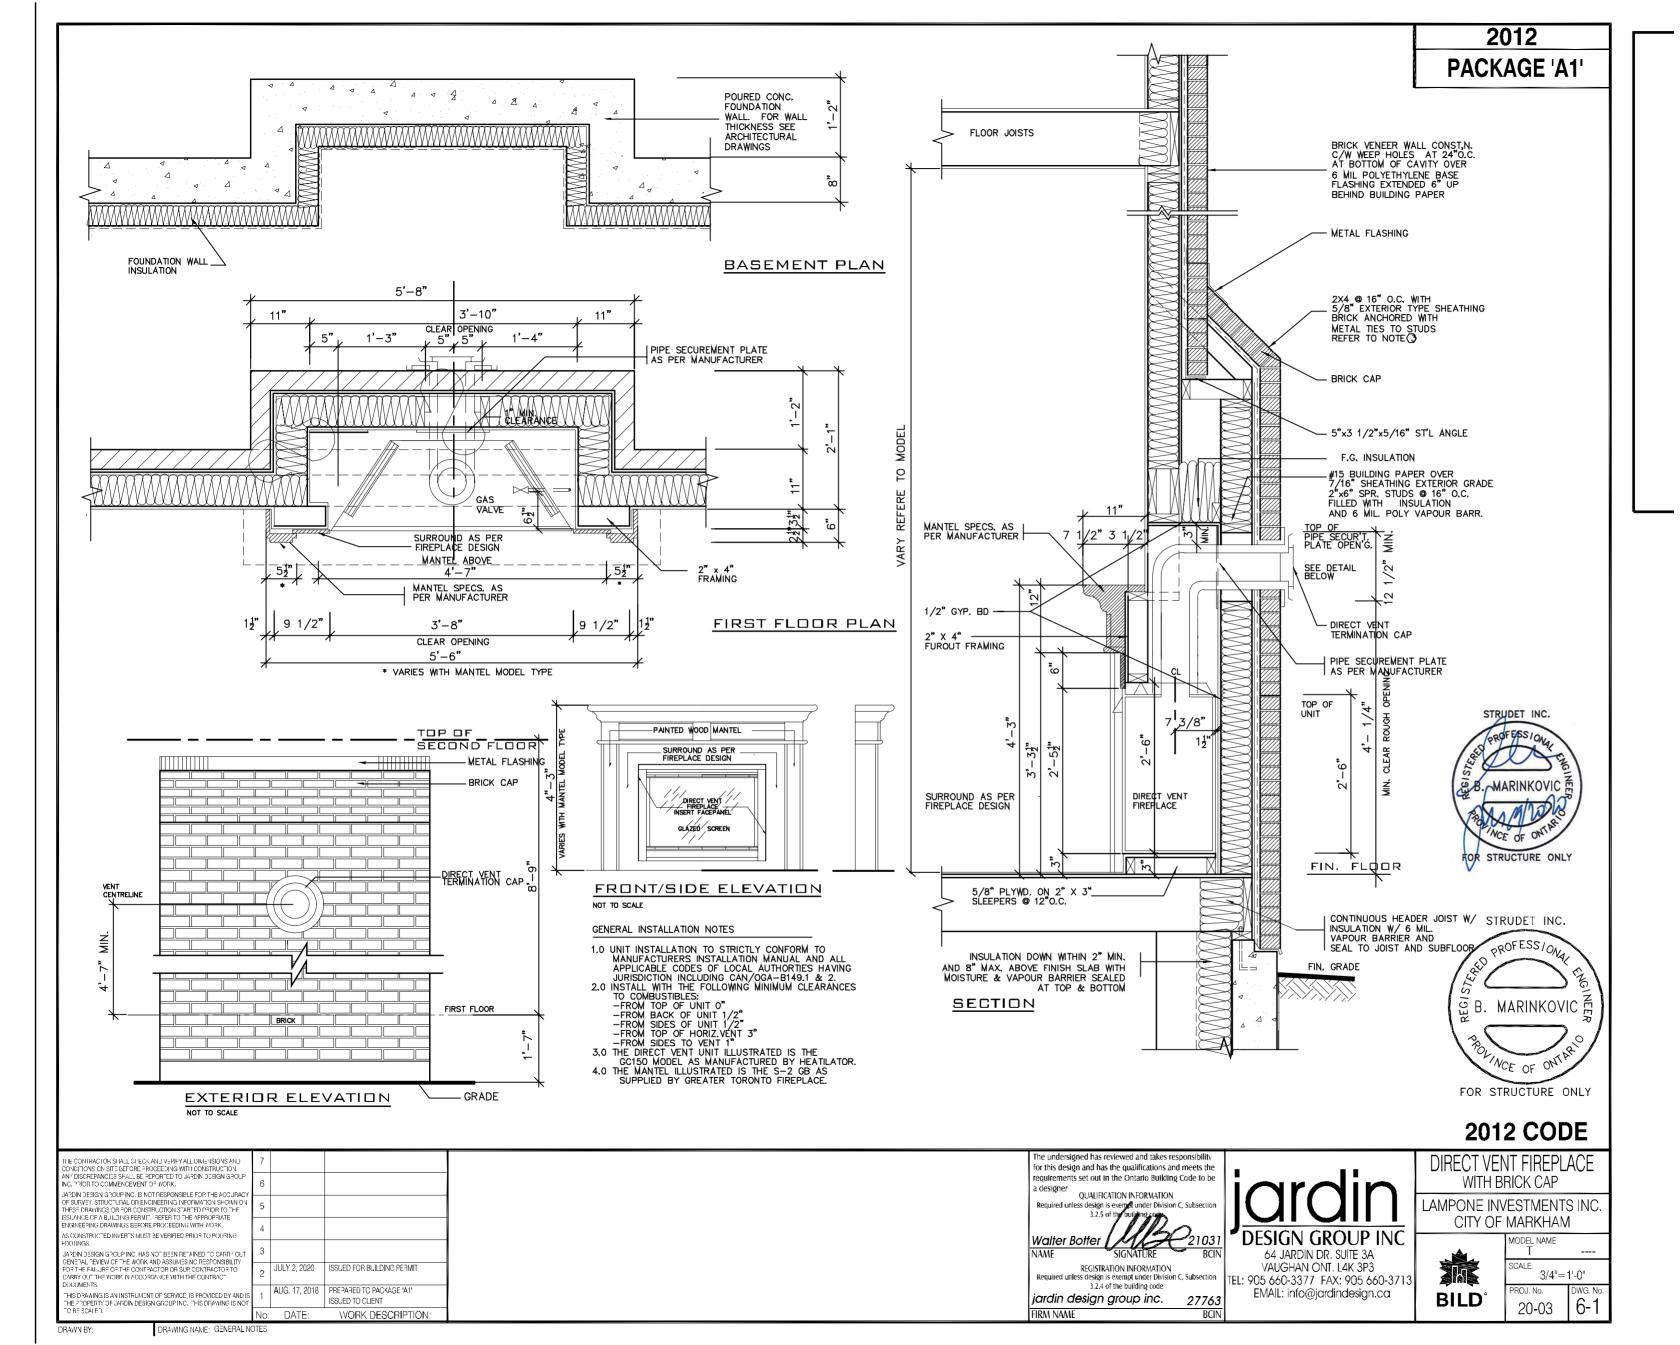






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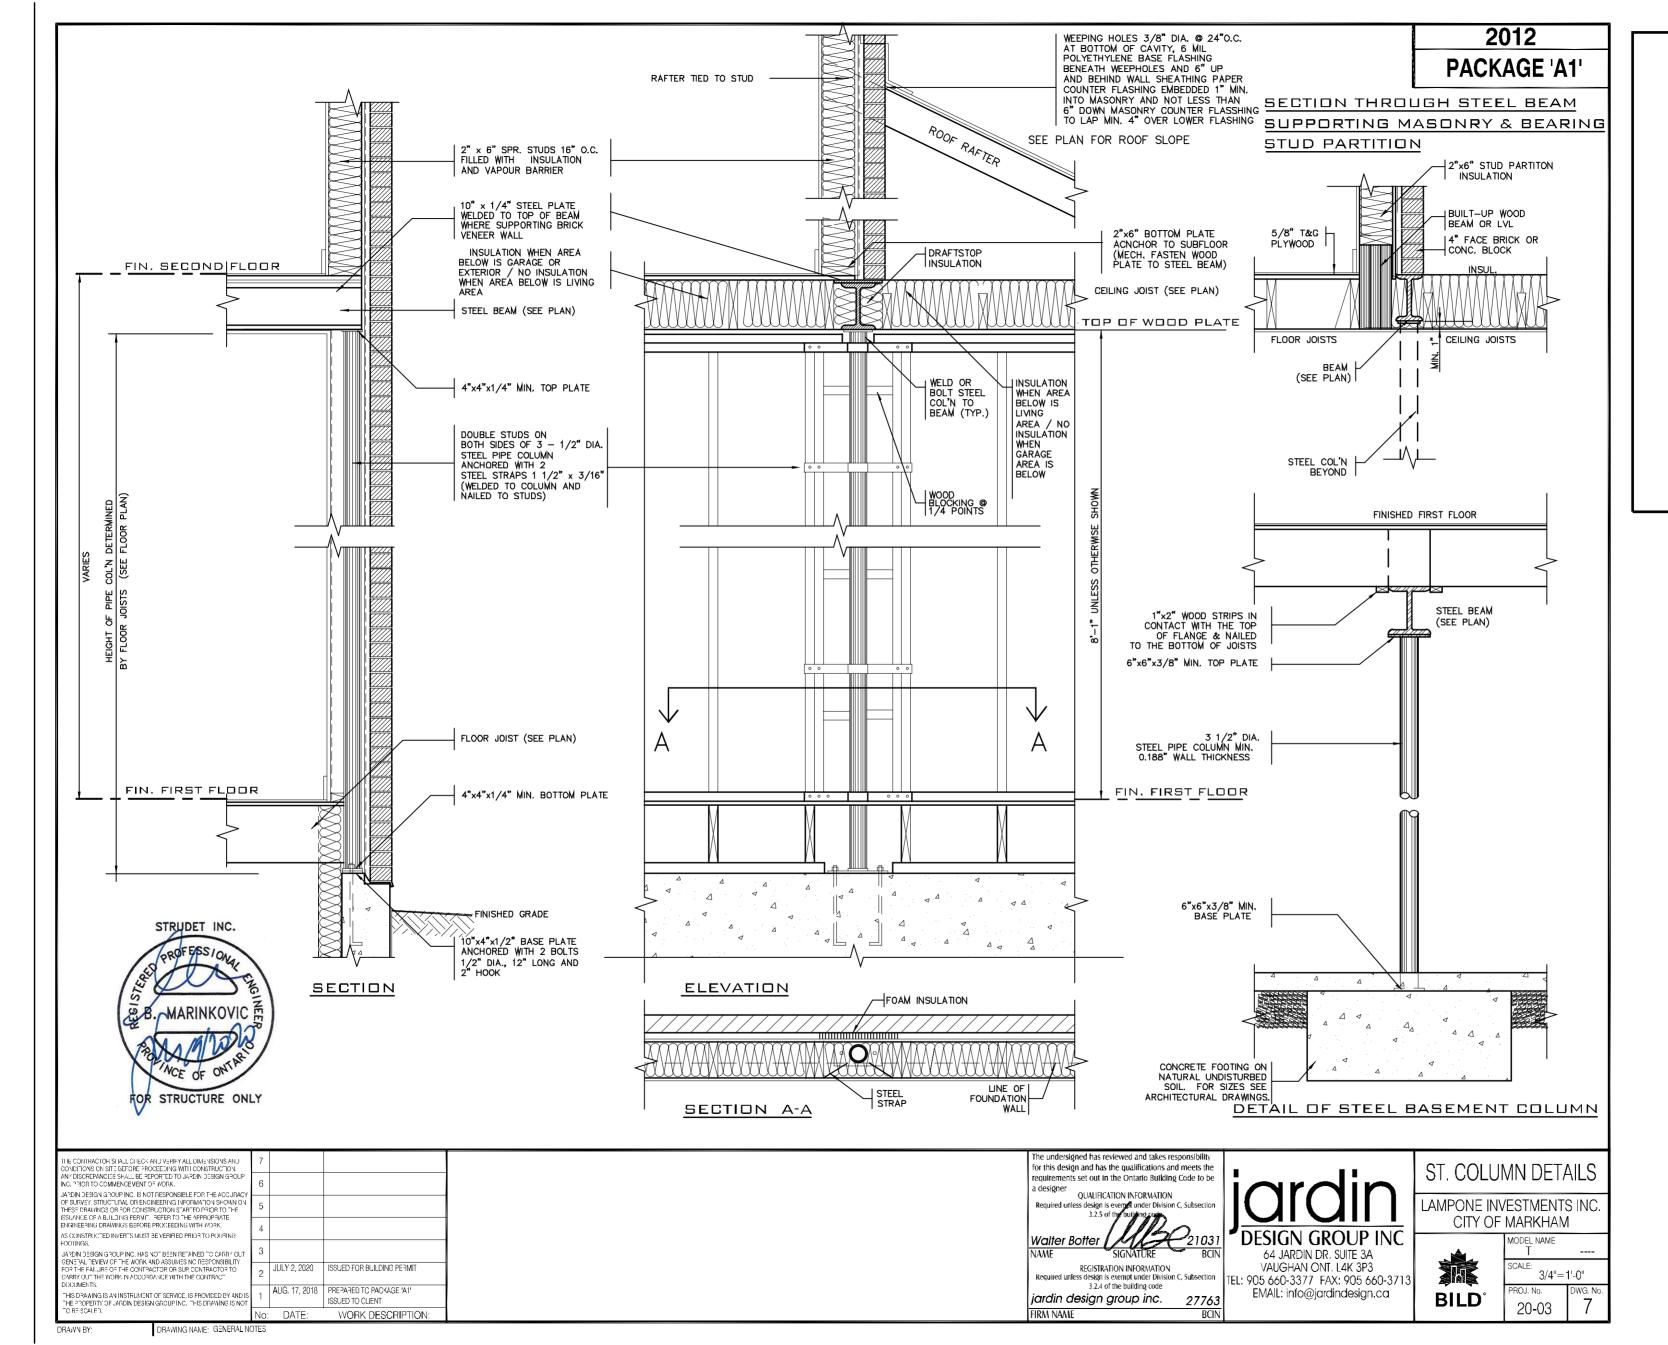


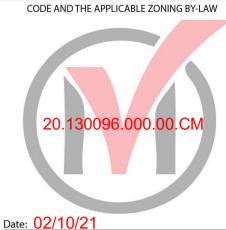

Date: 02/10/2

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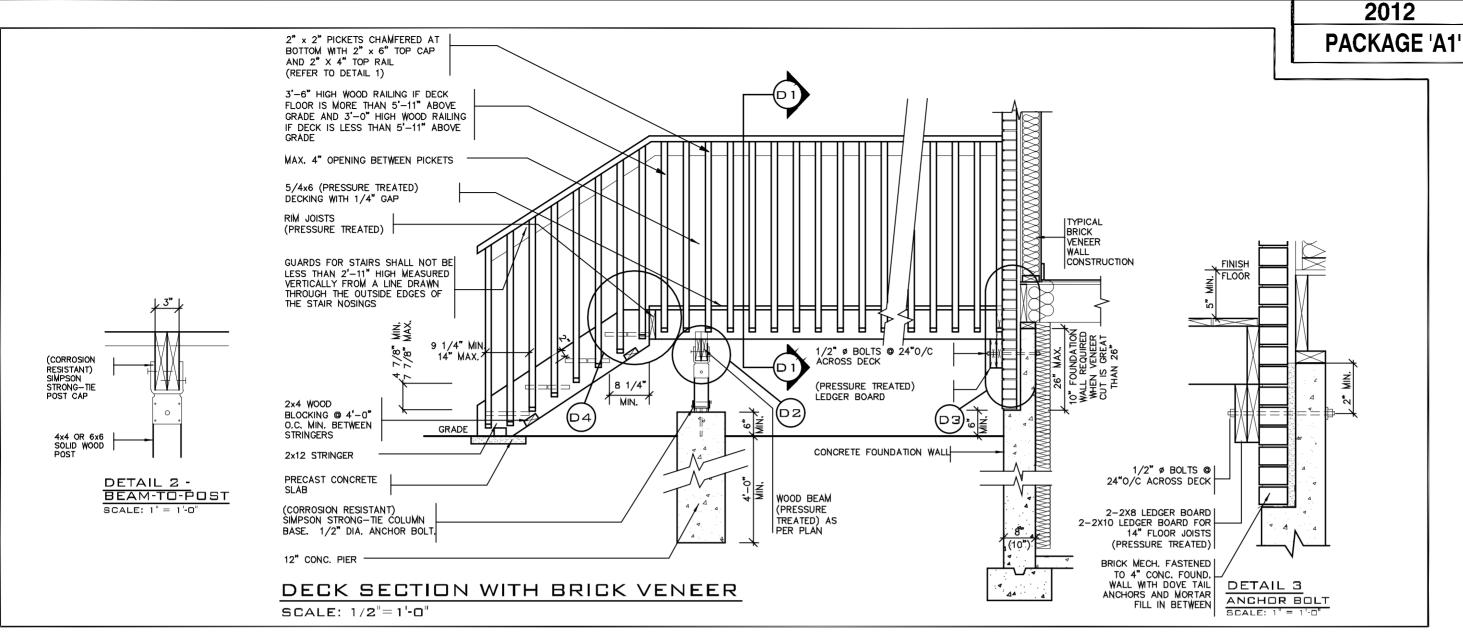
REVIEWED FOR COMPLIANCE WITH THE ONTARIO BUILDING CODE AND THE APPLICABLE ZONING BY-LAW





Date: 02/10/21

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GENERAL NOTES

- 1. BRICK TO BE COMPRESSIVE STRENGTH OF 15mPa (2200 p.s.i.) MIN, UNITS TO BE LAID WITH FULL HEAD AND BED JOINTS.
- MORTAR
 (3 /4") MAX. MORTAR TO BE TYPE S WITH JOINT THICKNESS OF 10mm (3 /8") MIN. AND 20mm
- 3, ALL NAILS AND SCREWS TO BE GALVANIZED.
- 4. WOOD FOR CANTILEVERED PICKETS PICKETS SHALL BE DOUGLAS FIR-LARCH, SPRUCE-PINE-FIR, OR HEM-FIR SPECIES.
- THE DECK HAS BEEN DESIGNED TO SAFELY SUPPORT A SUPERIMPOSED LOAD OF
- $6.\,\,$ Concrete shall have compressive strength of 20Mpa at 28 days and $5{-}8\%$ Air entrained.
- FOOTING TO BE PLACED ON UNDISTURBED SOIL WITH MIN. BEARING PRESSURE OF 150kPa [3130psf],

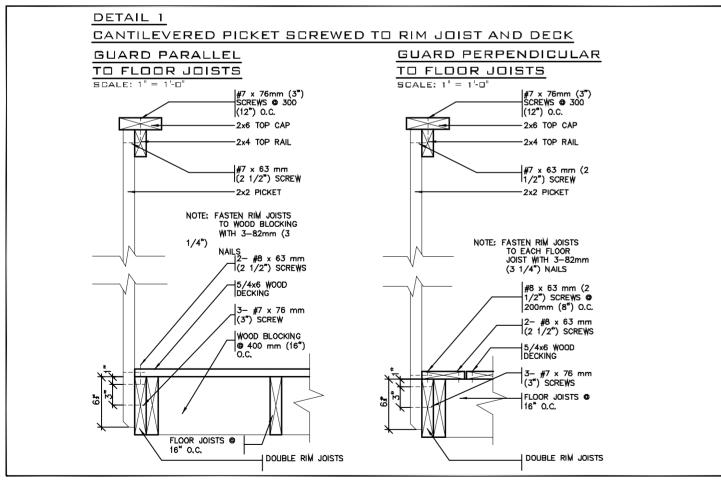

2012 CODE

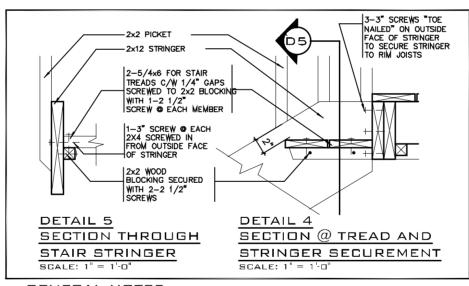WOOD DECK DETAIL

CONTRACTOR SHALL CHECK AND VEMINY ALL DIMENSIONS AND ICHTONS ON SITE BETORE PROCEEDING WITH CONSTRUCTION. DESCEPANCIES SHALL BE PEROPITED TO JAPPIN DESIGN GROUP PRIOR TO COMMENCE VENT OF WORK. CON DESIGN GROUP INC. IS NOT RESPONSIBLE FOR THE ACCURAC VEY, STRUCTURAL OR ENCINEERING INFORMATION SHOW SHAVINIOS OR FOR CONSTRUCTION STARTED FAIRS TO ECOFA BUILDING FERMIT. REFER TO THE APPROPRIATE ERING DRAVINGS BEFORE PROCEEDING WITH WORK. INSTRUCTED INVERTS MUST BE VERIFIED PRIOR TO POURING JULY 2, 2020 ISSUED FOR BUILDING PERMIT AUG. 17, 2018 PREPARED TO PACKAGE 'A1' WORK DESCRIPTION:

DRAWING NAME: GENERAL NOTES

for this design and has the qualifications and meets the uirements set out in the Ontario Building Code to be OUALIFICATION INFORMATION design is exempt under Division C, Subsectio 3.2.5 of the building code REGISTRATION INFORMATION ss design is exempt under Division 3.2.4 of the building code jardin design group inc.

64 JARDIN DR. SUITE 3A VAUGHAN ONT. L4K 3P3

EL: 905 660-3377 FAX: 905 660-3713

EMAIL: info@jardindesign.ca

LAMPONE INVESTMENTS INC. CITY OF MARKHAM NODEL NAME

瓢 BILD


AS SHOWN 8 20-03






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GENERAL NOTES


1. THE DECK HAS BEEN DESIGNED TO SAFELY SUPPORT A SUPERIMPOSED LOAD OF 1.9kPa [40psf].

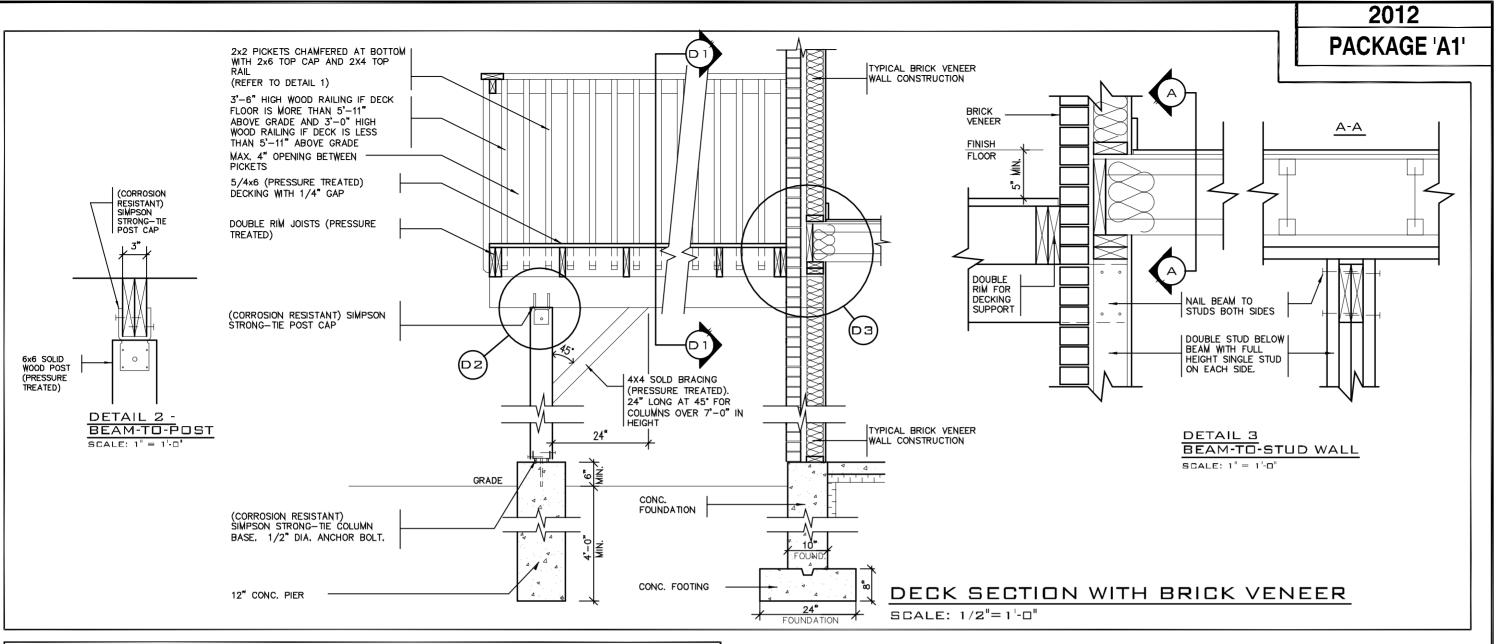ALL NAILS AND SCREWS TO BE GALVANIZED.

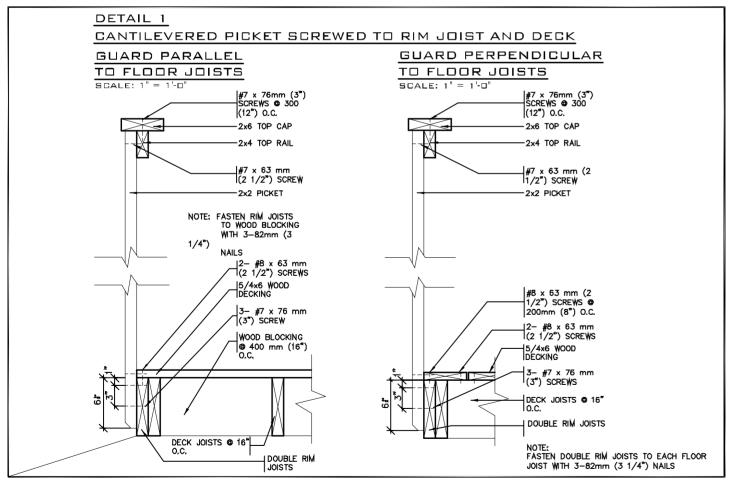3. WOOD FOR CANTILEVERED PICKETS PICKETS SHALL BE DOUGLAS FIR-LARCH, SPRUCE-PINE-FIR, OR HEM-FIR SPECIES.

4. CONCRETE SHALL HAVE COMPRESSIVE STRENGTH OF 20MPa AT 28 DAYS AND 5-8%% AIR ENTRAINED.

5. FOOTING TO BE PLACED ON UNDISTURBED SOIL WITH MIN. BEARING PRESSURE OF 150kPa [3130psf].

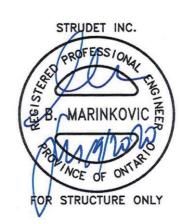

2012 CODE

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DRAWING NAME: GENERAL NOTES

for this design and has the qualifications and meets the quirements set out in the Ontario Building Code to be a designer OUALIFICATION INFORMATION

design is exempt under Division C, Subsection 3.2.5 of the building code

REGISTRATION INFORMATION ss design is exempt under Division 3.2.4 of the building code jardin design group inc.

64 JARDIN DR. SUITE 3A

VAUGHAN ONT. L4K 3P3 EL: 905 660-3377 FAX: 905 660-3713 EMAIL: info@jardindesign.ca

WALK-OUT DECK DETAIL


LAMPONE INVESTMENTS INC. CITY OF MARKHAM



NODEL NAME


AS SHOWN 20-03

BUILDING STANDARDS DIVISION REVIEWED FOR COMPLIANCE WITH THE ONTARIO BUILDING

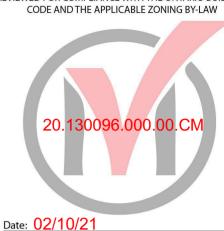

ALL CONSTRUCTION SHALL COMPLY WITH THE ONTARIO BUILDING CODE

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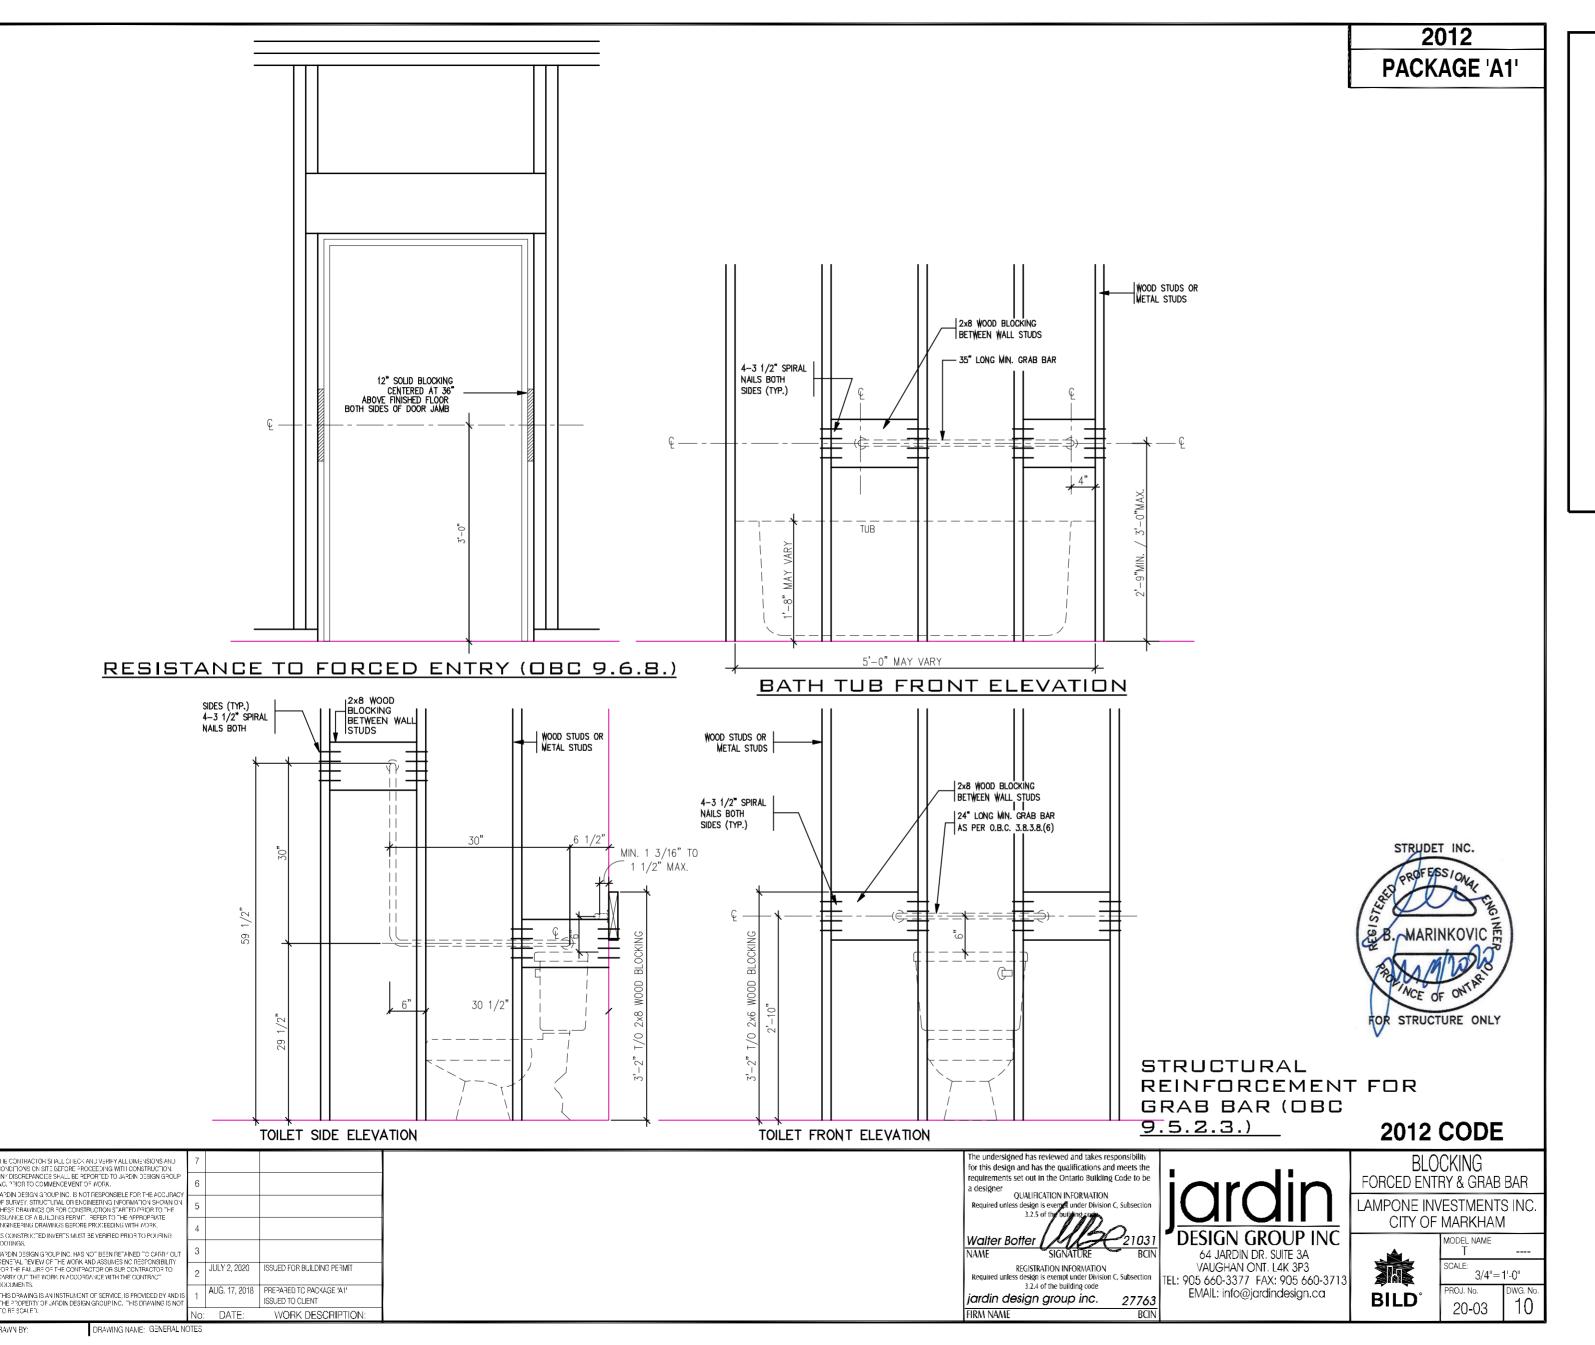

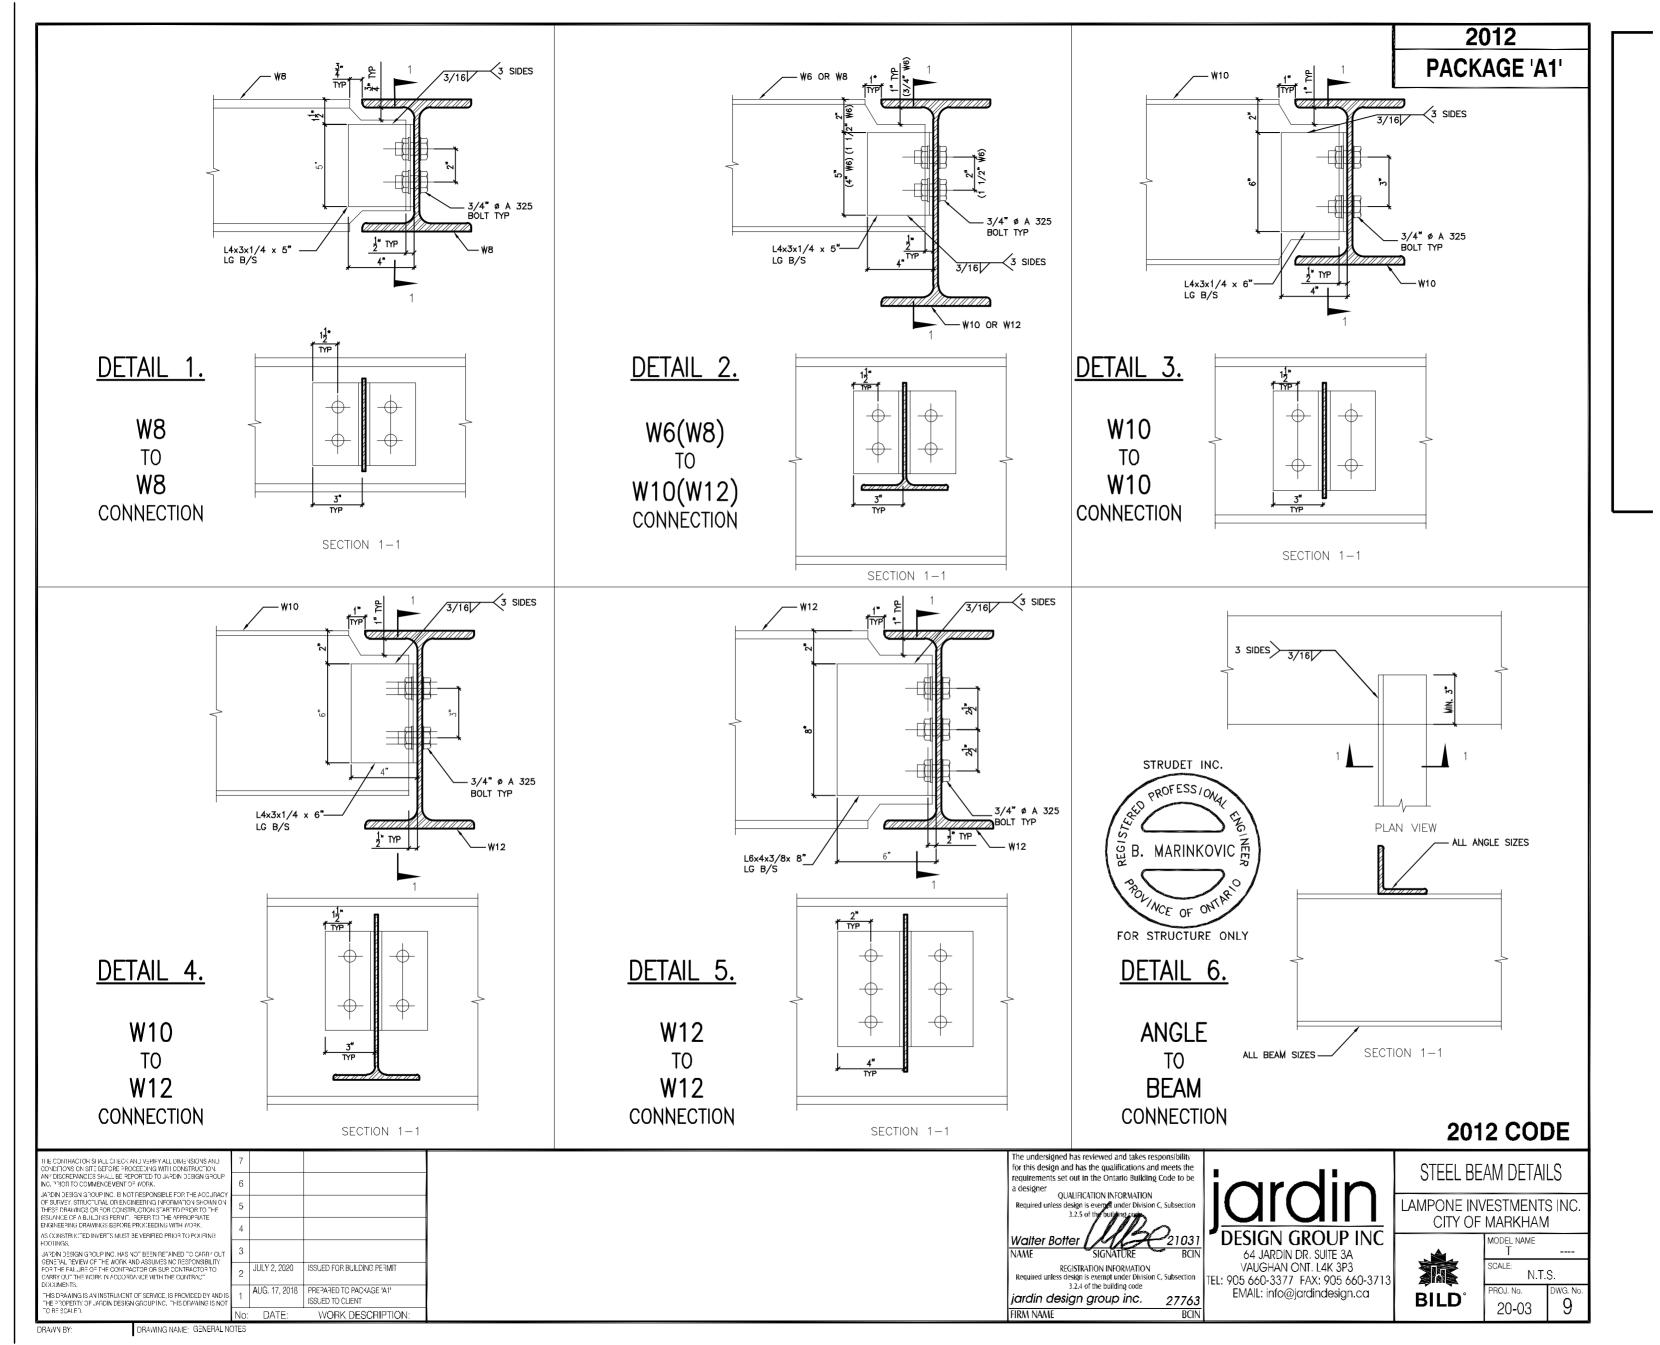
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Date: 02/10/21

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CITY OF WARKHAM
BUILDING STANDARDS DIVISION


REVIEWED FOR COMPLIANCE WITH THE ONTARIO BUILDING CODE AND THE APPLICABLE ZONING BY-LAW



Date: 02/10/21

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PLAN VIEW

AIR SPACE

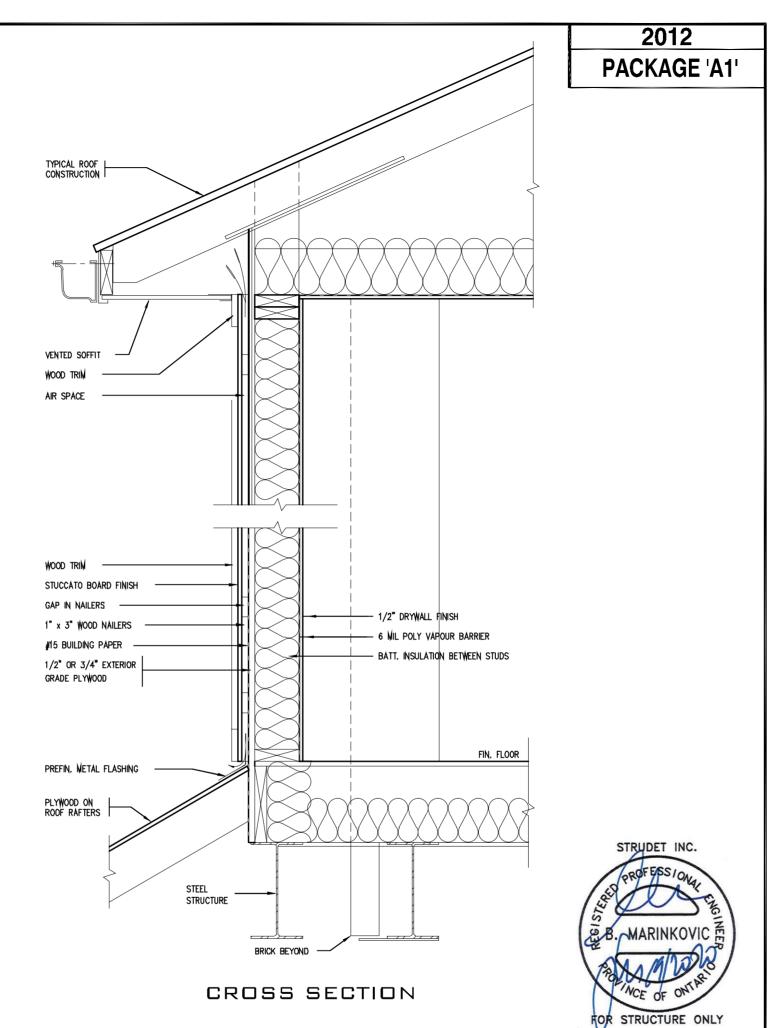WOOD TRIM -

BRICK VENEER

STUCCATO BOARD FINISH CLADDING (OBC 9.27.)

VARIES

R.S.O. VARIES

VÁRIFS

- WINDOW FRAME

-WINDOW TRIM

SHIM SPACE

2012 CODE

for this design and has the qualifications and meets the equirements set out in the Ontario Building Code to be OUALIFICATION INFORMATION

REGISTRATION INFORMATION Required unless design is exempt under Division C, Subsection 3.2.4 of the building code jardin design group inc.

64 JARDIN DR. SUITE 3A

VAUGHAN ONT. L4K 3P3 TEL: 905 660-3377 FAX: 905 660-3713 EMAIL: info@jardindesign.ca

STUCCATO BOARD FINISH CLADDING

LAMPONE INVESTMENTS INC. CITY OF MARKHAM



1"=1'-0" 20-03

BUILDING STANDARDS DIVISION REVIEWED FOR COMPLIANCE WITH THE ONTARIO BUILDING CODE AND THE APPLICABLE ZONING BY-LAW



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NOTE: THE PROPOSED DEVELOPMENT IS SUBJECT TO COMPLIANCE WITH ALL APPLICABLE PROVISIONS OF THE ZONING BY-LAW AND ALL OTHER APPLICABLE LAWS INCLUDING THE PROVISIONS OF A SITE PLAN AND / OR SUBDIVISION AGREEMENT WHICH MAY OR MAY NOT BE REGISTERED ON TITLE

CONTRACTOR SHALL CHECK AND YEMEY ALL DIMENSIONS AND ICPTONS ON SITE BETORE "PROCEEDING WITH CONSTRUCTION. IDSCREPANCIES SHALL BE "EPORTED TO JA-POIN DESIGN G-POUP "FIGHT TO COMMENCE VENT OF WORK. RDIN DESIGN GROUP INC. IS NOT RESPONSIBLE FOR THE ACCURAC INSTRUCTED INVERTS MUST BE VERIFIED PRIOR TO POURING JULY 2, 2020 ISSUED FOR BUILDING PERMIT

VARIES

STUCCATO BOARD FINISH

-1" x 3" WOOD NAILERS

- #15 BUILDING PAPER

GRADE PLYWOOD

—1/2" DRYWALL FINISH


-6 MIL POLY VAPOUR BARRIER BATT, INSULATION BETWEEN STUDS

AUG. 17, 2018 PREPARED TO PACKAGE 'A1' ISSUED TO CLIENT

WORK DESCRIPTION:

1/2" OR 3/4" EXTERIOR


DRAWING NAME: GENERAL NOTES

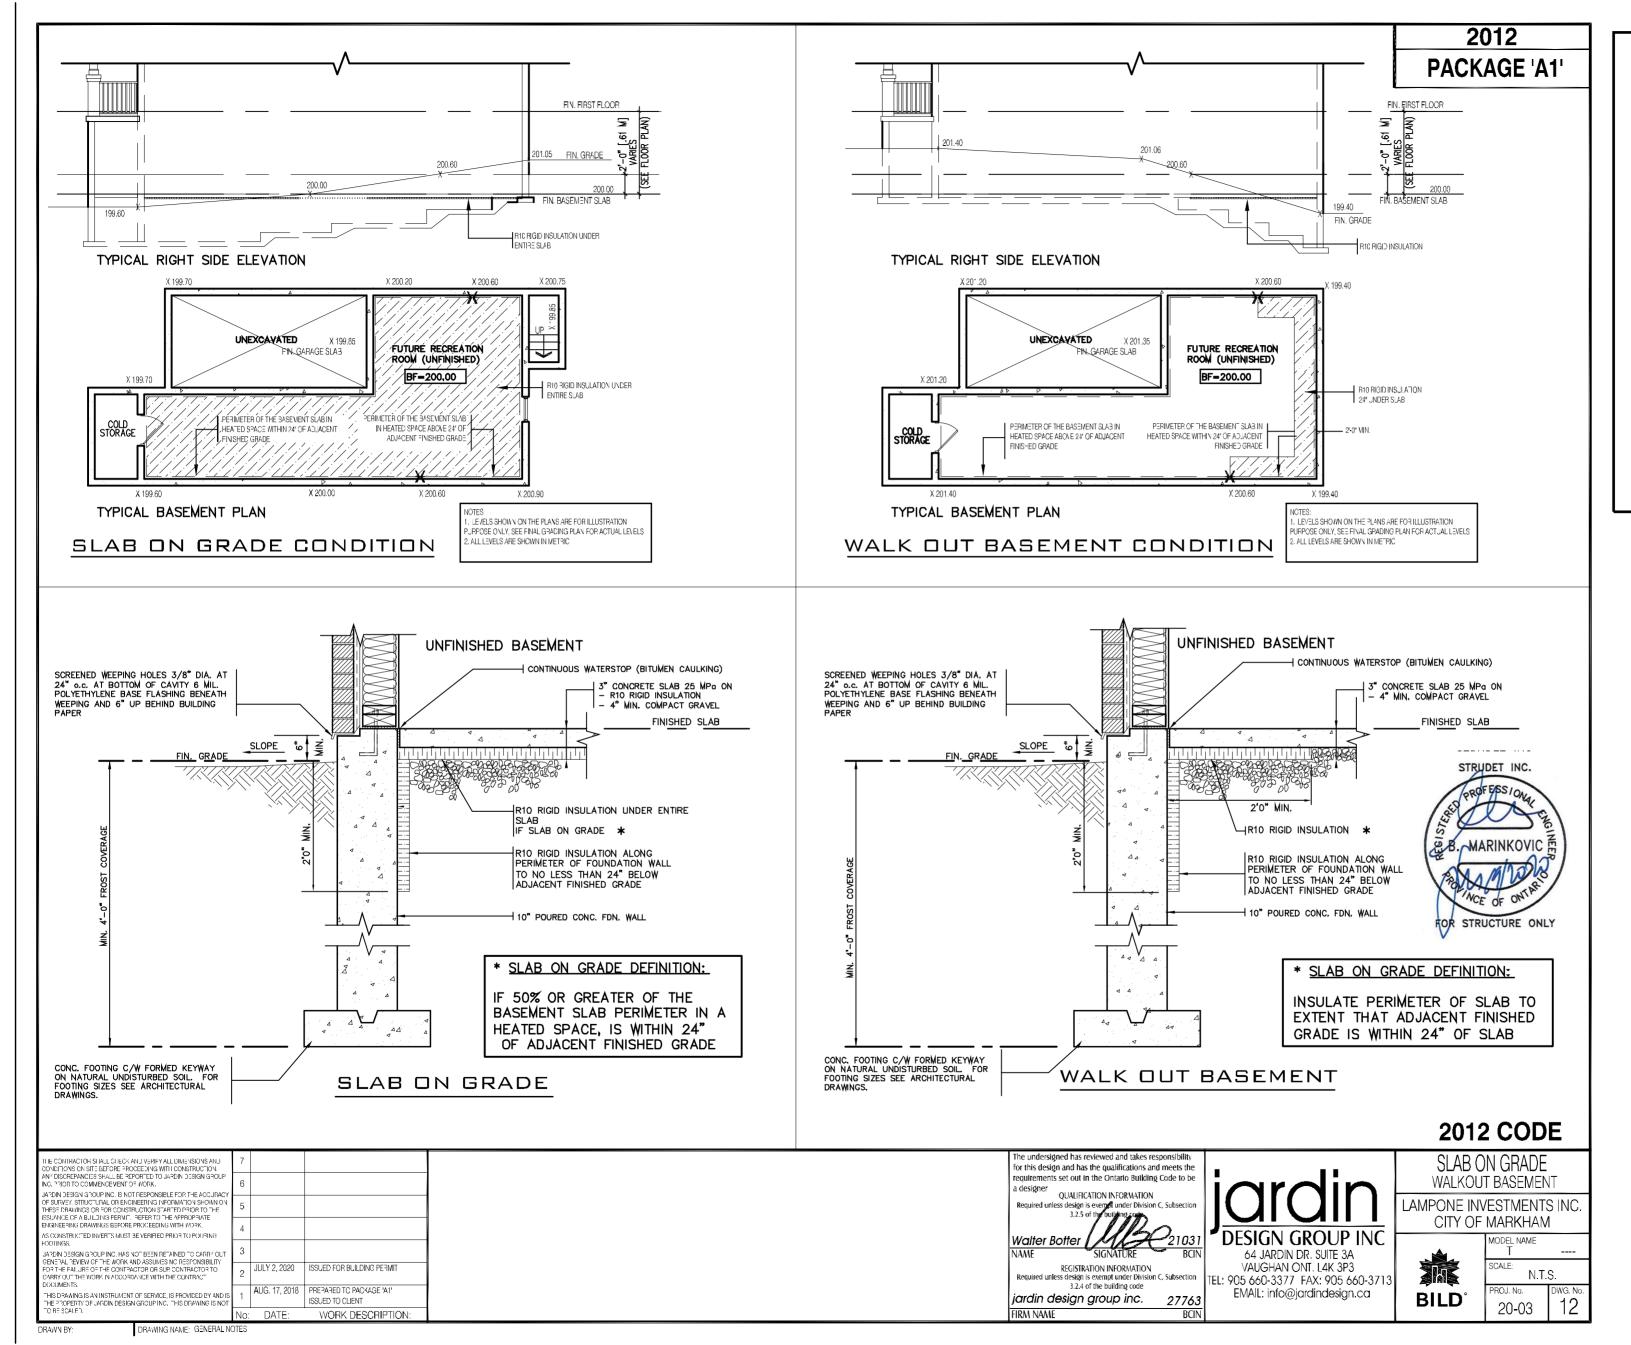



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AUG. 17, 2018 PREPARED TO PACKAGE 'A1'

DRAWING NAME: GENERAL NOTES

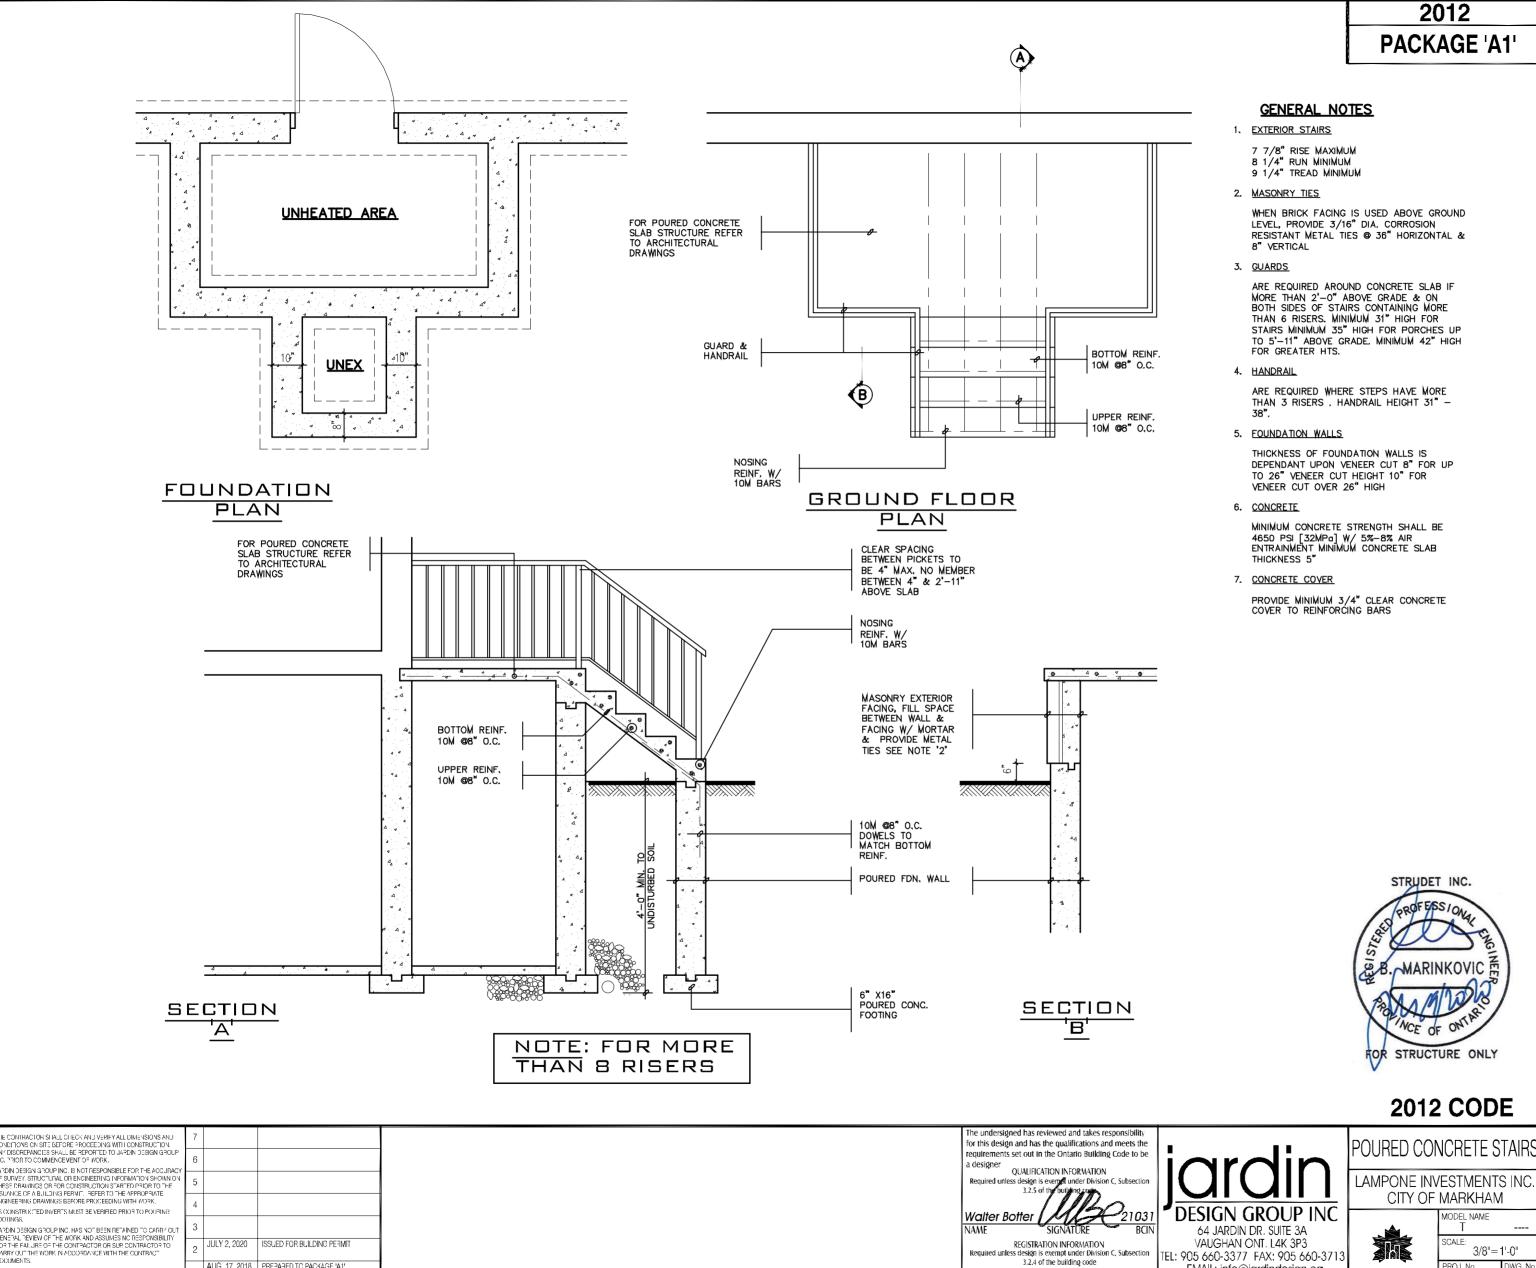WORK DESCRIPTION:



REVIEWED FOR COMPLIANCE WITH THE ONTARIO BUILDING CODE AND THE APPLICABLE ZONING BY-LAW



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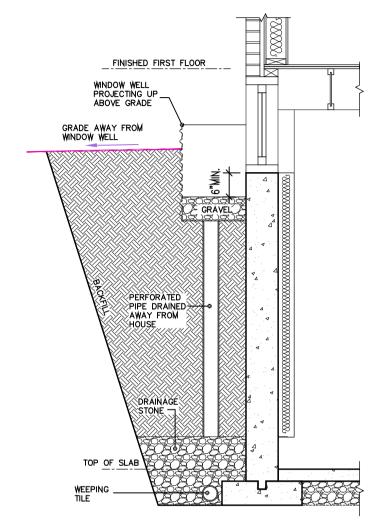
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TEL: 905 660-3377 FAX: 905 660-3713 EMAIL: info@jardindesign.ca

jardin design group inc.

BILD

3/8"=1'-0" 20-03



SECTION BASEMENT WINDOW WELL DETAIL

SCALE: 1/2" = 1'-0"



BUILDING STANDARDS DIVISION REVIEWED FOR COMPLIANCE WITH THE ONTARIO BUILDING

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THE CONTRACTOR SHALL CHECK AND VERIFY ALL DIMENSIONS AND CONDITIONS ON SITE BEFORE PROCEEDING WITH CONSTRUCTION, ANY DISCREPANCIES SHALL BE REPORTED TO JARDIN DESIGN GROUP INC, PRIOR TO COMMENCEMENT OF WORK,

JARDIN DESIGN GROUP INC, IS NOT RESPONSIBLE FOR THE ACCURACY

OWNIND DESIGN GROUP INC. IS NOT DESPONSIBLE FOR THE ALCOPACY OF SURVEY, STUDICTURAL, OR ENGINEERING INFORMATION SHOWN ON THESE DRAWINGS OR FOR CONSTRUCTION STARTED PRIOR TO THE SSUANCE OF A BULDING PERMIT. REFER TO THE APPROPRIATE ENGINEERING DRAWINGS BEFORE PROCEEDING WITH WORK.

AS CONSTRUCTED INVERTS MUST BE VERIFIED PRIOR TO POURING

JARDIN DESIGN GROUP INC. HAS NOT BEEN RETAINED TO CARRY OUT. GENERAL REVIEW OF THE WORK AND ASSUMES NO RESPONSIBILITY FOR THE FAILURE OF THE CONTRACTOR OR SUB CONTRACTOR TO CARRY OUT THE WORK IN ACCORDANCE WITH THE CONTRACT DOCUMENTS.

THIS DRAWING IS AN INSTRUMENT OF SERVICE, IS PROVIDED BY AND IS THE PROPERTY OF JARDIN DESIGN GROUP INC. THIS DRAWING IS NOT TO BE SCALED.

7			
6			
5			
4			
3			
2			
Λ	DEC. 2, 2020	ADDED DRAWING TO SET; REISSUED FOR PERMIT	
No:	DATE:	WORK DESCRIPTION:	

The undersigned has reviewed and takes responsibility for this design and has the qualifications and meets the requirements set out in the Ontario Building Code to be a designer

QUALIFICATION INFORMATION

Required unless design is even under plusion C, Subsection

3.2.5 of the pull

Required unless design is exempt under Division C, Subsection 3.2.5 of the building of the Walter Botter 21031

NAME

REGISTRATION INFORMATION Required unless design is exempt under Division C, Subsection 3.2.4 of the building code

jardin design group inc. 27763
FIRM NAME BCIN



64 JARDIN DR. SUITE 3A VAUGHAN ONT. L4K 3P3 TEL: 905 660-3377 FAX: 905 660-3713 EMAIL: info@jardindesign.ca WINDOW WELL DETAIL

LAMPONE INVESTMENT INC. CITY OF MARKHAM



TYPE AREA

SCALE:
1/2"=1'-0"

PROJ. No. DWG

ROJ. No. DWG. No. **14**

