

THIS LOT GRADING PLAN HAS BEEN REVIEWED BY METROPOLITAN CONSULTING INC. FOR CONFORMANCE WITH THE APPROVED SUBDIVISION GRADING DESIGN. THE PROPOSED GRADES ON THIS PLAN ARE IN GENERAL CONFORMITY WITH THE APPROVED GRADING PLAN AS IT RELATES TO THIS LOT AND ADJACENT LOTS. WHERE THE BASEMENT FLOOR OR OTHER FOUNDATION ELEVATIONS ARE PROPOSED AT A DIFFERENT ELEVATION THAN THAT SHOWN ON THE APPROVED SUBDIVISION PLANS THE SEWER LATERALS HAVE BEEN REVIEWED AND WE ARE SATISFIED THAT THE MINIMUM GRADES FOR THESE LATERALS CAN BE MAINTAINED IN ACCORDANCE WITH THE REQUIREMENTS OF THE O.B.C. AND CITY DESIGN CRITERIA. NOTE, THIS CERTIFICATION DOES NOT REPLACE THE BUILDER'S RESPONSIBILITY TO EXPOSE THE SEWER LATERALS AND CONFIRM ELEVATIONS PRIOR TO EXCAVATING FOR THE FOUNDATION. BY USE OF THIS PLAN THE BUILDER AGREES THAT THEY SHALL BE RESPONSIBLE FOR IMMEDIATELY REPORTING TO METROPOLITAN CONSULTING ANY DISCREPANCY OR VARIATION BETWEEN THE LATERAL INFORMATION AND GRADES DEPICTED ON THIS PLAN AND THE CONDITIONS FOUND IN THE FIELD.



It is the builder's complete responsibility to ensure that all plans submitted for approval fully comply with the Architectural Guidelines and all applicable regulations and requirements including zoning provisions and any provisions in the subdivision agreement. The Control Architect is not responsible in any way for examining or approving site (lotting) plans or working drawings with respect to any zoning or building code or permit matter or that any house can be properly built or located on its lot.

This is to certify that these plans comply with the applicable Architectural Design Guidelines approved by the City of Hamilton.

JOHN G. WILLIAMS LTD., ARCHITECT
ARCHITECTURAL CONTROL REVIEW
AND APPROVAL

APPROVED BY:

DATE: SEP 08, 2021

This stamp certifies compliance with the applicable Design Guidelines only and bears no further professional responsibility.

CITY OF HAMILTON
Building Division


Permit No. 21-154659

THESE STAMPED DRAWINGS SHALL BE AVAILABLE ON SITE

THE OWNER AND/OR CONTRACTOR SHALL COMPLY WITH THE ONTARIO BUILDING CODE AND ALL OTHER APPLICABLE LAW

These drawings and/or specifications have been reviewed by DATE: Nov 12/21

FOR CHIEF BUILDING OFFICIAL

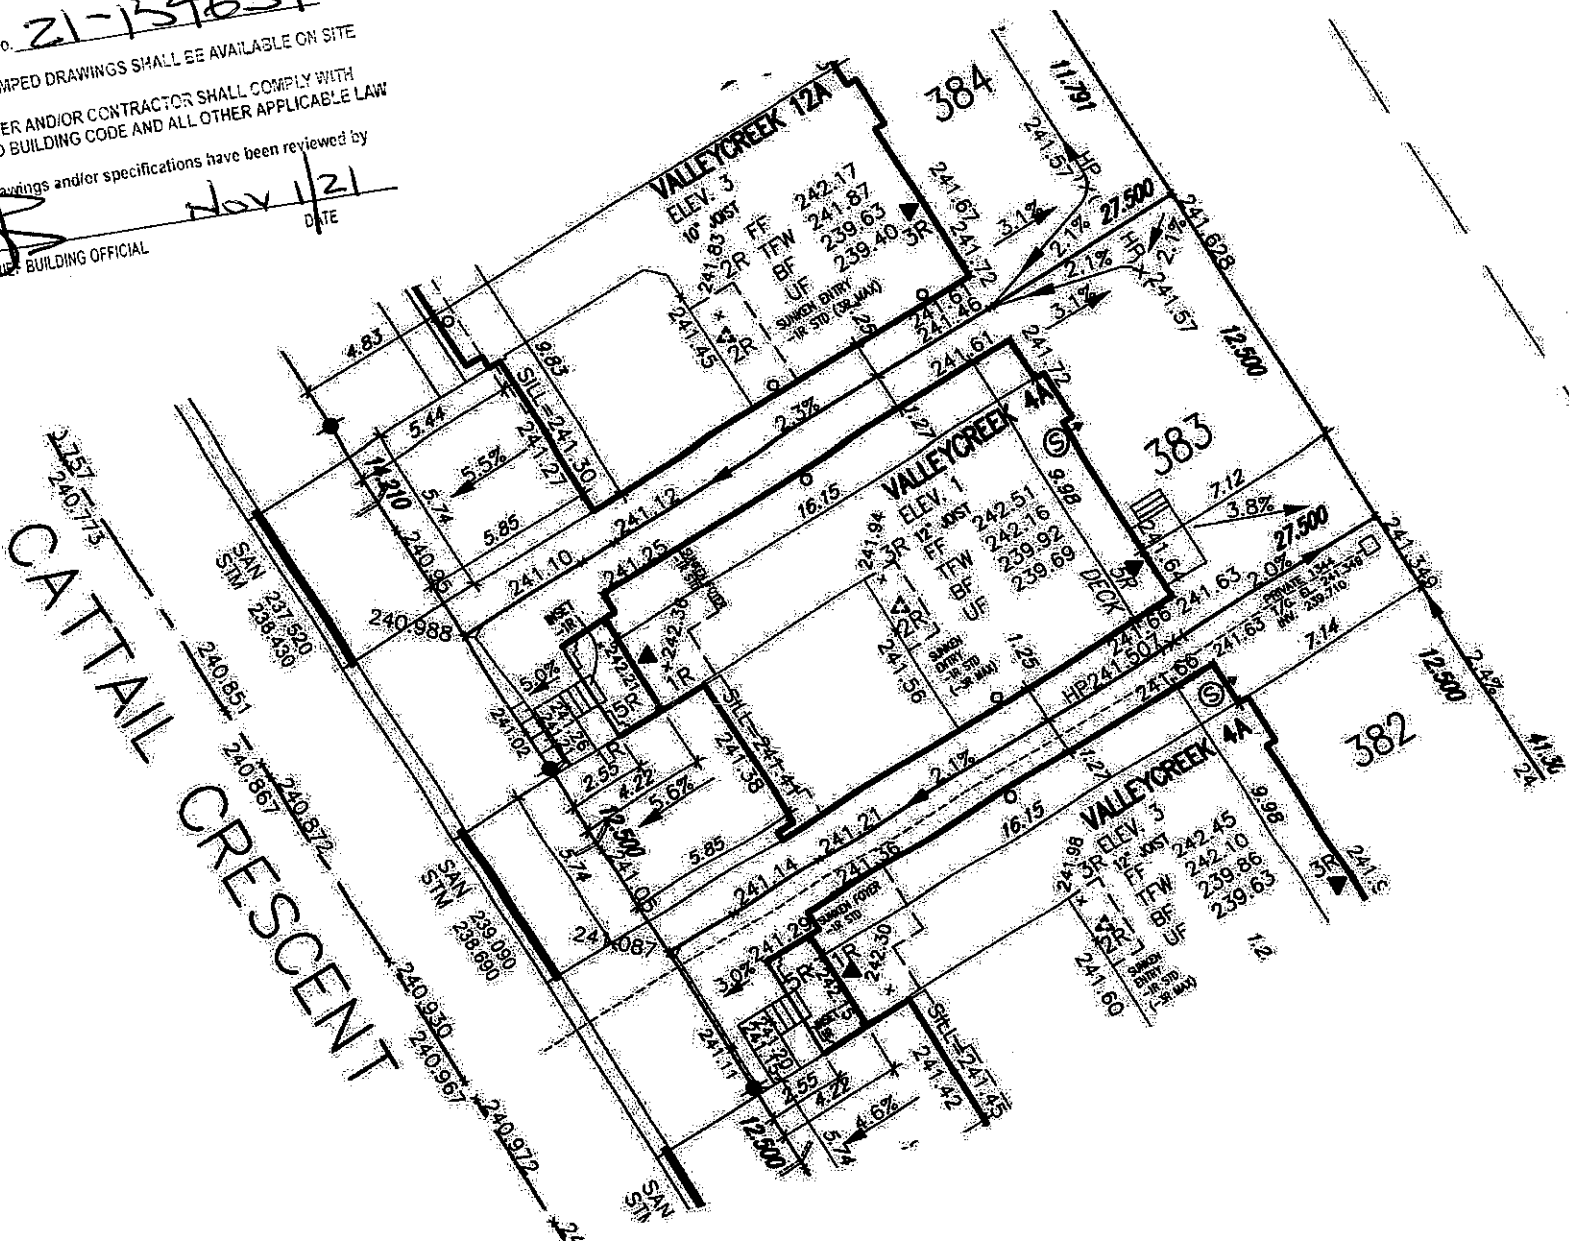

Grading Notes:

It shall be the responsibility of the builder to have all grades and services verified and checked before construction by an approved grading engineer. These grades and the placement of storm and sanitary services off the street are to meet the requirements of the municipality having jurisdiction.

VA3 Design Inc. is to be notified promptly of any discrepancies at least 1 (one) week prior to excavation commences in order that the building can be re-sited. Failure to observe these conditions may require expensive remedial action that will not be the responsibility of or cost to VA3 Design Inc. Foundation wall shall be poured to a minimum of 6" above approved grades.

Finished grade lines as indicated on the house prototype are for reference only and do not necessarily depict finish grading conditions of any particular lot.

These drawings are to be read in conjunction with municipal approved site engineering drawings prepared by Metropolitan Consulting Inc.

ROCK LOT

LOT 383

LOT No.	LOT WIDTH (M) (± 5.8m)	LOT AREA (M ²)
383	12.50	343.75

NOTE: REFER TO LANDSCAPE DRAWINGS FOR ALL FENCING TYPES, HEIGHTS AND LOCATIONS. CONTRACTOR TO VERIFY PRIOR TO INSTALLATION.

 PROPOSED VALVE	 LIGHT POLE	 HYDRANT	 TRANSFORMER	 DOUBLE S/W/SAN CONNECTION	 SINGLE S/W/SAN CONNECTION	 CATCH BASIN	 CABLE TELEVISION PEDESTAL	 BELL PEDESTAL	 No. OF RISERS	 FINISHED FLOOR ELEVATION	 FINISHED MAIN LEVEL ELEVATION	 UNDERGROUND FOOTING ELEVATION	 FIN. BASEMENT FLOOR SLAB	 TOP OF FOUNDATION WALL	 UNDERGROUND FOOTING AT REAR	 UNDERGROUND FOOTING AT FRONT	 UNDERGROUND FOOTING AT SIDE	 WALK OUT DECK	 WALK OUT BASEMENT	 REVERSE PLAN	 STREET SIGN	 MAIL BOX	 REMAINING WALL	 CHAIN LINK FENCE (SEE LANDSCAPE PLAN)	 ACOUSTICAL FENCE (SEE LANDSCAPE PLAN)	 WOOD SCREEN FENCE (SEE LANDSCAPE PLAN)	 HYDRO SERVICE LATERAL	 HYDRO METER	 GAS METER	 SLOPE DIRECTION	 PROVIDE 1/4" DIA. CLEAR STONE IN THIS AREA	 THIS LOT CONTAINS ENGINEERED FILL	 AIR CONDITIONER REQUIRED	 RAIN WATER DOWNSPOUT LOCATION (DISCHARGE ONTO SPLASHPAD)	 SIDE WINDOW LOCATION	 OFF DOOR LOCATION	 EXTERIOR DOOR LOCATION	 REDUCE SIDE YARD
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North arrow



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Greenpark
project name: RUSSELL GARDENS PHASE 4
municipality: HAMILTON
date: JUL 2021
drawn by: [signature]
checked by: [signature]
scale: 1:250
GREG - H:\ARCHIVE\WORKING\2021\20027\GRE\SITE PLAN\20027-RC4-SITE-LAYOUTS.dwg - F4 - Aug 27 2021 - 8:45 AM

lot/block no. 383
registered plan no. 62M-1266
project no. 20027
drawing no. 1
LOT SITING/GRADING
20027-RC4-SITE-LAYOUTS