DOOR SHEDULE:

1 = 2'-10" x 6'-8" INSULATED ENTRANCE DOOR 1A = 2'-8" x 6'-8" INSULATED ENTRANCE DOOR

 $2 = 2'-8" \times 6'-8"$ EXTERIOR GLAZED DOOR

 $3 = 2'-8" \times 6'-8"$ SLAB DOOR (1 3/4" EXTERIOR

 $4 = 2'-8" \times 6'-8"$ SLAB DOOR (1 3/8" INTERIOR)

 $5 = 2'-6'' \times 6'-8''' \text{ SLAB DOOR } (1.3/8''' \text{ INTERIOR})$

 $6 = 2'-2'' \times 6'-8''$ SLAB DOOR (1 3/8" INTERIOR)

 $7 = 1'-6" \times 6'-8"$ SLAB DOOR (1 3/8" INTERIOR)

 $8 = 2'-6'' \times 6'-8'' BI-FOLD (1 3/8'' INTERIOR)$

 $9 = 3'-0" \times 6'-8"$ BI-FOLD (1 3/8" INTERIOR)

10= 2- 2'-0" x 6'-8" BI-FOLD (1 3/8" INTERIOR)

11= 2- 2'-6" x 6'-8" BI-FOLD (1 3/8" INTERIOR)

12 = 2'-6" x 6'-8" FRENCH DOOR (1 3/8" INTERIOR)

PAD FOOTING

120 KPa NATIVE SOIL 90 KPa ENGINEERED FILL SOIL F1 = 42"x42"x18" CONCRETE PAD F1 = 48"x48"x20" CONCRETE PAD F2 = 36"x36"x16" CONCRETE PAD F2 = 40"x40"x16" CONCRETE PAD F3 = 30"x30"x12" CONCRETE PAD F3 = 34"x34"x14" CONCRETE PAD F4 = 24"x24"x12" CONCRETE PAD F4 = 28"x28"x12" CONCRETE PAD F5 = 16"x16"x8" CONCRETE PAD F5 = 18"x18"x8" CONCRETE PAD

(REFER TO FLOOR PLAN FOR UNUSUAL SIZE PADS NOT ON CHART)

NOTE:

WHEN VENEER CUT IS GREATER THAN 26" A 10" POURED CONC. FOUNDATION WALL IS REQUIRED.

ALL GARAGE SLABS, PORCH SLABS, STAIRS (EXPOSED CONC. FLAT WORK) TO BE 32 MPa WITH 5-8% AIR ENTRAITMENT

BRICK VENEER LINTELS:

 $WL1 = 3 \frac{1}{2} \times 3 \frac{1}{2} \times 1 \frac{4}{90} (90x90x6) + 2 - 2 \times 8 \times SPR.$ WL2 = 4" x 3 1\2" x 5\16" (100x90x8) + 2- 2" x 8" SPR.

 $WL3 = 5'' \times 3 \times 12'' \times 5 \times 16'' \times 125 \times 90 \times 8) + 2 - 2'' \times 10'' SPR.$ $WL4 = 6" \times 3 \times 1/2" \times 3/8" (150 \times 90 \times 10) + 2 - 2" \times 12" SPR.$ $WL5 = 6" \times 4" \times 3\8" (150\times100\times10) + 2-2" \times 12" SPR.$

 $WL6 = 5" \times 3 \times 12" \times 5 \times 16" \times 125 \times 90 \times 8) + 2 \times 2" \times 12" SPR.$ $WL7 = 5" \times 3 \times 12" \times 5 \times 16" (125 \times 90 \times 8) + 3 - 2" \times 10" SPR.$ WL8 = 5" x 3 1\2" x 5\16" (125x90x8) + 3-2" x12" SPR.

 $WL9 = 6" \times 4" \times 3\8" (150\times100\times10) + 3-2" \times 12" SPR.$

WOOD LINTELS:

WB1 = 2-2" x 8" SPRUCE BEAM WB6 = 3-2" x 12" SPRUCE BEAM WB2 = 3-2" x 8" SPRUCE BEAM WB7 = 5-2" x 12" SPRUCE BEAM WB3 = 2-2" x 10" SPRUCE BEAM WB10 = 4-2" x 8" SPRUCE BEAM WB4 = 3-2" x 10" SPRUCE BEAM WB11 = 4-2" x 10" SPRUCE BEAM WB5 = 2-2" x 12" SPRUCE BEAM

STEEL LINTELS:


 $L1 = 3.1 \times 3.1 \times 1.4$ (90 x 90 x 6) L4 = 6 x 3.1 \(2 x 3\8 (150 x 90 x 10) L2 = 4" x 3 1\2" x 5\16" (100 x 90 x 8) L5 = 6" x 4" x 3\8" (150 x 100 x 10) L3 = 5" x 3 1\2" x 5\16" (125 x 90 x 8) L6 = 7" x 4" x 3\8" (180 x 100 x 10)

LAMINATED VENEER LUMBER (LVL BEAMS)

 $|V| 1A = 1.1 3/4" \times 7 1/4" (1.45 \times 184)$ $LVL1 = 2-1 3/4" \times 7 1/4" (2-45\times184)$ $LVL2 = 3-1 3/4" \times 7 1/4" (3-45 \times 184)$ $LVL3 = 4-13/4" \times 71/4" (4-45\times184)$ $LVL4A = 1-13/4" \times 91/2" (1-45x240)$ $LVL4 = 2-1 3/4" \times 9 1/2" (2-45x240)$ LVL5 = 3-1 3/4" x 9 1/2" (3-45x240) $LVL5A = 4-1 3/4" \times 9 1/2" (4-45x240)$ LVL6A= 1-1 3/4" x 11 7/8" (1-45x300 LVL6 = 2-1 3/4" x 11 7/8" (2-45x300) LVL7 = 3-13/4" x 117/8" (3-45x300

LVL8 = 2-1 3/4" x 14" (2-45x356) NOT THE GRANTING OF A PERMIT NOR REVIEWING OF SPEC LVL9 = 3-1 3/4" x 14" (3-45x356) & DRAWINGS NOR INSPECTIONS MADE DURING INSTALLATION BY THE OFFICIAL HAVING JURISDICTION SHALL RELIEVE THE

CODE AND ANY OTHER REFERENCED REQUIREMENTS

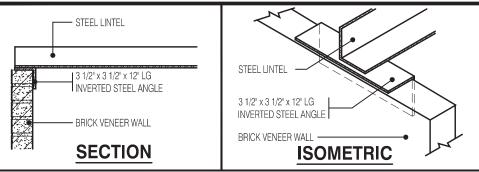

OPENING FT

62.35

86.17

0.00

107.46

255 98

A SEPARATE PERMIT IS REQUIRED FOR THE

FINISHING OF ALL ROUGHIN PLUBMING FIXTURES

OPENING FT²

72.00

86.17

0.00

107.46

265.63

THE ONTARIO BUILDING CODE REQUIRES THAT A SMOKE ALARM BE INSTALL

ON EACH FLOOR LEVEL AND WITHIN EACH SLEEPING ROOM. ALL SMOKE ALARMS SHALL BE INTERCONNECTED. EACH DEVICE SHALL HAVE A VISUAL

SIGNALING COMPONENT IN ADDITION TO THE TEMPORAL PATTERN IN

ENERGY EFFICIENCY- SB12

PERCENTAGE

16.94 %

6.46 %

0.00 %

26.35 %

7.61 %

CONFORMANCE WITH 18.5.3. OF "LIGHT, COLOUR AND PULSE

INVERTED STEEL ANGLE DETAIL

WALL FT²

424 98

1332.92

1326.37

407.75

3492 02

WALL FT²

424.98

1332.92

1326.37

407.75

3492.02

CHERRY 3E ELEV.-1

ELEVATION

EFT SIDE

RIGHT SIDE

REAR

ALL NEW WINDOWS AND SLIDING GLASS DO

TO COMPLY WITH THE THERMAL REQUIREMENT

OF SB-12, MAX U-1.6, ER-25

AND STORAGE AREAS, SHALL CONSIST OF

FELTED-SYNTHETIC-FIBRE FLOOR COVERING, CONCRETE, TILE, OR OTHER FLOORING

PROVIDING A SIMILAR WATER RESISTANCE

SECTION 9.27 OF DIVISION B OR HAVE A CCMO

OR BMEC APPROVAL, OR A MINISTERS RULING

ELEVATION

FRONT

EFT SIDE

RIGHT SIDE

REAR

TOTAL

ROOF TRUSS DRAWINGS BY MANUFACTURER

FLOOR TRUSS LAYOUT BY MANUFACTURER

CHERRY 3E ELEV.-2

MAX. HOT WATER TEMP. SHALL NOT EXCEED 49°C (120°F) EXCEPT FOR DISHWASHERS AND CLOTHES WASHERS

NG IN KITCHENS WASHROOMS LAUNDR

Scale: 3/4" = 1'-0"

ENERGY EFFICIENCY-SB12

PERCENTAGE

14.67 %

6.46 %

0.00%

26.35 %

7 33 %

PORCH SLAB SHALL BE REVIEWED PRIOR TO POURING CONRETE (see inspector)

PROVIDE P.ENG APPROVED TRUSS & FLOOR AWINGS AND SPECIFICATIONS TO BUILDING INSPECTOR AT FRAMING INSPECTION

INSTALLATION OF FLUSH STEEL BEAMS SHALL CONFORM TO THE REQUIREMENTS OF

CONFIRM BEARING CAPACITY OF SOILS. SEE FIELD INSPECTOR

FINAL GRADING CERTIFICATE REQ'D FFORE FINAL INSPECTION SIGN-OFF

GLAZING PRODUCTS IDENTIFYING THE CERTIFIED VALUES SHALL REMAIN ON FOR REVIEW DURING CONSTRUCTION

AREA CALCULATIONS EL-1

FIRST FLOOR AREA 981 Sq. Ft. SECOND FLOOR AREA = 1159 Sq. Ft. TOTAL FLOOR AREA = 2140 Sq. Ft. ADD OPEN AREAS 14 Sq. Ft. ADD FIN. BASEMENT AREA = 0 Sq. Ft GROSS FLOOR AREA 2154 Sq. Ft. 981 Sq. Ft. GROUND FLOOR COVERAGE = 247 Sq. Ft. GARAGE COVERAGE / AREA = PORCH COVERAGE / AREA = 66 Sq. Ft. = 1294 Sa. Ft. COVERAGE W/ PORCH = 120.22 Sq. m. = 1228 Sa. Ft. COVERAGE W/O PORCH = 114.08 Sq. m.

AREA CALCULATIONS EL-2

FIRST FLOOR AREA 981 Sa. Ft SECOND FLOOR AREA = 1159 Sq. Ft. TOTAL FLOOR AREA = 2140 Sq. Ft ADD OPEN AREAS 14 Sq. Ft ADD FIN. BASEMENT AREA _ 0 Sq. Ft 2154 Sq. Ft GROSS FLOOR AREA GROUND FLOOR COVERAGE = 981 Sq. Ft GARAGE COVERAGE / AREA = 247 Sq. Ft = PORCH COVERAGE / AREA 66 Sq. Ft

COVERAGE W/ PORCH = 1294 Sa. Ft $= 120.22 \, \text{Sa. m.}$

= 1228 Sq. Ft COVERAGE W/O PORCH $= 114.08 \, \text{Sg. m.}$

R31

R31

R22

R10

R10

R20ci

BUILDING FACE < THAN 4'-0" (1.2m) (45 MIN. FIRE RATING REQ'D)

OR POINT LOAD FROM ABOVE 202

D.J.

REPEAT NOTE

SHOWER WEEPERS

CITY OF CAMBRIDGE BUILDING DIVISION

30

9

2

S

Units

0

 $\overline{}$

 $\overline{}$

ock

 $\overline{\mathbf{m}}$

STRUDET INC.



FOR STRUCTURE ONLY

LEGEND:

INDICATES SOLID BEARING REQUIRED

STL. PLATE FOR STEEL COL'N ABOVE

LVL LAMINATED VENEER LUMBER

S.J. SINGLE JOIST

DOUBLE JOIST T.J. TRIPLE JOIST

0

6.10m LOTS CHERRY 3E (GR)

2154

ELEVATION 1 & 2

A1 PACKAGE

O.REG. 332/12

ONDITIONS ON SITE BEFORE PROCEEDING WITH CONSTRUCTION Y DISCREPANCIES SHALL BE REPORTED TO JARDIN DESIGN GROU INC. PRIOR TO COMMENCEMENT OF WORK.

IADDIN DESIGN COOLID INC. IS NOT DESPONSIBLE FOR THE ACCUR. OF SURVEY, STRUCTURAL OR ENGINEERING INFORMATION SHOWN HESE DRAWINGS OR FOR CONSTRUCTION STARTED PRIOR TO TH SUANCE OF A BUILDING PERMIT. REFER TO THE APPROPRIATE NGINEERING DRAWINGS BEFORE PROCEEDING WITH WORK.

AS CONSTRUCTED INVERTS MUST BE VERIFIED PRIOR TO POURING IARDIN DESIGN GROUP INC. HAS NOT BEEN BETAINED TO CARRY OF

ARIDIN DESIGN GROUP INC. HAS NOT BEEN HETAINED TO CARHY OF SENERAL REVIEW OF THE WORK AND ASSUMES NO RESPONSIBILITY OR THE FAILURE OF THE CONTRACTOR OR SUB CONTRACTOR TO SARRY OUT THE WORK IN ACCORDANCE WITH THE CONTRACT OCUMENTS.

THIS DRAWING IS AN INSTRUMENT OF SERVICE. IS PROVIDED BY AND HE PROPERTY OF JARDIN DESIGN GROUP INC. THIS DRAWING IS N

AUG. 31. 2022 ISSUED FOR BUILDING PERMIT COORDINATED FLOOR, ROOF AND AUG. 29, 2022 ENGINEER COMMENTS REPARED TO PRE-COORDINATION JUN. 20, 2022 STAGE & ISSUED TO CLIENT MAR. 28, 2022 ISSUED TO CLIENT FOR BROCHUR

DATE: WORK DESCRIPTION:

DESIGN GROUP INC

64 JARDIN DR. SUITE 3A VAUGHAN ONT, L4K 3P3 TEL: 905 660-3377 FAX: 905 660-3713 EMAIL: info@jardindesian.ca

The undersigned has reviewed and takes responsibility for this design and has the qualifications and meets the requirements set out in the Ontario Building Code to be a designer

QUALIFICATION INFORMATION

3.2.5 of Walter Botter

REGISTRATION INFORMATION Required unless design is exempt under Division C, Subsection 3.2.4 of the building code 27763

jardin design group inc. FIRM NAME

TITLE PAGE

BARLASSINA CONSTRUCTION CITY OF CAMBRIDGE



NAME

CHERRY 3E SCALE:

3/16"=1'-0" ROJ. No.

21-35

DRAWING NAME

LVL7A= 4-1 3/4" x 11 7/8" (4-45x300)

PROVIDE 1 ROW BRIDGING FOR SPANS OF 5'-7', 2 ROWS FOR SPANS GREATER THAN 7

NOTE:

NOTE:

NOTE: THESE DRAWINGS ARE TO BE READ IN CONJUNCTION WITH ENGINEER APPROVED

SPACE CONVENTIONAL FLOOR JOISTS @ 12" O.C. BELOW ALL CERAMIC TILE AREAS.

THESE DRAWINGS ARE TO BE READ IN CONJUNCTION WITH ENGINEER APPROVED

NOTE:

PLANS NOT DRAWN TO ACTUAL GRADE. REFER TO FINAL GRADING PLAN


CEILING W/O ATTIC SPACE EXPOSED FLOOR WALLS ABOVE GRADE BASEMENT WALLS SLAB > 600mm BELOW GRADE EDGE OF SLAB < 600mm BELOW GRADE WINDOWS AND SLIDING GLASS DOORS SKYLIGHTS. SPACE HEATING EQUIPMENT


HEATED SLAB OR < 600mm BELOW GRADE


CEILING WITH ATTIC SPACE

MAX. U0.28 ER25 MAX. U0.49 MIN. AFUE 96% MIN. SRE 75% MIN. EF. 0.80 DOMESTIC WATER HEATER MIN. 42% DRAIN WATER HEAT RECOVERY UNIT

SB-12 - COMPLIANCE PACKAGE A1

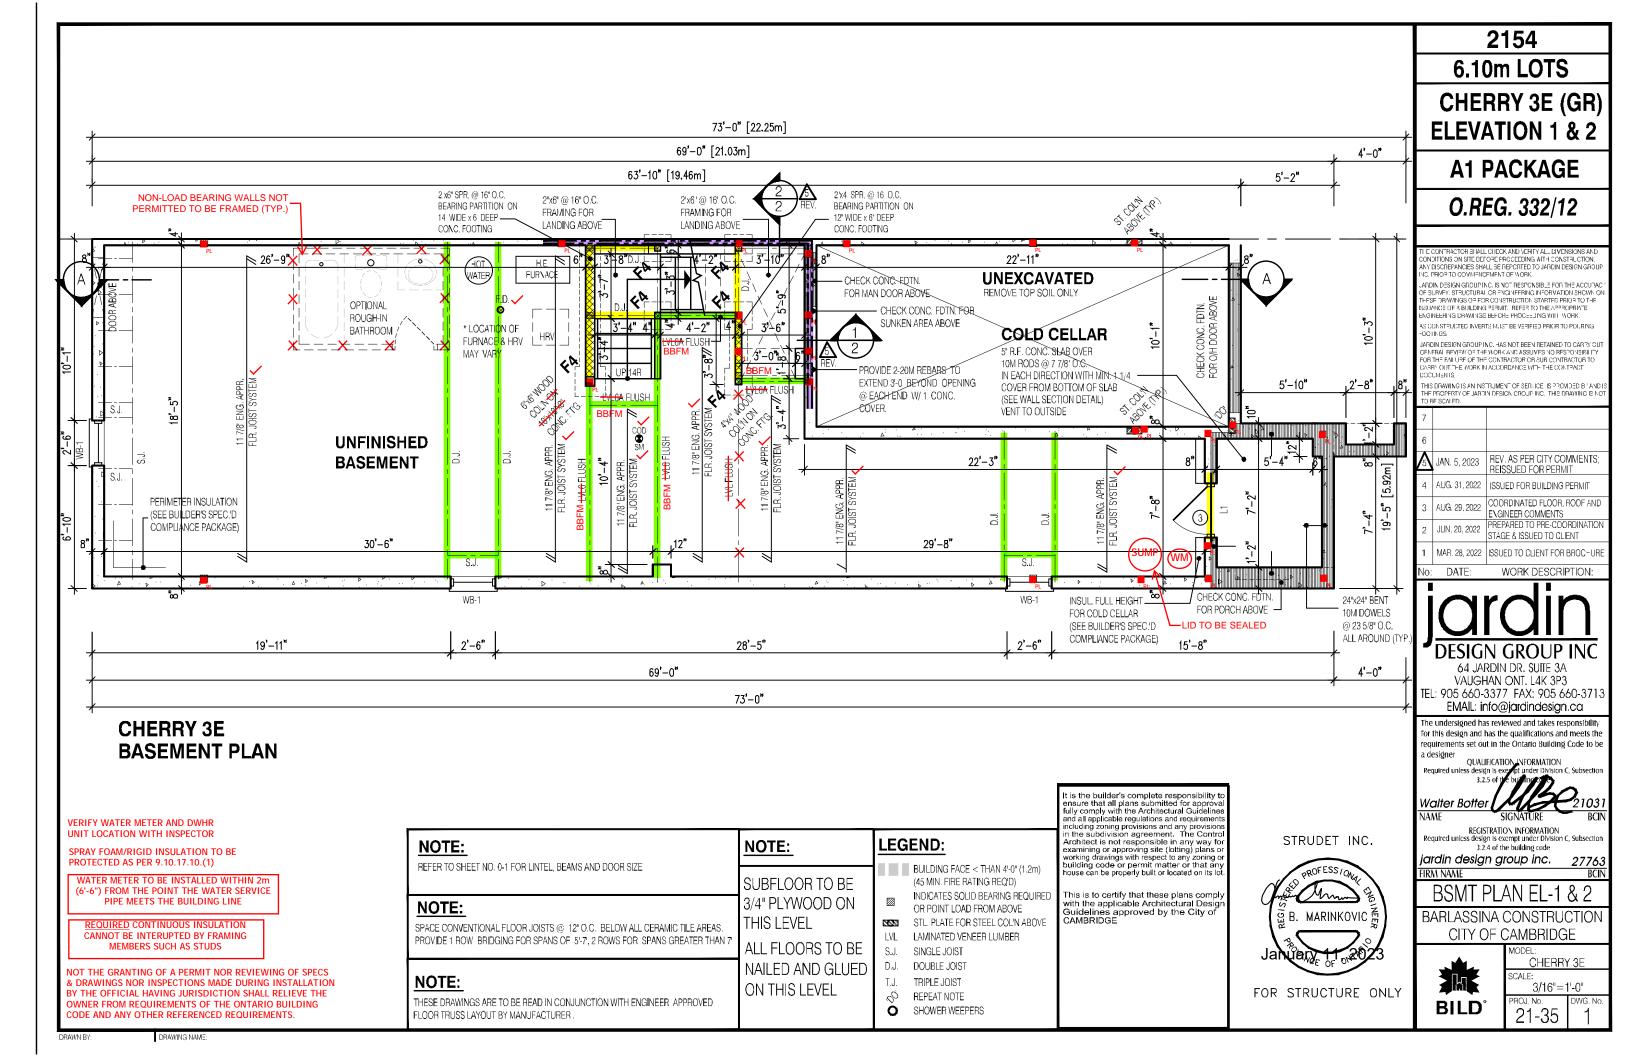

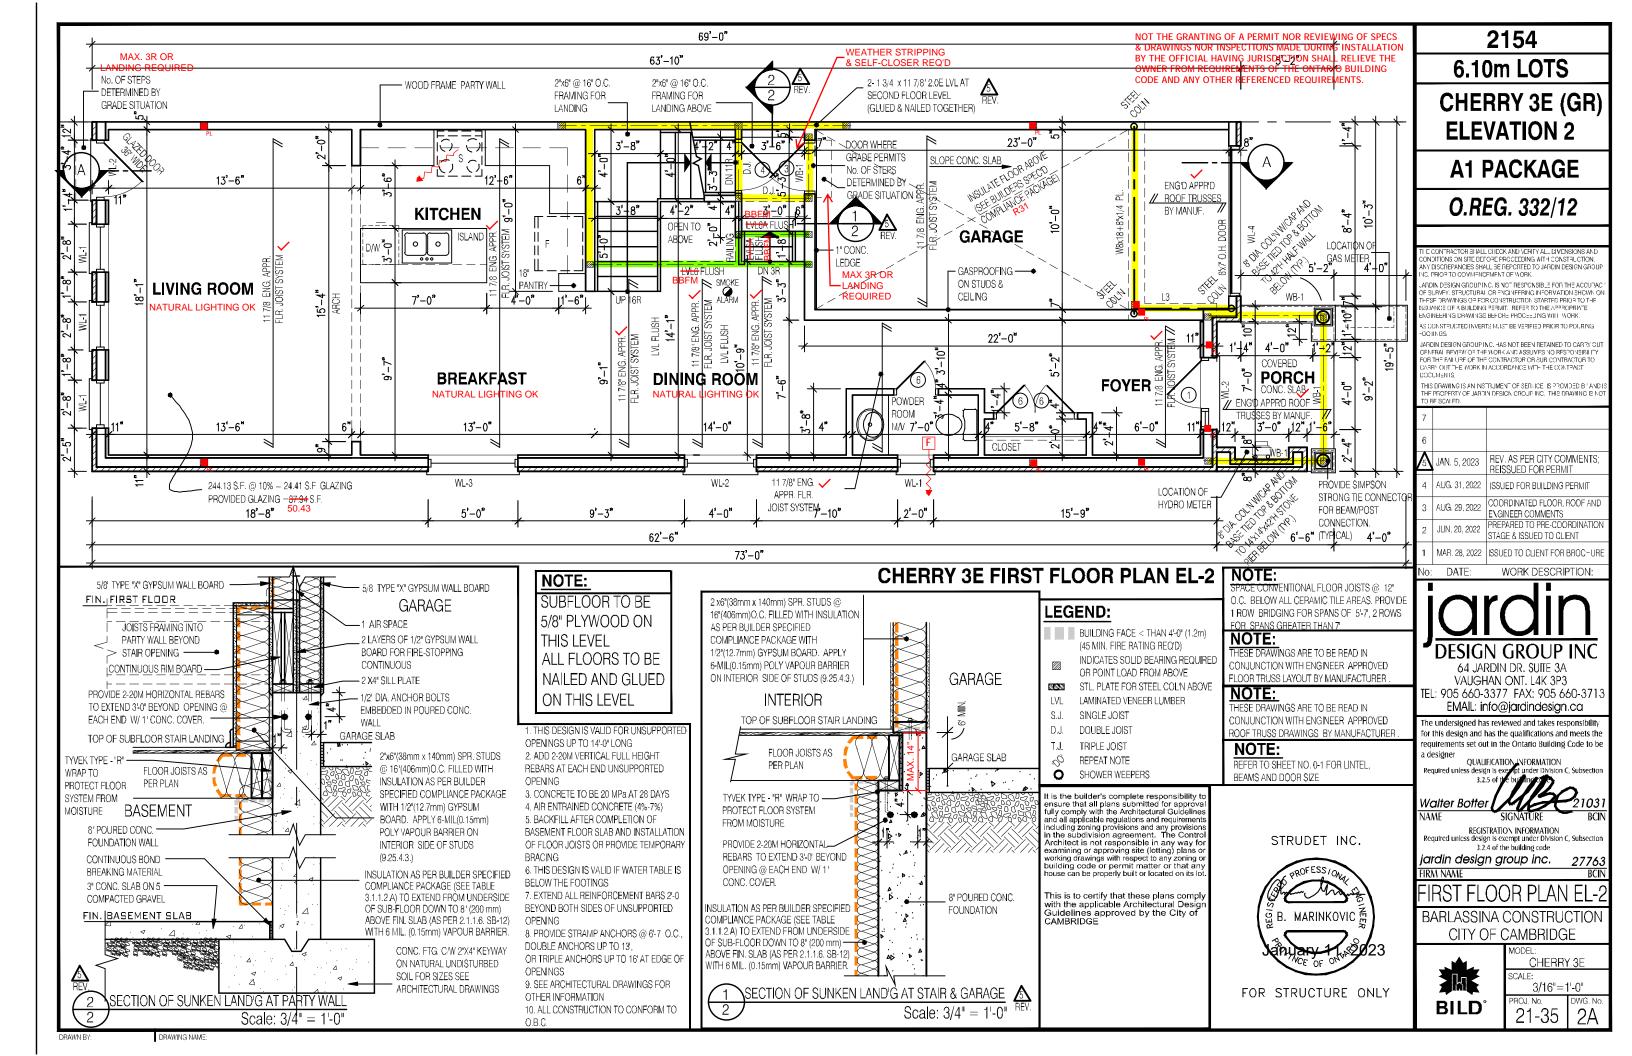

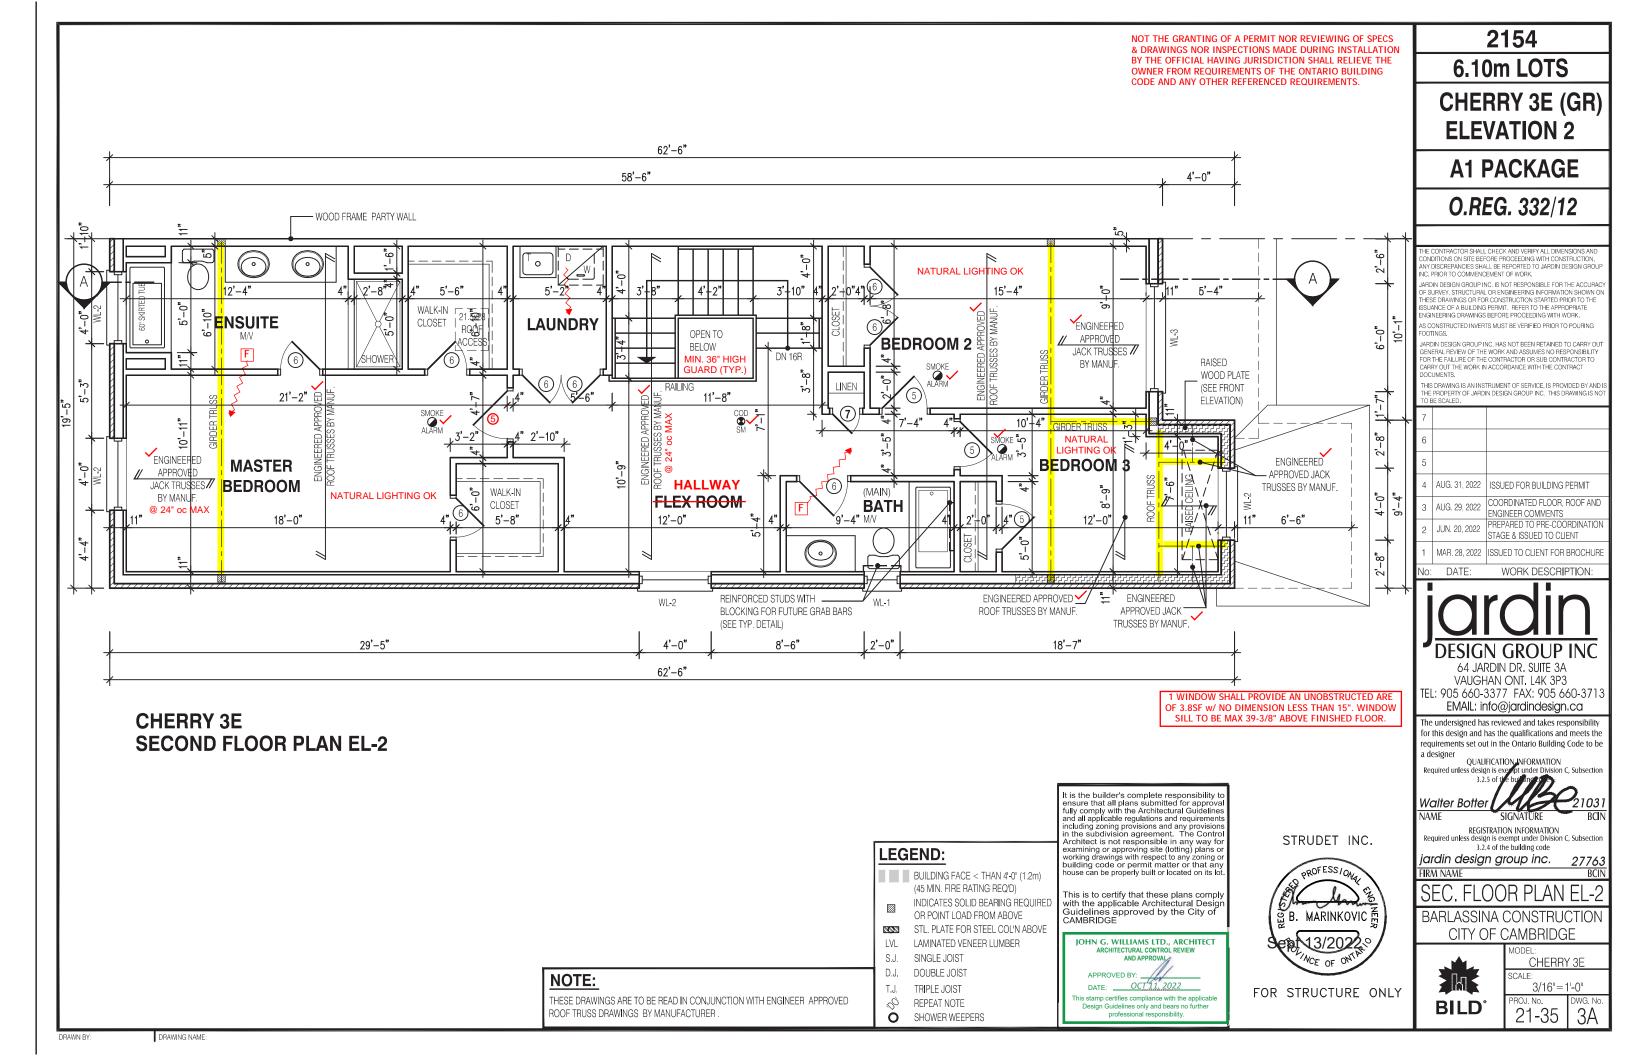

NOT THE GRANTING OF A PERMIT NOR REVIEWING OF SPECS & DRAWINGS NOR INSPECTIONS MADE DURING INSTALLATION BY THE OFFICIAL HAVING JURISDICTION SHALL RELIEVE THE OWNER FROM REQUIREMENTS OF THE ONTARIO BUILDING CODE AND ANY OTHER REFERENCED REQUIREMENTS.


69'-0"

13'-6"

LIVING ROOM

13'-6"

63'-10"

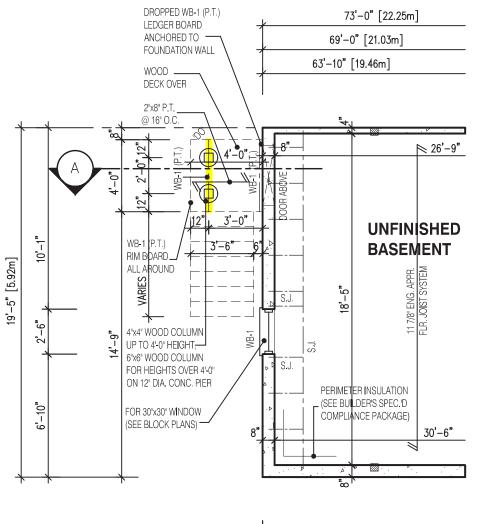

NOTE:

SUBFLOOR TO BE 3/4" PLYWOOD ON THIS LEVEL ALL FLOORS TO BE NAILED AND GLUED

ON THIS LEVEL

19'-11" 69'-0" 73'-0"

PARTIAL BASEMENT LAYOUT FOR DECK CONDITION EL-2

NOTE:

SUBFLOOR TO BE 5/8" PLYWOOD ON THIS LEVEL

ALL FLOORS TO BE NAILED AND GLUED ON THIS LEVEL

18'-8" 62'-6" 73'-0"

BUILDING FACE < THAN 4'-0" (1.2m)

INDICATES SOLID BEARING REQUIRED

STL. PLATE FOR STEEL COL'N ABOVE

(45 MIN. FIRE RATING REQ'D)

OR POINT LOAD FROM ABOVE

LAMINATED VENEER LUMBER

SINGLE JOIST

DOUBLE JOIST

TRIPLE JOIST

REPEAT NOTE

SHOWER WEEPERS

LEGEND:

2.0.3

LVL

D.J.

T.J.

PARTIAL FIRST FLOOR LAYOUT FOR DECK CONDITION EL-2

WOOD

2'-8"

1,-8,

2'-8"

2'-8"

2'-5"

19'-5" [5.92m]

3'-6"

No. OF STEPS

DETERMINED BY -

GRADE SITUATION

STRUDET INC.



FOR STRUCTURE ONLY

It is the builder's complete responsibility ensure that all plans submitted for approv fully comply with the Architectural Guidelin and all applicable regulations and requiremer and an applicable regulations and requirement including zoning provisions and any provision in the subdivision agreement. The Contro Architect is not responsible in any way fo examining or approving site (lotting) plans of working drawings with respect to any zoning of building code or permit matter or that an nouse can be properly built or located on its I

This is to certify that these plans comp with the applicable Architectural Designation Guidelines approved by the City of CAMBRIDGE.

JOHN G. WILLIAMS LTD., ARCHITECT APPROVED BY OCT 11, 2022 s stamp certifies compliance with the applicable Design Guidelines only and bears no further professional responsibility

2154

6.10m LOTS

CHERRY 3E (GR) **ELEVATION 2**

A1 PACKAGE

O.REG. 332/12

ONDITIONS ON SITE BEFORE PROCEEDING WITH CONSTRUCTION Y DISCREPANCIES SHALL BE REPORTED TO JARDIN DESIGN GROU NC. PRIOR TO COMMENCEMENT OF WORK.

IADDIN DESIGN ODDI ID INC. IS NOT DESDONSIDI E COD THE ACCUIDA SUANCE OF A BUILDING PERMIT. REFER TO THE APPROPRIATE NGINEERING DRAWINGS BEFORE PROCEEDING WITH WORK. S CONSTRUCTED INVERTS MUST BE VERIFIED PRIOR TO POURING

JARDIN DESIGN GROUP INC. HAS NOT BEEN RETAINED TO CARRY OUT GENERAL REVIEW OF THE WORK AND ASSUMES NO RESPONSIBILITY FOR THE FALIURE OF THE CONTRACTOR OR SUB CONTRACTOR TO CARRY OUT THE WORK IN ACCORDANCE WITH THE CONTRACT

THIS DRAWING IS AN INSTRUMENT OF SERVICE. IS PROVIDED BY AND HE PROPERTY OF JARDIN DESIGN GROUP INC. THIS DRAWING IS N O BE SCALED.

AUG. 31. 2022 ISSUED FOR BUILDING PERMIT COORDINATED FLOOR, ROOF AND ENGINEER COMMENTS REPARED TO PRE-COORDINATION JUN. 20, 2022 STAGE & ISSUED TO CLIENT MAR. 28, 2022 ISSUED TO CLIENT FOR BROCHURE

DATE WORK DESCRIPTION:

64 JARDIN DR. SUITE 3A VAUGHAN ONT, L4K 3P3 TEL: 905 660-3377 FAX: 905 660-3713 EMAIL: info@jardindesian.ca

The undersigned has reviewed and takes responsibility for this design and has the qualifications and meets the requirements set out in the Ontario Building Code to be a designer

QUALIFICATION INFORMATION NAME

REGISTRATION INFORMATION Required unless design is exempt under Division C, Subsection 3.2.4 of the building code

jardin design group inc.

FIRM NAME **DECK CONDITION EL-2**

BARLASSINA CONSTRUCTION CITY OF CAMBRIDGE



CHERRY 3E SCALE

3/16"=1'-0" 21-35

NOTE:

WHEN VENEER CUT IS GREATER THAN 26" A 10" POURED CONC, FOUNDATION WALL IS REQUIRED. (FOUNDATION PLAN TO BE REVIEWED IN CONJUNCTION WITH SITE PLAN)

NOTE:

NOTE:

REFER TO SHEET NO. 0 - FOR LINTEL, BEAMS AND DOOR SIZE

THESE DRAWINGS ARE TO BE READ IN CONJUNCTION WITH ENGINEER APPROVED ROOF TRUSS DRAWINGS BY MANUFACTURER

NOTE:

SPACE CONVENTIONAL FLOOR JOISTS @ 12" O.C. BELOW ALL CERAMIC TILE AREAS. PROVIDE 1 ROW BRIDGING FOR SPANS OF 5'-7', 2 ROWS FOR SPANS GREATER THAN 7


NOTE:

THESE DRAWINGS ARE TO BE READ IN CONJUNCTION WITH ENGINEER APPROVED FLOOR TRUSS LAYOUT BY MANUFACTURER

NOT THE GRANTING OF A PERMIT NOR REVIEWING OF SPECS & DRAWINGS NOR INSPECTIONS MADE DURING INSTALLATION BY THE OFFICIAL HAVING JURISDICTION SHALL RELIEVE THE OWNER FROM REQUIREMENTS OF THE ONTARIO BUILDING CODE AND ANY OTHER REFERENCED REQUIREMENTS.

13'-6"

13'-6"

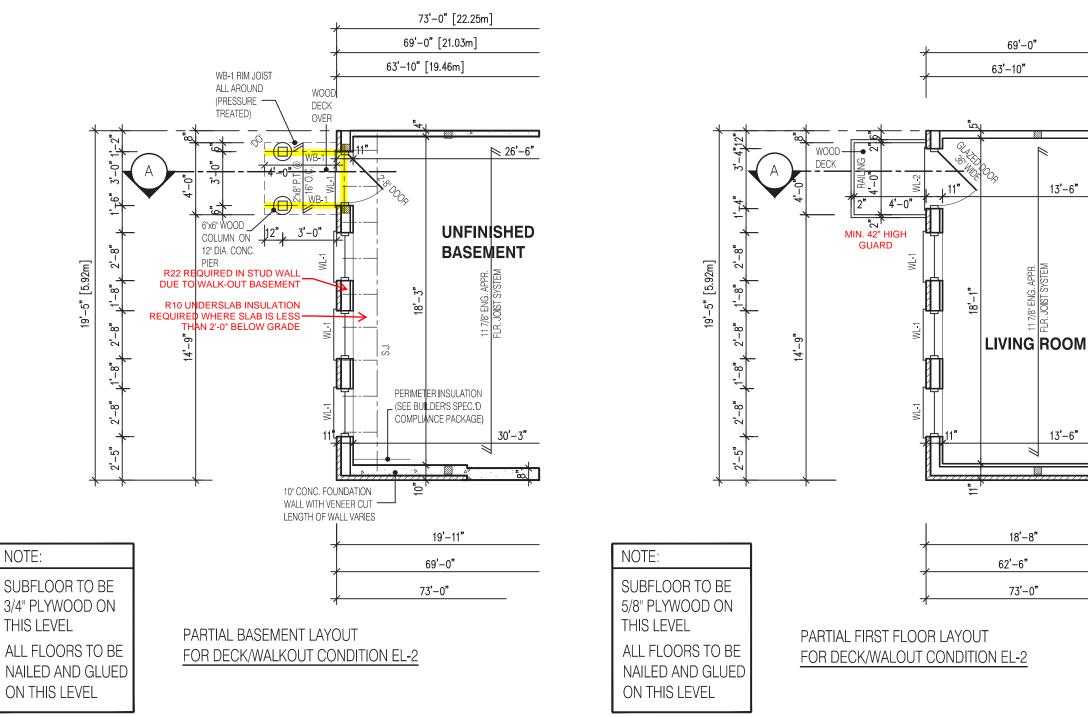

NOTE:

NOTE:

REFER TO SHEET NO. 0 - FOR LINTEL, BEAMS AND DOOR SIZE

THESE DRAWINGS ARE TO BE READ IN CONJUNCTION WITH ENGINEER APPROVED ROOF TRUSS DRAWINGS BY MANUFACTURER

NOTE:

SPACE CONVENTIONAL FLOOR JOISTS @ 12" O.C. BELOW ALL CERAMIC TILE AREAS. PROVIDE 1 ROW BRIDGING FOR SPANS OF 5'-7', 2 ROWS FOR SPANS GREATER THAN 7

NOTE:

THESE DRAWINGS ARE TO BE READ IN CONJUNCTION WITH ENGINEER APPROVED FLOOR TRUSS LAYOUT BY MANUFACTURER

LEGEND:

BUILDING FACE < THAN 4'-0" (1.2m) (45 MIN. FIRE RATING REQ'D) INDICATES SOLID BEARING REQUIRED

OR POINT LOAD FROM ABOVE STL. PLATE FOR STEEL COL'N ABOVE 2.0.3 LVL LAMINATED VENEER LUMBER

SINGLE JOIST

D.J. DOUBLE JOIST

T.J. TRIPLE JOIST REPEAT NOTE

SHOWER WEEPERS

STRUDET INC.



FOR STRUCTURE ONLY

It is the builder's complete responsibility ensure that all plans submitted for approv fully comply with the Architectural Guidelin-and all applicable regulations and requiremen and an applicable regulations and requirement including zoning provisions and any provision in the subdivision agreement. The Contro Architect is not responsible in any way fo examining or approving site (lotting) plans of working drawings with respect to any zoning of building code or permit matter or that an nouse can be properly built or located on its I

This is to certify that these plans comp with the applicable Architectural Designation Guidelines approved by the City of CAMBRIDGE.

IOHN G. WILLIAMS LTD., ARCHITECT DATE: OCT 11, 2022 This stamp certifies compliance with the applicable Design Guidelines only and bears no further professional responsibility.

2154

6.10m LOTS

CHERRY 3E (GR) **ELEVATION 2**

A1 PACKAGE

O.REG. 332/12

ONDITIONS ON SITE BEFORE PROCEEDING WITH CONSTRUCTION Y DISCREPANCIES SHALL BE REPORTED TO JARDIN DESIGN GROU NC. PRIOR TO COMMENCEMENT OF WORK.

IADDIN DESIGN ODDI ID INC. IS NOT DESDONSIDI E COD THE ACCUIDA SUANCE OF A BUILDING PERMIT. REFER TO THE APPROPRIATE NGINEERING DRAWINGS BEFORE PROCEEDING WITH WORK. S CONSTRUCTED INVERTS MUST BE VERIFIED PRIOR TO POURING

JARDIN DESIGN GROUP INC. HAS NOT BEEN RETAINED TO CARRY OUT GENERAL REVIEW OF THE WORK AND ASSUMES NO RESPONSIBILITY FOR THE FALIURE OF THE CONTRACTOR OR SUB CONTRACTOR TO CARRY OUT THE WORK IN ACCORDANCE WITH THE CONTRACT

THIS DRAWING IS AN INSTRUMENT OF SERVICE. IS PROVIDED BY AND HE PROPERTY OF JARDIN DESIGN GROUP INC. THIS DRAWING IS NOT BE SCALED.

AUG. 31. 2022 ISSUED FOR BUILDING PERMIT COORDINATED FLOOR, ROOF AND ENGINEER COMMENTS REPARED TO PRE-COORDINATION JUN. 20, 2022 STAGE & ISSUED TO CLIENT MAR. 28, 2022 ISSUED TO CLIENT FOR BROCHURE

DATE WORK DESCRIPTION:



64 JARDIN DR. SUITE 3A VAUGHAN ONT, L4K 3P3 TEL: 905 660-3377 FAX: 905 660-3713 EMAIL: info@jardindesian.ca

The undersigned has reviewed and takes responsibility for this design and has the qualifications and meets the requirements set out in the Ontario Building Code to be a designer

QUALIFICATION_INFORMATION NAME

REGISTRATION INFORMATION Required unless design is exempt under Division C, Subsection

3.2.4 of the building code

jardin design group inc. IRM NAME

DECK/WALKOUT EL-2

BARLASSINA CONSTRUCTION CITY OF CAMBRIDGE



CHERRY 3E SCALE:

3/16"=1'-0" 21-35

DRAWING NAME

SITE PLAN)

NOTE:


WHEN VENEER CUT IS GREATER THAN

26" A 10" POURED CONC, FOUNDATION

WALL IS REQUIRED. (FOUNDATION PLAN

TO BE REVIEWED IN CONJUNCTION WITH

NOTE:

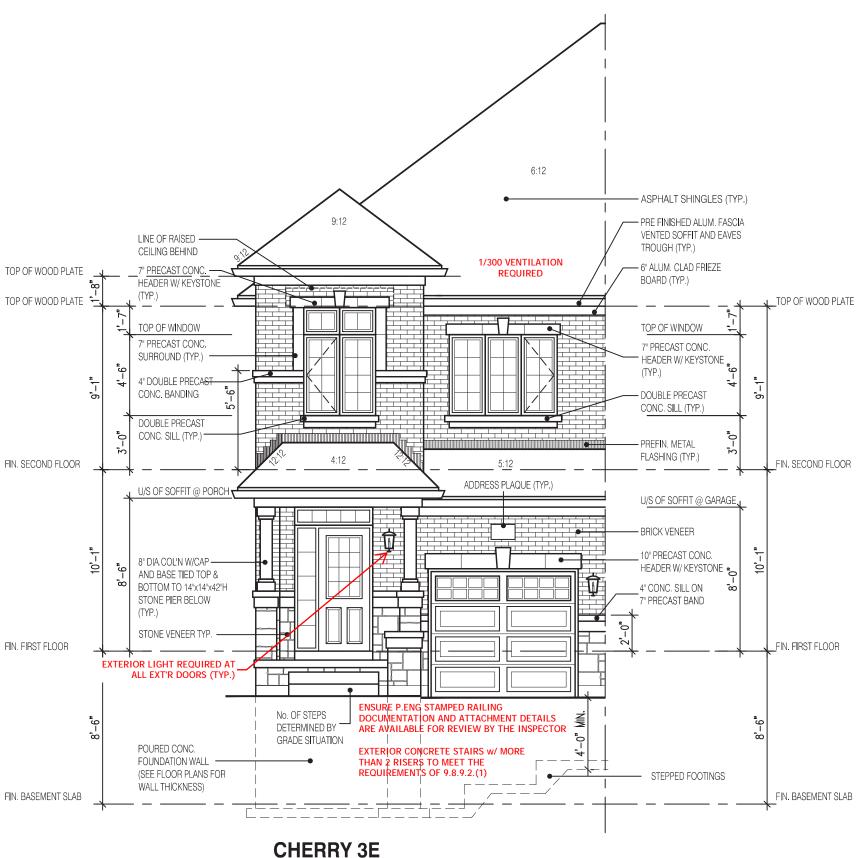

CHERRY 3E FRONT ELEVATION 2

NOT THE GRANTING OF A PERMIT NOR REVIEWING OF SPECS & DRAWINGS NOR INSPECTIONS MADE DURING INSTALLATION BY THE OFFICIAL HAVING JURISDICTION SHALL RELIEVE THE OWNER FROM REQUIREMENTS OF THE ONTARIO BUILDING CODE AND ANY OTHER REFERENCED REQUIREMENTS.

It is the builder's complete responsibility to ensure that all plans submitted for approval fully comply with the Architectural Guidelines and all applicable regulations and requirements including zoning provisions and any provisions in the subdivision agreement. The Control Architect is not responsible in any way for examining or approving site (lotting) plans or working drawings with respect to any zoning or building code or permit matter or that any house can be properly built or located on its lot.

This is to certify that these plans comply with the applicable Architectural Design Guidelines approved by the City of CAMBRIDGE.

JOHN G. WILLIAMS LTD., ARCHITECT
ARCHITECTURAL CONTROL REVIEW
AND APPROVAL

APPROVED BY:
DATE:
OCT 11, 2022

This stamp certifies compliance with the applicable

This stamp certifies compliance with the applicable Design Guidelines only and bears no further professional responsibility. 2154

6.10m LOTS

CHERRY 3E (GR) ELEVATION 2

A1 PACKAGE

O.REG. 332/12

THE CONTRACTOR SHALL CHECK AND VEHILY ALL DIMENSIONS AND CONDITIONS ON SITE BEFORE PROCEEDING WITH CONSTRUCTION. ANY DISCREPANCIES SHALL BE REPORTED TO JARDIN DESIGN GROUF INC. PRIOR TO COMMENCEMENT OF WORK.

JARDIN DESIGN GROUP INC. IS NOT RESPONSIBLE FOR THE ACCURACY OF SURVEY, STRUCTURAL OR ENGINEERING INFORMATION SHOWN ON THESE DRAWINGS OR FOR CONSTRUCTION STARTED PRIOR TO THE ISSUANCE OF A BUILDING PERMIT, REFER TO THE APPROPRIATE ENGINEERING DRAWINGS BEFORE PROCEEDING WITH WORK.

AS CONSTRUCTED INVERTIS MUST BE VERIFIED PRIOR TO POURING

JARDIN DESIGN GROUP INC. HAS NOT BEEN RETAINED TO CARRY OUT GENERAL REVIEW OF THE WORK AND ASSUMES NO RESPONSIBILITY FOR THE FALIURE OF THE CONTRACTOR OR SUB CONTRACTOR TO CARRY OUT THE WORK IN ACCORDANCE WITH THE CONTRACT DOCUMENTS.

THIS DRAWING IS AN INSTRUMENT OF SERVICE, IS PROVIDED BY AND IS THE PROPERTY OF JARDIN DESIGN GROUP INC. THIS DRAWING IS NOT TO BE SCALED.

/		
6		
5		
4	AUG. 31, 2022	ISSUED FOR BUILDING PERMIT
3	AUG. 29, 2022	COORDINATED FLOOR, ROOF AN ENGINEER COMMENTS
2	JUN. 20, 2022	PREPARED TO PRE-COORDINATION STAGE & ISSUED TO CLIENT
1	MAR 28 2022	ISSUED TO CUENT FOR RECOUL

No: DATE: WORK DESCRIPTION:



VAUGHAN ONT. L4K 3P3
TEL: 905 660-3377 FAX: 905 660-3713
EMAIL: info@iardindesian.ca

The undersigned has reviewed and takes responsibility for this design and has the qualifications and meets the requirements set out in the Ontario Building Code to be a designer

QUALIFICATION INFORMATION red unless design is exempt under Division C, Sub

Walter Botter 210
NAME SIGNATURE B

REGISTRATION INFORMATION
Required unless design is exempt under Division C, Subsection
3.2.4 of the building code

jardin design group inc.
FIRM NAME


FRONT ELEVATION 2


BARLASSINA CONSTRUCTION CITY OF CAMBRIDGE



CHERRY 3E
SCALE:

3/16"=1'-0"
PROJ. No. DWG.
21-35 4/

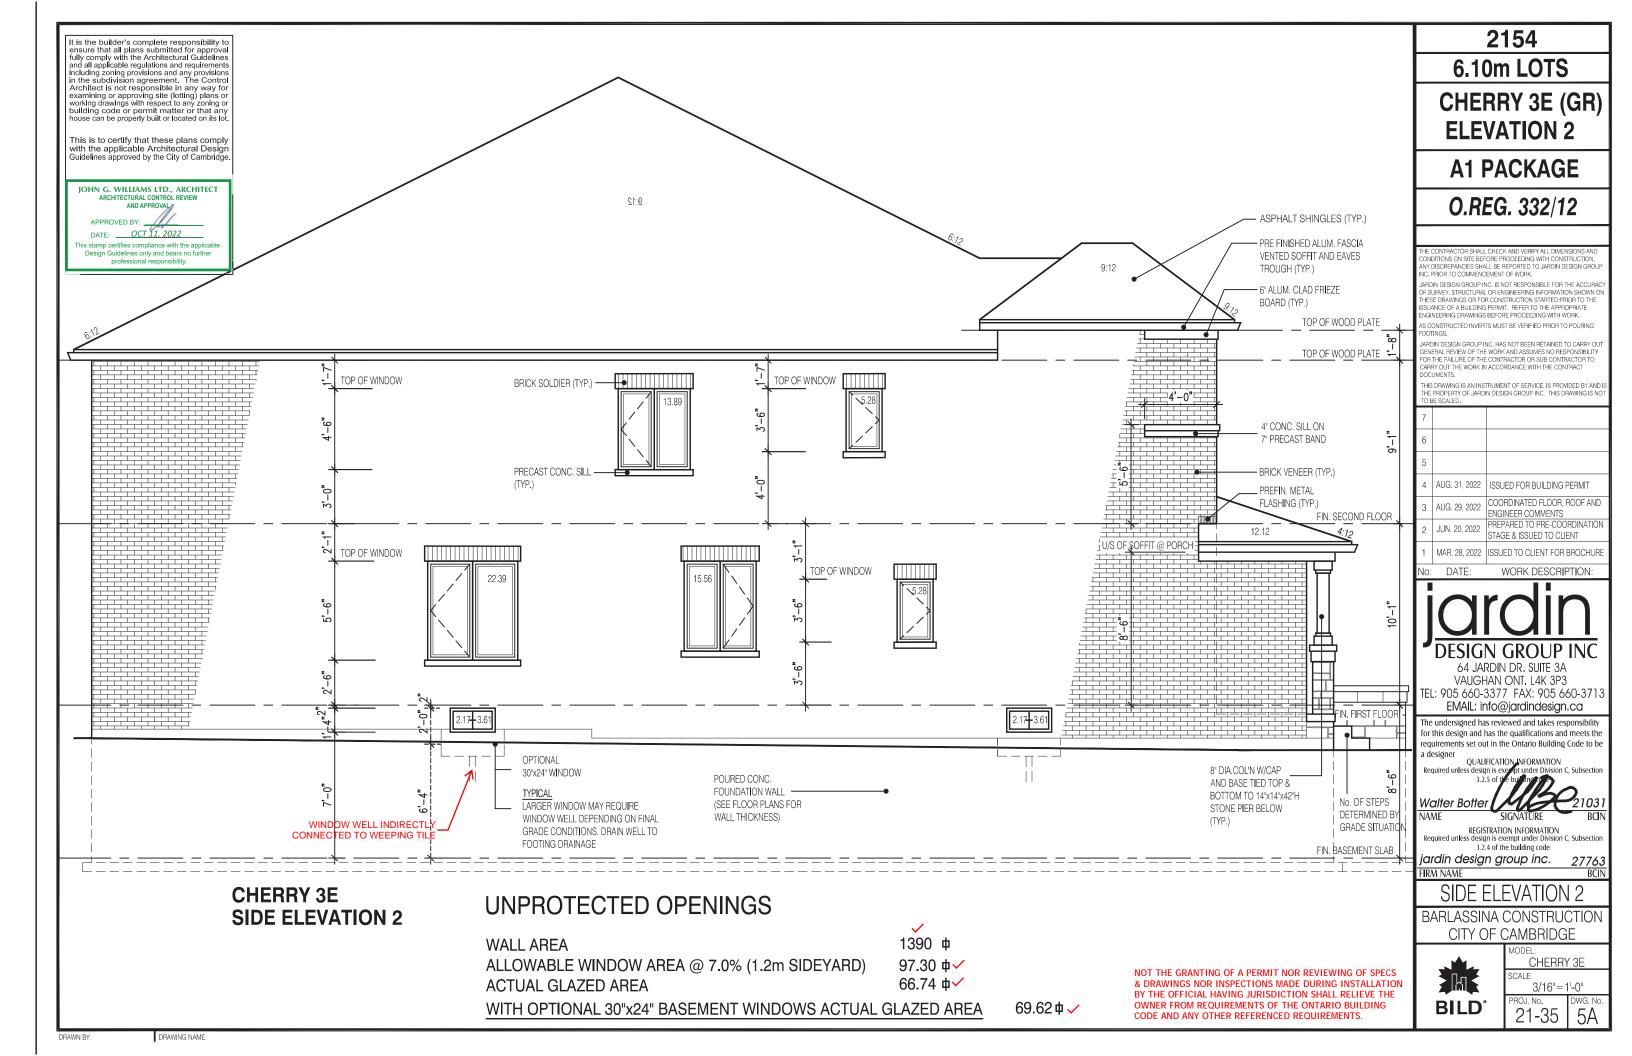

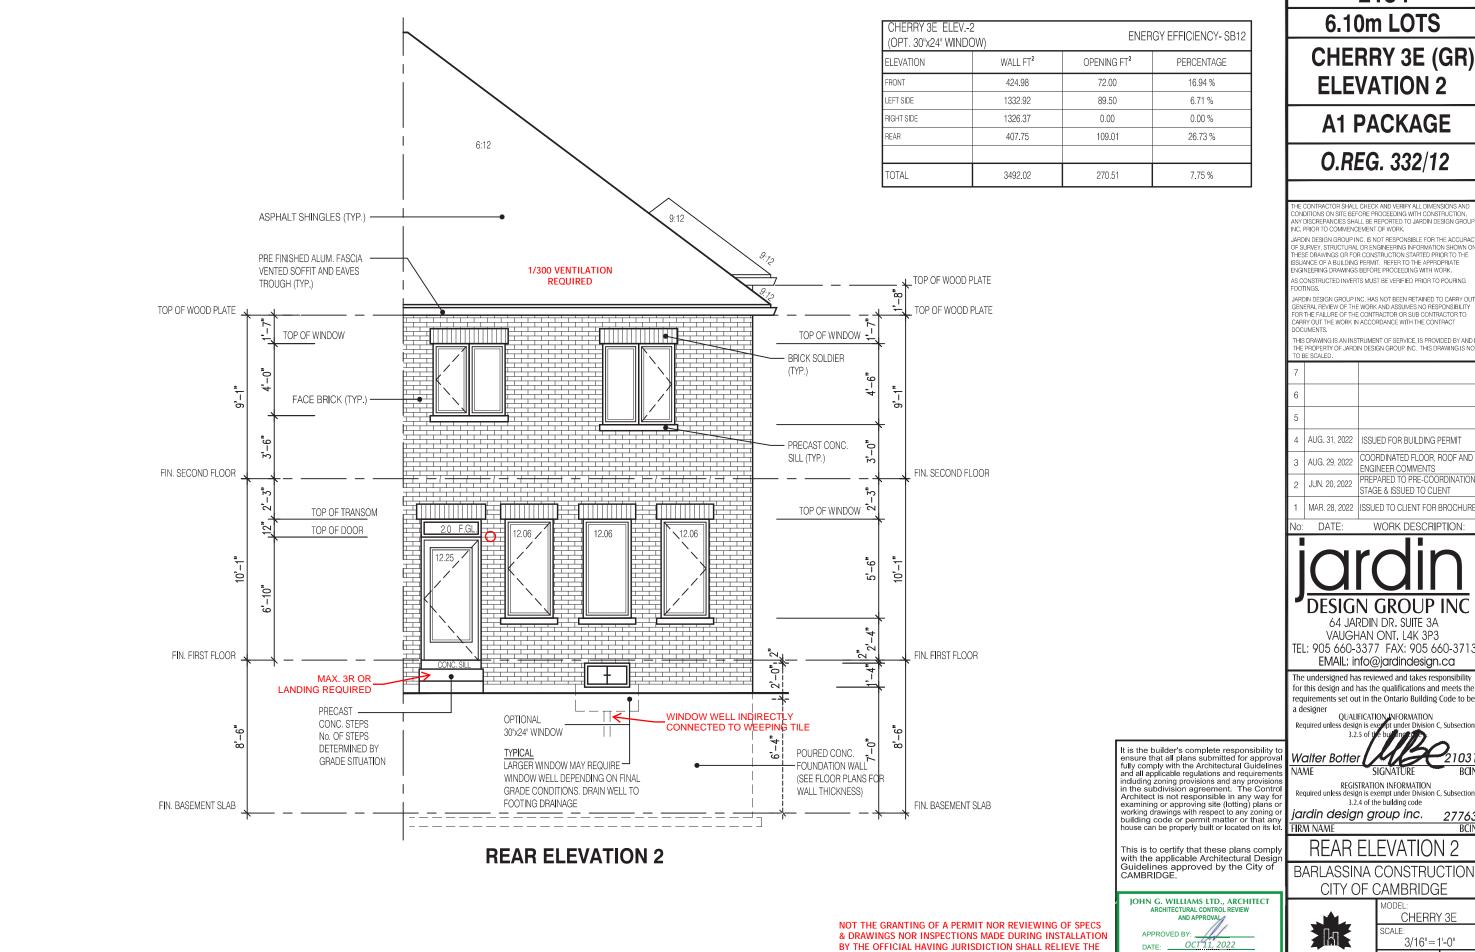

OWNER FROM REQUIREMENTS OF THE ONTARIO BUILDING

CODE AND ANY OTHER REFERENCED REQUIREMENTS.

2154

6.10m LOTS

CHERRY 3E (GR) **ELEVATION 2**

A1 PACKAGE

O.REG. 332/12

CONDITIONS ON SITE BEFORE PROCEEDING WITH CONSTRUCTION. IY DISCREPANCIES SHALL BE REPORTED TO JARDIN DESIGN GROUI

ARBINI DESIGN ORDUP INC. IS NOT RESPONSIBLE FOR THE ACCURY OF SURVEY, STRUCTURAL OR ENGINEERING INFORMATION SHOWN THESE DRAWINGS OR FOR CONSTRUCTION STARTED PRIOR TO THE SSUANCE OF A BUILDING PERMIT. REFER TO THE APPROPRIATE ENGINEERING DRAWINGS BEFORE PROCEEDING WITH WORK. AS CONSTRUCTED INVERTS MUST BE VERIFIED PRIOR TO POURING

THIS DRAWING IS AN INSTRUMENT OF SERVICE. IS PROVIDED BY AND IS HE PROPERTY OF JARDIN DESIGN GROUP INC. THIS DRAWING IS NOT BE SCALED.

ISSUED FOR BUILDING PERMIT COORDINATED FLOOR, ROOF AND ENGINEER COMMENTS REPARED TO PRE-COORDINATION STAGE & ISSUED TO CLIENT

WORK DESCRIPTION:



VAUGHAN ONT, L4K 3P3 TEL: 905 660-3377 FAX: 905 660-3713 EMAIL: info@jardindesian.ca

The undersigned has reviewed and takes responsibility for this design and has the qualifications and meets the requirements set out in the Ontario Building Code to be

REGISTRATION INFORMATION Required unless design is exempt under Division C, Subsection 3.2.4 of the building code

iardin design group inc.

REAR ELEVATION 2


BARLASSINA CONSTRUCTION CITY OF CAMBRIDGE



his stamp certifies compliance with the applicabl Design Guidelines only and bears no further

CHERRY 3E SCALE: 3/16"=1'-0" ROJ. No. 21-35

6A

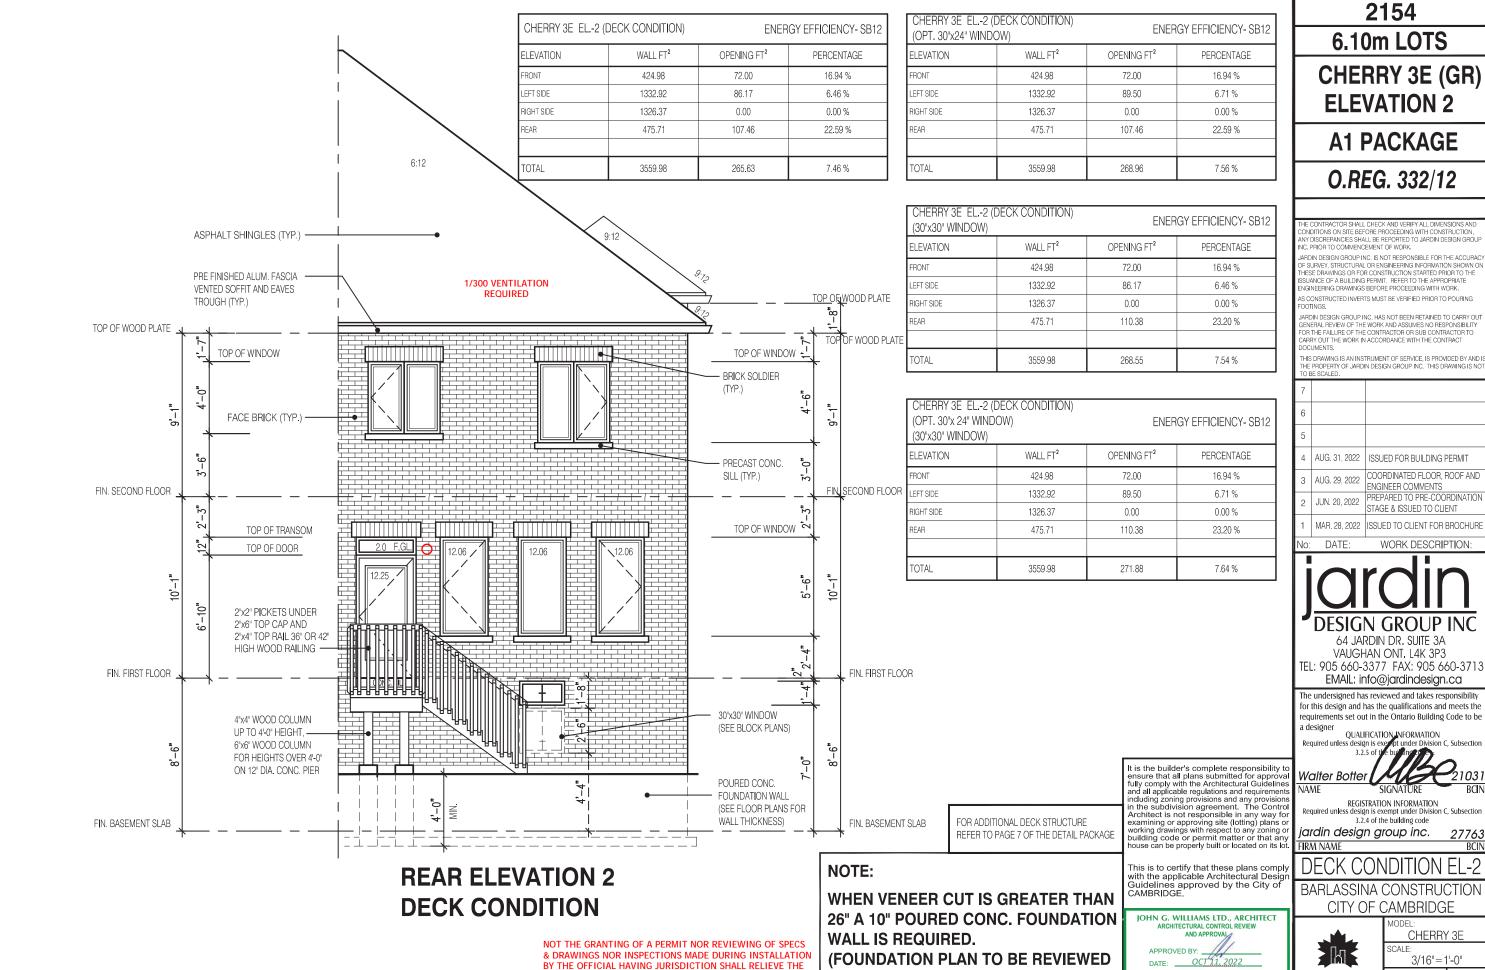

OWNER FROM REQUIREMENTS OF THE ONTARIO BUILDING

CODE AND ANY OTHER REFERENCED REQUIREMENTS.

DRAWING NAME

BILD

his stamp certifies compliance with the applical

Design Guidelines only and bears no furthe

IN CONJUNCTION WITH SITE PLAN)

ISSUED FOR BUILDING PERMIT

ENGINEER COMMENTS

COORDINATED FLOOR, ROOF AND

REPARED TO PRE-COORDINATION

WORK DESCRIPTION:


CHERRY 3E

3/16"=1'-0"

SCALE

21-35

STAGE & ISSUED TO CLIENT

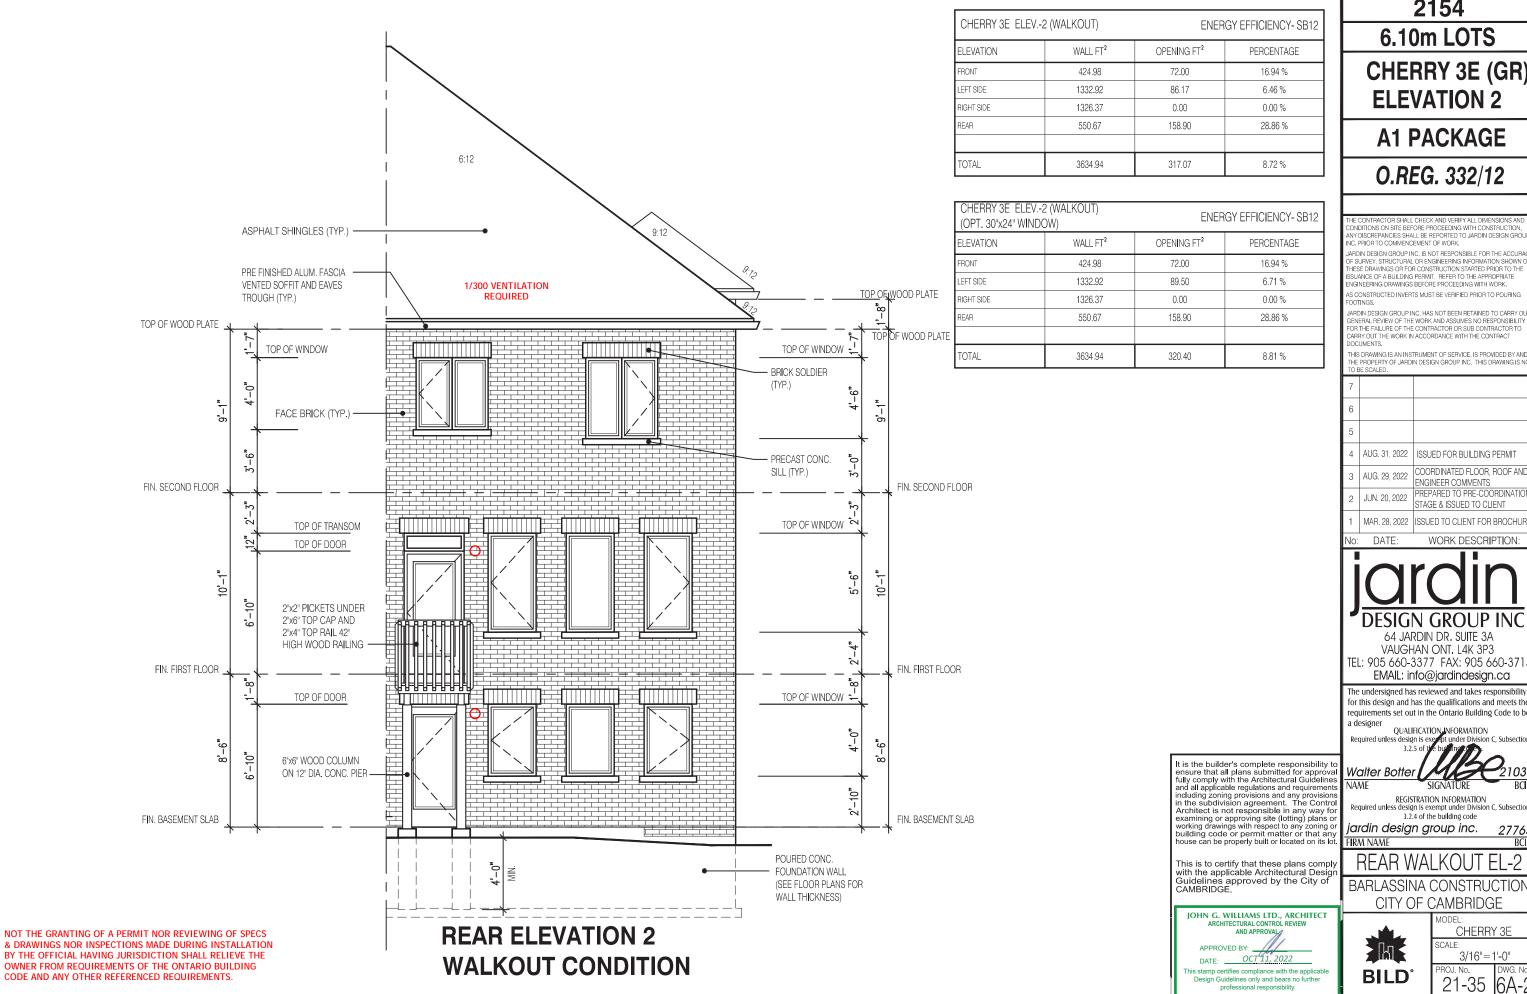

2154

6.10m LOTS

CHERRY 3E (GR) **ELEVATION 2**

A1 PACKAGE

ONDITIONS ON SITE BEFORE PROCEEDING WITH CONSTRUCTION

SUANCE OF A BUILDING PERMIT. REFER TO THE APPROPRIATE NGINEERING DRAWINGS BEFORE PROCEEDING WITH WORK.

ARRY OUT THE WORK IN ACCORDANCE WITH THE CONTRACT THIS DRAWING IS AN INSTRUMENT OF SERVICE, IS PROVIDED BY AND

THE PROPERTY OF JARDIN DESIGN GROUP INC. THIS DRAWING IS NOT BE SCALED.

6		
5		
4	AUG. 31, 2022	ISSUED FOR BUILDING PERMIT
3	AUG. 29, 2022	COORDINATED FLOOR, ROOF AND ENGINEER COMMENTS
2	JUN. 20, 2022	PREPARED TO PRE-COORDINATION STAGE & ISSUED TO CLIENT
1	MAR. 28. 2022	ISSUED TO CLIENT FOR BROCHUR

WORK DESCRIPTION:



VAUGHAN ONT. L4K 3P3 TEL: 905 660-3377 FAX: 905 660-3713 EMAIL: info@jardindesign.ca

The undersigned has reviewed and takes responsibility for this design and has the qualifications and meets the requirements set out in the Ontario Building Code to be

REGISTRATION INFORMATION Required unless design is exempt under Division C, Subsection

REAR WALKOUT EL-2

BARLASSINA CONSTRUCTION CITY OF CAMBRIDGE

CHERRY 3E

3/16"=1'-0"

