DOOR SHEDULE

1 = 2'-10" x 6'-8" INSULATED ENTRANCE DOOR 1A = 2'-8" x 6'-8" INSULATED ENTRANCE DOOR

 $2 = 2'-8" \times 6'-8"$ EXTERIOR GLAZED DOOR

 $3 = 2'-8" \times 6'-8"$ SLAB DOOR (1 3/4" EXTERIOR) $4 = 2'-8" \times 6'-8"$ SLAB DOOR (1 3/8" INTERIOR)

 $5 = 2'-6" \times 6'-8"$ SLAB DOOR (1 3/8" INTERIOR)

 $6 = 2'-2'' \times 6'-8''$ SLAB DOOR (1 3/8" INTERIOR)

 $7 = 1'-6" \times 6'-8"$ SLAB DOOR (1 3/8" INTERIOR)

 $8 = 2'-6" \times 6'-8" BI-FOLD (1 3/8" INTERIOR)$

 $9 = 3'-0" \times 6'-8" BI-FOLD (1 3/8" INTERIOR)$

10= 2- 2'-0" x 6'-8" BI-FOLD (1 3/8" INTERIOR

11= 2- 2'-6" x 6'-8" BI-FOLD (1 3/8" INTERIOR

 $12 = 2'-6" \times 6'-8"$ FRENCH DOOR (1 3/8" INTERIOR)

PAD FOOTING

120 KPa NATIVE SOIL 90 KPa ENGINEERED FILL SOIL

F1 = 42"x42"x18" CONCRETE PAD F1 = 48"x48"x20" CONCRETE PAD F2 = 36"x36"x16" CONCRETE PAD F2 = 40"x40"x16" CONCRETE PAD

F3 = 30"x30"x12" CONCRETE PAD F3 = 34"x34"x14" CONCRETE PAD

F4 = 24"x24"x12" CONCRETE PAD F4 = 28"x28"x12" CONCRETE PAD F5 = 16"x16"x8" CONCRETE PAD F5 = 18"x18"x8" CONCRETE PAD

(REFER TO FLOOR PLAN FOR UNUSUAL SIZE PADS NOT ON CHART)

WHEN VENEER CUT IS GREATER THAN 26" A 10" POURED CONC. FOUNDATION WALL IS REQUIRED.

NOTE:

ALL GARAGE SLABS, PORCH SLABS, STAIRS (EXPOSED CONC. FLAT WORK) TO BE 32 MPa WITH 5-8% AIR ENTRAITMENT.

BRICK VENEER LINTELS:

 $WL1 = 3 \frac{1}{2} \times 3 \frac{1}{2} \times 1 \frac{4}{90 \times 90 \times 6} + 2 - 2 \times 8 \times SPR.$ WL2 = 4" x 3 1\2" x 5\16" (100x90x8) + 2-2" x 8" SPR.

 $WL3 = 5" \times 3 \ 1\ 2" \times 5\ 16" (125 \times 90 \times 8) + 2 - 2" \times 10" SPR.$ $WL4 = 6" \times 3 \ 1\ 2" \times 3\ 8" \ (150\times90\times10) + 2-2" \times 12" \ SPR.$ $WL5 = 6" \times 4" \times 3 \times (150 \times 100 \times 10) + 2 - 2" \times 12" SPR.$

WL6 = 5" x 3 1\2" x 5\16" (125x90x8) + 2- 2" x 12" SPR. $WL7 = 5'' \times 3 \times 1^2 \times 5 \times 16'' \times 125 \times 90 \times 8 \times 10'' \times 1$ WL8 = 5" x 3 1\2" x 5\16" (125x90x8) + 3-2" x12" SPR. WL9 = 6" x 4" x 3\8" (150x100x10) + 3- 2" x 12" SPR.

WOOD LINTELS:

WB1 = 2-2" x 8" SPRUCE BEAM WB6 = 3-2" x 12" SPRUCE BEAM WB2 = 3-2" x 8" SPRUCE BEAM WB7 = 5-2" x 12" SPRUCE BEAM WB3 = 2-2" x 10" SPRUCE BEAM WB10 = 4-2" x 8" SPRUCE BEAM WB4 = 3-2" x 10" SPRUCE BEAM WB11 = 4-2" x 10" SPRUCE BEAM WB5 = 2-2" x 12" SPRUCE BEAM

STEEL LINTELS:

 $L1 = 3.1 \times 3.1 \times 1.4$ (90 x 90 x 6) L4 = 6 x 3.1 \(2 x 3\8 (150 x 90 x 10) L2 = 4" x 3 1\2" x 5\16" (100 x 90 x 8) L5 = 6" x 4" x 3\8" (150 x 100 x 10) L3 = 5" x 3 1\2" x 5\16" (125 x 90 x 8) L6 = 7" x 4" x 3\8" (180 x 100 x 10)


LAMINATED VENEER LUMBER (LVL BEAMS)

 $LVL1A = 1-1 3/4" \times 7 1/4" (1-45x184)$ LVL1 = 2-1 3/4" x 7 1/4" (2-45x184) $LVL2 = 3-1 3/4" \times 7 1/4" (3-45 \times 184)$ $LVL3 = 4-1 3/4" \times 7 1/4" (4-45 \times 184)$ $LVL4A = 1-1 3/4" \times 9 1/2" (1-45x240)$ $LVL4 = 2-1 3/4" \times 9 1/2" (2-45x240)$ LVL5 = 3-13/4" x 9 1/2" (3-45x240) LVL5A = 4-1.3/4" x 9 1/2" (4-45x240) LVL6A= 1-1 3/4" x 11 7/8" (1-45x300

LVL6 = 2-1 3/4" x 11 7/8" (2-45x300) IVI7 = 3-1 3/4" x 11 7/8" (3-45x300) LVL7A= 4-1 3/4" x 11 7/8" (4-45x300)

BY THE OFFICIAL HAVING JURISDICTION SHALL RELIEVE TH CODE AND ANY OTHER REFERENCED REQUIREMENTS

LVL8 = 2-13/4" x 14" (2-45x356) NOT THE GRANTING OF A PERMIT NOR REVIEWING OF SPEC LVL9 = 3-1 3/4" x 14" (3-45x356) & DRAWINGS NOR INSPECTIONS MADE DURING INSTALLATION

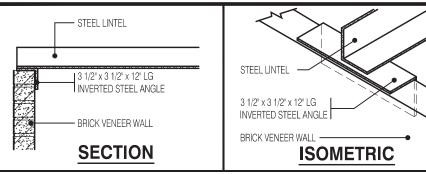

INVERTED STEEL ANGLE DETAIL

WALL FT²

394.76

1315.55

1315.55

379.06

3404.92

WALL FT²

394.76

1315.55

1315.55

379.06

3404 92

CHERRY 2 ELEV.-1

ELEVAT**I**ON

EFT SIDE

RIGHT SIDE

ALL NEW WINDOWS AND SLIDING GLASS DOORS TO COMPLY WITH THE THERMAL REQUIREMENTS OF SB-12. MAX U-1.6, ER-25

OORING IN KITCHENS, WASHROOMS, LAUNDR'

AND STORAGE AREAS, SHALL CONSIST OF FELTED-SYNTHETIC-FIBRE FLOOR COVERING,

CONCRETE, TILE, OR OTHER FLOORING

PROVIDING A SIMILAR WATER RESISTANCE

SIDING MATERIALS SHALL CONFORM TO

SECTION 9.27 OF DIVISION B OR HAVE A CCMC OR BMEC APPROVAL, OR A MINISTERS RULING

ELEVATION

FRONT

EFT SIDE

RIGHT SIDE

CHERRY 2 ELEV.-2

EXCEED 49°C (120°F) EXCEPT FOR

Scale: 3/4'' = 1'-0''

ENERGY EFFICIENCY-SB12

PERCENTAGE

10.47 %

0.00 %

1.60 %

24.48 %

4.56 %

OPENING FT²

41.35

0.00

21.00

92.78

155.13

THE ONTARIO BUILDING CODE REQUIRES THAT A SMOKE ALARM BE INSTALL ON EACH FLOOR LEVEL AND WITHIN EACH SLEEPING ROOM. ALL SMOKE

ALARMS SHALL BE INTERCONNECTED. EACH DEVICE SHALL HAVE A VISUAL

SIGNALING COMPONENT IN ADDITION TO THE TEMPORAL PATTERN IN

CONFORMANCE WITH 18.5.3. OF "LIGHT, COLOUR AND PULSE

CHARACTERISTICS" OF NFPA 72

ENERGY EFFICIENCY-SB12

PERCENTAGE

12.92 %

0.00 %

1.60 %

24.48 %

4.84 %

A SEPARATE PERMIT IS REQUIRED FOR THE FINISHING OF ALL ROUGHIN PLUBMING FIXTURES

OPENING FT²

50.99

0.00

21.00

92.78

164.77

A CARBON MONOXIDE DETECTOR SHALL BE LOCATED ADJACENT TO SLEEPING AREAS

PORCH SLAB SHALL BE REVIEWED PRIOR TO POURING CONRETE (see inspector)

PROVIDE P.ENG APPROVED TRUSS & FLOOR DRAWINGS AND SPECIFICATIONS TO BUILDING INSPECTOR AT FRAMING INSPECTION

INSTALLATION OF FLUSH STEEL BEAMS HALL CONFORM TO THE REQUIREMENTS OF 9.23.9.2.(3), (4) & (5)

SOILS. SEE FIELD INSPECTOR

FINAL GRADING CERTIFICATE REQ'D BEFORE FINAL INSPECTION SIGN-OFF

GLAZING PRODUCTS IDENTIFYING THE CERTIFIED VALUES SHALL REMAIN ON FOR REVIEW DURING CONSTRUCTION

AREA CALCULATIONS EL-1

FIRST FLOOR AREA 812 Sq. Ft SECOND FLOOR AREA TOTAL FLOOR AREA ADD OPEN AREAS ADD FIN. BASEMENT AREA = GROSS FLOOR AREA GROUND FLOOR COVERAGE = 812 Sq. Ft. GARAGE COVERAGE / AREA = 406 Sg. Ft. PORCH COVERAGE / AREA COVERAGE W/ PORCH COVERAGE W/O PORCH

AREA CALCULATIONS EL-2

NOTE:

THESE DRAWINGS ARE TO BE READ IN CONJUNCTION WITH ENGINEER APPROVED ROOF TRUSS DRAWINGS BY MANUFACTURER

NOTE:

SPACE CONVENTIONAL FLOOR JOISTS @ 12" O.C. BELOW ALL CERAMIC TILE AREAS. PROVIDE 1 ROW BRIDGING FOR SPANS OF 5'-7', 2 ROWS FOR SPANS GREATER THAN 7'

NOTE:

THESE DRAWINGS ARE TO BE READ IN CONJUNCTION WITH ENGINEER APPROVED FLOOR TRUSS LAYOUT BY MANUFACTURER

NOTE:

PLANS NOT DRAWN TO ACTUAL GRADE. REFER TO FINAL GRADING PLAN.

SB-12 - COMPLIANCE PACKAGE A1 CEILING WITH ATTIC SPACE R31 CEILING W/O ATTIC SPACE R31 EXPOSED FLOOR R22 VALLS ABOVE GRADE BASEMENT WALLS R20ci SLAB > 600mm BELOW GRADE HEATED SLAB OR < 600mm BELOW GRADE R10 R10 EDGE OF SLAB < 600mm BELOW GRADE WINDOWS AND SLIDING GLASS DOORS MAX. U0.28 ER25 MAX. U0.49 SKYLIGHTS MIN. AFUE 96% SPACE HEATING EQUIPMENT MIN. SRE 75% MIN. EF. 0.80 DOMESTIC WATER HEATER MIN. 42% DRAIN WATER HEAT RECOVERY UNIT

CITY OF CAMBRIDGE BUILDING DIVISION

 $\widetilde{\mathfrak{O}}$

3

တ

 $\overline{}$

 $\overline{}$

Block

STRUDET INC.

នួ B. MARINKOVIC

FOR STRUCTURE ONLY

= 1218 Sq. Ft. 2030 Sq. Ft. 0 Sq. Ft. 0 Sq. Ft. 2030 Sq. Ft. 61 Sq. Ft. = 1279 Sq. Ft $= 118.82 \, \text{Sq. m.}$ = 1218 Sq. Ft. $= 113.16 \, \text{Sg. m.}$

FIRST FLOOR AREA SECOND FLOOR AREA	=	0.= 0q	
OTAL FLOOR AREA	=	2030 Sq. Ft.	
ADD OPEN AREAS ADD FIN. BASEMENT AREA	=		
GROSS FLOOR AREA	=	2030 Sq. Ft.	
GROUND FLOOR COVERAGE GARAGE COVERAGE / AREA PORCH COVERAGE / AREA	=		
COVERAGE W/ PORCH		1279 Sq. Ft. 118.82Sq. m.	
COVERAGE W/O PORCH		1218 Sq. Ft. 113.16 Sq. m.	

LEGEND:

BUILDING FACE < THAN 4'-0" (1.2m) (45 MIN. FIRE RATING REQ'D) INDICATES SOLID BEARING REQUIRED

OR POINT LOAD FROM ABOVE STL. PLATE FOR STEEL COL'N ABOVE 2.0.3

LVL LAMINATED VENEER LUMBER

S.J. SINGLE JOIST

D.J. DOUBLE JOIST

T.J. TRIPLE JOIST 0 REPEAT NOTE

0 SHOWER WEEPERS

2030

6.10m LOTS CHERRY 2 (GR)

ELEVATION 1 & 2

A1 PACKAGE

O.REG. 332/12

ONDITIONS ON SITE BEFORE PROCEEDING WITH CONSTRUCTION NY DISCREPANCIES SHALL BE REPORTED TO JARDIN DESIGN GROU INC. PRIOR TO COMMENCEMENT OF WORK

JARDIN DESIGN GROUP INC. IS NOT RESPONSIBLE FOR THE ACCURA ORDINI DESIGN AND INC. IN ON INSERVINISHE PON THE RECOVERY OF SURVEY, STRUCTURAL OR ENGINEERING INFORMATION SHOWN OF THESE DRAWINGS OR FOR CONSTRUCTION STATTED PRIOR TO THE ISSUANCE OF A BUILDING PERMIT. REFER TO THE APPROPRIATE ENGINEERING DRAWINGS BEFORE PROCEEDING WITH WORK.

CONSTRUCTED INVERTS MUST BE VERIFIED PRIOR TO POURING

JARDIN DESIGN GROUP INC. HAS NOT BEEN RETAINED TO CARRY OU SENERAL REVIEW OF THE WORK AND ASSUMES NO RESPONSIBILITY FOR THE FAILURE OF THE CONTRACTOR OR SUB CONTRACTOR TO

THIS DRAWING IS AN INSTRUMENT OF SERVICE, IS PROVIDED BY AND THE PROPERTY OF JARDIN DESIGN GROUP INC. THIS DRAWING IS N

7		
6		
5		
4	AUG. 31, 2022	ISSUED FOR BUILDING PERMIT
3	AUG. 29, 2022	COORDINATED FLOOR, ROOF AND ENGINEER COMMENTS
2	JUN. 20, 2022	PREPARED TO PRE-COORDINATION STAGE & ISSUED TO CLIENT
1	MAR. 28, 2022	ISSUED TO CLIENT FOR BROCHUR

DATE: WORK DESCRIPTION

64 JARDIN DR. SUITE 3A VAUGHAN ONT, L4K 3P3 TEL: 905 660-3377 FAX: 905 660-3713 EMAIL: info@jardindesign.ca

The undersigned has reviewed and takes responsibility for this design and has the qualifications and meets the requirements set out in the Ontario Building Code to be a designer

a designer

QUALIFICATION INFORMATION

Required unless design is exempt under Division C, Subsection

3.2.5 of the building C (2)

Walter Botter NAME

REGISTRATION INFORMATION 3.2.4 of the building code 27763

jardin design group inc. FIRM NAME

TITLE PAGE

BARLASSINA CONSTRUCTION CITY OF CAMBRIDGE





CHERRY 2


3/16"=1'-0" DWG. No

21-35

DRAWING NAME

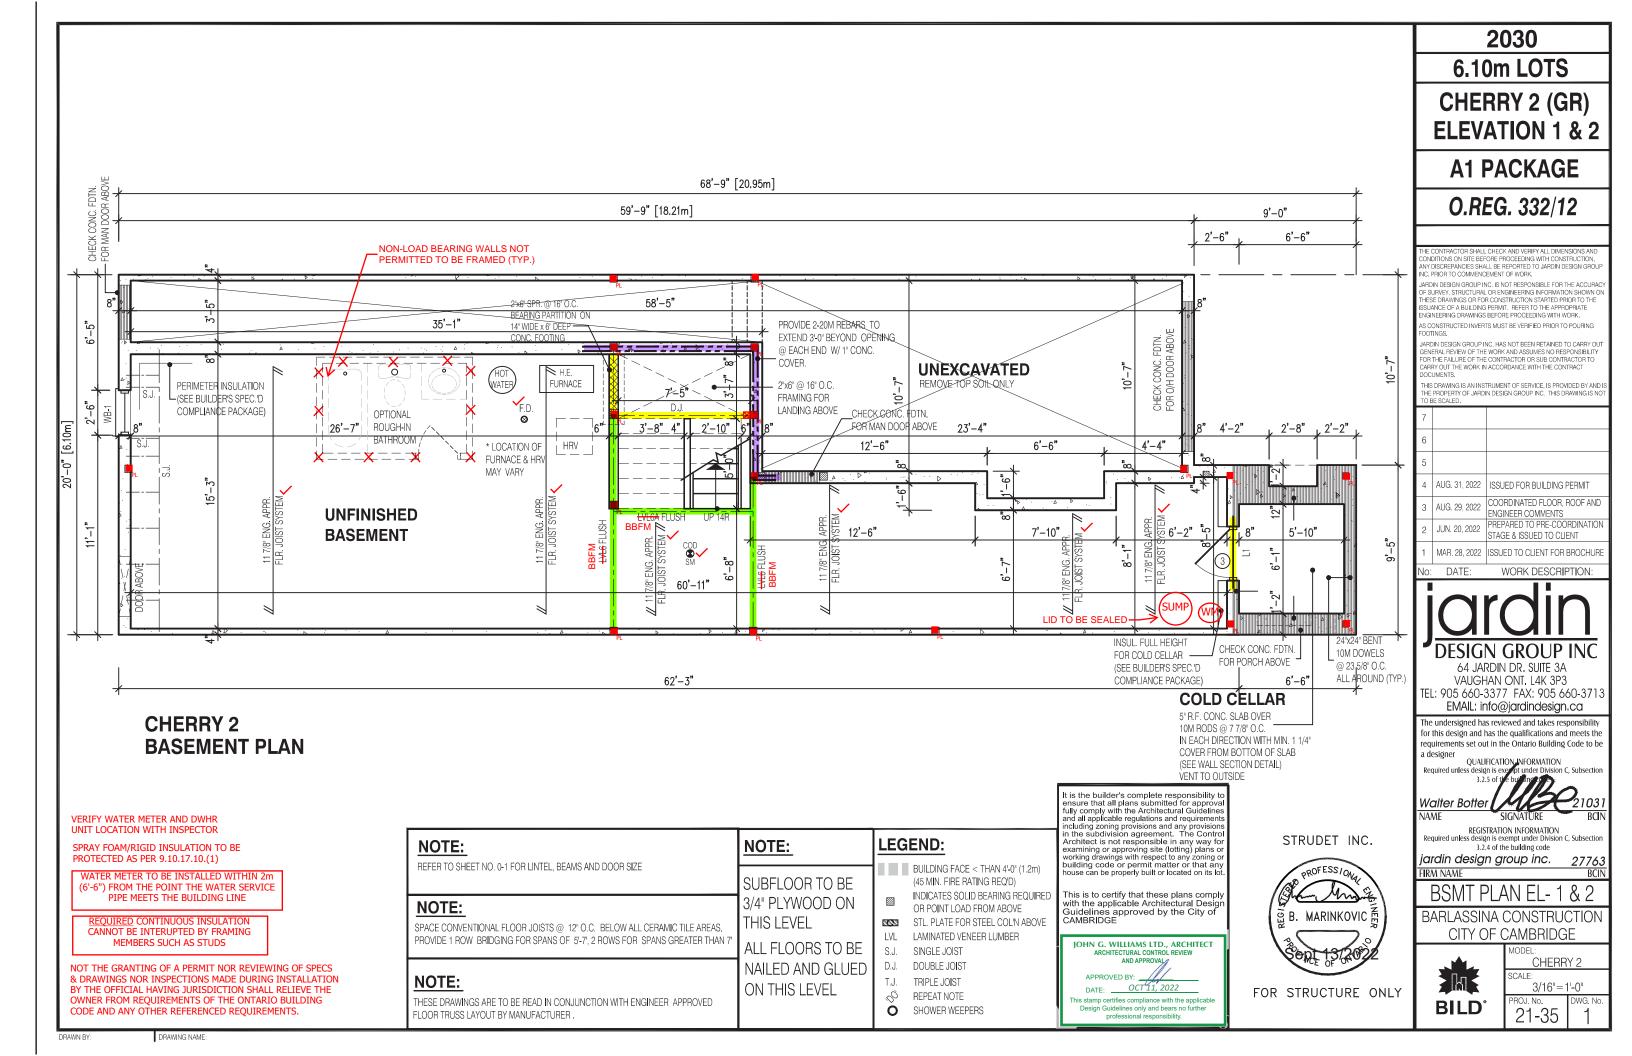

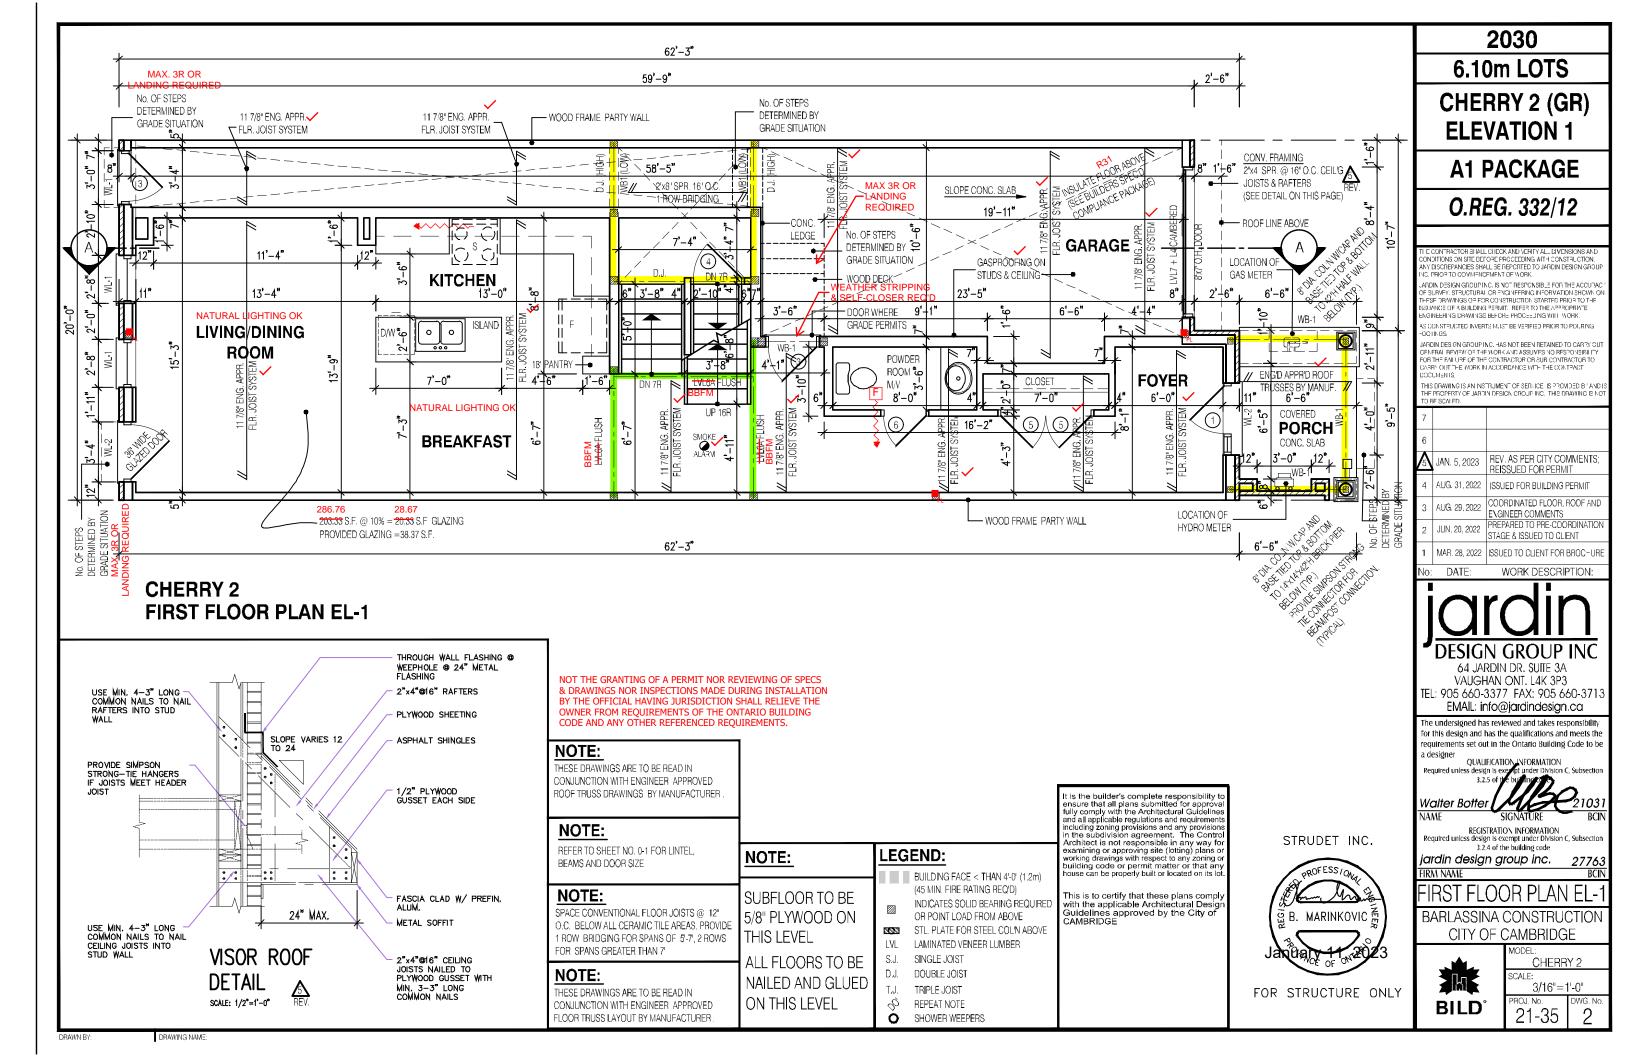

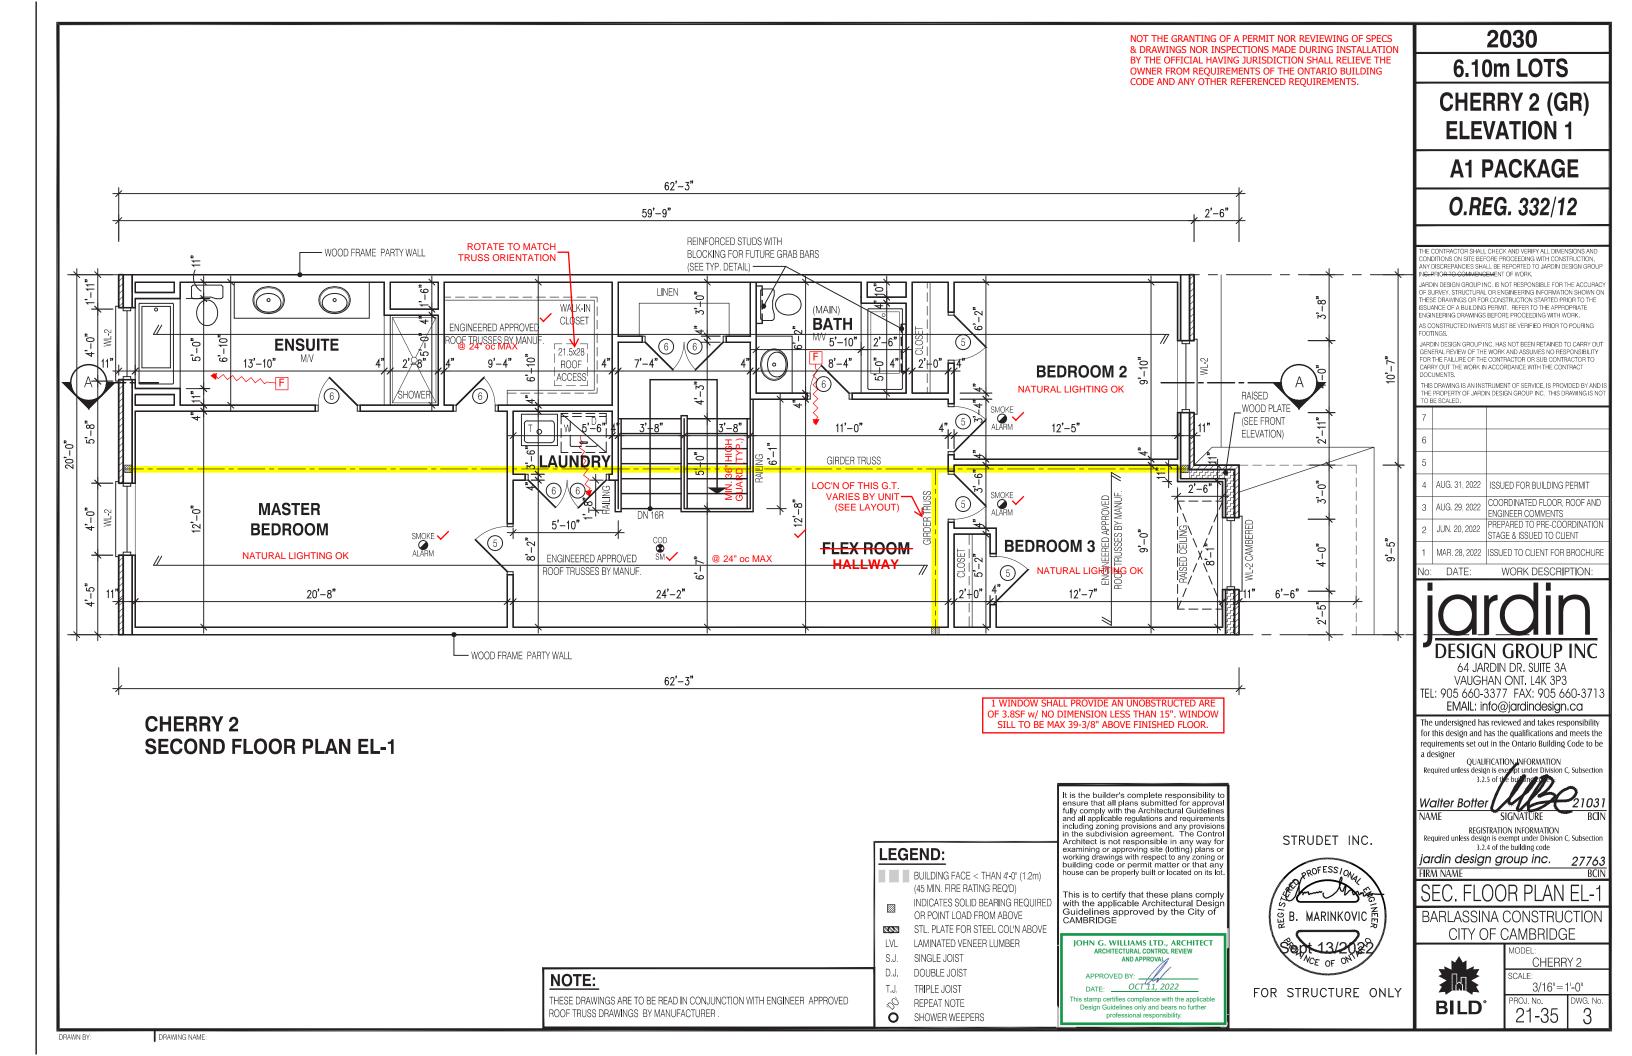

NOT THE GRANTING OF A PERMIT NOR REVIEWING OF SPECS & DRAWINGS NOR INSPECTIONS MADE DURING INSTALLATION BY THE OFFICIAL HAVING JURISDICTION SHALL RELIEVE THE OWNER FROM REQUIREMENTS OF THE ONTARIO BUILDING CODE AND ANY OTHER REFERENCED REQUIREMENTS.

11 7/8" FNG APPR

11'-4"

13'-4"

(45 MIN. FIRE RATING REQ'D)

OR POINT LOAD FROM ABOVE

LAMINATED VENEER LUMBER

SINGLE JOIST

DOUBLE JOIST

TRIPLE JOIST

REPEAT NOTE

SHOWER WEEPERS

8.0.8

LVL

S.J.


D.J.

T.J.

Ò

INDICATES SOLID BEARING REQUIRED

STL. PLATE FOR STEEL COL'N ABOVE

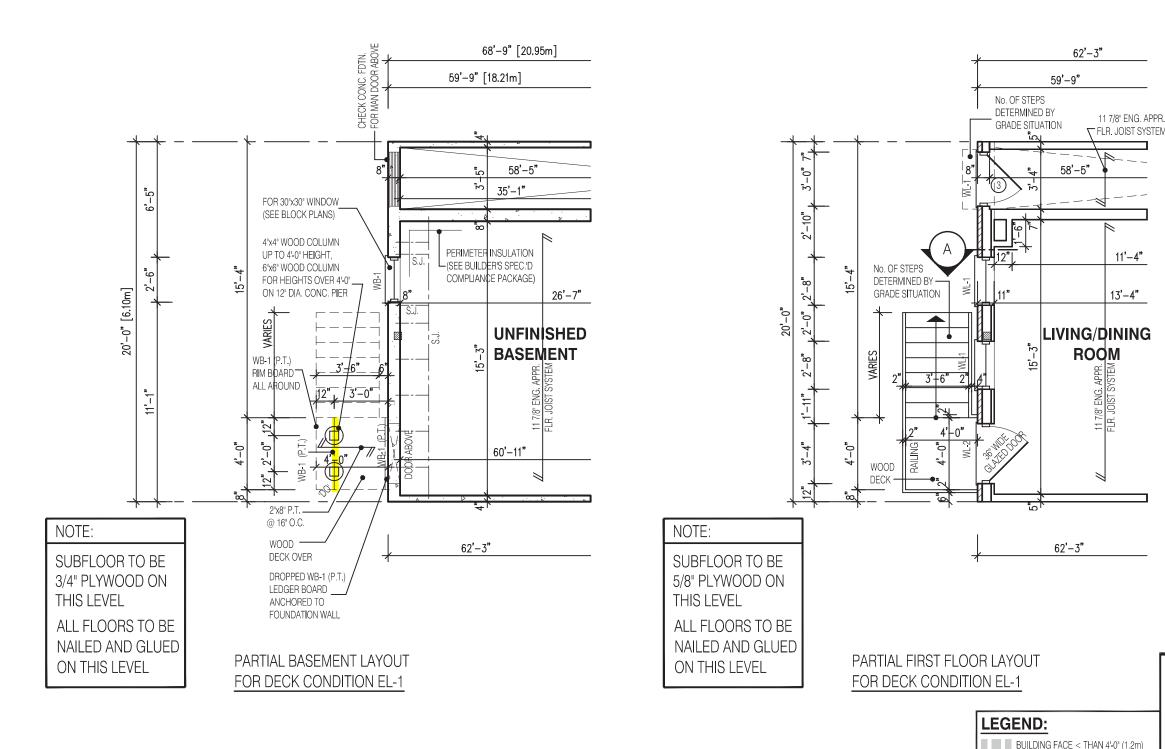

STRUDET INC.



FOR STRUCTURE ONLY

It is the builder's complete responsibility ensure that all plans submitted for approv fully comply with the Architectural Guideline and all applicable regulations and requiremen and all applicable regulations and requirement including zoning provisions and any provision in the subdivision agreement. The Contro Architect is not responsible in any way fo examining or approving site (lotting) plans o working drawings with respect to any zoning o building code or permit matter or that any nouse can be properly built or located on its I

This is to certify that these plans comp with the applicable Architectural Designation Guidelines approved by the City of

JOHN G. WILLIAMS LTD., ARCHITECT APPROVED BY: DATE: OCT 11, 2022

This stamp certifies compliance with the applicab Design Guidelines only and bears no further

2030

6.10m LOTS

CHERRY 2 (GR) **ELEVATION 1**

A1 PACKAGE

O.REG. 332/12

NDITIONS ON SITE BEFORE PROCEEDING WITH CONSTRUCTION Y DISCREPANCIES SHALL BE REPORTED TO JARDIN DESIGN GROU

ARDIN DESIGN GROUP INC. IS NOT RESPONSIBLE FOR THE ACCURAC OF SURVEY, STRUCTURAL OR ENGINEERING INFORMATION SHOWN O HESE DRAWINGS OR FOR CONSTRUCTION STARTED PRIOR TO THE UANCE OF A BUILDING PERMIT. REFER TO THE APPROPRIATE NGINEERING DRAWINGS BEFORE PROCEEDING WITH WORK. S CONSTRUCTED INVERTS MUST BE VERIFIED PRIOR TO POURING

ARDIN DESIGN GROUP INC. HAS NOT BEEN HETAINED TO CARRY OU ENERAL REVIEW OF THE WORK AND ASSUMES NO RESPONSIBILITY OR THE FAILURE OF THE CONTRACTOR OR SUB CONTRACTOR TO ARRY OUT THE WORK IN ACCORDANCE WITH THE CONTRACT

THIS DRAWING IS AN INSTRUMENT OF SERVICE. IS PROVIDED BY AND I HE PROPERTY OF JARDIN DESIGN GROUP INC. THIS DRAWING IS N

AUG. 31, 2022 ISSUED FOR BUILDING PERMIT COORDINATED FLOOR, ROOF AND ENGINEER COMMENTS PREPARED TO PRE-COORDINATION STAGE & ISSUED TO CLIENT MAR. 28, 2022 ISSUED TO CLIENT FOR BROCHURE

WORK DESCRIPTION:

DESIGN GROUP INC

64 JARDIN DR. SUITE 3A VAUGHAN ONT. L4K 3P3 TEL: 905 660-3377 FAX: 905 660-3713 EMAIL: info@jardindesign.ca

The undersigned has reviewed and takes responsibility for this design and has the qualifications and meets the requirements set out in the Ontario Building Code to be a designer

OUALIFICATION INFORMATION

Nalter Botter NAME

REGISTRATION INFORMATION
Required unless design is exempt under Division C, Subsection 3.2.4 of the building code

jardin design group inc. FIRM NAME

DECK CONDITION EL-1

BARLASSINA CONSTRUCTION CITY OF CAMBRIDGE



CHERRY 2 3/16"=1'-0"

27763

21-35

NOTE:

DRAWN BY

WHEN VENEER CUT IS GREATER THAN 26" A 10" POURED CONC, FOUNDATION WALL IS REQUIRED. (FOUNDATION PLAN TO BE REVIEWED IN CONJUNCTION WITH SITE PLAN)

NOTE:

REFER TO SHEET NO. 0 - FOR LINTEL, BEAMS AND DOOR SIZE

NOTE:

THESE DRAWINGS ARE TO BE READ IN CONJUNCTION WITH ENGINEER APPROVED ROOF TRUSS DRAWINGS BY MANUFACTURER.


NOTE:

SPACE CONVENTIONAL FLOOR JOISTS @ 12" O.C. BELOW ALL CERAMIC TILE AREAS. PROVIDE 1 ROW BRIDGING FOR SPANS OF 5'-7', 2 ROWS FOR SPANS GREATER THAN 7

NOTE:

THESE DRAWINGS ARE TO BE READ IN CONJUNCTION WITH ENGINEER APPROVED FLOOR TRUSS LAYOUT BY MANUFACTURER

NOT THE GRANTING OF A PERMIT NOR REVIEWING OF SPECS & DRAWINGS NOR INSPECTIONS MADE DURING INSTALLATION BY THE OFFICIAL HAVING JURISDICTION SHALL RELIEVE THE OWNER FROM REQUIREMENTS OF THE ONTARIO BUILDING CODE AND ANY OTHER REFERENCED REQUIREMENTS.

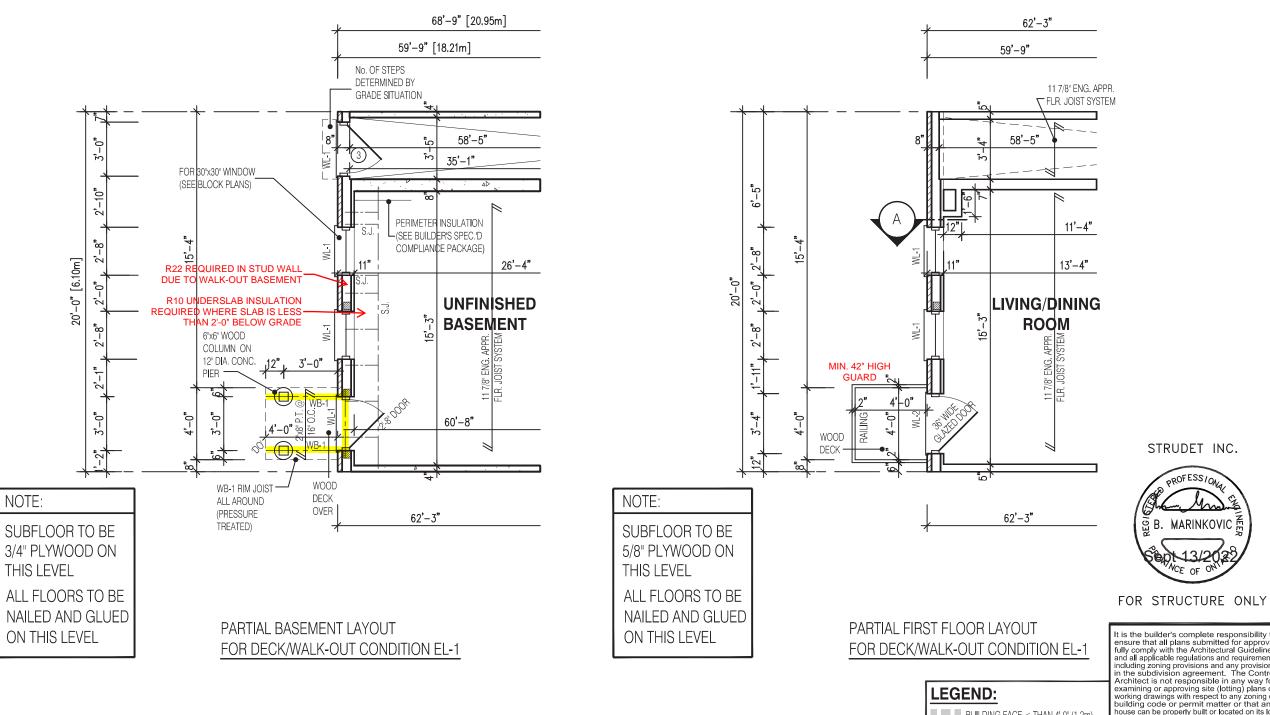

BUILDING FACE < THAN 4'-0" (1.2m) (45 MIN. FIRE RATING REQ'D)

INDICATES SOLID BEARING REQUIRED OR POINT LOAD FROM ABOVE STL. PLATE FOR STEEL COL'N ABOVE 2.02 LVL

LAMINATED VENEER LUMBER

S.J. SINGLE JOIST

D.J. DOUBLE JOIST

REPEAT NOTE

SHOWER WEEPERS

STRUDET INC.

PROFESS/ON

흥 B. MARINKOVIC 魚

VCE OF ON

This is to certify that these plans comp with the applicable Architectural Designation

Guidelines approved by the City of

JOHN G. WILLIAMS LTD., ARCHITECT

This stamp certifies compliance with the applicable

Design Guidelines only and bears no further professional responsibility.

DATE:

OCT 11, 2022

4 AUG. 31, 2022 ISSUED FOR BUILDING PERMIT COORDINATED FLOOR, ROOF AND ENGINEER COMMENTS

2030

6.10m LOTS

CHERRY 2 (GR)

ELEVATION 1

A1 PACKAGE

O.REG. 332/12

CONDITIONS ON SITE BEFORE PROCEEDING WITH CONSTRUCTION

NC. PRIOR TO COMMENCEMENT OF WORK.

NY DISCREPANCIES SHALL BE REPORTED TO JARDIN DESIGN GROU

JARDIN DESIGN GROUP INC. IS NOT RESPONSIBLE FOR THE ACCURAC OF SURVEY, STRUCTURAL OR ENGINEERING INFORMATION SHOWN OI THESE DRAWINGS OR FOR CONSTRUCTION STARTED PRIOR TO THE

SSUANCE OF A BUILDING PERMIT. REFER TO THE APPROPRIATE ENGINEERING DRAWINGS BEFORE PROCEEDING WITH WORK.

AS CONSTRUCTED INVERTS MUST BE VERIFIED PRIOR TO POURING

JARDIN DESIGN GROUP INC. HAS NOT BEEN BETAINED TO CARRY OF

JARDIN DESIGN GROUP INC. HAS NOT BEEN HE INNEL TO CHARTY OU GENERAL REVIEW OF THE WORK AND ASSUMES NO RESPONSIBILITY FOR THE FAILURE OF THE CONTRACTOR OR SUB CONTRACTOR TO CARRY OUT THE WORK IN ACCORDANCE WITH THE CONTRACT

THIS DRAWING IS AN INSTRUMENT OF SERVICE, IS PROVIDED BY AND

HE PROPERTY OF JARDIN DESIGN GROUP INC. THIS DRAWING IS N

REPARED TO PRE-COORDINATION JUN. 20, 2022 TAGE & ISSUED TO CLIENT ISSUED TO CLIENT FOR BROCHURI

WORK DESCRIPTION:

DESIGN GROUP INC

64 JARDIN DR. SUITE 3A VAUGHAN ONT, L4K 3P3 TEL: 905 660-3377 FAX: 905 660-3713 EMAIL: info@jardindesign.ca

The undersigned has reviewed and takes responsibility for this design and has the qualifications and meets the requirements set out in the Ontario Building Code to be a designer

OUALIFICATION INFORMATION

Walter Bottei NAME

REGISTRATION INFORMATION Required unless design is exempt under Division C, Subsection

3.2.4 of the building code

jardin design group inc. IRM NAME

DECK/WALKOUT BARLASSINA CONSTRUCTION

CITY OF CAMBRIDGE



CHERRY 2 3/16"=1'-0"

21-35

NOTE:

DRAWN BY

WHEN VENEER CUT IS GREATER THAN 26" A 10" POURED CONC. FOUNDATION WALL IS REQUIRED. (FOUNDATION PLAN TO BE REVIEWED IN CONJUNCTION WITH SITE PLAN)

NOTE:

REFER TO SHEET NO. 0 - FOR LINTEL, BEAMS AND DOOR SIZE

NOTE:

HESE DRAWINGS ARE TO BE READ IN CONJUNCTION WITH ENGINEER APPROVED ROOF TRUSS DRAWINGS BY MANUFACTURER

NOTE:

SPACE CONVENTIONAL FLOOR JOISTS @ 12" O.C. BELOW ALL CERAMIC TILE AREAS. PROVIDE 1 ROW BRIDGING FOR SPANS OF 5'-7', 2 ROWS FOR SPANS GREATER THAN 7


NOTE:

THESE DRAWINGS ARE TO BE READ IN CONJUNCTION WITH ENGINEER APPROVED FLOOR TRUSS LAYOUT BY MANUFACTURER

T.J. TRIPLE JOIST

Ò

DRAWING NAME

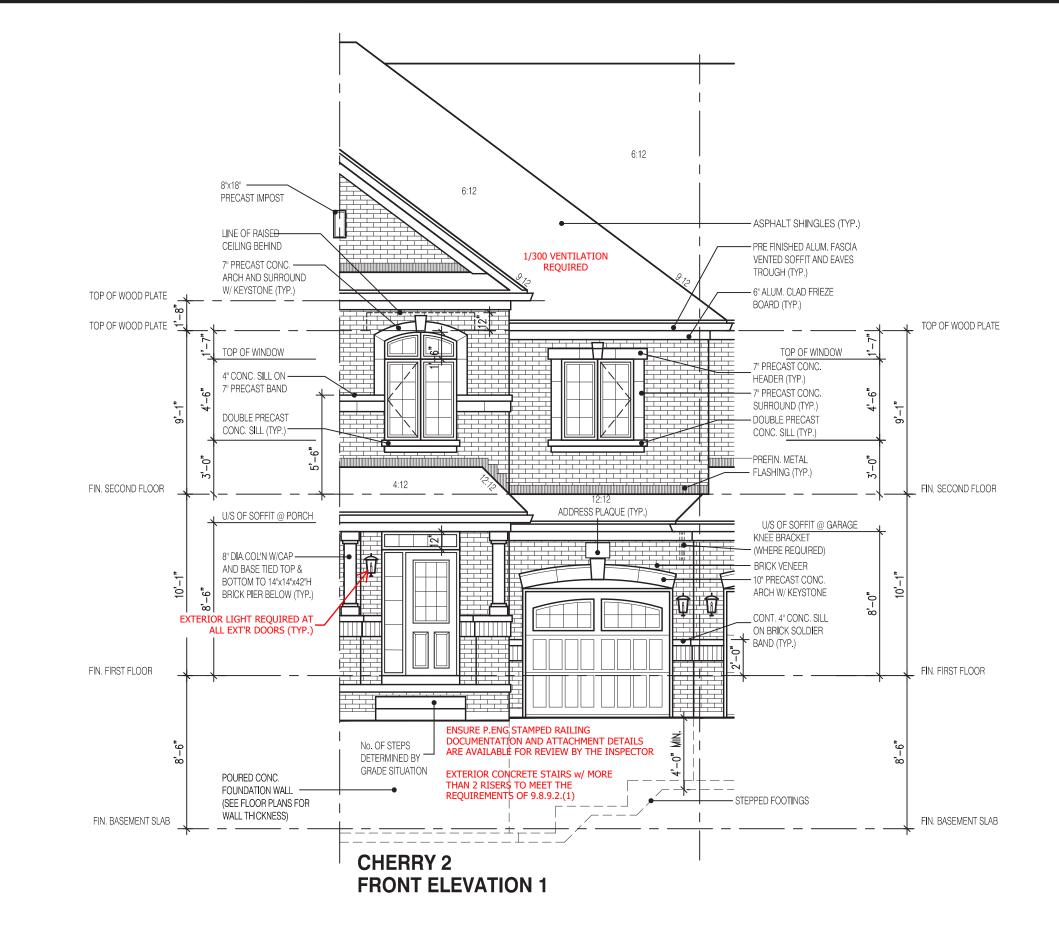

NOT THE GRANTING OF A PERMIT NOR REVIEWING OF SPECS & DRAWINGS NOR INSPECTIONS MADE DURING INSTALLATION BY THE OFFICIAL HAVING JURISDICTION SHALL RELIEVE THE OWNER FROM REQUIREMENTS OF THE ONTARIO BUILDING CODE AND ANY OTHER REFERENCED REQUIREMENTS.

2030

6.10m LOTS

CHERRY 2 (GR) **ELEVATION 1**

A1 PACKAGE

O.REG. 332/12

CONDITIONS ON SITE BEFORE PROCEEDING WITH CONSTRUCTION. IY DISCREPANCIES SHALL BE REPORTED TO JARDIN DESIGN GROUI INC. PRIOR TO COMMENCEMENT OF WORK.

JARDIN DESIGN GROUP INC. IS NOT RESPONSIBLE FOR THE ACCURA-ARBINI DESIGN ORDUP INC. IS NOT RESPONSIBLE FOR THE ACCURY OF SURVEY, STRUCTURAL OR ENGINEERING INFORMATION SHOWN THESE DRAWINGS OR FOR CONSTRUCTION STARTED PRIOR TO THE SSUANCE OF A BUILDING PERMIT. REFER TO THE APPROPRIATE ENGINEERING DRAWINGS BEFORE PROCEEDING WITH WORK. AS CONSTRUCTED INVERTS MUST BE VERIFIED PRIOR TO POURING

JARDIN DESIGN GROUP INC. HAS NOT BEEN RETAINED TO CARRY OUT GENERAL REVIEW OF THE WORK AND ASSUMES NO RESPONSIBILITY FOR THE FALIURE OF THE CONTRACTOR OR SUB CONTRACTOR TO CARRY OUT THE WORK IN ACCORDANCE WITH THE CONTRACT

THIS DRAWING IS AN INSTRUMENT OF SERVICE. IS PROVIDED BY AND I HE PROPERTY OF JARDIN DESIGN GROUP INC. THIS DRAWING IS NOT BE SCALED.

_′		
6		
5		
4	AUG. 31, 2022	ISSUED FOR BUILDING PERMIT
3	AUG. 29, 2022	COORDINATED FLOOR, ROOF AN ENGINEER COMMENTS
2	JUN. 20, 2022	PREPARED TO PRE-COORDINATION STAGE & ISSUED TO CLIENT
1	MAR. 28, 2022	ISSUED TO CLIENT FOR BROCHU

DATE: WORK DESCRIPTION:



VAUGHAN ONT, L4K 3P3 TEL: 905 660-3377 FAX: 905 660-3713 EMAIL: info@jardindesign.ca

The undersigned has reviewed and takes responsibility for this design and has the qualifications and meets the requirements set out in the Ontario Building Code to be a designer

QUALIFICATION NFORMATION

Walter Botter NAME

REGISTRATION INFORMATION Required unless design is exempt under Division C, Subsection 3.2.4 of the building code

iardin design group inc.

It is the builder's complete responsibility to ensure that all plans submitted for approva fully comply with the Architectural Guidelines and all applicable regulations and requirements including zoning provisions and any provisions in the subdivision agreement. The Contro Architect is not responsible in any way for examining or approving site (Idition) plans or

examining or approving site (lotting) plans of working drawings with respect to any zoning of building code or permit matter or that anhouse can be properly built or located on its lo

This is to certify that these plans comply

with the applicable Architectural Desig Guidelines approved by the City of CAMBRIDGE.

JOHN G. WILLIAMS LTD., ARCHITECT

DATE: OCT 11, 2022

This stamp certifies compliance with the applicab Design Guidelines only and bears no further professional responsibility.

APPROVED BY: _

IRM NAME


FRONT ELEVATION 1

BARLASSINA CONSTRUCTION CITY OF CAMBRIDGE



CHERRY 2 SCALE: 3/16"=1'-0" ROJ. No.

21-35

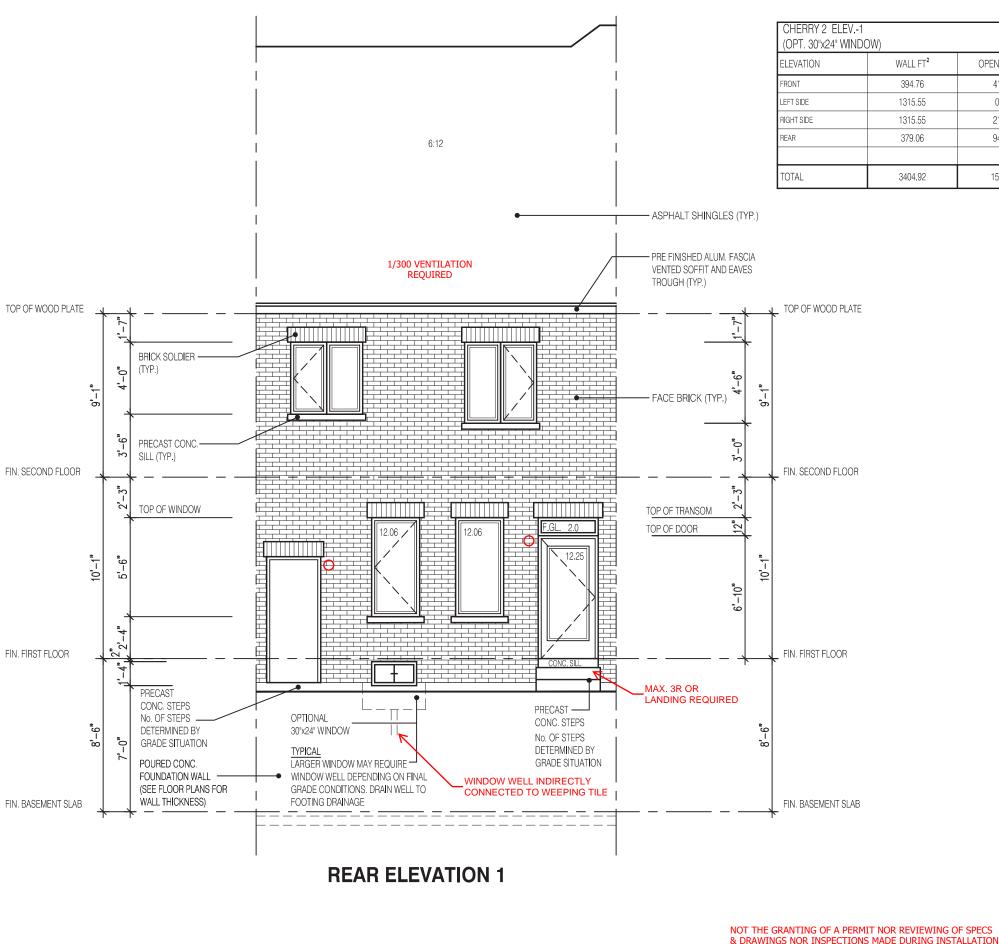

ENERGY EFFICIENCY-SB12 OPENING FT² PERCENTAGE 41.35 10.47 % 0.00 0.00 % 21.00 1.60 % 94.44 24.91 % 4.60 % 156.79

> It is the builder's complete responsibility ensure that all plans submitted for approva fully comply with the Architectural Guidelines and all applicable regulations and requirement including zoning provisions and any provisions in the subdivision agreement. The Contro Architect is not responsible in any way fo examipion or approving site (Intrino plans or examining or approving site (lotting) plans of working drawings with respect to any zoning or building code or permit matter or that an house can be properly built or located on its lo

This is to certify that these plans compl with the applicable Architectural Desig Guidelines approved by the City of CAMBRIDGE.

JOHN G. WILLIAMS LTD., ARCHITECT ARCHITECTURAL CONTROL REVIEW AND APPROVAL APPROVED BY: DATE: OCT 11, 2022

BY THE OFFICIAL HAVING JURISDICTION SHALL RELIEVE THE OWNER FROM REQUIREMENTS OF THE ONTARIO BUILDING

CODE AND ANY OTHER REFERENCED REQUIREMENTS.

This stamp certifies compliance with the applicable Design Guidelines only and bears no further professional responsibility.

2030

6.10m LOTS

CHERRY 2 (GR) **ELEVATION 1**

A1 PACKAGE

O.REG. 332/12

ONDITIONS ON SITE BEFORE PROCEEDING WITH CONSTRUCTION. Y DISCREPANCIES SHALL BE REPORTED TO JARDIN DESIGN GROUI INC. PRIOR TO COMMENCEMENT OF WORK.

JARDIN DESIGN GROUP INC. IS NOT RESPONSIBLE FOR THE ACCURA-ARBINI DESIGN ORDUP INC. IS NOT RESPONSIBLE FOR THE ACCURY OF SURVEY, STRUCTURAL OR ENGINEERING INFORMATION SHOWN THESE DRAWINGS OR FOR CONSTRUCTION STARTED PRIOR TO THE SSUANCE OF A BUILDING PERMIT. REFER TO THE APPROPRIATE ENGINEERING DRAWINGS BEFORE PROCEEDING WITH WORK. AS CONSTRUCTED INVERTS MUST BE VERIFIED PRIOR TO POURING

JARDIN DESIGN GROUP INC. HAS NOT BEEN RETAINED TO CARRY OUT GENERAL REVIEW OF THE WORK AND ASSUMES NO RESPONSIBILITY FOR THE FALIURE OF THE CONTRACTOR OR SUB CONTRACTOR TO CARRY OUT THE WORK IN ACCORDANCE WITH THE CONTRACT

THIS DRAWING IS AN INSTRUMENT OF SERVICE. IS PROVIDED BY AND IS THE PROPERTY OF JARDIN DESIGN GROUP INC. THIS DRAWING IS N TO BE SCALED.

/		
6		
5		
4	AUG. 31, 2022	ISSUED FOR BUILDING PERMIT
3	AUG. 29, 2022	COORDINATED FLOOR, ROOF AND ENGINEER COMMENTS
2	JUN. 20, 2022	PREPARED TO PRE-COORDINATION STAGE & ISSUED TO CLIENT
1	MAR. 28, 2022	ISSUED TO CLIENT FOR BROCHURE

WORK DESCRIPTION:

DATE:

64 JARDIN DR. SUITE 3A

VAUGHAN ONT, L4K 3P3 TEL: 905 660-3377 FAX: 905 660-3713 EMAIL: info@jardindesian.ca

The undersigned has reviewed and takes responsibility for this design and has the qualifications and meets the requirements set out in the Ontario Building Code to be a designer

QUALIFICATION NFORMATION

Walter Botter NAME

REGISTRATION INFORMATION Required unless design is exempt under Division C, Subsection 3.2.4 of the building code

iardin design group inc. IRM NAME


REAR ELEVATION 1

BARLASSINA CONSTRUCTION CITY OF CAMBRIDGE



CHERRY 2 SCALE:

3/16"=1'-0" ROJ. No.

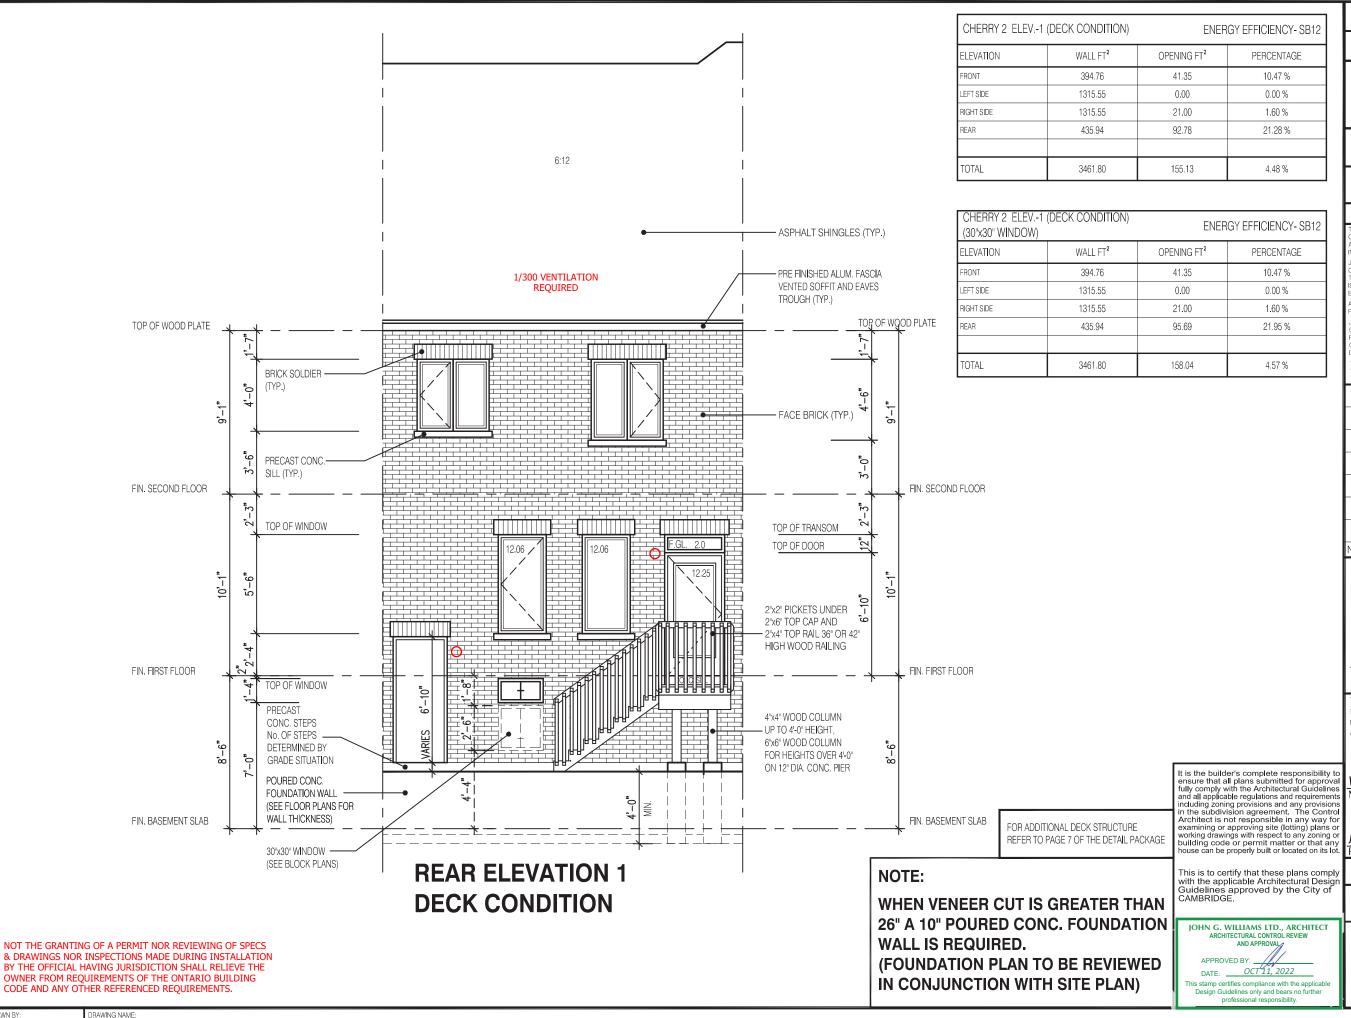

2030

6.10m LOTS

CHERRY 2 (GR) **ELEVATION 1**

A1 PACKAGE

O.REG. 332/12

NOTIONS ON SITE BEFORE PROCEEDING WITH

ARDIN DESIGN GROUP INC. IS NOT RESPONSIBLE FOR THE ACCURACY OF SURVEY, STRUCTURAL OR ENGINEERING INFORMATION SHOWN ON HESE DRAWINGS OR FOR CONSTRUCTION STARTED PRIOR TO THE SUANCE OF A BUILDING PERMIT. REFER TO THE APPROPRIATE NGINEERING DRAWINGS BEFORE PROCEEDING WITH WORK

S CONSTRUCTED INVERTS MUST BE VERIFIED PRIOR TO POURING

JARDIN DESIGN GROUP INC. HAS NOT BEEN RETAINED TO CARRY OL GENERAL REVIEW OF THE WORK AND ASSUMES NO RESPONSIBILITY FOR THE FAILURE OF THE CONTRACTOR OR SUB CONTRACTOR TO BRY OUT THE WORK IN ACCORDANCE WITH THE CONTRACT

THIS DRAWING IS AN INSTRUMENT OF SERVICE, IS PROVIDED BY AND THE PROPERTY OF JARDIN DESIGN GROUP INC. THIS DRAWING IS NO TO BE SCALED.

7		
6		
5		
4	AUG. 31, 2022	ISSUED FOR BUILDING PERMIT
3	AUG. 29, 2022	COORDINATED FLOOR, ROOF AND ENGINEER COMMENTS
2	JUN. 20, 2022	PREPARED TO PRE-COORDINATION STAGE & ISSUED TO CLIENT
1	MAR. 28, 2022	ISSUED TO CLIENT FOR BROCHURE
NIa.	DATE.	WORK DECORPTION.

DESIGN GROUP INC

64 JARDIN DR. SUITE 3A VAUGHAN ONT. L4K 3P3 TEL: 905 660-3377 FAX: 905 660-371 EMAIL: info@jardindesign.ca

The undersigned has reviewed and takes responsibility for this design and has the qualifications and meets the requirements set out in the Ontario Building Code to be a designer

OUALIFICATION INFORMATION Required unless design is exe 3.2.5 of

Walter Bottei

Required unless design is exempt under Division C. Subsectio 3.2.4 of the building code


jardin design group inc. FIRM NAM

BARLASSINA CONSTRUCTION CITY OF CAMBRIDGE



CHERRY 2 3/16"=1'-0"

DWG. No 21-35

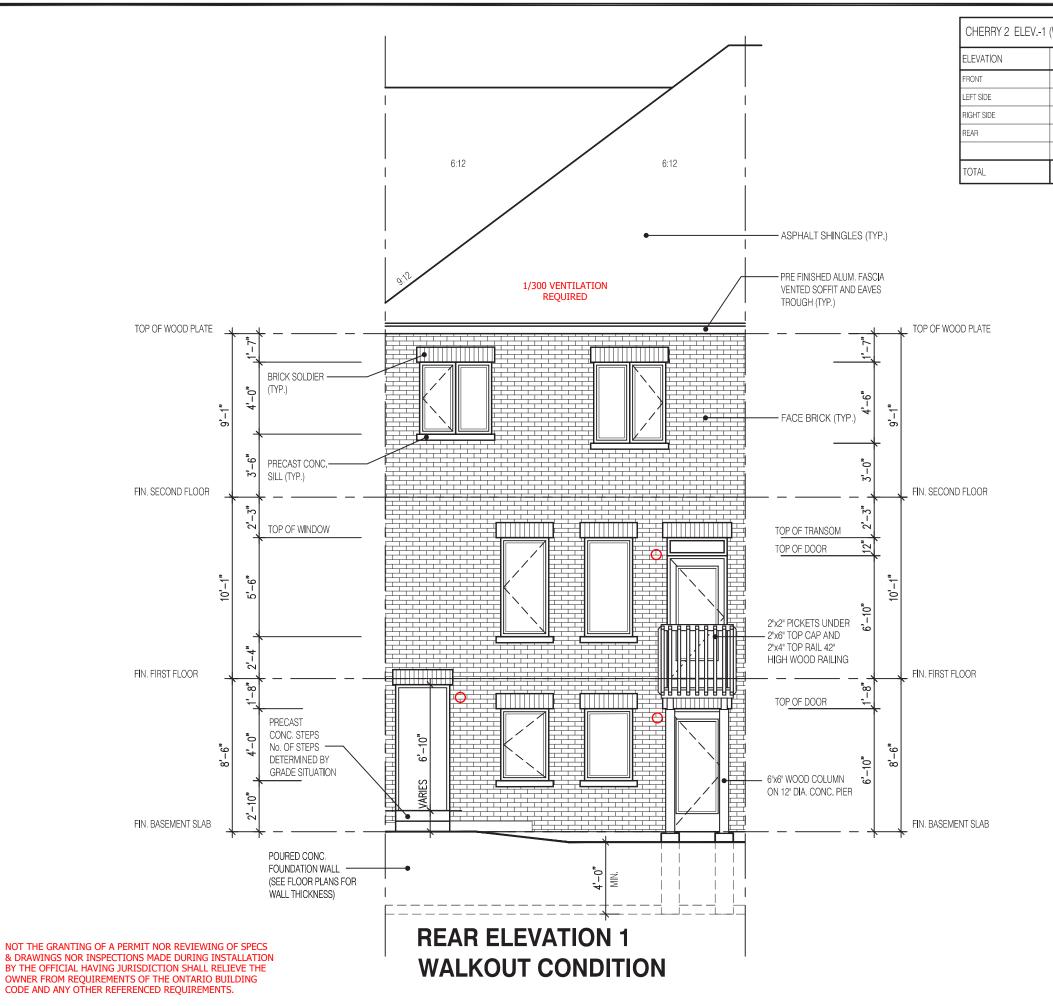

CHERRY 2 ELEV.-1 (WALKOUT) **ENERGY EFFICIENCY- SB12** WALL FT² OPENING FT² 394.76 41.35 10.47 % 1315.55 0.00 0.00 % 1315.55 21.00 1.60 % 494.61 133.42 26.97 % 3520.47 195.77 5.56 %

> It is the builder's complete responsibility to ensure that all plans submitted for approval fully comply with the Architectural Guidelines and all applicable regulations and requirements including zoning provisions and any provisions in the subdivision agreement. The Control Architect is not responsible in any way for examining or approving site (lotting) plans or working drawings with respect to any zoning or working drawings with respect to any zoning or building code or permit matter or that any house can be properly built or located on its lot.

This is to certify that these plans comply with the applicable Architectural Design Guidelines approved by the City of CAMBRIDGE.

JOHN G. WILLIAMS LTD., ARCHITECT ARCHITECTURAL CONTROL REVIEW APPROVED BY:

Design Guidelines only and bears no further

2030

6.10m LOTS

CHERRY 2 (GR) **ELEVATION 1**

A1 PACKAGE

O.REG. 332/12

ONDITIONS ON SITE BEFORE PROCEEDING WITH CONSTRUCTION

JARDIN DESIGN GROUP INC. IS NOT RESPONSIBLE FOR THE ACCURAC OF SURVEY, STRUCTURAL OR ENGINEERING INFORMATION SHOWN OF THESE DRAWINGS OR FOR CONSTRUCTION STARTED PRIOR TO THE SUANCE OF A BUILDING PERMIT. REFER TO THE APPROPRIATE NGINEERING DRAWINGS BEFORE PROCEEDING WITH WORK.

AS CONSTRUCTED INVERTS MUST BE VERIFIED PRIOR TO POURING

IARDIN DESIGN GROUP INC. HAS NOT BEEN RETAINED TO CARRY OU GENERAL REVIEW OF THE WORK AND ASSUMES NO RESPONSIBILITY FOR THE FAILURE OF THE CONTRACTOR OR SUB CONTRACTOR TO ARRY OUT THE WORK IN ACCORDANCE WITH THE CONTRACT DOCUMENTS.

THIS DRAWING IS AN INSTRUMENT OF SERVICE. IS PROVIDED BY AND THE PROPERTY OF JARDIN DESIGN GROUP INC. THIS DRAWING IS NO

AUG. 31, 2022 | ISSUED FOR BUILDING PERMIT COORDINATED FLOOR, ROOF AND ENGINEER COMMENTS REPARED TO PRE-COORDINATION JUN. 20, 2022 STAGE & ISSUED TO CLIENT MAR. 28, 2022 ISSUED TO CLIENT FOR BROCHURE

DESIGN GROUP INC

WORK DESCRIPTION:

64 JARDIN DR. SUITE 3A VAUGHAN ONT. L4K 3P3 TEL: 905 660-3377 FAX: 905 660-3713 EMAIL: info@jardindesign.ca

The undersigned has reviewed and takes responsibility for this design and has the qualifications and meets the requirements set out in the Ontario Building Code to be a designer OUALIFICATION INFORMATION

3.2.5 of

Walter Botter NAME

REGISTRATION INFORMATION Required unless design is exempt under Division C, Subsection 3.2.4 of the building code

jardin design group inc. FIRM NAME

REAR WALKOUT EL-1

BARLASSINA CONSTRUCTION CITY OF CAMBRIDGE



CHERRY 2 3/16"=1'-0"

21-35

