


DRAWING NAME: --

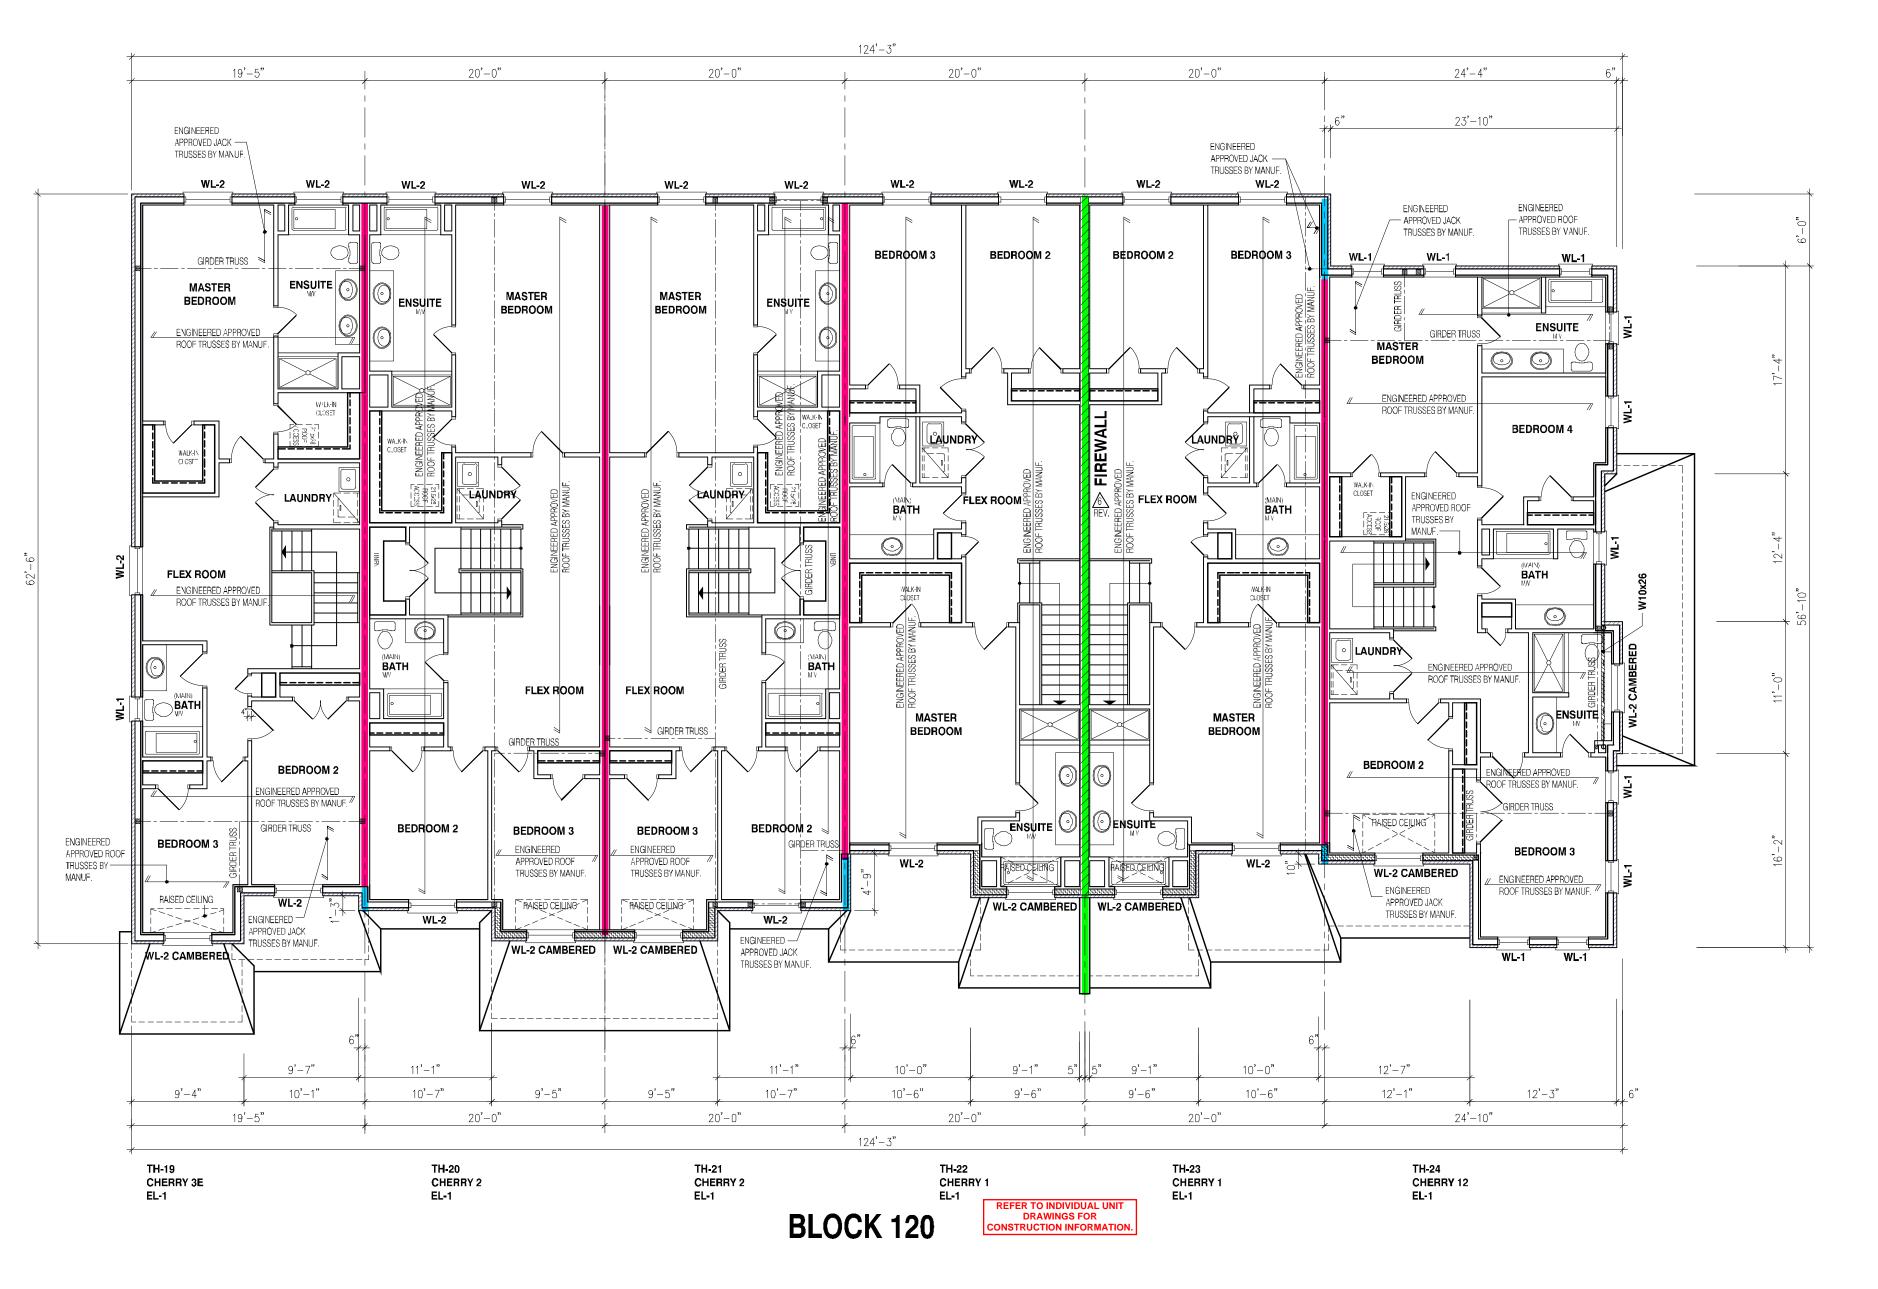

6.10m TOWNS **CHERRY MODELS** TH-19 TO TH-24





FOR STRUCTURE ONLY

IF CONTRACTOR SHALL CHECK AND VERIFY ALL DIMENSIONS AND CONDITIONS ON SI FORE FROCEEDING WITH CONSTRUCTION. ANY DISCREPANCIES SHALL BE REPORTE RDIN DESIGN GROUP INC. PRIOR TO COMMENCEMENT OF MOTIK. PRDIN DESIGN GROUP INCLISING PRESPONSIBLE FOR IT TE ACCUPACY OF SURVEY TRUCTURAL OR ENCINFERING INFORMATION SHOWN ON THESE DRAWINGS OR FO ONSTRUCTION STAFFLED FRIGHT (IT IS SUANCE OF A BUILDING 2-BMT.). HEHER PROGRAME FINGIN-FRING DRAWINGS REPORT PROCFEDING WITH WORK. CONSTRUCTED INVERTS MUST BE VERIFIED PRIOR TO POURING FOOTINGS.

ARDIN DESIGN CROUP INC. HAS NOT BEEN BETAINED TO CARRY OUT GENERAL RENIE HE WORK AND ASSUMES NO RESPONSIBILLY OR HELFALLALLAL OF HEL CONTRACTORY BUR CONTRACTOR TO CARRY OUT THE MORK IN ACCORDANCE WITH THE CONTRACT

IIS DRAWING IS AN INSTRUMENT OF SERVICE, IS PROVIDED BY AND IS THE PROPER HON DESIGN GHOUP INC. IT IIS DRAWING IS NOT TO BE SCALED.

REV. AS PER CITY COMMENTS JAN. 5, 2023 REISSUED FOR PERMIT AUG. 31, 2022 ISSUED FOR BUILDING PERMIT OORDINATED FLOOR, ROOF AND ENGINEEI AUG. 29, 2022 COMMENTS PREPARED TO PRE-COORDINATION STAGE 8 JUN. 20, 2022 ISSUED TO CLIENT MAR. 28, 2022 ISSUED TO CLIENT FOR BROCHURE

WORK DESCRIPTION:

MAR. 8, 2022 PREPARED AND ISSUED TO CLIENT FOR A.C. PRELIMINARY REVIEW

64 Jardin dr. Suite 3A VAUGHAN ONT. L4K 3P3 TEL: 905 660-3377 FAX: 905 660-3713 EMAIL: info@jardindesign.ca

The undersigned has reviewed and takes responsibility for this design and has the qualifications and meets the requirements set out in the Ontario Building Code to be a designer QUALIFICATION INFORMATION

Required unless design is exempt under Division C, Subsection

3.2.5 of the building code

Natter Botter SIGNATURE BC

REGISTRATION INFORMATION Walter Botter Required unless design is exempt under Division C, Subsection

jardin design group inc. FIRM NAME

SECOND FLOOR PLAN ELEV-1

BARLASSINA CONSTRUCTION

CAMBRIDGE, ONTARIO

----1/8"=1'-0" **BILD** 3 21-35

NOTE: NOT THE GRANTING OF A PERMIT NOR REVIEWING OF SPECS BY THE OFFICIAL HAVING JURISDICTION SHALL RELIEVE THE OWNER FROM REQUIREMENTS OF THE ONTARIO BUILDING

CODE AND ANY OTHER REFERENCED REQUIREMENTS.

REFER TO INDIVIDUAL PLANS FOR STANDARD WOOD, STEEL BEAMS AND LINTELS OVER WINDOWS

APPROVED ROOF TRUSS DRAWINGS BY

NOTE:

L3 = 5" x 3 1\2" x 5\16' (125 x 90 x 8) L4 = 6" x 3 1\2" x 3\8" (150 x 90 x 10) L5 - 6" x 4" x 3\8" (150 x 100 x 10) 6 = 7" x 4" x 3\8" (180 x 100 x 10) THESE DRAWINGS ARE TO BE READ IN CONJUNCTION WITH ENGINEER

STEEL LINTELS:

 $WL1 = 3 \frac{1}{2} \times 3 \frac{1}{2} \times 1\frac{4}{90x90x6} - 2 \cdot 2 \times 8 \text{ SPR}.$ $L1 = 3 \frac{1}{2} \times 3 \frac{1}{2} \times \frac{1}{4} (90 \times 90 \times 6)$ $WL2 = 4' \times 3 \ 1\ 2' \times 5\ 16'' (100\times90\times8) + 2 - 2' \times 8' SPR.$ 2 = 4" x 3 1\2" x 5\16' (100 x 90 x 8)

WL3 = 5' x 3 1\2' x 5\16" (125x90x8) + 2- 2' x 10" SPR. $WL4 = 6' \times 3 \text{ 1}\2' \times 3\8' (150x90x10) + 2-2' \times 12'' \text{ SPR}.$ WL5 - 6' x 4" x 3\8' (150x100x10) + 2-2' x 12" SPR. WL6 = 5' x 3 1\2' x 5\16" (125x90x8) + 2-2' x 12" SPR. $VL7 = 5' \times 3 \, 1\2' \times 5\16'' (125\times90\times8) + 3-2' \times 10'' \, SPR.$ $WL8 = 5' \times 3 \frac{1}{2}' \times \frac{5}{16} (125x90x8) + 3-2' \times 12'' SPR.$

BRICK VENEER LINTELS:

WB5 = 2-2" x 12" SPRUCE BEAM WB6 - 3-2" x 12' SPRUCE BEAM WB7 = 5-2" x 12' SPRUCE BEAM WB10 = 4-2" x 8" SPRUCE BEAM WB11 = 4-2" x 10" SPRUCE BEAM $WL9 = 6' \times 4'' \times 3 \times (150 \times 100 \times 10) + 3 - 2' \times 12'' SPR.$ WB12 = 4-2" x 12" SPRUCE BEAM _SL = TIMBERSTRAND BOARD

WOOD LINTELS:

WB1 - 2-2" x 8" SPRUCE BEAM

WB2 = $3-2" \times 8"$ SPRUCE BEAM

WB3 = 2-2" x 10" SPRUCE BEAM

WB4 = 3-2" x 10' SPRUCE BEAM



