STRIP FOOTINGS FOR SINGLES AND SEMIS UP TO 2 STOREY

P.ENG SOILS REPORT IS REQ'D TO CONFIRM BEARING CAPACITY OF SOILS. SEE FIELD INSPECTOR

120 KPa NATIVE SOIL

20'x6" CONCRETE STRIP FOOTINGS BELOW FOUNDATION WALLS. 24 x8" CONCRETE STRIP FOOTINGS BELOW PARTY WALLS.

90 KPa ENGINEERED FILL SOIL

24'x8" CONCRETE STRIP FOOTINGS WITH REINFORCING BELOW FOUNDATION WALLS, 30'x8" CONCRETE STRIP FOOTINGS WITH REINFORCING BELOW PARTY WALLS.

100 KPa NATIVE SOIL

22'x8' CONCRETE STRIP FOOTINGS BELOW FOUNDATION WALLS. 28"x10" CONCRETE STRIP FOOTINGS BELOW PARTY WALLS 28'x8' CONCRETE STRIP FOOTINGS WITH REINFORCING BELOW PARTY WALLS

GENERAL NOTE

ASSUMED 120/100 KPa NATIVE SOIL BEARING CAPACITY OR 90 KPa FOR ENGINEERED FILL. TO BE VERIFIED ON SITE, REFER TO ENGINEERED FILL FOOTING DETAIL FOR REINFORCEMENT.

(REFER TO ENG. FILL FOOTING DETAIL)

AREA CALCULATIONS EL-1

FIRST FLOOR AREA 1088 Sq. Ft. SECOND FLOOR AREA = 1312 Sq. Ft. TOTAL FLOOR AREA = 2400 Sq. Ft. ADD OPEN AREAS 0 Sq. Ft ADD FIN. BASEMENT AREA 0 Sq. Ft.

= 2400 sg. Ft. GROSS FLOOR AREA GROUND FLOOR COVERAGE = 1088 Sq. Ft. GARAGE COVERAGE / AREA = 242 Sa. Ft

62 Sq. Ft. PORCH COVERAGE / AREA = 1392 Sq. Ft. COVERAGE W/ PORCH = 129.32 Sa. m.

= 1330 Sq. Ft. COVERAGE W/O PORCH = 123.56 Sq. m.

3 BEDROOM

ELEVATION

FRONT

LEFT SIDE

RIGHT SIDE

TOTAL

OF SB-12, MAX U-1.6, FR-25

AND STORAGE AREAS, SHALL CONSIST OF

CONCRETE, TILE, OR OTHER FLOORING

DISHWASHERS AND CLOTHES WASHERS

SECTION 9.27 OF DIVISION B OR HAVE A COM

OR BMEC APPROVAL, OR A MINISTERS RULING

A SEPARATE PERMIT IS REQUIRED FOR THE

FINISHING OF ALL ROUGHIN PLUBMING FIXTURES

91.50

OPENING FT¹

82.33

91.50

0.00

121.27

295.10

HE ONTARIO BUILDING CODE REQUIRES THAT A SMOKE ALARM BE INSTALLE

ON EACH FLOOR LEVEL AND WITHIN EACH SLEEPING ROOM. ALL SMOKE

ALARMS SHALL BE INTERCONNECTED. EACH DEVICE SHALL HAVE A VISUAL SIGNALING COMPONENT IN ADDITION TO THE TEMPORAL PATTERN IN CONFORMANCE WITH 18.5.3. OF "LIGHT, COLOUR AND PULSE

IN KITCHENS, WASHROOMS, LAUN

AREA CALCULATIONS EL-2 AREA CALCULATIONS EL-3

WALL FT²

523.40

1216.65

1196,36

494,79

3431.20

WALL FT²

515.13

1249,09

1202.22

494,79

3461.23

WALL FT2

515,06

1222.07

1198,54

494,79

3428.46

FIRST FLOOR AREA 1088 Sq. Ft. FIRST FLOOR AREA = 1088 Sq. Ft. SECOND FLOOR AREA = 1312 Sq. Ft. SECOND FLOOR AREA = 1327 Sq. Ft. TOTAL FLOOR AREA 2400 Sq. Ft. TOTAL FLOOR AREA = 2415 Sq. Ft. ADD OPEN AREAS ADD OPEN AREAS 0 Sq. Ft. ADD FIN. BA\$EMENT AREA 0 Sq. Ft. ADD FIN, BASEMENT AREA = 2400 Sq. Ft. = 2415 Sq. Ft. GROSS FLOOR AREA GROSS FLOOR AREA

GROUND FLOOR COVERAGE = 1088 Sq. Ft. GROUND FLOOR COVERAGE = GARAGE COVERAGE / AREA = 242 Sq. Ft. GARAGE COVERAGE / AREA = 241 Sq. Ft. PORCH COVERAGE / AREA PORCH COVERAGE / AREA 62 Sq. Ft. = 1391 Sq. Ft. = 1392 Sq. Ft. COVERAGE W/ PORCH COVERAGE W/ PORCH = 129.23 Sq. m.

= 129.32 Sq. m. = 1330 Sq. Ft. COVERAGE W/O PORCH COVERAGE W/O PORCH = 123,56 Sq. m.

CERTIFIED VALUES SHALL REMAIN ON

FOR REVIEW DURING CONSTRUCTION

BEFORE FINAL INSPECTION SIGN-OFF

P.ENG SOILS REPORT MAY BE REQ'D T CONFIRM BEARING CAPACITY OF

NSTALLATION OF FLUSH STEEL BEAM

9.23.9.2.(3), (4) & (5)

OVIDE P.ENG APPROVED

DRAWINGS AND SPECIFICATIONS TO BUILDING

RIGHT SIDE

OTAL

RONT

REAR

TOTAL

LEFT SIDE

RIGHT SIDE

ALT, 4 BEDROOM

LEVATION

INSPECTOR AT FRAMING INSPECTION

NFORCING REQUIRED IN FOUNDA WALL OR PORCH SLAB SHALL BE

REVIEWED PRIOR TO POURING CONR

GARDEN 3 (GR) 0 Sq. Ft. **ELEVATION 1, 2 & 3** 0 Sq. Ft. 1088 Sa. Ft

62 Sq. Ft.

PERCENTAGE

15,90 %

8,40 %

0.00%

8.94 %

PERCENTAGE

16.31 %

8.18 %

0.00%

24.51 %

8.88 %

PERCENTAGE

15.98 %

8.36 %

0.00 %

24.51 %

8.92 %

= 1329 Sq. Ft.

 $= 123.47 \, \text{Sq. m.}$

ENERGY EFFICIENCY- A1 PACKA

ENERGY EFFICIENCY- A1 PACKAG

ENERGY EFFICIENCY- A1 PACKAG

OPENING FT2

83.24

102.14

0.00

121,27

306.65

OPENING FT²

84.00

102,14

0.00

121.27

307.41

OPENING FT

82.33

102.14

0.00

121.27

305.74

CITY OF CAMBRIDGE

BUILDING DIVISION

O.REG. 332/12

HE CONTRACTOR SHALL CHECK AND VERIFY ALL DIVENSIONS AND CONDITIONS ON SITE BEFORE PROCEEDING WITH CONSTRUCTION. / DISCREPANCIES SHALL BE REPORTED TO JARDIN DESIGN GROU PRIOR TO COMMENCEMENT OF WORK.

2400

9.14m LOTS

A1 PACKAGE

JARDIN DESIGN GROUP INC. IS NOT RESPONSIBLE FOR THE ACCURAC OF SURVEY, STRUCTURAL OR ENGINEERING INFORMATION SHOWN OF HESE DRAWINGS OR FOR CONSTRUCTION STARTED PRIOR TO THE SUANCE OF A BUILDING PERMIT. REFER TO THE APPROPRIATE NGINEERING DRAWINGS BEFORE PROCEEDING WITH WORK. AS CONSTRUCTED INVERTS MUST BE VERIFIED PRIOR TO POURING

JARDIN DESIGN GROUP INC. HAS NOT BEEN RETAINED TO CARRY OL GENERAL REVIEW OF THE WORK AND ASSUMES NO RESPONSIBILITY FOR THE FALLIPE OF THE CONTRACTOR OR SUB CONTRACTOR TO ARRY OUT THE WORK IN ACCORDANCE WITH THE CONTRACT COCUMENTS

THIS DRAWING IS AN INSTRUMENT OF SERVICE. IS PROVIDED BY AND I HE PROPERTY OF JARDIN DESIGN CROUP INC. THIS DRAWING IS NOT DIE SCALED.

E	7		
	6	AUG. 10, 2022	ISSUED FOR BUILDING PERMIT
	5	AUG. 3, 2022	COORDINATED FLOOR, ROOF AND ENGINEER COMMENTS
_	4	JUN. 2, 2022	REVISED AS PER CLIENT COMMENT & RE-ISSUED TO CLIENT
_	3	MAY 10, 2022	PREPARED TO PRE-COORDINATION STAGE & ISSUED TO CLIENT
_	2	MAR. 23, 2022	REVISED AS PER CLIENT & ISSUED FOR BROCHURE
Ε	1	JAN. 26, 2022	ISSUED TO CLIENT FOR

DATE WORK DESCRIPTION:

DESIGN GROUP INC

64 JARDIN DR. SUITE 3A VAUGHAN ONT, L4K 3P3 EL: 905 660-3377 FAX: 905 660-3713 EMAIL: info@iardindesian.ca

he undersigned has reviewed and takes responsibility or this design and has the qualifications and meets the equirements set out in the Ontario Building Code to be

ı designer QUALIFICATION INFORMATION juired unless design is execute under Division C, Subsectio

3.2.5 of t Walter Botter NAME

REGISTRATION INFORMATION

3.2.4 of the building code

Required unless design is exempt under Division C, Subsection

ardin design group inc.

FIRM NAME

BARLASSINA CONSTRUCTION CITY OF CAMBRIDGE



GARDEN 3 (GR) SCALE:

27763

3/16"=1'-0" PROJ. No. WG. No 21-35

PAD FOOTING

120 KPa NATIVE SOI 90 KPa ENGINEERED FILL SOIL 100 KPa NATIVE SOL F1 = 42"x42"x18" CONCRETE PAD F1 = 48'x48"x20" CONCRETE PAD F1 = 46'x46'x20' CONCRETE PAD F2 = 40"x40"x16" CONCRETE PAD F2 = 36"x36"x16" CONCRETE PAD F2 = 38"x38"x16" CONCRETE PAD F3 = 30'x30'x12" CONCRETE PAD F3 = 34"x34"x14" CONCRETE PAD F3 = 32'x32'x14' CONCRETE PAD F4 = 24'x24'x12" CONCRETE PAD F4 = 28"x28"x12" CONCRETE PAD F4 = 26"x26"x12" CONCRETE PAD F5 = 16'x16'x8" CONCRETE PAD F5 = 17"x17"x8" CONCRETE PAD F5 = 18"x18"x8" CONCRETE PAD (REFER TO FLOOR PLAN FOR UNUSUAL SIZE PADS NOT ON CHART

NOTE:

WHEN VENEER CUT IS GREATER THAN 26" A 10" POURED CONC. FOUNDATION WALL IS REQUIRED.

NOTE:

ALL GARAGE SLABS, PORCH SLABS, STAIRS (EXPOSED CONC. FLAT WORK) TO BE 32 MPa WITH 5-8% AIR ENTRAITMENT.

BRICK VENEER LINTELS:

 $WL1 = 3 \frac{1}{2} \times 3 \frac{1}{2} \times 1\frac{4}{90} \times 90 \times 6 + 2 \cdot 2^{n} \times 8^{n} SPR.$ $WL2 = 4'' \times 3 1 \times 15'' \times 15'' \times 100 \times 10$ $WL3 = 5'' \times 3 \times 1/2'' \times 5/16'' \times 125 \times 90 \times 8) + 2 - 2'' \times 10'' \text{ SPR}$ $WL4 = 6" \times 3 \times 1/2" \times 3/8" (150x90x10) + 2-2" \times 12" SPR.$ WL5 = 6" x 4" x 3\8" {150x100x10} + 2-2" x 12" SPR.

 $WL6 = 5'' \times 3 1 \times 15'' \times 15'' \times 12'' \times 12'$ $WL7 = 5" \times 3 \times 12" \times 5 \times 16" \times 125 \times 90 \times 8) + 3 \times 2" \times 10" SPR.$ $WL8 = 5'' \times 3 \frac{1}{2}'' \times \frac{5}{16}'' (125 \times 90 \times 8) + 3 - 2'' \times 12'' SPR$ $WL9 = 6" \times 4" \times 3 \times (150 \times 100 \times 10) + 3 - 2" \times 12" SPR.$

WOOD LINTELS:

WB1 = 2-2"x8" SPRUCE BEAM WB6 = 3-2" x 12" SPRUCE BEAM WB2 = 3-2"x8" SPRUCE BEAM WB7 = 5-2" x 12" SPRUCE BEAM WB10 = 4-2" x 8" SPRUCE BEAM WB3 = 2-2" x 10" SPRUCE BEAM WB4 = 3-2" x 10" SPRUCE BEAM WB11 = 4-2" x 10" SPRUCE BEAM WB5 = 2-2" x 12" SPRUCE BEAM

STEEL LINTELS:

 $L1 = 3.1 \times 3.1 \times 1.14$ (90 x 90 x 6) L4 = 6 x 3.1 \(\text{2"} \text{ x 3\8'} \) (150 x 90 x 10) $L2 = 4^{\circ} \times 3 \times 1/2^{\circ} \times 5/16^{\circ} \times (100 \times 90 \times 8)$ $L5 = 6^{\circ} \times 4^{\circ} \times 3/8^{\circ} \times (150 \times 100 \times 10)$ L3 = 5" x 3 1\2" x 5\16" (125 x 90 x 8) L6 = 7" x 4" x 3\8" (180 x 100 x 10)

LAMINATED VENEER LUMBER (LVL BEAMS)


LVL1A = 1-1 3/4" x 7 1/4" (1-45x184) $LVL1 = 2-13/4" \times 71/4" (2-45x184)$ $LVL2 = 3-13/4" \times 71/4" (3-45\times184)$ $IV|3 = 4-1.3/4" \times 7.1/4" (4-45x184)$ $LVL4A = 1-1 3/4" \times 9 1/2" (1-45x240)$ $LVL4 = 2-1 3/4" \times 9 1/2" (2-45x240)$ $LVL5 = 3-1 3/4" \times 9 1/2" (3-45x240)$ $LVL5A = 4-1 3/4" \times 9 1/2" (4-45x240)$ LVL6A= 1-1 3/4" x 11 7/8" (1-45x300) $LVL6 = 2-1 3/4" \times 11 7/8" (2-45x300)$

 $LVL7 = 3-13/4" \times 117/8" (3-45x300)$

LVL7A= 4-1 3/4" x 11 7/8" (4-45x300) LVL8 = 2-1 3/4" x 14" (2-45x356) LVL9 = 3-1 3/4" x 14" (3-45x356)

NOT THE GRANTING OF A PERMIT NOR REVIEWING OF SPECS & DRAWINGS NOR INSPECTIONS MADE DURING INSTALLATION BY THE OFFICIAL HAVING JURISDICTION SHALL RELIEVE THE OWNER FROM REQUIREMENTS OF THE ONTARIO BUILDING CODE AND ANY OTHER REFERENCED REQUIREMENTS.


2-2"x6" STUD WALL NAILED TOGETHER AND SPACED @12" O.C. FULL HT C/W SOLID BLOCKING 41-0" O.C. VERTICAL AND 7/16" EXT. PLYWOOD SHEATHING.

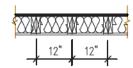

MAXIMUM HEIGHT OF WALL FOR THIS DETAIL IS 18-0" AND MAXIMUM SUPPORTED LENGTH OF TRUSS IS 40'-0"

TWO STOREY HEIGHT WALL

2 - 1 1/2" x 5 1/2" TIMBERSTRAND (LSL) 1.5E STUD WALL GLUED AND NAILED TOGETHER AND SPACED MAX. @10'O.C. FULL HT C/W SOLID BLOCKING MAX. 8'-0"O.C. VERTICAL AND 7/16" EXT. OSB SHEATHING.

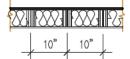

MAXIMUM HEIGHT OF WALL FOR THIS DETAIL IS 20'-2" AND MAXIMUM SUPPORTED LENGTH OF TRUSS IS 40'-0"

TWO STOREY HEIGHT WALL DETAIL

NOTE:

THESE DRAWINGS ARE TO BE READ IN CONJUNCTION WITH ENGINEER APPROVED ROOF TRUSS DRAWINGS BY MANUFACTURER

NOTE:

SPACE CONVENTIONAL FLOOR JOISTS @ 12" O.C. BELOW ALL CERAMIC TILE AREAS, PROVIDE 1 ROW BRIDGING FOR SPANS OF 5'-7', 2 ROWS FOR SPANS GREATER THAN 7'

NOTE:

THESE DRAWINGS ARE TO BE READ IN CONJUNCTION WITH ENGINEER APPROVED FLOOR TRUSS LAYOUT BY MANUFACTURER.

NOTE:

PLANS NOT DRAWN TO ACTUAL GRADE, REFER TO FINAL GRADING PLAN.

MASTER PLAN

WALL FT²

515.06

1222,07

1196.54

494.79

3428.46

10DEL:GARDEN 3 ELEVATION: 3

OPTIONS: (SAME AS ABOVE PLUS), **SUNKEN** FOYER, ALT 2ND FLOOR (4 bedroom), LOOK OUT DECK, WALK OUT DECK/BASEMENT.

	NO.	WIDTH HEIGHT 8' TO 9' CEILINGS		HEIGHT 10' OR MORE CEILINGS		TYPE	
I	1	2 ' -10"	6 <mark>'</mark> -8"	(865x2033)	8 ' -0"	(865x2439)	INSULATED ENTRANCE DOOR
ı	1a	2'-8"	6 '- 8"	(815x2033)	8'-0"	(815x2439)	INSULATED FRONT DOORS
١	2	2'-8"	6'-8"	(815x2033)	8'-0"	(815x2439)	WOOD & GLASS DOOR
ı	3	2'-8"	6'-8 x 1-3/4"	(815x2033x45)	8'-0" x 1-3/4"	(815x2439x45)	EXTERIOR SLAB DOOR
	4	2'-8"	6'-8" x 1-3/8"	(815x2033x35)	8'-0" x 1-3/8"	(815x2439x35)	INTERIOR SLAB DOOR
ı	5	2'-6"	6'-8" x 1-3/8"	(760x2033x35)	8'-0" x 1-3/8"	(760x2439x35)	INTERIOR SLAB DOOR
	6	2'-2"	6'-8" x 1-3/8"	(660x2033x35)	8'-0" x 1-3/8"	(660x2439x35)	INTERIOR SLAB DOOR
	7	1'-6"	6'-8" x 1-3/8"	(460x2033x35)	8'-0" x 1-3/8"	(460x2439x35)	INTERIOR SLAB DOOR
						(+ 1 - + . + + + - 1	

Door Schedule

NO.	WIDIT	TEIGHT 6 I	U 9 CEILINGS	HEIGHT TO OR	WORE CEILINGS	111-6
1	2 ^l -10"	6 ¹ -8"	(865×2033)	8'-0"	(865x2439)	INSULATED ENTRANCE DO
1a	2'-8"	6 ' -8"	(815x2033)	8'-0"	(815x2439)	INSULATED FRONT DOORS
2	2'-8"	6'-8"	(815x2033)	8'-0"	(815x2439)	WOOD & GLASS DOOR
3	2'-8"	6'-8 x 1-3/4"	(815x2033x45)	8 ' -0" x 1-3/4"	(815x2439x45)	EXTERIOR SLAB DOOR
4	2'-8"	6'-8" x 1-3/8"	(815x2033x35)	8'-0" x 1-3/8"	(815x2439x35)	INTERIOR SLAB DOOR
5	2'-6"	6'-8" x 1-3/8"	(760x2033x35)	8'-0" x 1-3/8"	(760x2439x35)	INTERIOR SLAB DOOR
6	2'-2"	6'-8" x 1-3/8"	(660x2033x35)	8'-0" x 1-3/8"	(660x2439x35)	INTERIOR SLAB DOOR
7	1'-6"	6'-8" x 1-3/8"	(460x2033x35)	8'-0" x 1-3/8"	(460x2439x35)	INTERIOR SLAB DOOR
8	3'-0"	6'-8" x 1-3/8"	(915x2033x35)	8'-0" x 1-3/8"	(915x2439x35)	INTERIOR SLAB DOOR

STRUDET INC.

ENERGY EFFICIENCY- A1 PACKAG

PERCENTAGE

15.98 %

7.49 %

0.00 %

24.51 %

8.61 %

B. MARINKOVIC january 16-2022

FOR STRUCTURE ONLY

HESE PLANS have been examined for compliance ith the Ontario Building Code Requirements. A Building Permit is in Order to issue subject to any


hanges noted under the condition that the building wil onstructed in accordance with the code


2023-03-0	
DATE	


It is the builder's complete responsibility to ensure that all plans submitted for approve fully comply with the Architectural Guideline and all applicable regulations and requirement and am application regulations and requirement including zoning provisions and any provision in the subdivision agreement. The Contr Architect is not responsible in any way fe examining or approving site (lotting) plans working drawings with respect to any zoning building code or permit matter or that ar house can be properly built or located on its I


This is to certify that these plans comp with the applicable Architectural Design Guidelines approved by the City of CAMBRIDGE. TITLE SHEE

DRAWING NAME:

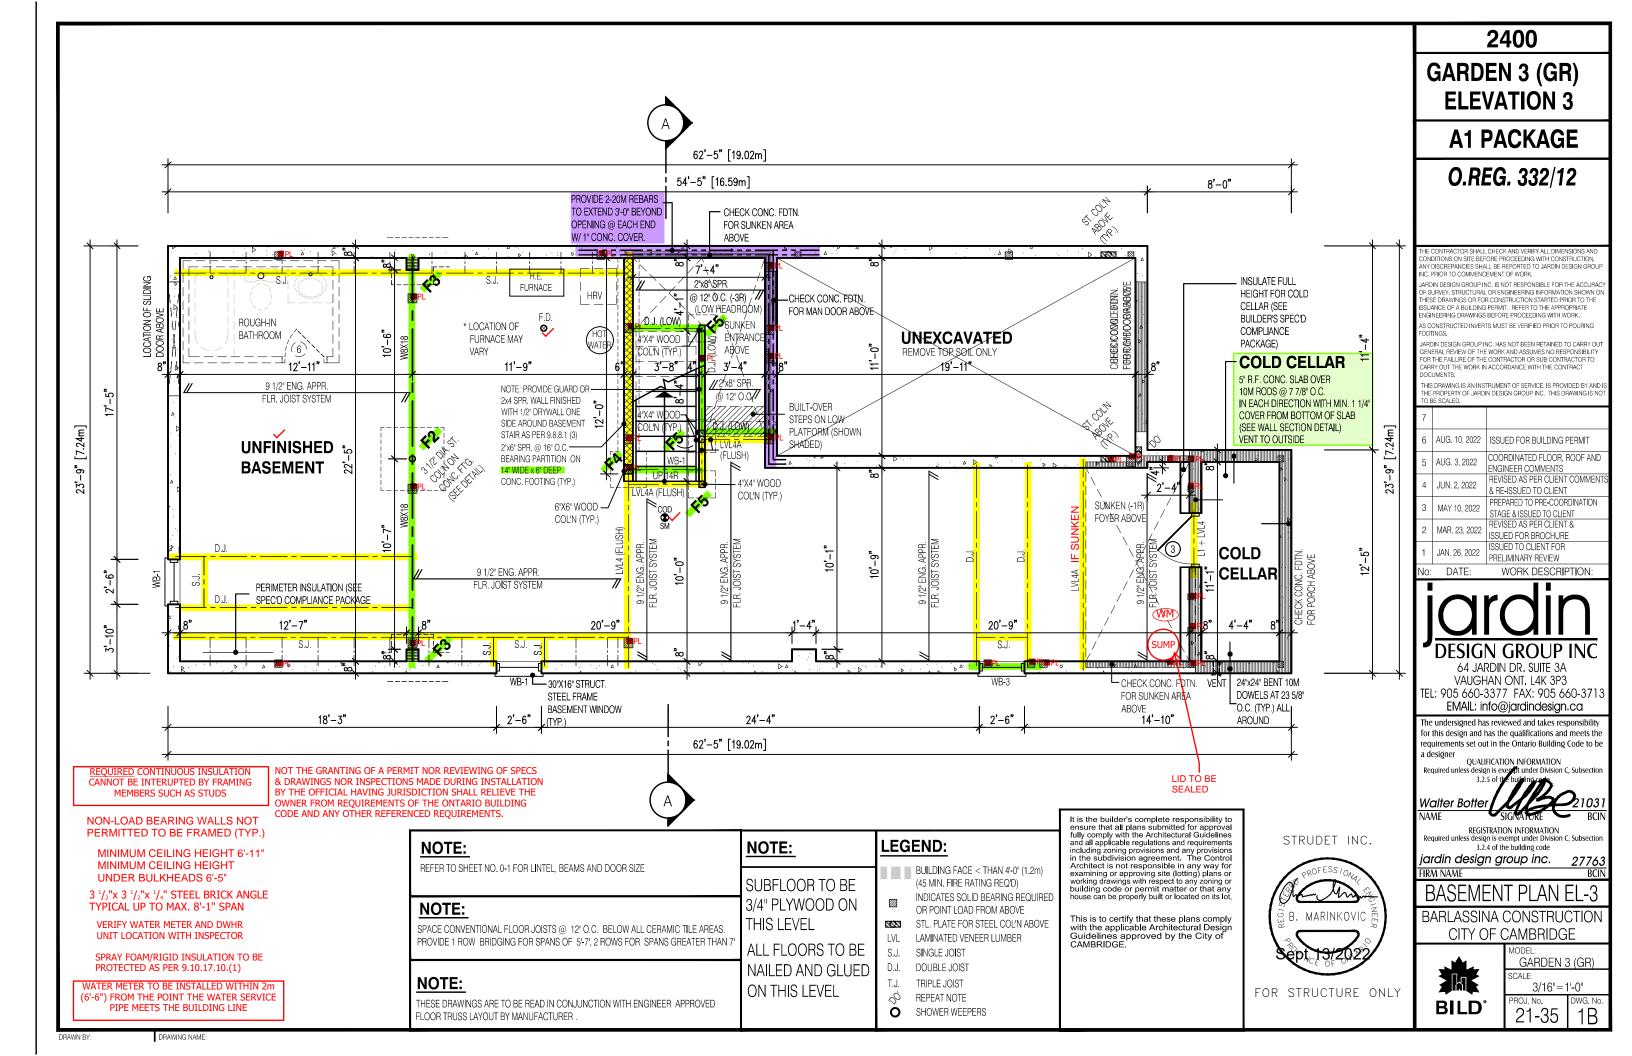

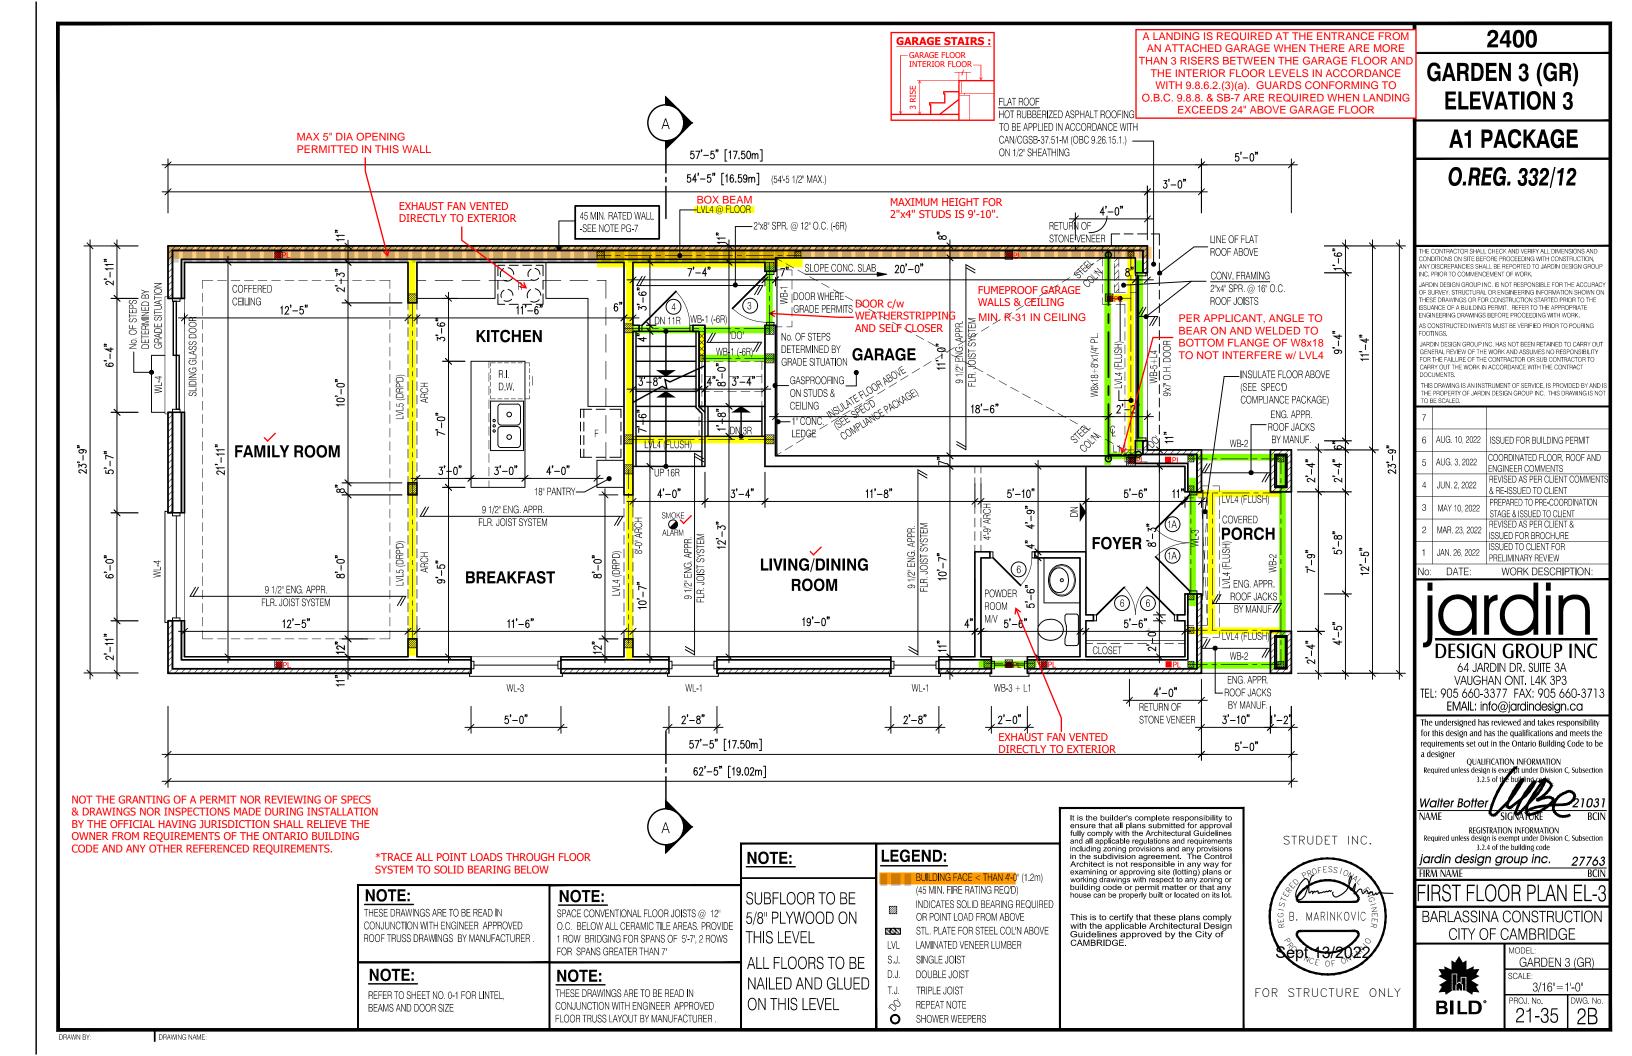

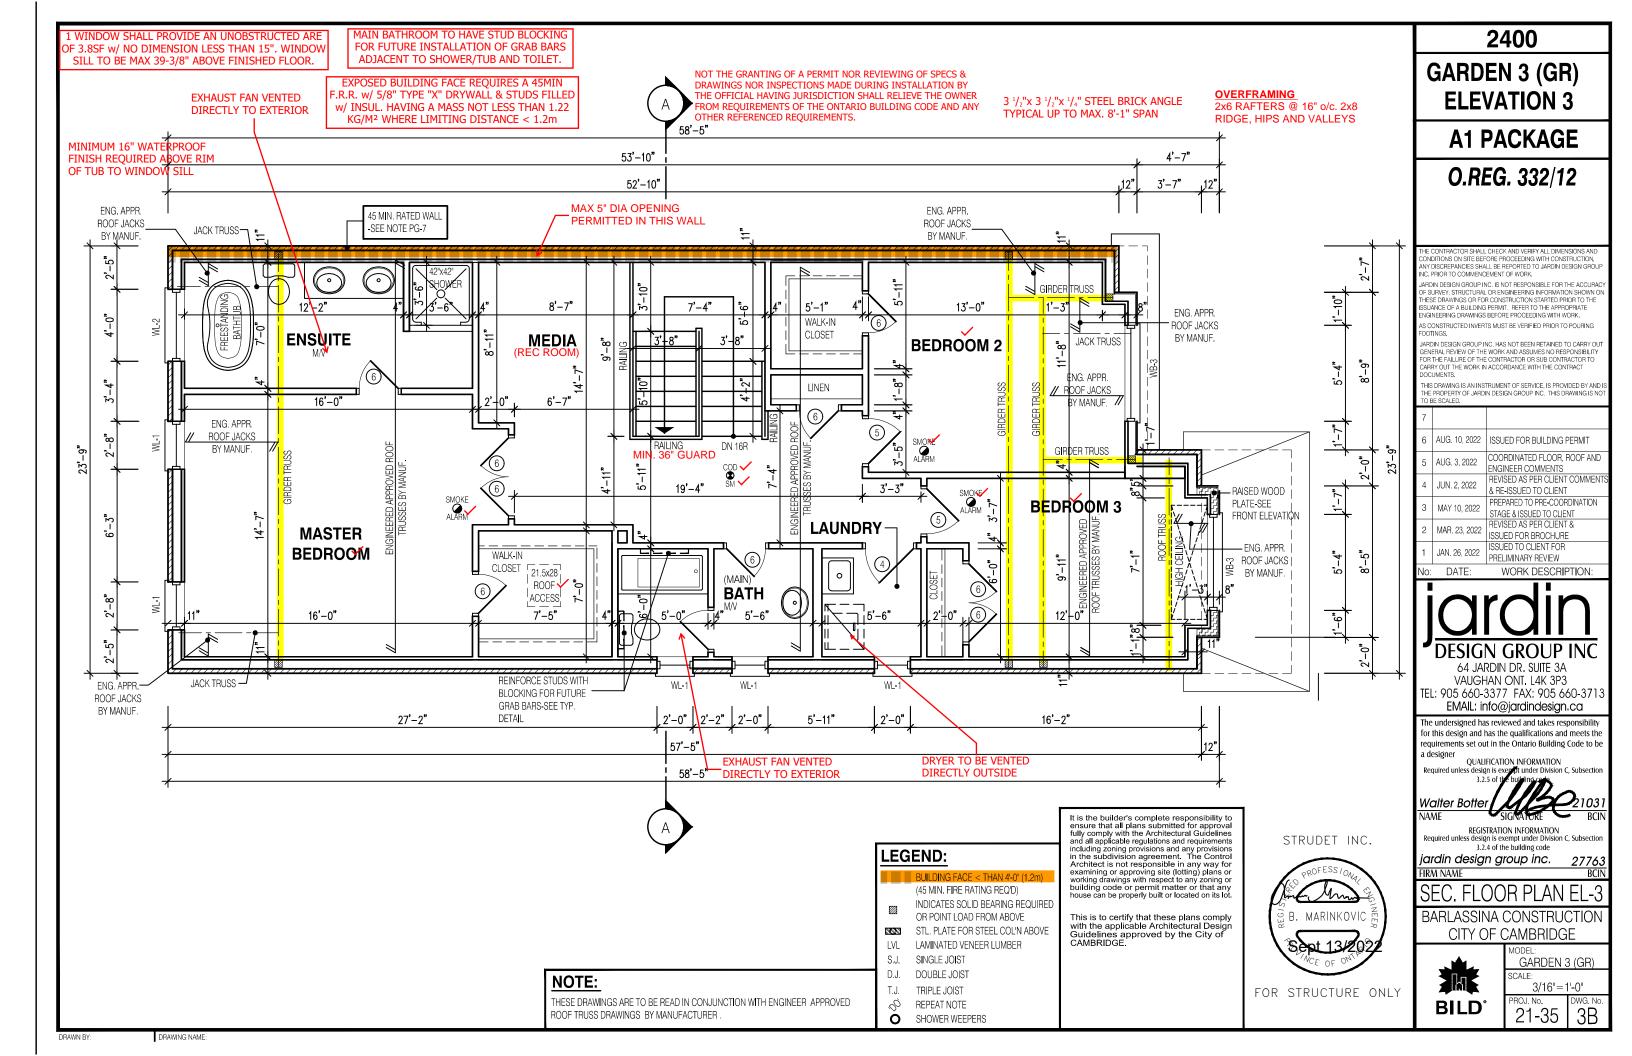

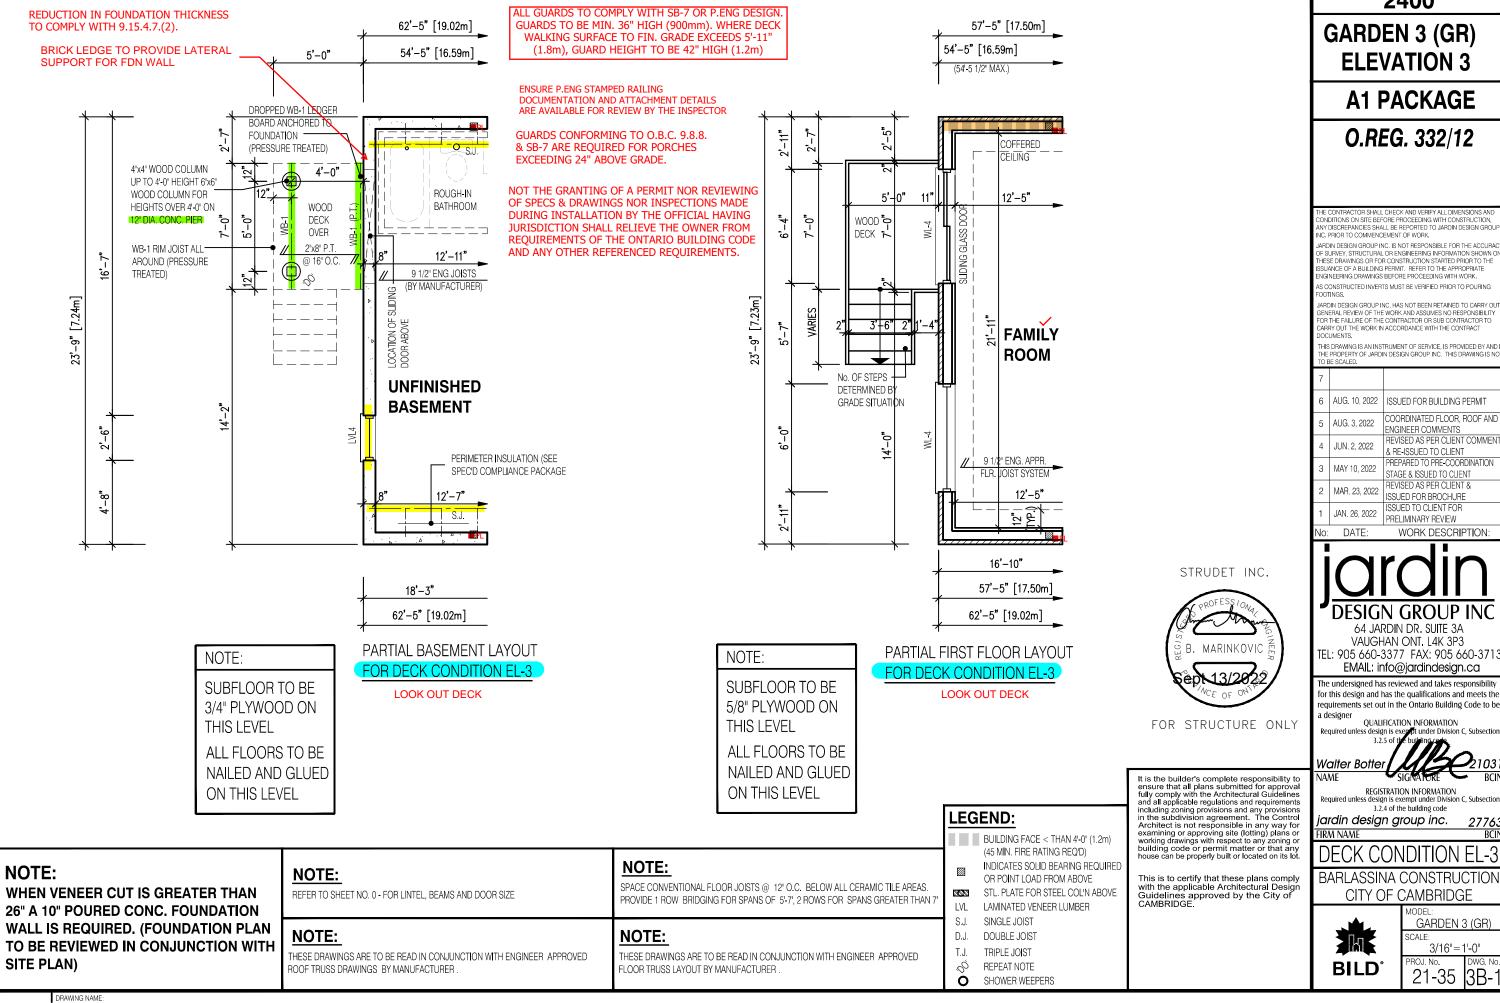

2400

IY DISCREPANCIES SHALL BE REPORTED TO JARDIN DESIGN GROU

OF SURVEY, STRUCTURAL OR ENGINEERING INFORMATION SHOWN THESE DRAWINGS OR FOR CONSTRUCTION STARTED PRIOR TO TH SUANCE OF A BUILDING PERMIT. REFER TO THE APPROPRIATE

HE PROPERTY OF JARDIN DESIGN GROUP INC. THIS DRAWING IS N


5 AUG. 3, 2022 ENGINEER COMMENTS	7		
AUG. 3, 2022 ENGINEER COMMENTS	6	AUG. 10, 2022	ISSUED FOR BUILDING PERMIT
4 JUN. 2, 2022 & RE-ISSUED TO CLIENT 3 MAY 10, 2022 PREPARED TO PRE-COORDINATION STAGE & ISSUED TO CLIENT 2 MAR. 23, 2022 REVISED AS PER CLIENT & ISSUED FOR BROCHURE 1 JAN. 26, 2022 ISSUED TO CLIENT FOR	5	AUG. 3, 2022	COORDINATED FLOOR, ROOF AND ENGINEER COMMENTS
3 MAY 10, 2022 STAGE & ISSUED TO CLIENT	4	JUN. 2, 2022	REVISED AS PER CLIENT COMMEN' & RE-ISSUED TO CLIENT
2 MAR. 23, 2022 ISSUED FOR BROCHURE 1 JAN 26 2022 ISSUED TO CLIENT FOR	3	MAY 10, 2022	
■ 1 IΔN 26 2022 1000000 100000000000000000000000	2	MAR. 23, 2022	
	1	JAN. 26, 2022	

DESIGN GROUP INC

TEL: 905 660-3377 FAX: 905 660-371.

for this design and has the qualifications and meets the requirements set out in the Ontario Building Code to be

GARDEN 3 (GR)

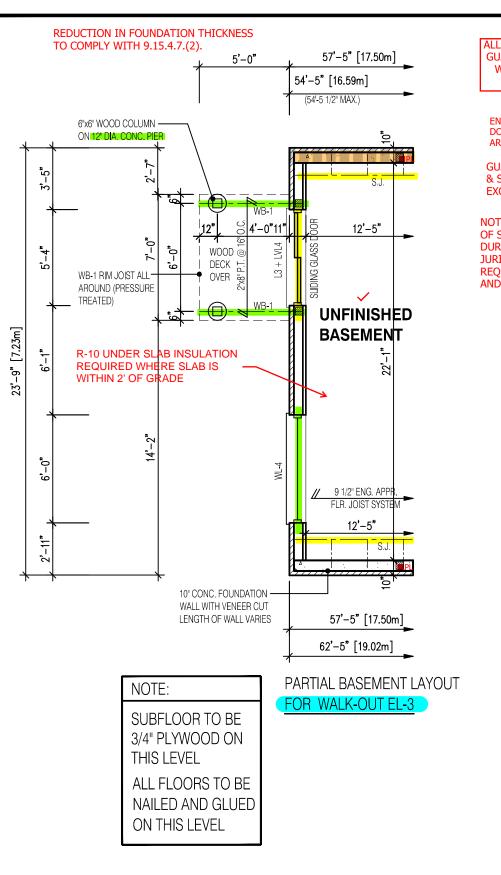

NOTE:

NOTE:

REFER TO SHEET NO. 0 - FOR LINTEL, BEAMS AND DOOR SIZE

ROOF TRUSS DRAWINGS BY MANUFACTURER

THESE DRAWINGS ARE TO BE READ IN CONJUNCTION WITH ENGINEER APPROVED

ALL GUARDS TO COMPLY WITH SB-7 OR P.ENG DESIGN GUARDS TO BE MIN. 36" HIGH (900mm). WHERE DECK WALKING SURFACE TO FIN. GRADE EXCEEDS 5'-11" (1.8m), GUARD HEIGHT TO BE 42" HIGH (1.2m)

57'-5" [17.50m] 6'-0" 54'-5" [16.59m] (54'-5 1/2" MAX.)

ENSURE P.ENG STAMPED RAILING DOCUMENTATION AND ATTACHMENT DETAILS ARE AVAILABLE FOR REVIEW BY THE INSPECTOR

GUARDS CONFORMING TO O.B.C. 9.8.8. & SB-7 ARE REQUIRED FOR PORCHES EXCEEDING 24" ABOVE GRADE.

NOT THE GRANTING OF A PERMIT NOR REVIEWING OF SPECS & DRAWINGS NOR INSPECTIONS MADE DURING INSTALLATION BY THE OFFICIAL HAVING JURISDICTION SHALL RELIEVE THE OWNER FROM REQUIREMENTS OF THE ONTARIO BUILDING CODE AND ANY OTHER REFERENCED REQUIREMENTS.

NOTE:

NOTE:

FLOOR TRUSS LAYOUT BY MANUFACTURER

CEILING RAILING 12'-5" 7'-0" -9" [7.23m] **FAMILY ROOM** 9 1/2" ENG. APPR

NOTE:

SUBFLOOR TO BE 5/8" PLYWOOD ON THIS LEVEL ALL FLOORS TO BE

NAILED AND GLUED ON THIS LEVEL

SPACE CONVENTIONAL FLOOR JOISTS @ 12" O.C. BELOW ALL CERAMIC TILE AREAS

THESE DRAWINGS ARE TO BE READ IN CONJUNCTION WITH ENGINEER APPROVED

PROVIDE 1 ROW BRIDGING FOR SPANS OF 5'-7', 2 ROWS FOR SPANS GREATER THAN 7

PARTIAL FIRST FLOOR LAYOUT WITH BASEMENT WALK-OUT EL-3 STRUDET INC.



FOR STRUCTURE ONLY

LEGEND:

BUILDING FACE < THAN 4'-0" (1.2m)

12 E

16'-10"

62'-5" [19.02m]

57'-5" [17,50m]

INDICATES SOLID BEARING REQUIRED OR POINT LOAD FROM ABOVE STL. PLATE FOR STEEL COL'N ABOVE

SINGLE JOIST

D.J. DOUBLE JOIST

REPEAT NOTE Ô

SHOWER WEEPERS 0

It is the builder's complete responsibility to It is the builder's complete responsibility to ensure that all plans submitted for approval fully comply with the Architectural Guidelines and all applicable regulations and requirements including zoning provisions and any provisions in the subdivision agreement. The Control Architect is not responsible in any way for examining or approving site (lotting) plans or working drawings with respect to any zoning or building code or permit matter or that any house can be properly built or located on its lot.

This is to certify that these plans comply with the applicable Architectural Design Guidelines approved by the City of CAMBRIDGE

2400

GARDEN 3 (GR) ELEVATION 3

A1 PACKAGE

O.REG. 332/12

ONDITIONS ON SITE BEFORE PROCEEDING WITH CONSTRUCTION IY DISCREPANCIES SHALL BE REPORTED TO JARDIN DESIGN GROU NC. PRIOR TO COMMENCEMENT OF WORK.

IADDIN DESIGN COOLID INC. IS NOT DESCONSIDED FOR THE ACCURA ARIJUN DESIGNI ORDUP INC. S NOT HESPONSIBLE FOR THE ACCUM PS SURVEY, STRUCTURAL OR ENGINEERING INFORMATION SHOWN THESE DRAWINGS OR FOR CONSTRUCTION STARTED PRIOR TO THE SSUANCE OF A BUILDING PERMIT. REFER TO THE APPROPRIATE NGINEERING DRAWINGS BEFORE PROCEEDING WITH WORK. AS CONSTRUCTED INVERTS MUST BE VERIFIED PRIOR TO POURING

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	2	MAR. 23, 2022	REVISED AS PER CLIENT & ISSUED FOR BROCHURE
	1	JAN. 26, 2022	ISSUED TO CLIENT FOR PRELIMINARY REVIEW

WORK DESCRIPTION: DATE:

DESIGN GROUP INC

64 JARDIN DR. SUITE 3A VAUGHAN ONT, L4K 3P3 TEL: 905 660-3377 FAX: 905 660-371. EMAIL: info@jardindesian.ca

The undersigned has reviewed and takes responsibility for this design and has the qualifications and meets the requirements set out in the Ontario Building Code to be a designer

QUALIFICATION INFORMATION Required unless design is exempt under Division C, Subsection

Walter Bottei NAME

REGISTRATION INFORMATION Required unless design is exempt under Division C, Subsectio

3.2.4 of the building code

iardin design group inc. IRM NAME

WALK-OUT CONDITION EL-3

BARLASSINA CONSTRUCTION CITY OF CAMBRIDGE



GARDEN 3 (GR) SCALE:

3/16"=1'-0" 21-35

(45 MIN. FIRE RATING REQ'D)

17.01.0

LVL LAMINATED VENEER LUMBER

S.J.

T.J. TRIPLE JOIST

DRAWING NAME:

WHEN VENEER CUT IS GREATER THAN


26" A 10" POURED CONC. FOUNDATION


WALL IS REQUIRED. (FOUNDATION PLAN

TO BE REVIEWED IN CONJUNCTION WITH

NOTE:

SITE PLAN)

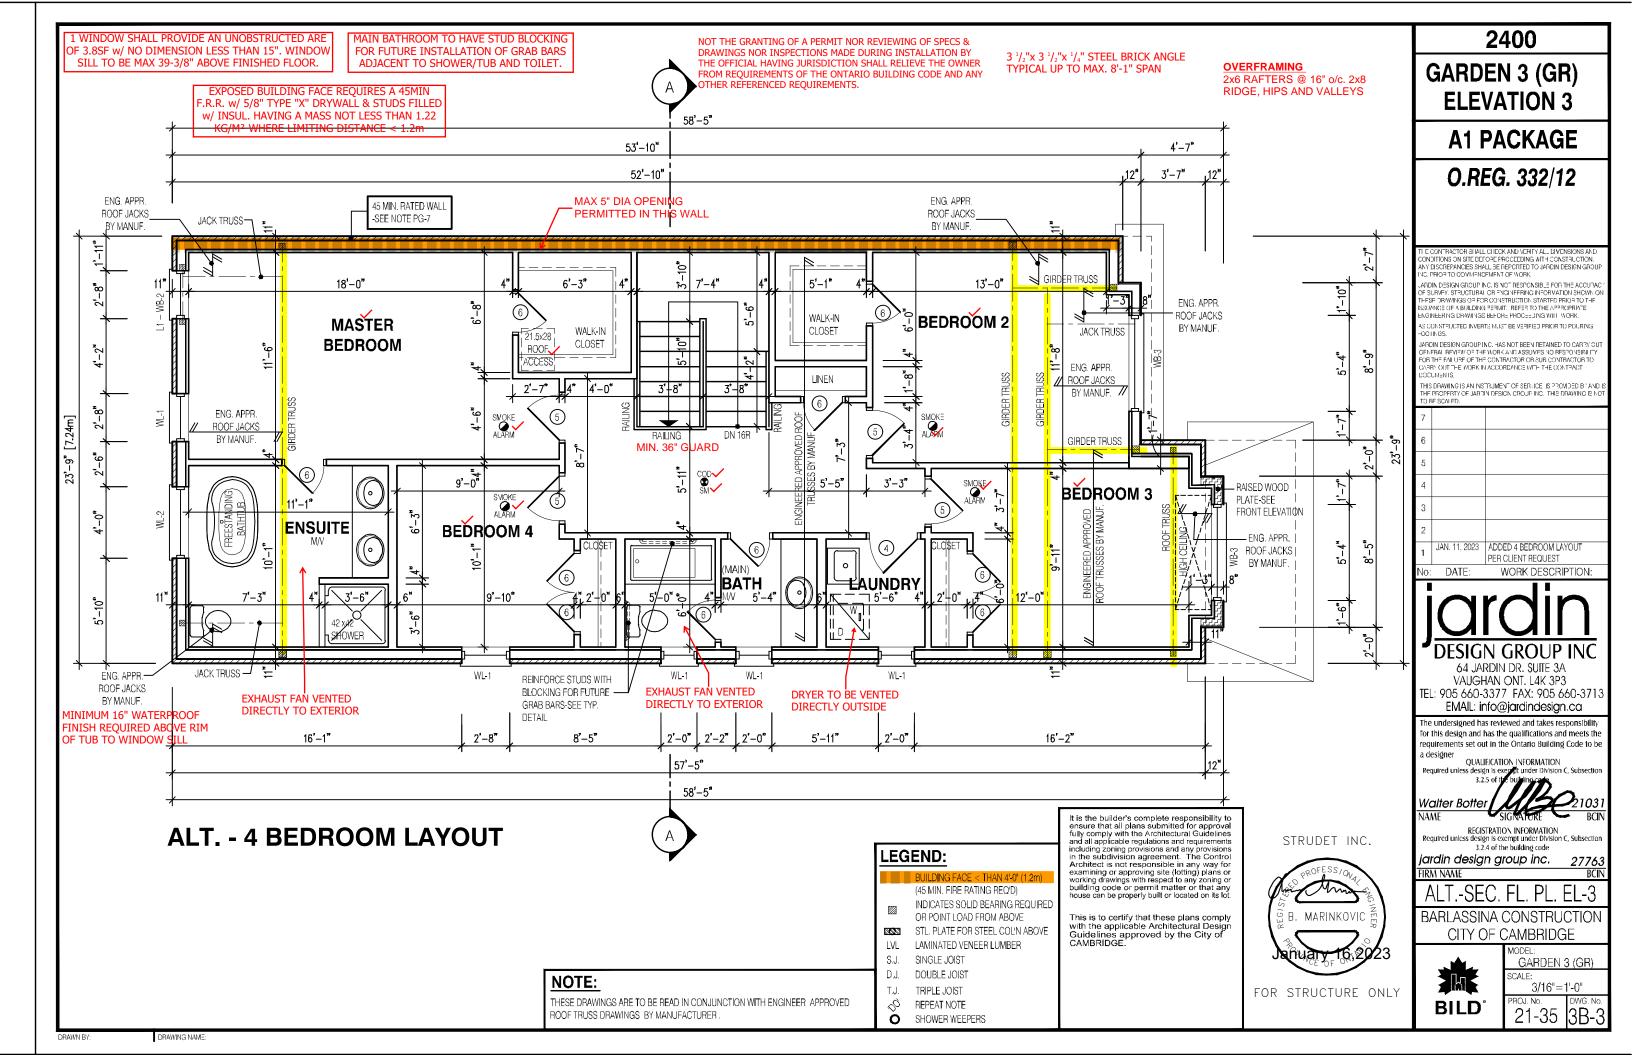

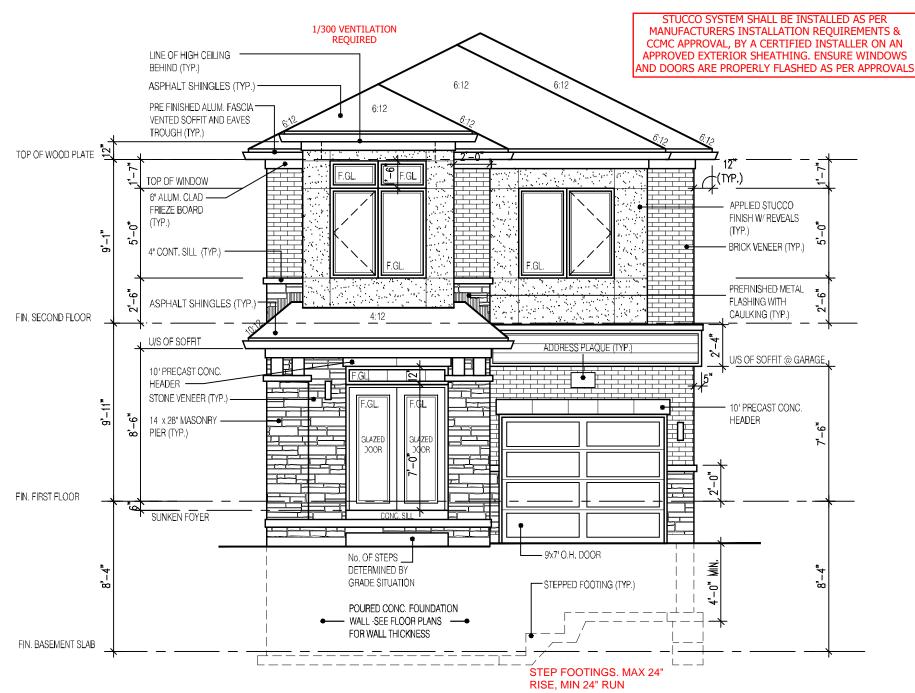

FRONT ELEVATION 3


NOT THE GRANTING OF A PERMIT NOR REVIEWING OF SPECS & DRAWINGS NOR INSPECTIONS MADE DURING INSTALLATION BY THE OFFICIAL HAVING JURISDICTION SHALL RELIEVE THE OWNER FROM REQUIREMENTS OF THE ONTARIO BUILDING CODE AND ANY OTHER REFERENCED REQUIREMENTS.

A LIGHT IS REQUIRED AT ALL ENTRANCES TO A SINGLE FAMILY DWELLING

GUARDS CONFORMING TO O.B.C. 9.8.8. & SB-7 ARE REQUIRED FOR PORCHES EXCEEDING 24" ABOVE GRADE.

ENSURE P.ENG STAMPED RAILING DOCUMENTATION AND ATTACHMENT DETAILS ARE AVAILABLE FOR REVIEW BY THE INSPECTOR

THAN 2 RISERS TO MEET THE REQUIREMENTS OF 9.8.9.2.(1)

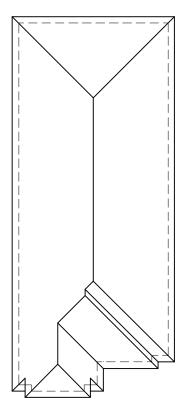

ROOF PLAN

It is the builder's complete responsibility to

or is the builder's complete responsibility to ensure that all plans submitted for approval fully comply with the Architectural Guidelines and all applicable regulations and requirements including zoning provisions and any provisions in the subdivision agreement. The Control

In the subdivision agreement. The Control Architect is not responsible in any way for examining or approving site (lotting) plans or working drawings with respect to any zoning or building code or permit matter or that any house can be properly built or located on its lot.

This is to certify that these plans comply with the applicable Architectural Design Guidelines approved by the City of CAMBRIDGE.

2400

GARDEN 3 (GR) **ELEVATION 3**

A1 PACKAGE

O.REG. 332/12

CONDITIONS ON SITE DEFORE PROCEEDING AITH CONSTRUCTION.

MY DISCREPANCIES SHALL BE REPORTED TO JARDIN DESIGN GROUND, PRIOR TO COVMENCEMENT OF WORK.

LADIN DESIGN GROUP INC. IS NOT RESPONSIBLE FOR THE ACCUPAC OF SURVEY, STEUCTURAL OR ENCINERING INFORMATION SHOWN OF THESE DRIWINGS OF FOR CONSTRUCTION STARTED PRIOR TO THE SSUANDE OF A BUILDING PENIT, REFER TO THE APPROPRIATE NGINEERING CRAWINGS BEFORE PROCESSING WITH WORK.

AS CONSTRUCTED INVERTS MUST BE VERIFIED PRIOR TO POURING

JARDIN DESIGNIGNOUP INC. HAS NOT BEEN RETAINED TO CARRY OUT CENTRAL REVIEW OF THE NORK AND ASSUMES NO RESTONSIBILITY FOR THE RALLUSE OF THE CONTRACTOR OR SUB-CONTRACTOR TO CASEN OUT THE MORKIN ACCORDANCE WITH THE CONTRACT

ALD BY STANKING IS AN INTERJMENT OF SERVICE IS PROVIDED BY A DISTANCE IS PROPERTY OF JAPAN DESIGN CROUP INC. THIS DRAWING IS NOT ONE SOAI FD.

AUG. 10, 2022	ISSUED FOR BUILDING PERMIT
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	AUG. 3, 2022 JUN. 2, 2022 MAY 10, 2022 MAR. 23, 2022

WORK DESCRIPTION:



64 JARDIN DR. SUITE 3A VAUGHAN ONT. L4K 3P3 TEL: 905 660-3377 FAX: 905 660-3713 EMAIL: info@jardindesign.ca

The undersigned has reviewed and takes responsibility for this design and has the qualifications and meets the requirements set out in the Ontario Building Code to be

a designer QUALIFICATION INFORMATION

Walter Botter NAME

REGISTRATION INFORMATION
Required unless design is exempt under Division C, Subsection

3.2.4 of the building code ardin design group inc.

RM NAME

FRONT ELEVATION 3

BARLASSINA CONSTRUCTION CITY OF CAMBRIDGE





GARDEN 3 (GR) SCALE: 3/16"=1'-0" PROJ. No.

21-35

4B

EXTERIOR CONCRETE STAIRS w/ MORE

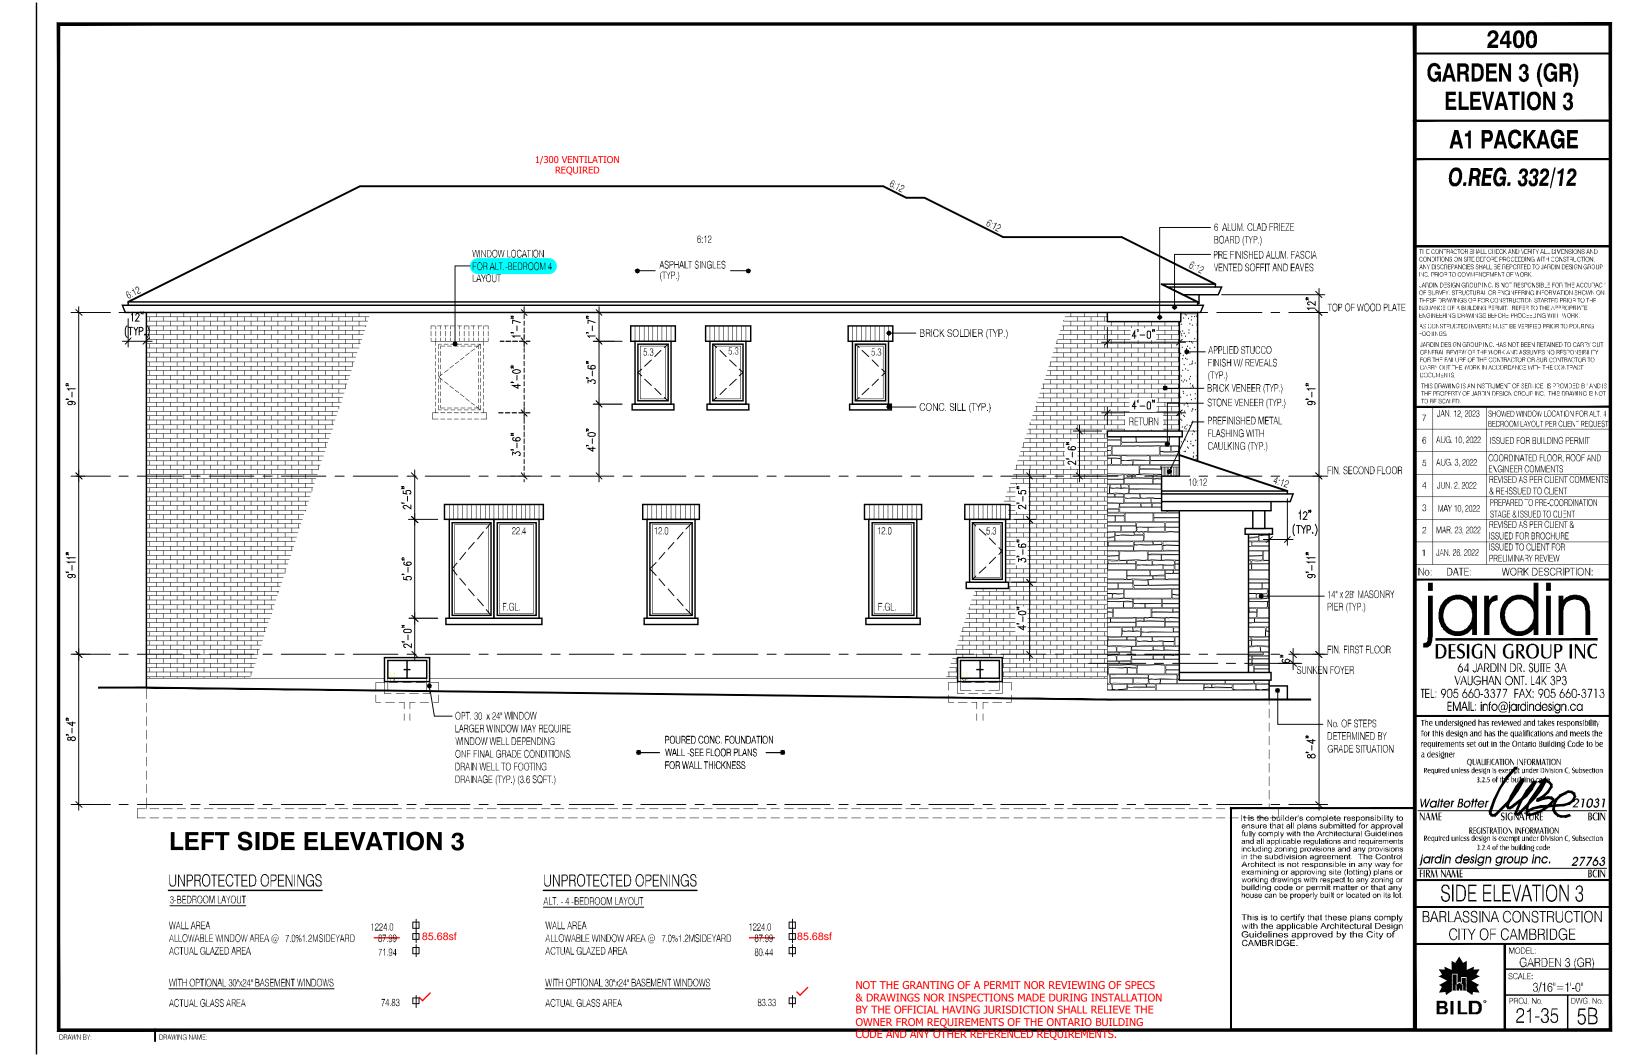

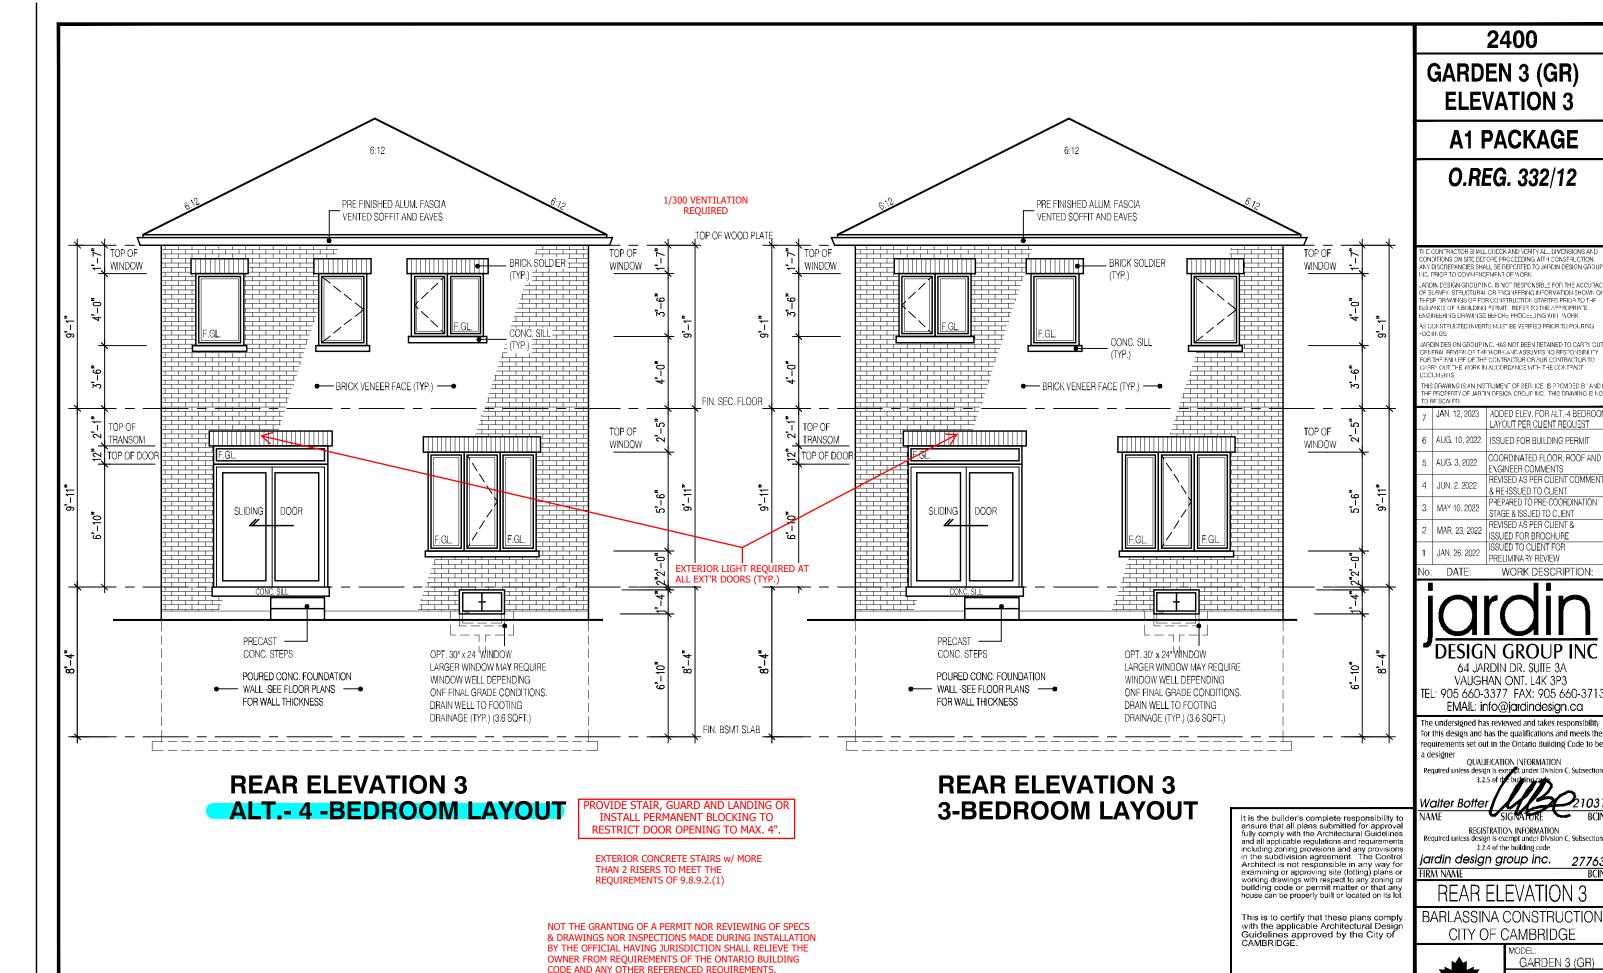

SCALE:

PROJ. No.


21-35


3/16"=1'-0"


6B


BILD

DRAWING NAME

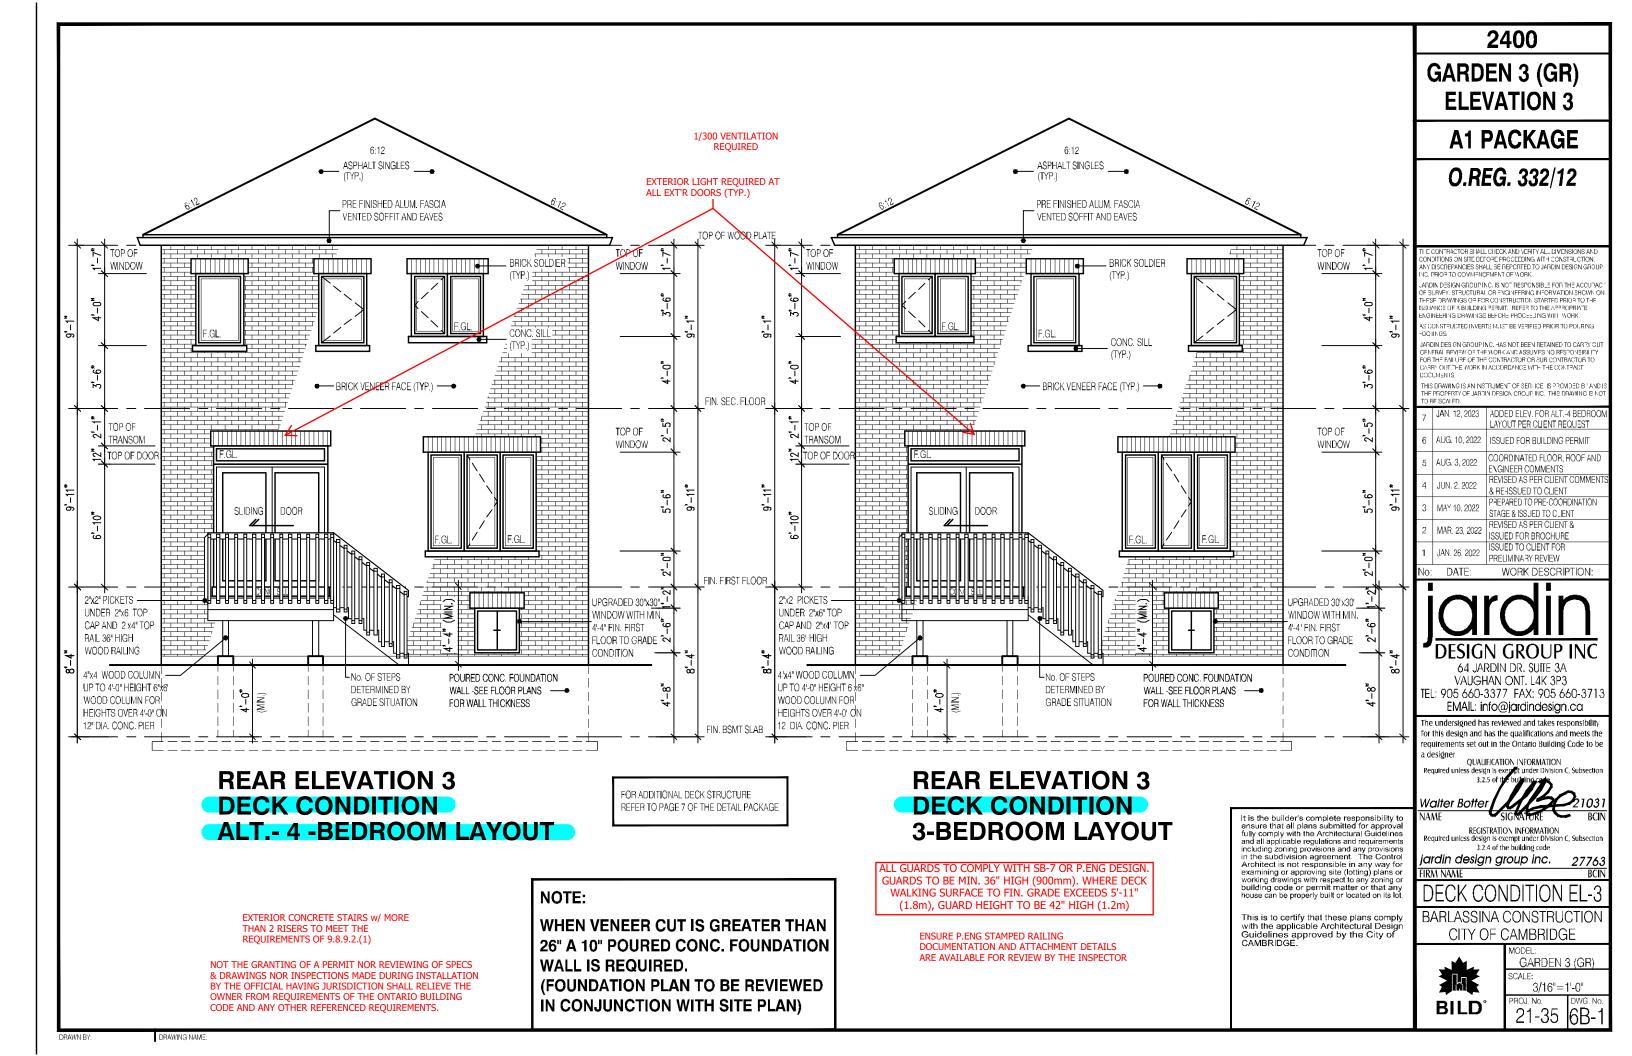

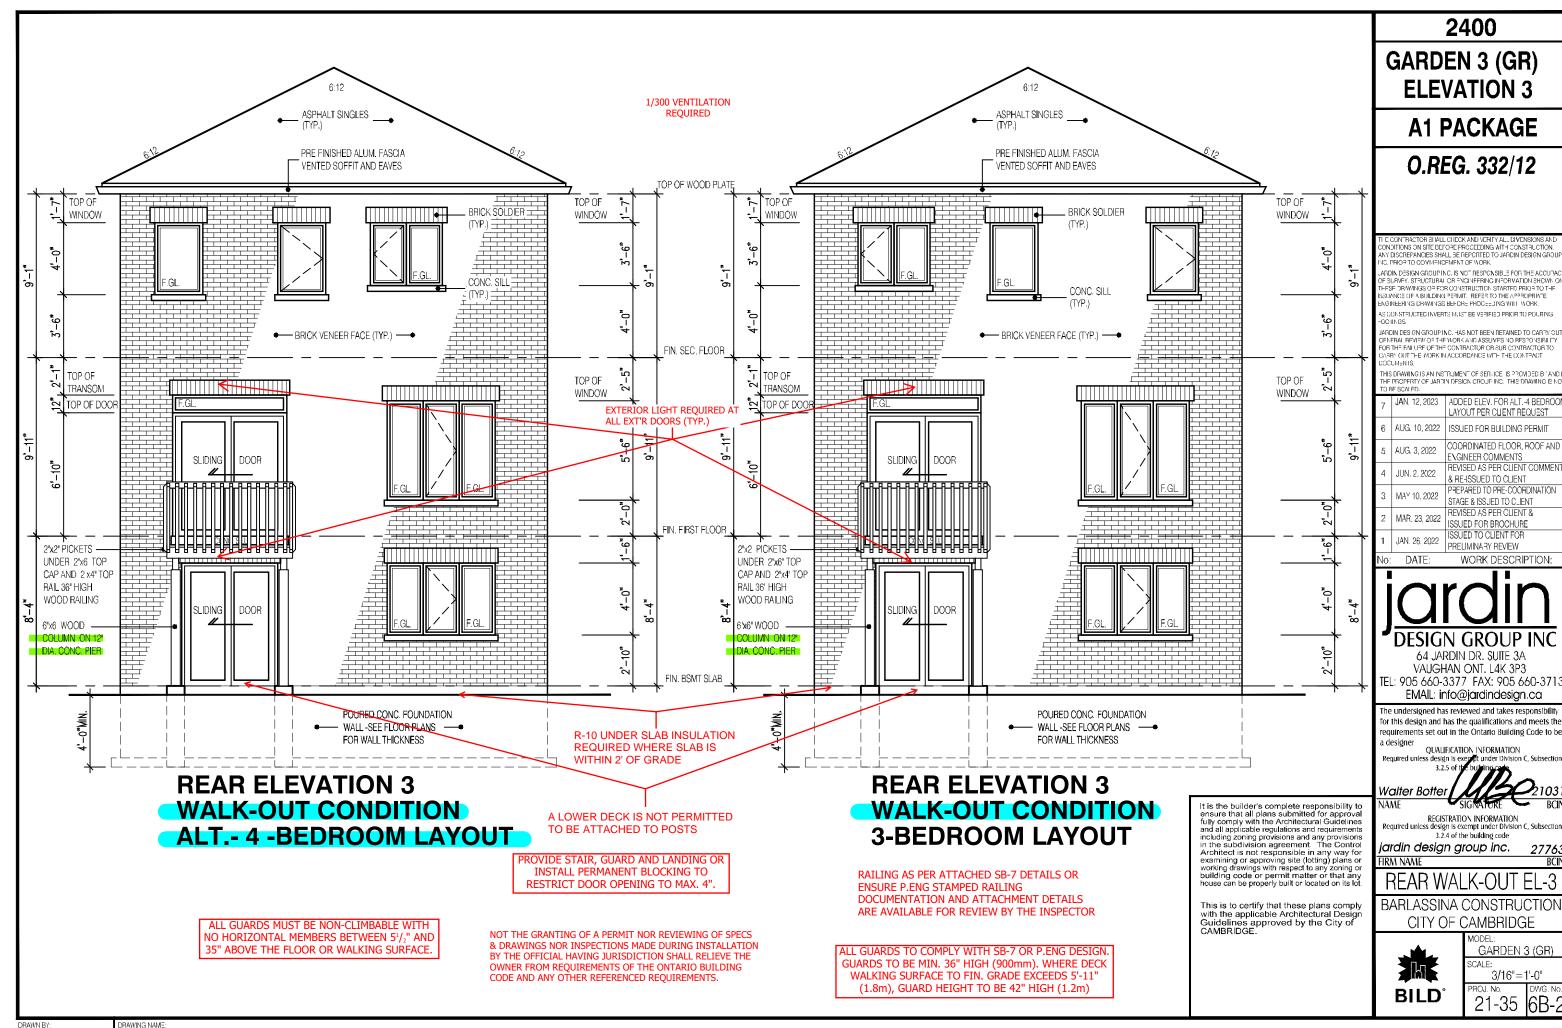

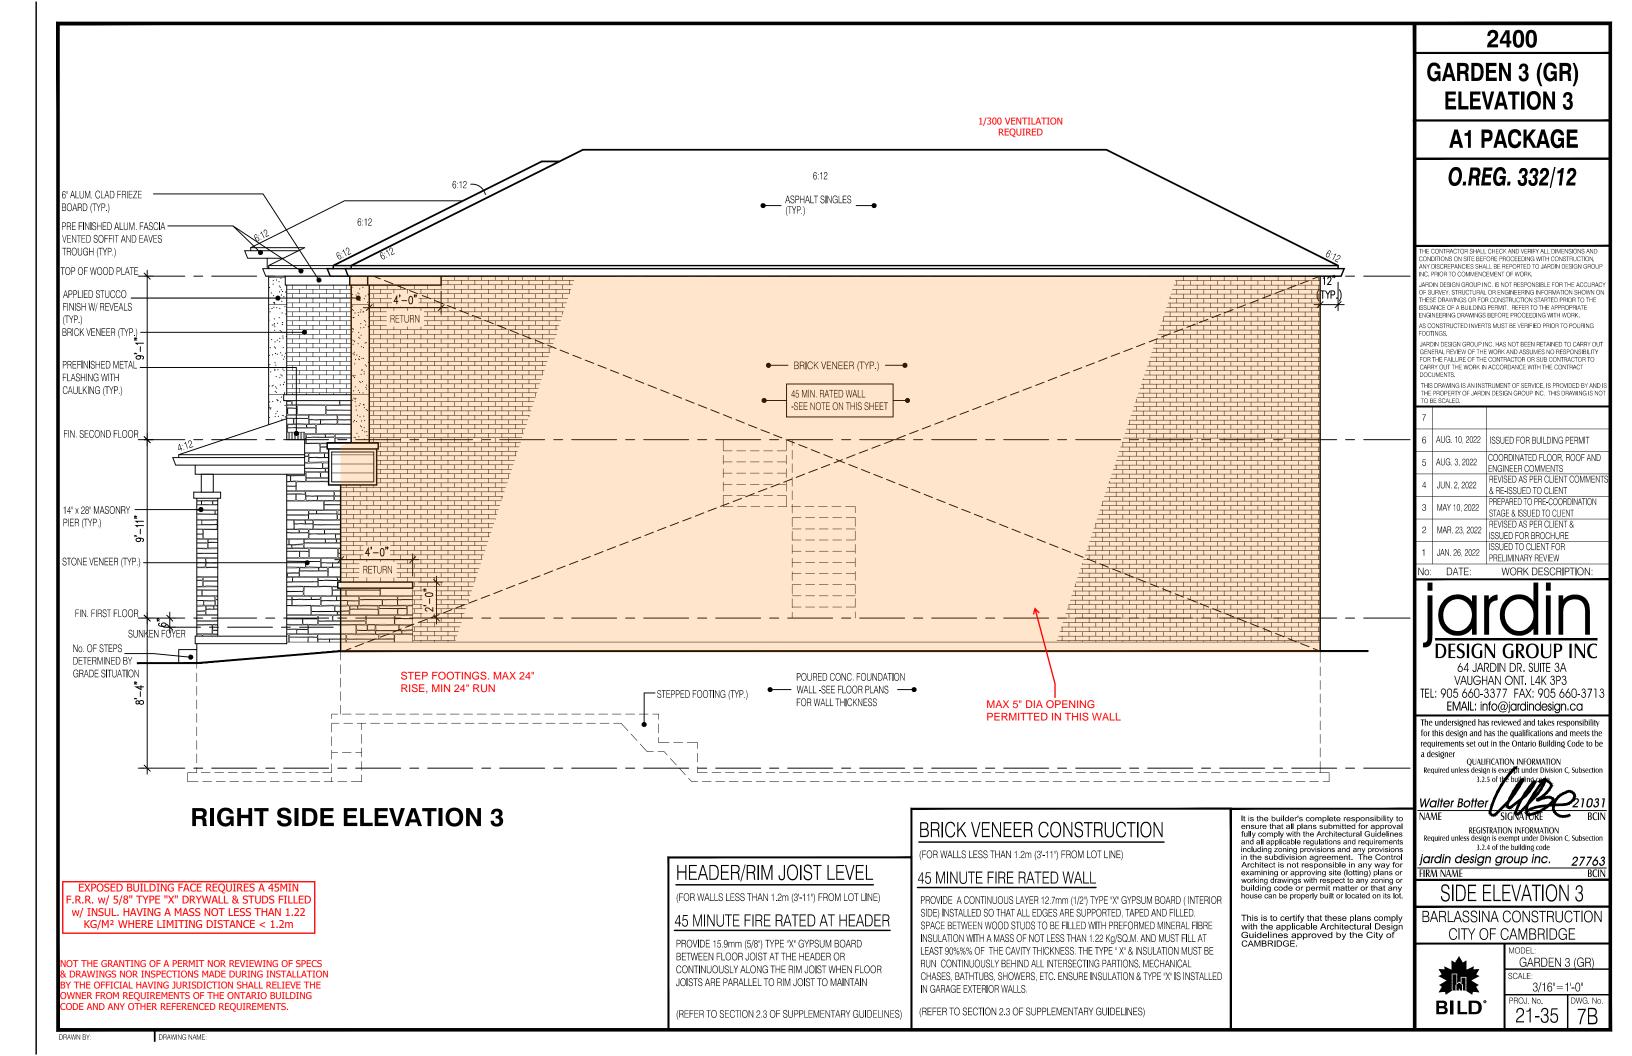

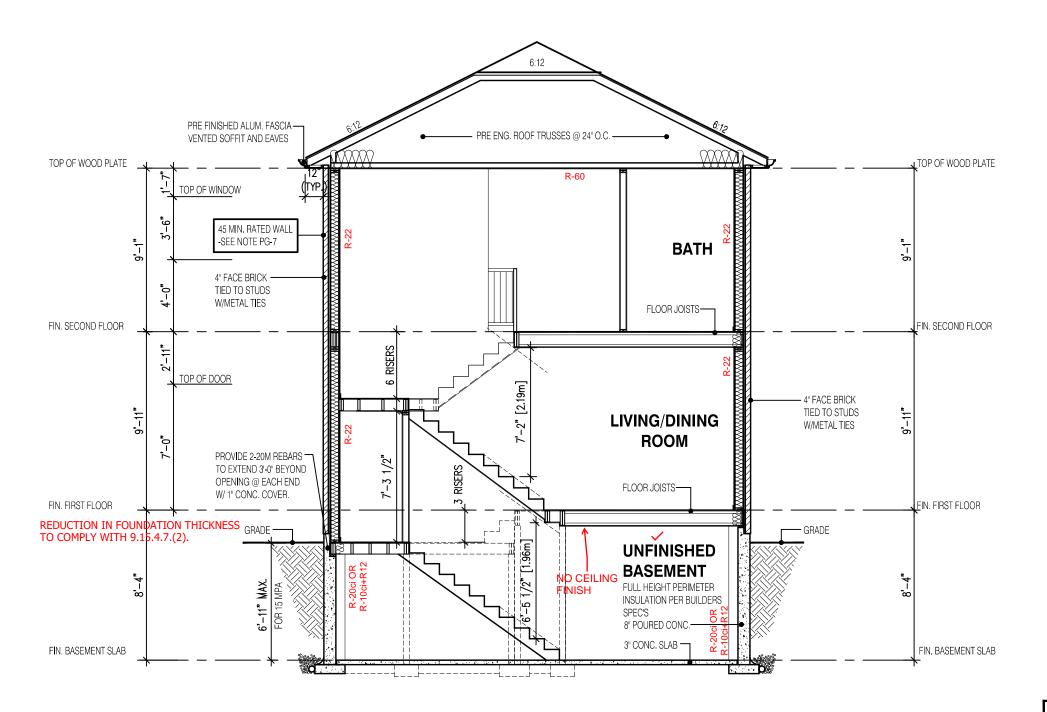

SECTION A-A ELEVATION 3

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STRUDET INC.



FOR STRUCTURE ONLY

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2400

GARDEN 3 (GR) **ELEVATION 3**

A1 PACKAGE

O.REG. 332/12

CONDITIONS ON SITE BEFORE PROCEEDING WITH CONSTRUCTION. ANY DISCREPANCIES SHALL BE REPORTED TO JARDIN DESIGN GROUI INC. PRIOR TO COMMENCEMENT OF WORK.

JARDIN DESIGN GROUP INC. IS NOT RESPONSIBLE FOR THE ACCURAC JARDIN DESIGN GROUP INC. IS NOT HESPONSIBLE FOR THE ACCUR-OF SURVEY, STRUCTURAL OR ROIS REERING INFORMATION SHOWN THESE DRAWINGS OR FOR CONSTRUCTION STARTED PRIOR TO THE ISSUANCE OF A BUILDING PERMIT. REFER TO THE APPROPRIATE ENGINEERING DRAWINGS BEFORE PROCEEDING WITH WORK. AS CONSTRUCTED INVERTS MUST BE VERIFIED PRIOR TO POURING

JARDIN DESIGN GROUP INC. HAS NOT BEEN RETAINED TO CARRY OUT GENERAL REVIEW OF THE WORK AND ASSUMES NO RESPONSIBILITY FOR THE FALIURE OF THE CONTRACTOR OF SUB CONTRACTOR TO CARRY OUT THE WORK IN ACCORDANCE WITH THE CONTRACT

THIS DRAWING IS AN INSTRUMENT OF SERVICE. IS PROVIDED BY AND IS HE PROPERTY OF JARDIN DESIGN GROUP INC. THIS DRAWING IS NO O BE SCALED.

7		
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QUALIFICATION INFORMATION

Walter Bottei

REGISTRATION INFORMATION Required unless design is exempt under Division C, Subsection

3.2.4 of the building code jardin design group inc.

IRM NAME **SECTION ELEVATION 3**

BARLASSINA CONSTRUCTION CITY OF CAMBRIDGE



GARDEN 3 (GR) SCALE:

3/16"=1'-0" 21-35