



# MHP 2302Development Services Department **Building Permit and Inspection Services**

BUILDING PERMIT PLANS	ACCEPTED AS NOTED		
REVIEW	REVIEWED BY	DATE	
ZONING			
PLANNING			
ARCHITECTURAL	CM	NOV 4, 2023	
STRUCTURAL			
FIRE			
PLUMBING	CARD		
MECHANICAL			
PLANS REVIEW COMPLETED	CM	NOV 4, 2023	

#### **SOIL CONDITIONS**

SOIL CONDITIONS SHALL BE VERIFIED BY A PROFESSIONAL ENGINEER COMPETENT IN THE FIELD OF SOIL ENGINEERING, PRIOR TO PLACING ANY FOUNDATION.

THE PERMIT PLANS HAVE BEEN **ANY FUTURE CHANGES WILL REQUIRE A SEPARATE BUILDING PERMIT** 

#### **PLUMBING INSTALLATIONS**

ALL PLUMBING INSTALLATIONS ARE TO BE DONE BY A PLUMBING CONTRACTOR POSSESSING AN ONTARIO COLLEGE OF TRADES MEMBERSHIP, NO PLUMBING IS TO BE COVERED UNTIL INSPECTED AND APPROVED BY A PLUMBING INSPECTOR. TELEPHONE 905-436-5658 WHEN READY FOR AN INSPECTION AND TESTING.

ALL STANDARDS REFERRED TO IN THESE BUILDING PERMIT DOCUMENTS SHALL BE THE **EDITION** DESIGNATED IN OBC 2012 AS AMENDED.

#### RAIN WATER DOWNSPOUTS ARE TO BE DISCHARGED AT GRADE AND NOT CONNECTED TO WEEPING TILES

#### **FUTURE ALTERATIONS**

A SEPARATE BUILDING PERMIT IS REQUIRED FOR ANY PROPOSED INTERIOR PARTITIONS AND/OR ALTERATIONS.

COPY OF THE STAMPED/REVIEWED DRAWINGS MUST REMAIN ON SITE DURING CONSTRUCTION.

### **NOTE:**

IT IS RECOMMENDED THAT CRUSHED CONCRETE OR SLAG AGGREGATE **NOT** TO BE USED FOR BACKFILL UNDER CONCRETE SLABS, AROUND SEWER LATERALS OR WEEPERS.

#### **MHP CERTIFICATION**

ALL MARKUPS AND STAMPS APPLIED TO BASE MODEL AND BASE ELEVATION SHALL APPLY AS APPLICABLE TO THE ENTIRE MODEL HOUSE

### **AS BUILT SURVEY**

UPON COMPLETION OF THE FOUNDATION, A SURVEY PREPARED BY AN ONTARIO LAND SURVEYOR INDICATING THE LOCATION OF THE BUILDING TO ALL PROPERTY LINES IS REQUIRED TO BE SUBMITTED TO THE BUILDING **DEPARTMENT** 

## **IMPORTANT NOTE**

NEITHER THE ISSUANCE OF A PERMIT NOR THE CARRYING OUT OF INSPECTIONS BY THE CITY RELIEVE THE APPLICANT FROM FULL RESPONSIBILITY FOR COMPLIANCE WITH THE PROVISIONS OF THE BUILDING CODE ACT AND THE ONTARIO BUILDING CODE, BOTH AS AMENDED, AS WELL AS OTHER APPLICABLE STATUES AND REGULATIONS OF THE PROVINCE OF ONTARIO AND ALL RELEVANT BY-LAWS OF THE CITY OF OSHAWA AND THE REGIONAL MUNICIPALITY OF DURHAM.

ALL ELECTRICAL WIRING MUST BE INSPECTED BY THE ELECTRICAL SAFETY AUTHORITY. SEPARATE INSPECTION APPLICATIONS (PERMITS) MUST BE FILED. WE RECOMMEND YOU USE A QUALIFIED ELECTRICAL CONTRACTOR. FOR MORE **INFORMATION PLEASE CALL:** 



1-877-ESA-SAFE OR VISIT WWW.ESASAFE.COM

#### **OBC 9.10.14.5 - CLADDING**

CLADDING ON THE EXPOSING BUILDING FACE IS PERMITTED TO BE VINYL WHEN WITHIN 600mm OF PROPERTY LINE, PROVIDED THAT THE VINYL CONFORMS TO OBC DIV. B. 9.27.13, IS INSTALLED OVER SHEATHING PAPER AND12.7mm DRYWALL, HAS A FLAME SPREAD RATING NOT GREATER THAN 25, AND IS NOT MORE THAN 2mm THICK AND THE ENTIRE EXTERIOR WALL HAS A MINIMUM FIRE RESISTANCE RATING OF 3/4 HOURS.

RETURN AIR INLET FROM ANYROOM
PROVISIONS SHALL BE MADE FOR THE RETURN OF AIR FROM ANY ROOM OR
SPACE WITHOUT A RETURN AIR INLET, BY LEAVING GAPS BENEATH DOORS,
USING LOUVERED DOORS, OR INSTALLING RETURN AIR DUCT INLETS.

#### **BEDROOM WINDOWS**

(1) EVERY FLOOR LEVEL CONTAINING BEDROOMS IN A SUITE SHALL BE PROVIDED WITH AT LEAST 1 OUTSIDE WINDOW THAT CAN BE OPENED FROM THE INSIDE WITHOUT THE USE OF TOOLS, AND EACH SUCH WINDOW SHALL PROVIDE AN INDIVIDUAL, UNOBSTRUCTED OPEN PORTION HAVING A MINIMUM AREA OF 0.35M2 (3.8 SQ.FT.) WITH NO DIMENSION LESS THAN 380 MM (15 IN).

(2) EXCEPT FOR BASEMENT AREAS. THE WINDOW DESCRIBED IN SENTENCE (1) SHALL HAVE A MAXIMUM SILL HEIGHT OF 1M (3 FT 3 IN) ABOVE THE FLOOR. (3) WHEN SLIDING WINDOWS ARE USED, THE MINIMUM DIMENSION DESCRIBED IN SENTENCE (1) SHALL APPLY TO THE OPENABLE PORTION OF THE WINDOW.

## PREFABRICATED WOOD TRUSSES

FABRICATION AND ERECTION DRAWINGS WITH DESIGN DATA, PREPARED AND SEALED BY A PROFESSIONAL ENGINEER, MUST BE AVAILABLE ON SITE FOR REVIEW BY THE BUILDING INSPECTOR

#### **ROOF CEILING INSULATION**

ROOF FRAMING OR TRUSS HEEL JOINT MUST PERMIT SUFFICIENT SPACE FOR THE EXTENSION OF THE ROOF-CELLING INSULATION OVER EXTERIOR WALLS MINIMIZE THERMAL BRIDGES. AN UNOBSTRUCTED VENTILATION SPACE MUST BE PROVIDED OVER EXTERIOR WALLS TO ALLOW UNIMPEDED AIR FLOW FORM SOFFIT

## LESS THAN 550mm (21 5") BY 900mm (35")

**ATTIC HATCHES SHALL NOT BE** 

## OBC 9.26.4.1.

FLASHING REQUIRED AT ALL **ROOF-WALL JUNCTIONS** 

## **INTERIOR FINISH OF EXITS**

THE FLAME SPREAD RATING OF WALL OR CEILING FINISH IN AN **EXIT MUST NOT EXCEED 25.** 

## **INTERIOR FINISH (EXCEPT EXITS)**

FLAME SPREAD RATING OF INTERIOR FINISH MATERIALS SHALL NOT EXCEED  $\underline{150}$  ON WALLS AND  $\underline{150}$  ON CEILINGS. COMBUSTIBLE WALL AND CEILING FINISHES SUCH AS WOOD, PLYWOOD, PLASTIC, FABRIC, CARPET, ETC. MUST BE APPROVED BY THE INSPECTOR PRIOR TO THE INSTALLATION.

## **DIV.B. 9.10.14.1 EXPOSING BUILDING FACE OF HOUSES**

UNPROTECTED OPENINGS IN THE EXPOSING BUILDING FACE SHALL NOT BE PERMITTED IF THE LIMITING DISTANCE IS LESS THAN 1.2m (3'11") AND SHALL BE LIMITED IN CONFORMANCE WITH THE REQUIREMENTS FOR UNPROTECTED OPENINGS IN DIV. B ARTICLE 9.10.15.1. WHERE THE LIMITING DISTANCE IS 1.2m (3'11") OR GREATER.

THE EXPOSING BUILDING FACE SHALL HAVE A FIRE RESISTANCE RATING OF NOT LESS THAN 45 MINUTES WHERE THE LIMITING DISTANCE IS LESS THAN

## ATTACHED OR BUILT-IN GARAGE

THE SEPARATION BETWEEN THE GARAGE AND DWELLING UNIT SHALL BE CONSTRUCTED AS AN EFFECTIVE BARRIER TO GAS AND EXHAUST FUMES. THE DOOR BETWEEN THE GARAGE AND DWELLING UNIT SHALL BE EXTERIOR TYPE, TIGHT FITTING AND WEATHER-STRIPPED TO PROVIDE AN EFFECTIVE BARRIER AGAINST THE PASSAGE OF GAS AND EXHAUST FUMES AND SHALL BE FITTED WITH AN APPROVED SELF CLOSING DEVICE

#### 2012 OBC DIV. B, 9.8.2.1. to 9.8.4.7. STAIR DIME MAX. RISE, MIN. RISE, MAX. RUN, mm MIN. RUN, mm STAIR HEAD

	mm, ALL STEPS	mm, ALL STEPS	RECTANGULAR TREADS	RECTANGULAR TREADS	WIDTH, mm	mm
PRIVATE STAIRS	200	125	355	255	860	1950
PUBLIC STAIRS	180	125	NO LIMIT	280	900	2050
SERVICE STAIRS	NO LIMIT	125	355	NO LIMIT	900	2050
STAIR TO UNOCCUPIED ATTIC SPACE	NO LIMIT	125	355	NO LIMIT	860	1950
STAIRS TO CRAWL SPACE	NO LIMIT	125	355	NO LIMIT	860	1950
STAIRS THAT SERVE MEZZANINES NOT EXCEEDING 20 m2 WITHIN LIVE/WORK UNITS	NO LIMIT	125	355	NO LIMIT	WIDTH AS PER DIV B 9.8.2.1.(3)	2050
NOTE			ADS SHALL NOT RE			EPTH

## STRUCTURAL ALTERATIONS

ALL STRUCTURAL ALTERATIONS MUST BE FIELD REVIEWED BY A PROFESSIONAL ENGINEER IF REQUIRED BY THE BUILDING INSPECTOR

## **FINISHED SITE GRADING**

THE BUILDING SHALL BE LOCATED AND THE BUILDING SITE GRADED SO THAT WATER WILL NOT ACCUMULATE AT OR NEAR THE BUILDING AND WILL NOT ADVERSELY AFFECT ANY ADJACENT PROPERTIES.

> **A CURSORY REVIEW OF THE** STRUCTURAL ELEMENTS HAS **BEEN COMPLETED AND IS RELIANT ON ENGINEER'S CERTIFICATION OF**

**RESISTANCE TO FORCED ENTRY** 2012 O.B.C. DIV B. 9.7.5.2. & 9.7.5.3. A return air inlet shall be located in any room where at least 1/2 of the floor area is located over an unconditioned space (e.g. room over a garage)

- 1. SWINGING DOORS PROVIDING ACCESS TO DWELLING UNITS SHALL SATISFY THE REQUIREMENTS FOR RESISTANCE TO FORCED ENTRY AS DESCRIBED IN SUBSECTION 9.7.5.2.
- 2. WINDOWS IN DWELLING UNITS THAT ARE LOCATED WITHIN 2M OF ADJACENT GROUND LEVEL SHALL CONFORM TO THE REQUIREMENTS FOR RESISTANCE TO FORCED ENTRY AS DESCRIBED IN CLAUSE 5.3.5.OF AAMA/WDMA/CSA 101/I.S.2/A440.

2012 Code

9.8.8.1.(8)(a)(b) Windows over Stairs, Ramps and Landings

(2) In dwelling units, glazing installed over stairs, ramps and landings that extend to less than 900 mm (2 ft 11 in) above the surface to the treads, ramp or landing shall be,

- (a) protected by guards, in accordance with this Subsection, or
- (b) non-openable and designed to withstand the specified lateral loads for *guards* as provided in Article 4.1.5.14.

#### 9.5.2.3. STUD WALL REINFORCEMENT

- (1) IF WOOD WALL STUDS OR SHEET STEEL WALL STUDS ENCLOSE THE MAIN BATHROOM IN A DWELLING UNIT, REINFORCEMENT SHALL BE INSTALLED TO PERMIT THE FUTURE INSTALLATION OF A GRAB BAR ON A WALL ADJACENT TO,
  - (a) A WATER CLOSET IN THE LOCATION REQUIRED BY CLAUSE 3.8.3.8.(1)(d), AND
  - (b) A SHOWER OR BATHTUB IN THE LOCATION BY CLAUSE 3.8.3.13.(1)(f).

(SEE APPENDIX A.)

The Corporation of the City of Oshawa, 50 Centre Street South, Oshawa, Ontario L1H 3Z7 Phone 905.436.5658 1.800.667.4292 Fax 905.436.5623

# STRIP FOOTINGS FOR SINGLES AND SEMIS UP TO 2 STOREY 120 KPa NATIVE SOIL 20 %6" CONCRETE STRIP FOOTINGS BELOW FOUNDATION WALLS. WALLS ONCE THE STRIP FOOTINGS WITH REINFORCING BELOW FOUNDATION WALLS.

100 KPa NATIVE SOIL

22"x8" CONCRETE STRIP FOOTINGS BELOW FOUNDATION WALLS. 28'x10" CONCRETE STRIP FOOTINGS BELOW PARTY WALLS

#### GENERAL NOTE

ASSUMED 120/100 KPa NATIVE SOIL BEARING CAPACITY OR 90 KPa FOR ENGINEERED FILL, TO BE VERIFIED ON SITE, REFER TO ENGINEERED FILL

**BESCASE** CONCEETE STRIP FOOTINGS WITH REINFORCING BELOW PARTY WALLS.

(REFER TO ENG. FILL FOOTING DETAIL)

## **AREA CALCULATIONS EL-1**

FIRST FLOOR AREA SECOND FLOOR AREA	=	995 Sq.   1177 Sq.
TOTAL FLOOR AREA	=	2172 Sq.
ADD OPEN AREAS ADD FIN. BASEMENT AREA	=	18 Sq. 0 Sq.
GROSS FLOOR AREA	=	2190 Sq.
GROUND FLOOR COVERAGE	=	995 Sa.

GARAGE COVERAGE / AREA = 242 Sa. Ft 74 Sq. Ft PORCH COVERAGE / AREA = 1311 Sq. Ft. COVERAGE W/ PORCH

 $= 121.80 \, \text{Sa. m.}$ = 1237 Sq. Ft. COVERAGE W/O PORCH

= 114.92 Sq. m.

RIVER 1 EL-1

ELEVATION

FRONT

I FFT SIDE

RIGHT SIDE

TOTAL

RIVER 1 EL-2

ELEVATION

FRONT

LEFT SIDE

RIGHT SIDE

TOTAL

RIVER 1 EL-3

ELEVATION

LEFT SIDE

RIGHT SIDE

TOTAL

## AREA CALCULATIONS EL-2

FIRST FLOOR AREA SECOND FLOOR AREA	=	995 Sq. Ft. 1177 Sq. Ft.
TOTAL FLOOR AREA	=	2172 Sq. Ft.
ADD OPEN AREAS ADD FIN. BASEMENT AREA	=	18 Sq. Ft. 0 Sq. Ft.
GROSS FLOOR AREA	=	2190 Sq. Ft.
GROUND FLOOR COVERAGE	=	995 Sq. Ft.
GARAGE COVERAGE / AREA PORCH COVERAGE / AREA	=	242 Sq. Ft. 74 Sq. Ft.
COVERAGE W/ PORCH	=	1311 Sq. Ft.
I	=	121 80 Sq. m

= 1237 Sq. Ft.

= 114.92 Sq. m.

OPENING FT<sup>2</sup>

68.35

54.67

0.00

121.28

244.29

OPENING FT

76.00

54 67

0.00

121 28

251.94

OPENING FT

119.97

54,67

0.00

121.28

295.91

ENERGY EFFICIENCY- A1 PACKAGE

ENERGY EFFICIENCY- A1 PACKAGE

ENERGY EFFICIENCY- A1 PACKAGE

PERCENTAGE

13.28 %

4.99 %

0.00%

24.51 %

7.68 %

PERCENTAGE

14.75 %

5.00 %

0.00 %

24.51 %

7,92 %

PERCENTAGE

22.74 %

4.89 %

0.00 %

24.51 %

9.20 %

COVERAGE W/O PORCH

WALL FT<sup>2</sup>

514.75

1095.28

1076.39

494.79

3181.21

WALL FT2

515.08

1093 67

1076.39

494.79

3179.93

WALL FT<sup>2</sup>

527.50

1117.90

1076.39

494.79

3216.58

## **AREA CALCULATIONS EL-3**

FIRST FLOOR AREA	=	997 Sq. Ft. 1179 Sq. Ft.
TOTAL FLOOR AREA	=	2176 Sq. Ft.
ADD OPEN AREAS ADD FIN. BASEMENT AREA	=	18 Sq. Ft. 0 Sq. Ft.
GROSS FLOOR AREA	=	2194 Sq. Ft.
	SECOND FLOOR AREA  TOTAL FLOOR AREA  ADD OPEN AREAS  ADD FIN. BASEMENT AREA	SECOND FLOOR AREA =  TOTAL FLOOR AREA =  ADD OPEN AREAS =  ADD FIN. BASEMENT AREA =

GROUND FLOOR COVERAGE = 997 Sq. Ft. GARAGE COVERAGE / AREA = 242 Sq. Ft. PORCH COVERAGE / AREA = 74 Sq. Ft. COVERAGE W/ PORCH = 1313 Sq. Ft. = 121.98 Sq. m.

= 1239 Sq. Ft. COVERAGE W/O PORCH = 115.11 Sq. m.

RIVER 1 (GR) **|ELEVATION 1, 2 & 3|** A1 PACKAGE

O.REG. 332/12

2190

**9.14m LOTS** 

ONDITIONS ON SITE BEFORE PROCEEDING WITH CONSTRUCTION. PRIOR TO COMMENCEMENT OF WORK.

JARDIN DESIGN GROUP INC. IS NOT RESPONSIBLE FOR THE ACCURAC OF SURVEY, STRUCTURAL OR ENGINEERING INFORMATION SHOWN THESE DRAWINGS OR FOR CONSTRUCTION STARTED PRIOR TO THE SSUANCE OF A BUILDING PERMIT. REFER TO THE APPROPRIATE. ENGINEERING DRAWINGS BEFORE PROCEEDING WITH WORK.

AS CONSTRUCTED INVERTS MUST BE VERIFIED PRIOR TO POURING

JARDIN DESIGN GROUP INC. HAS NOT BEEN PETAINED TO CARRY OUT CENERAL REVIEW OF THE WORK AND ASSUVES NO RESPONSIBILITY FOR THE FAILURE OF THE CONTRACTOR OR SUB CONTRACTOR TO ARRY OUT THE WORK IN ACCORDANCE WITH THE CONTRACT

THIS DRAWING IS AN INSTRUMENT OF SERVICE, IS PROVIDED BY AND I THE PROPERTY OF JARDIN DESIGN GROUP INC. THIS DRAWING IS NO

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COORDINATED FLOOR, ROOF AND MAY 4, 2023 ENGINEER COMMENTS

MAR. 1, 2023 INTRODUCED FROM JOB 21-35 FEB. 14, 2023

MODEL GARDEN 1, 4 BED LAYOUT DATE WORK DESCRIPTION:

# DESIGN GROUP INC

64 JARDIN DR. SUITE 3A VAUGHAN ONT, L4K 3P3 TEL: 905 660-3377 FAX: 905 660-3713 EMAL: info@iardindesian.ca

The undersigned has reviewed and takes responsibility for this design and has the qualifications and meets the requirements set out in the Ontario Building Code to be a designer

QUALIFICATION INFORMATION Required unless design is exempt under Division C, Subsectio 3.2.5 of 1

Walter Botter NAME

REGISTRATION INFORMATION

Required unless design is exempt under Division C, Subsection 3.2.4 of the building code 27763

jardin design group inc.

FIRM NAME

TITLE SHEET

ZADORRA ESTATE INC. CITY OF OSHAWA




RIVER 1 (GR) SCALE: 3/16"=1'-0" PROJ. No.

22-16

WG. No


PAD FOOTING 2-2"x6" STUD WALL NAILED TOGETHER AND SPACED @12" O.C. FULL HT C/W SOLID BLOCKING 4'-0' O.C. VERTICAL AND 7/16" 120 KPa NATIVE SOIL 90 KPa ENGINEERED FILL SOIL 100 KPa NATIVE SOIL EXT. PLYWOOD SHEATHING

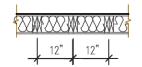

MAXIMUM HEIGHT OF WALL FOR THIS DETAIL IS 18'-0" AND MAXIMUM SUPPORTED LENGTH OF TRUSS IS 40'-0"

## TWO STOREY HEIGHT WALL DETAIL

2 - 1 1/2" x 5 1/2" TIMBERSTRAND (LSL) 1.5E STUD WALL GLUED AND NAILED TOGETHER AND SPACED MAX. @10"O.C. FULL HT C/W SOLID BLOCKING MAX. 8'-0"O.C. VERTICAL AND 7/16' EXT. OSB SHEATHING.

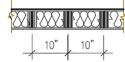

MAXIMUM HEIGHT OF WALL FOR THIS DETAIL IS 20-2" AND MAXIMUM SUPPORTED LENGTH OF TRUSS IS 40'-0"

## TWO STOREY HEIGHT WALL DETAIL

## NOTE:

THESE DRAWINGS ARE TO BE READ IN CONJUNCTION WITH ENGINEER APPROVED ROOF TRUSS DRAWINGS BY MANUFACTURER

## NOTE:

SPACE CONVENTIONAL FLOOR JOISTS @ 12" O.C. BELOW ALL CERAMIC TILE AREAS. PROVIDE 1 ROW BRIDGING FOR SPANS OF 5'-7', 2 ROWS FOR SPANS GREATER THAN 7'

## NOTE:

THESE DRAWINGS ARE TO BE READ IN CONJUNCTION WITH ENGINEER APPROVED FLOOR TRUSS LAYOUT BY MANUFACTURER.

## NOTE:

PLANS NOT DRAWN TO ACTUAL GRADE. REFER TO FINAL GRADING PLAN.

## **Door Schedule**

	NO.	WIDTH	HEIGHT HEIGHT 8' TO 9' 10' OR MORE CEILINGS CEILINGS		TYPE		
NS	1	2'-10"	6'-8"	(865x2033)	8'-0"	(865x2439)	INSULATED ENTRANCE DOOR
┙	1a	2'-8"	6'-8"	(815x2033)	8'-0"	(815x2439)	INSULATED FRONT DOORS
٦	2	2'-8"	6'-8"	(815x2033)	8'-0"	(815x2439)	WOOD & GLASS DOOR
1	3	2'-8"	6'-8 x 1-3/4"	(815x2033x45)	8'-0" x 1-3/4"	(815x2439x45)	EXTERIOR SLAB DOOR
1	4	2'-8"	6'-8" x 1-3/8"	(815x2033x35)	8'-0" x 1-3/8"	(815x2439x35)	INTERIOR SLAB DOOR
╛	5	2'-6"	6'-8" x 1-3/8"	(760x2033x35)	8'-0" x 1-3/8"	(760x2439x35)	INTERIOR SLAB DOOR
	6	2'-2"	6'-8" x 1-3/8"	(660x2033x35)	8'-0" x 1-3/8"	(660x2439x35)	INTERIOR SLAB DOOR
1	7	1'-6"	6'-8" x 1-3/8"	(460x2033x35)	8'-0" x 1-3/8"	(460x2439x35)	INTERIOR SLAB DOOR

NO.	WIDTH	HEIGHT 8' TO 9' CEILINGS		HEIGI 10' OI CEILII	R MORE	TYPE
1	2'-10"	6'-8"	(865x2033)	8' <b>-</b> 0"	(865x2439)	INSULATED ENTRANCE DOOR
1a	2'-8"	6'-8"	(815x2033)	8'-0"	(815x2439)	INSULATED FRONT DOORS
2	2'-8"	6'-8"	(815x2033)	8'-0"	(815x2439)	WOOD & GLASS DOOR
3	2'-8"	6'-8 x 1-3/4"	(815x2033x45)	8'-0" x 1-3/4"	(815x2439x45)	EXTERIOR SLAB DOOR
4	2'-8"	6'-8" x 1-3/8"	(815x2033x35)	8'-0" x 1-3/8"	(815x2439x35)	INTERIOR SLAB DOOR
5	2'-6"	6'-8" x 1-3/8"	(760x2033x35)	8'-0" x 1-3/8"	(760x2439x35)	INTERIOR SLAB DOOR
6	2'-2"	6'-8" x 1-3/8"	(660x2033x35)	8'-0" x 1 <b>-3</b> /8"	(660x2439x35)	INTERIOR SLAB DOOR
7	1'-6"	6'-8" x 1-3/8"	(460x2033x35)	8'-0" x 1-3/8"	(460x2439x35)	INTERIOR SLAB DOOR
8	3'-0"	6'-8" x 1-3/8"	(915x2033x35)	8'-0" x 1 <b>-</b> 3/8"	(915x2439x35)	INTERIOR SLAB DOOR

STRUDET INC.



FOR STRUCTURE ONL

t is the builder's complete responsibility this the bullets complete responsibility ensure that all plans submitted for approving fully comply with the Architectural Guidelin and all applicable regulations and requirement including zoning provisions and any provision to the activities of the proving provision and any provision. in the subdivision agreement. The Control
architect is not responsible in any way for
examining or approving site (lotting) plans or
working drawings with respect to any zoning or
building code or permit matter or that any

This is to certify that these plans comply with the applicable Architectural Design Guidelines approved by the City of

house can be properly built or located on its

## DRAWING NAME

24"x8" CONCRETE STRIP FOOTINGS BELOW PARTY WALLS

28"x8" CONCRETE STRIP FOOTINGS WITH REINFORCING BELOW PARTY WALLS

FOOTING DETAIL FOR REINFORCEMENT.

F1 = 46'x46'x20'' CONCRETE PAD F2 = 38"x38"x16" CONCRETE PAD

F3 = 32'x32'x14'' CONCRETE PAD F4 = 26"x26"x12" CONCRETE PAD

F4 = 24"x24"x12" CONCRETE PAD F4 = 28"x28"x12" CONCRETE PAD F5 = 18"x18"x8" CONCRETE PAD F5 = 17''x17''x8'' CONCRETE PAD

LVL7A= 4-1 3/4" x 11 7/8" (4-45x300)

 $LVL8 = 2-13/4" \times 14" (2-45x356)$ 

 $LVL9 = 3-13/4" \times 14" (3-45x356)$ 

(REFER TO FLOOR PLAN FOR UNUSUAL SIZE PADS NOT ON CHART

## NOTE:

F1 = 42"x42"x18" CONCRETE PAD

F2 = 36"x36"x16" CONCRETE PAD

F3 = 30"x30"x12" CONCRETE PAD

F5 = 16"x16"x8" CONCRETE PAD

WHEN VENEER CUT IS GREATER THAN 26" A 10" POURED CONC. FOUNDATION WALL IS REQUIRED.

F1 = 48"x48"x20" CONCRETE PAD

F2 = 40"x40"x16" CONCRETE PAD

F3 = 34"x34"x14" CONCRETE PAD

#### NOTE:

ALL GARAGE SLABS, PORCH SLABS, STAIRS (EXPOSED CONC. FLAT WORK) TO BE 32 MPa WITH 5-8% AIR ENTRAITMENT.

## **BRICK VENEER LINTELS:**

 $WL1 = 3 \frac{1}{2} \times 3 \frac{1}{2} \times 1 \frac{4}{90 \times 90 \times 6} + 2 - 2 \times 8 \times SPR$ WL2 = 4" x 3 1\2" x 5\16" (100x90x8) + 2-2" x 8" SPR.  $WL3 = 5'' \times 3 \times 1/2'' \times 5/16'' (125 \times 90 \times 8) + 2 \cdot 2'' \times 10'' SPR.$ WL4 = 6" x 3 1\2" x 3\8" (150x90x10) + 2-2" x 12" SPR.

WL6 = 5" x 3 1\2" x 5\16" (125x90x8) + 2- 2" x 12" SPR. WL7 = 5" x 3 1\2" x 5\16" (125x90x8) + 3-2" x 10" SPR.  $WL8 = 5" \times 3 \times 12" \times 5 \times 16" (125 \times 90 \times 8) + 3 - 2" \times 12" SPR.$ WL9 = 6" x 4" x 3\8" {150x100x10} + 3-2" x 12" SPR.

WL5 = 6" x 4" x 3\8" (150x100x10) + 2-2" x 12" SPR.

## **WOOD LINTELS:**

WB1 = 2-2"x8" SPRUCE BEAM WB6 = 3-2" x 12" SPRUCE BEAM WB2 = 3-2"x8" SPRUCE BEAM WB7 = 5-2" x 12" SPRUCE BEAM WB3 = 2-2"x 10" SPRUCE BEAM WB10 = 4-2" x 8" SPRUCE BEAM WB4 = 3-2" x 10" SPRUCE BEAM WB11 = 4-2" x 10" SPRUCE BEAM


WB5 = 2-2" x 12" SPRUCE BEAM


## STEEL LINTELS:


 $L1 = 3.1 \times 3.1 \times 3.1 \times 1.4$  (90 x 90 x 6) L4 = 6" x 3 1\2" x 3\8" (150 x 90 x 10) L2 = 4" x 3 1\2" x 5\16" (100 x 90 x 8) L5 = 6" x 4" x 3\8" (150 x 100 x 10)  $L3 = 5' \times 3 \times 12'' \times 5 \times 16'' \times 125 \times 90 \times 8$   $L6 = 7'' \times 4'' \times 3 \times 100 \times 10$ 


## LAMINATED VENEER LUMBER (LVL BEAMS)


LVL1A =	1-1 3/4" x 7 1/4" (1-45x184)
LVL1 =	2-1 3/4" x 7 1/4" (2-45x184)
LVL2 =	3-1 3/4" x 7 1/4" (3-45x184)
LVL3 =	4-1 3/4" x 7 1/4" (4-45x184)
LVL4A =	1-1 3/4" x 9 1/2" (1-45x240)
LVL4 =	2-1 3/4" x 9 1/2" (2-45x240)
LVL5 =	3-1 3/4" x 9 1/2" (3-45x240)
LVL5A =	4-1 3/4" x 9 1/2" (4-45x240)
LVL6A=	1-1 3/4" x 11 7/8" (1-45x300)
LVL6 =	2-1 3/4" x 11 7/8" (2-45x300)
LVL7 =	3-1 3/4" x 11 7/8" (3-45x300)

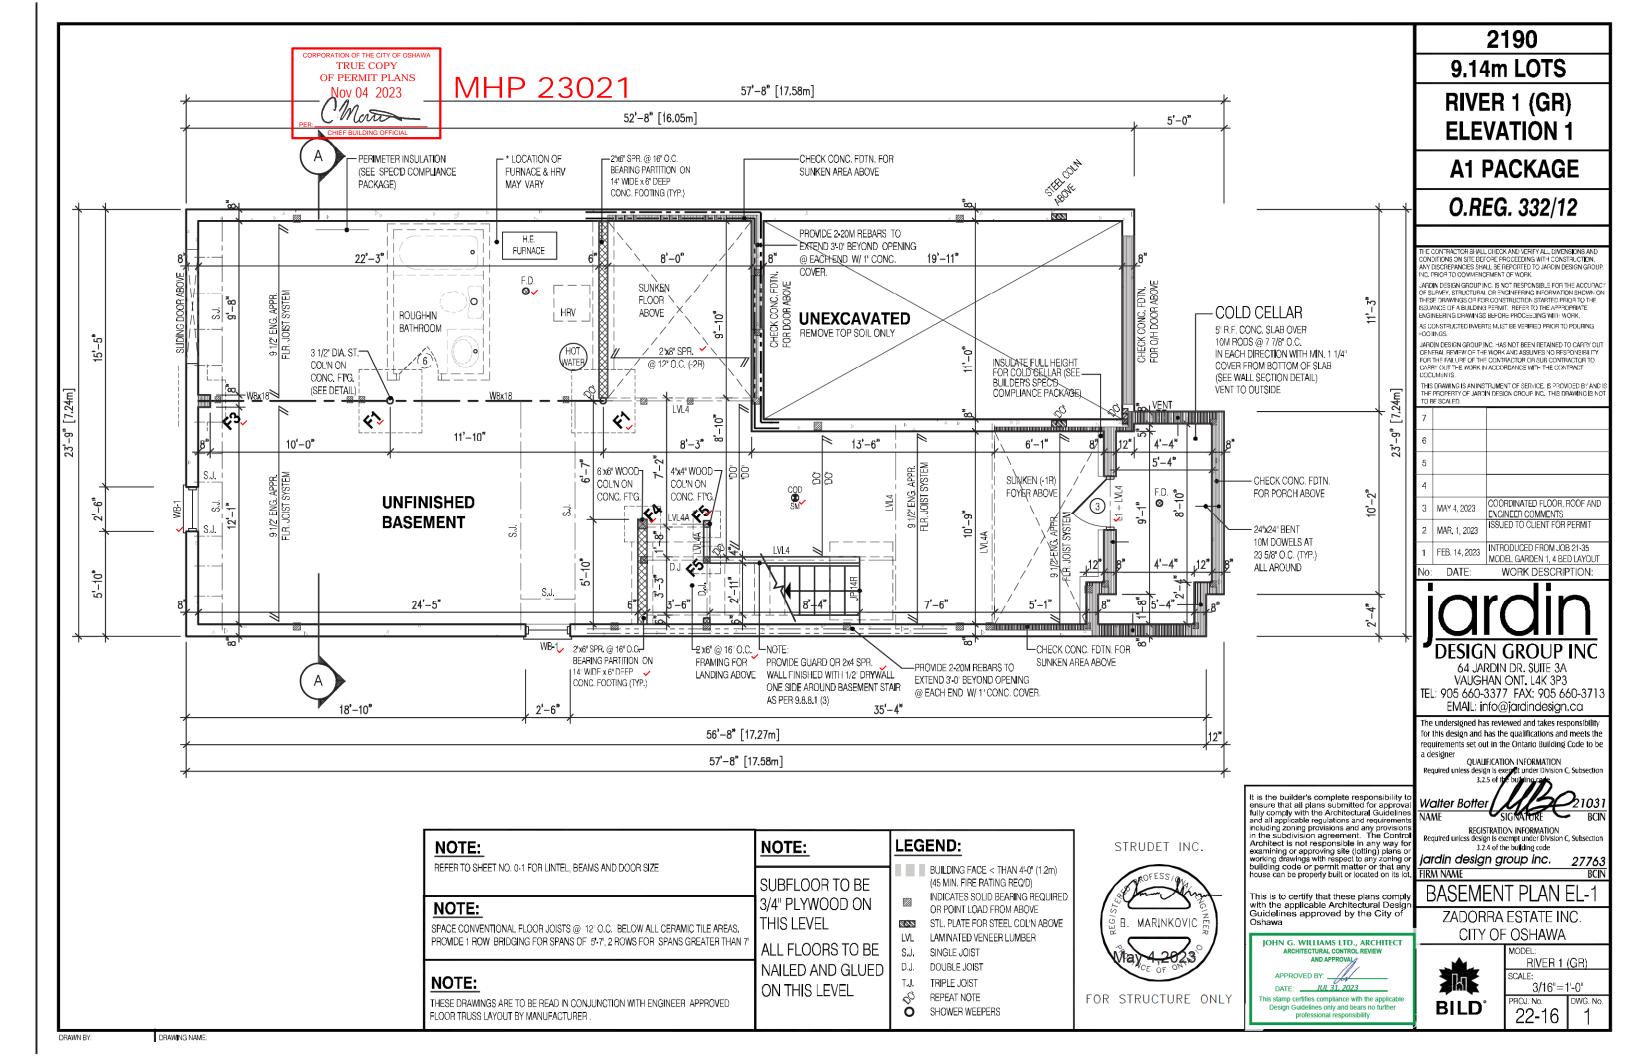


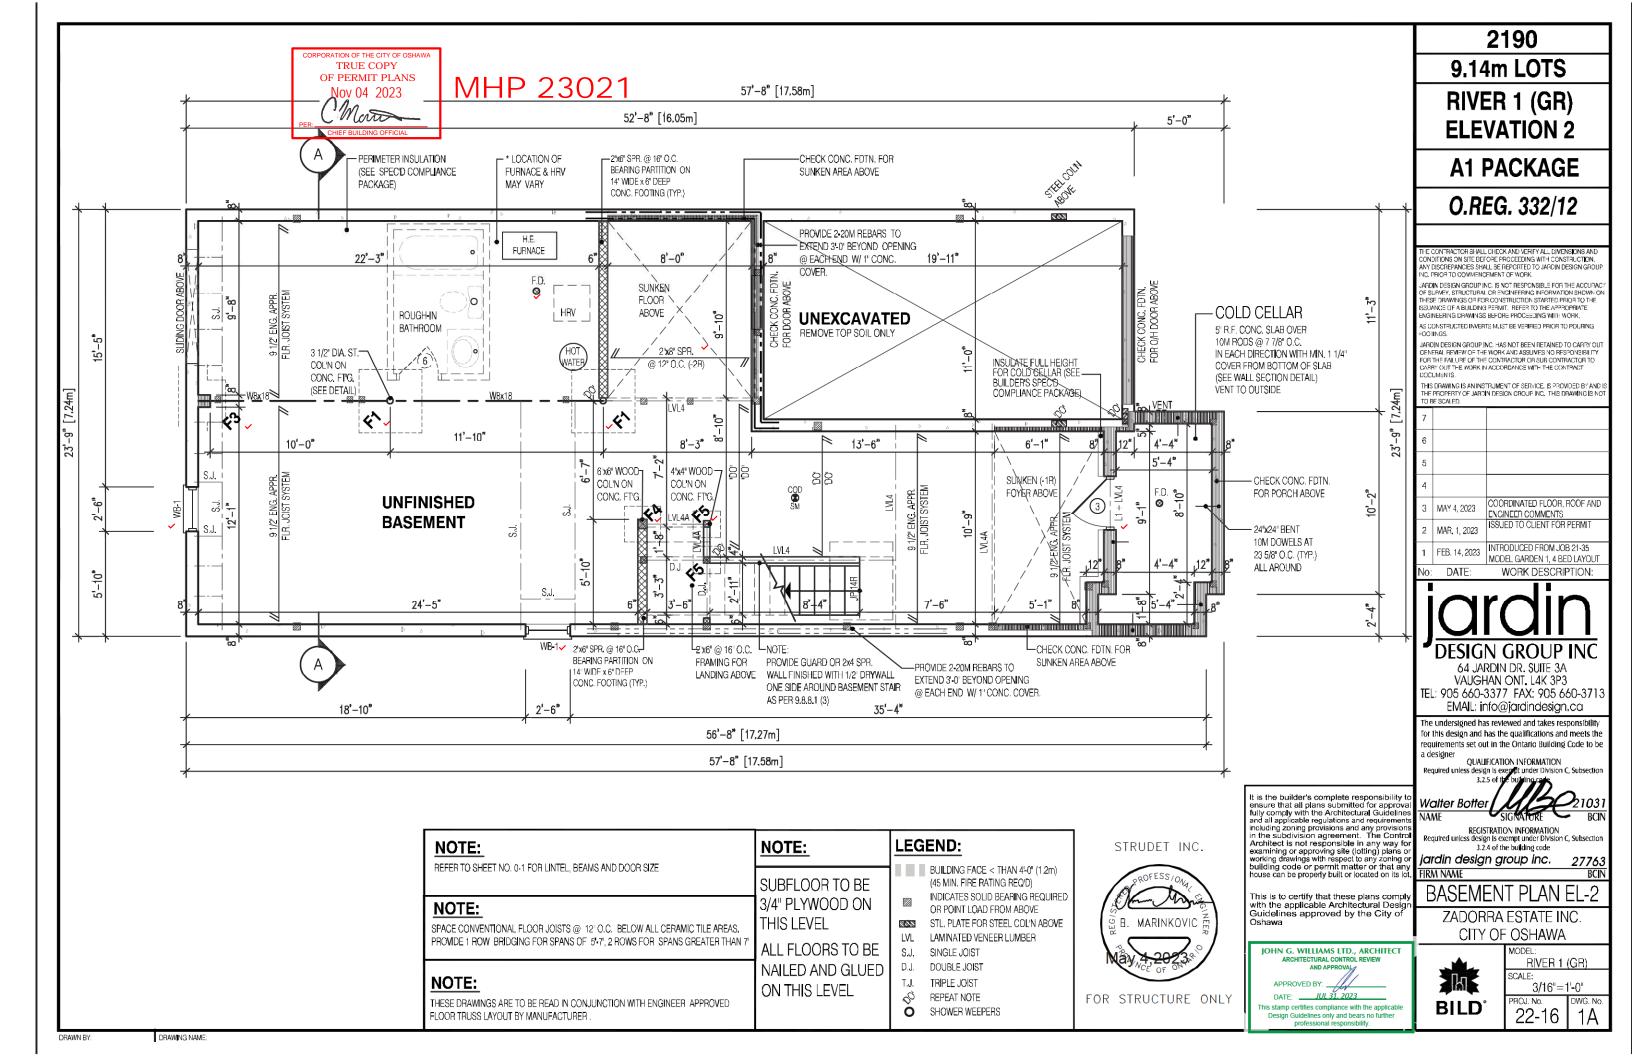


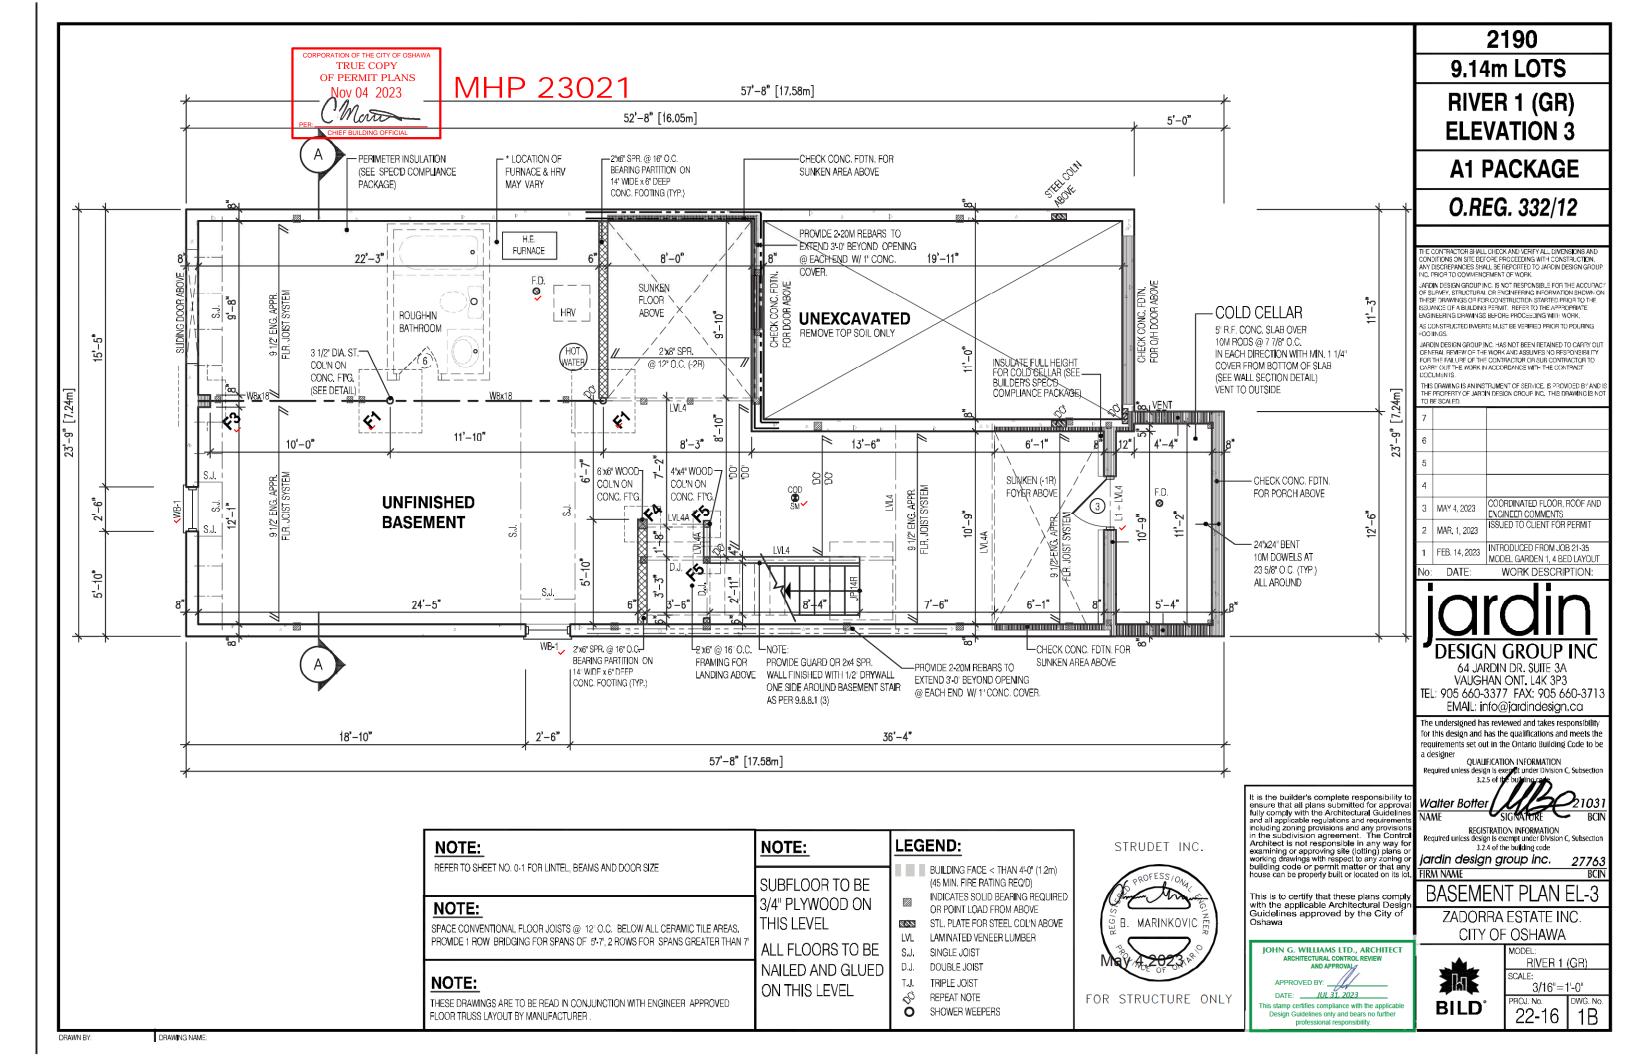


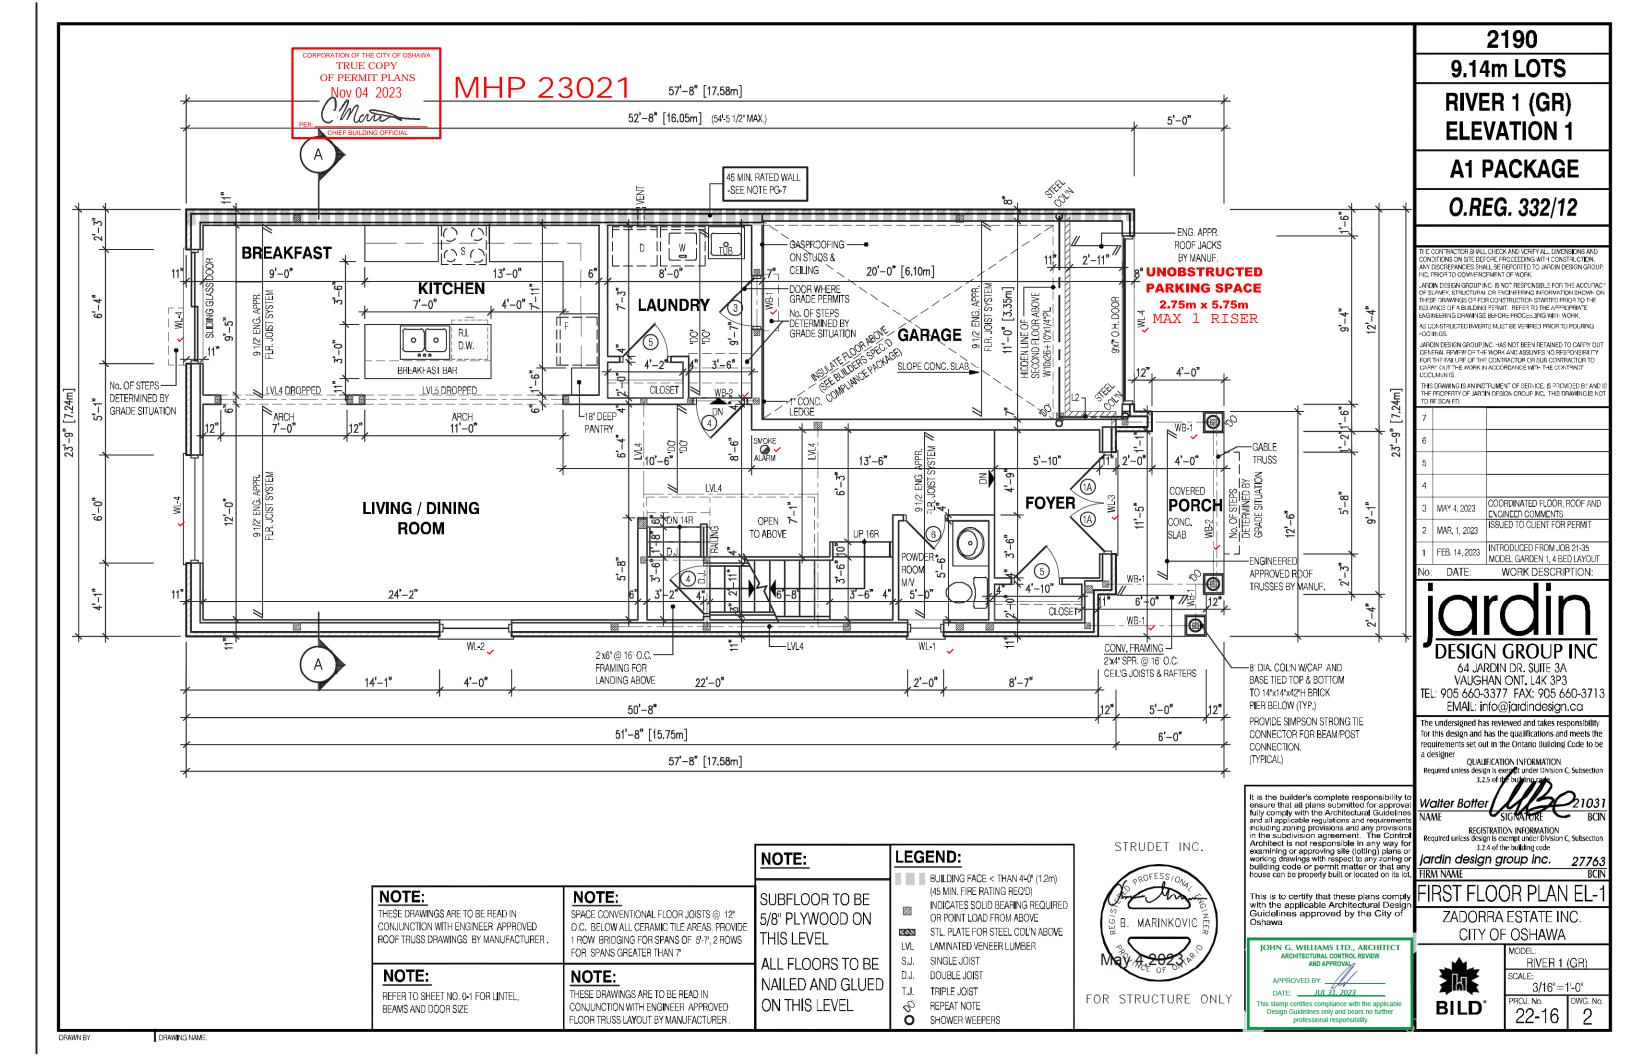


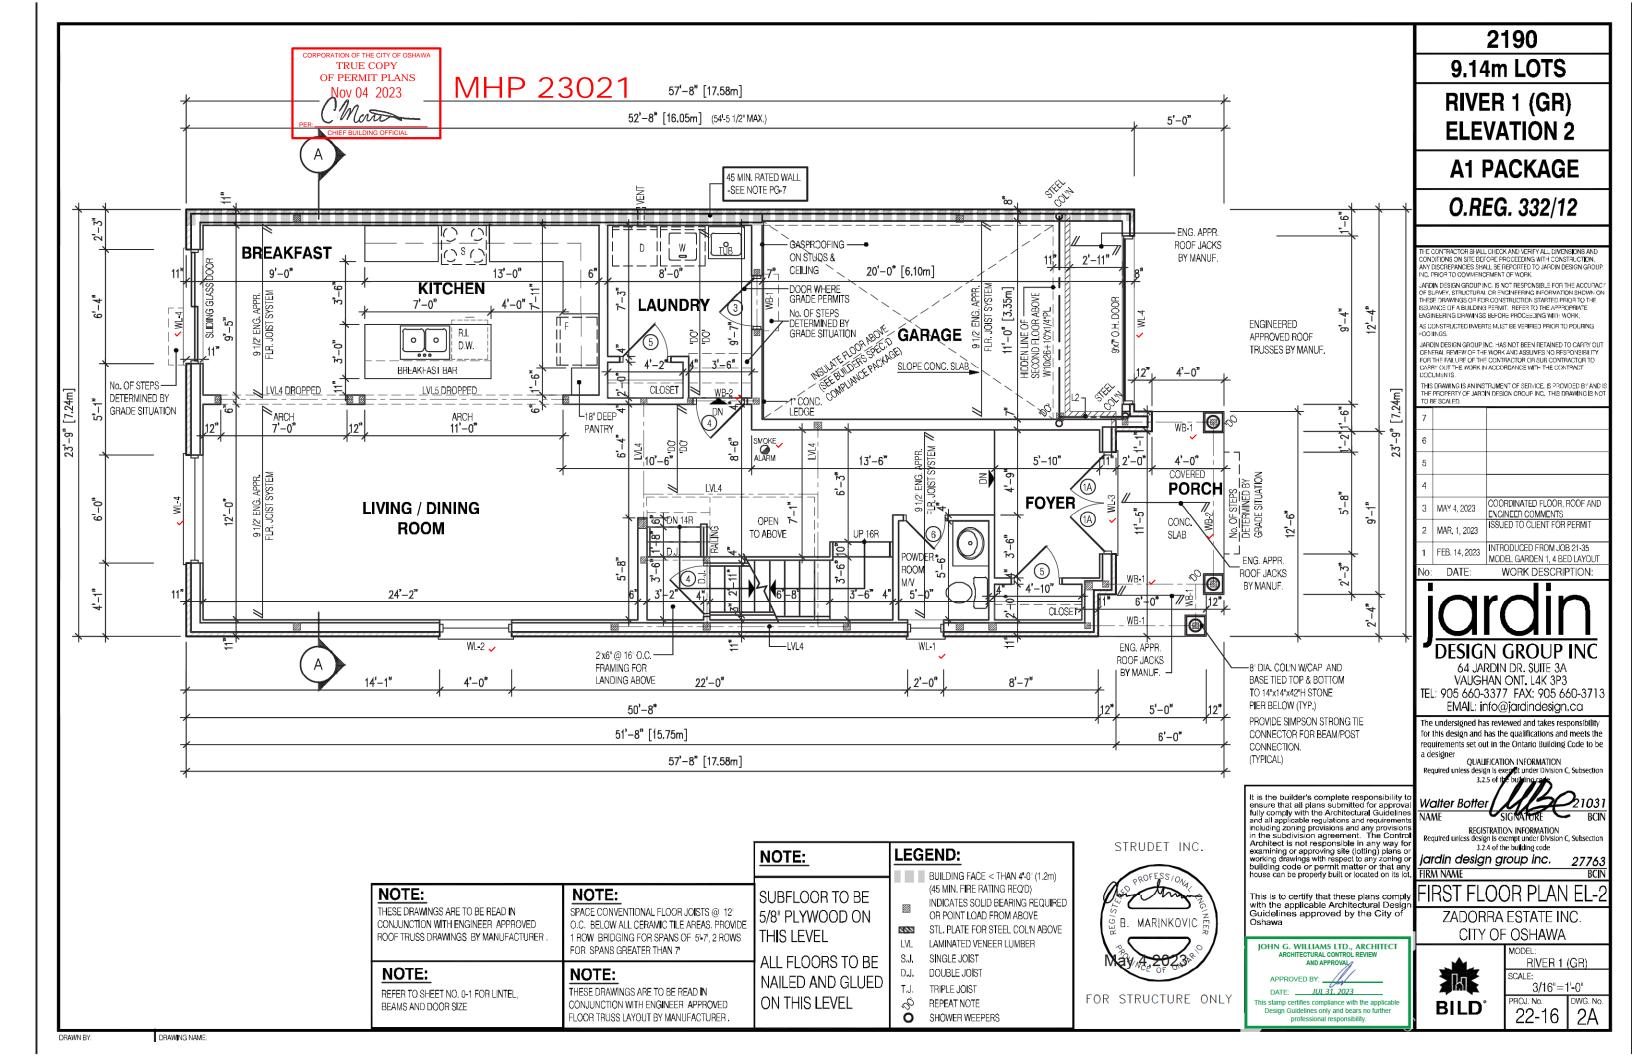


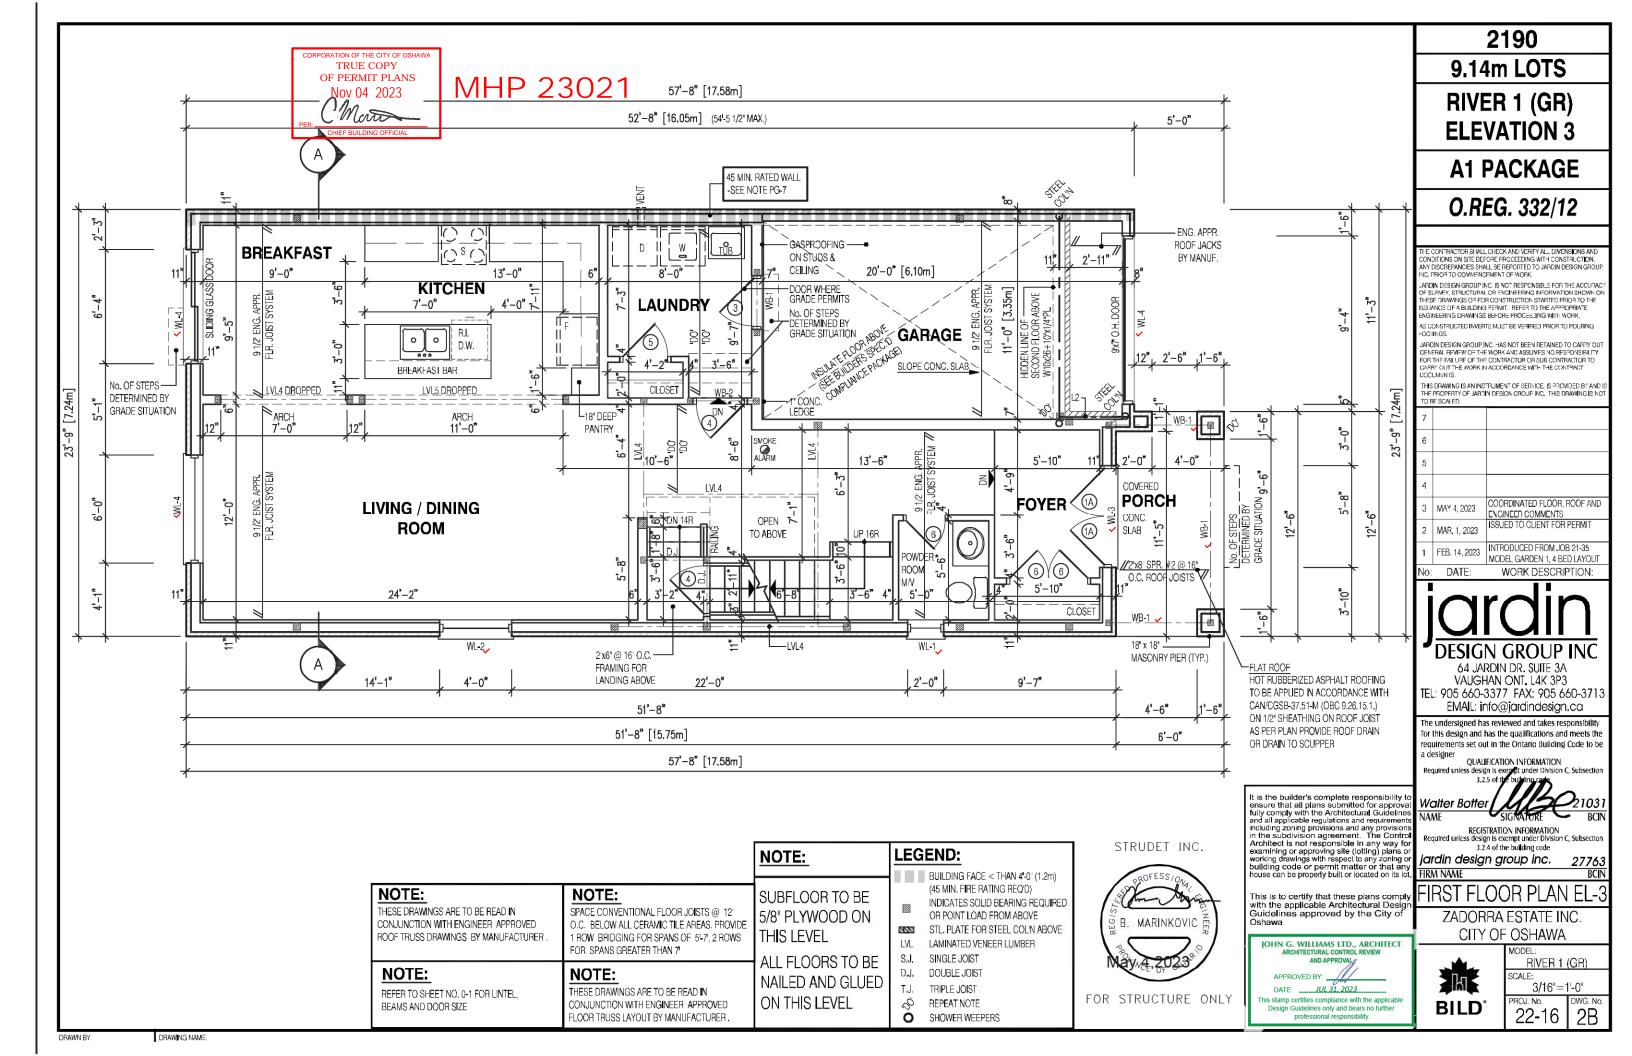


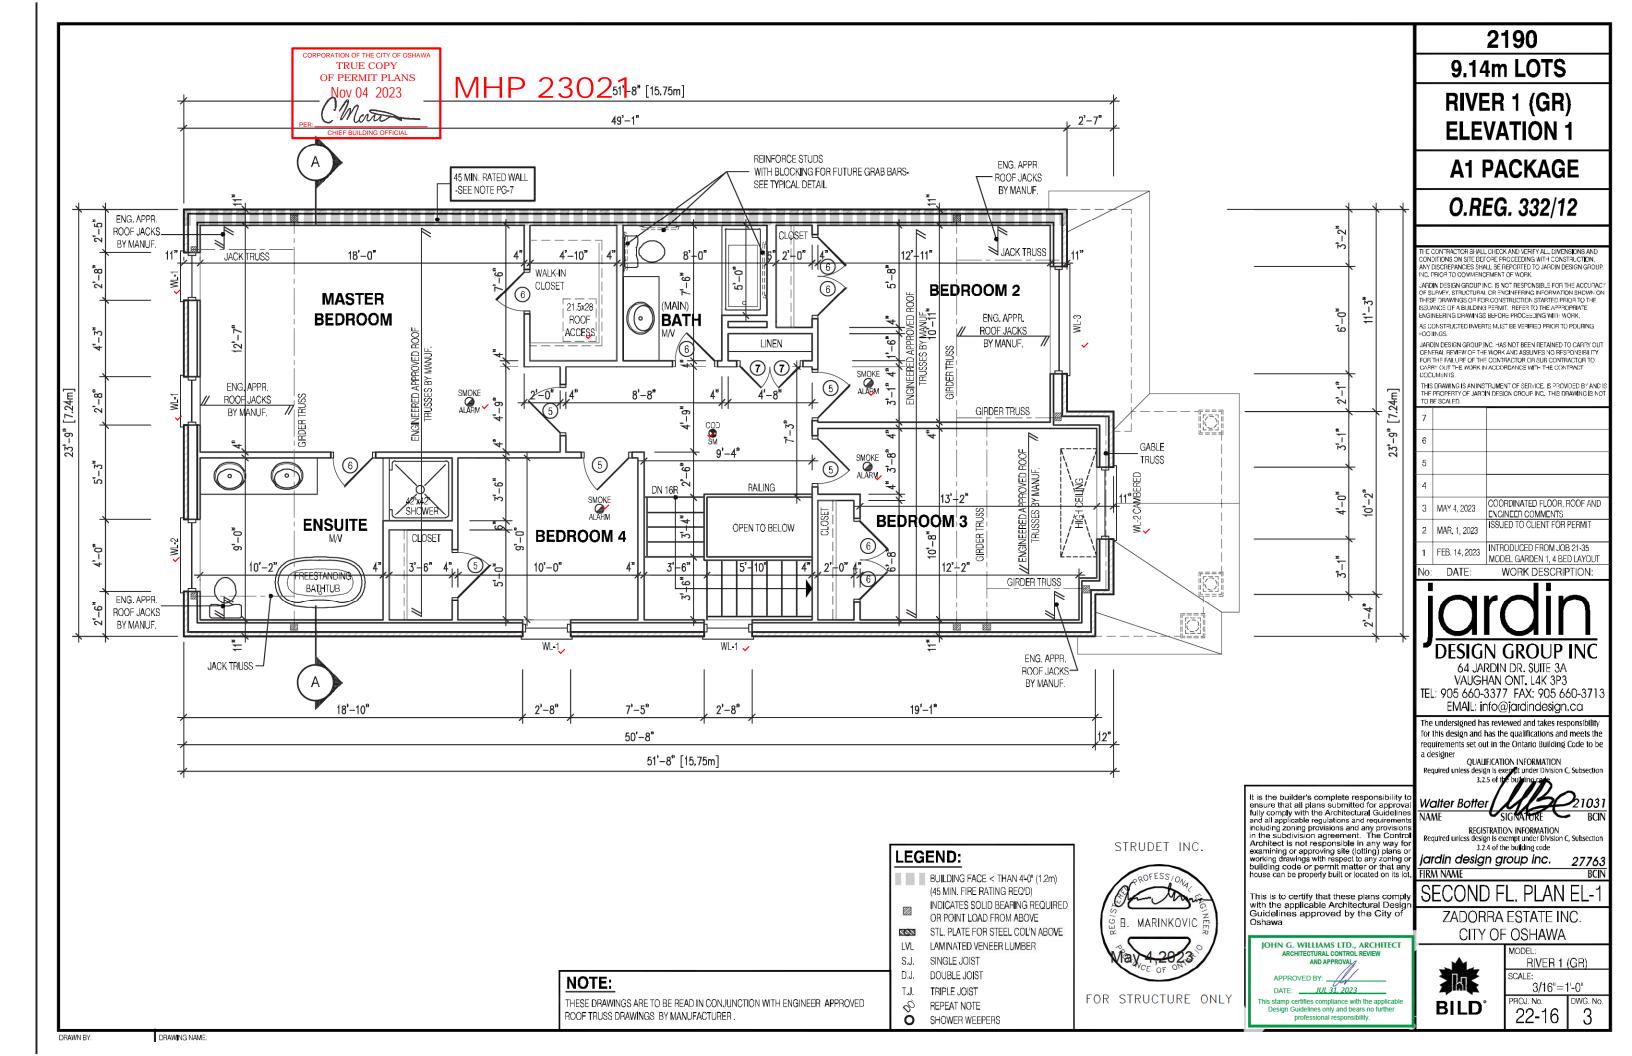


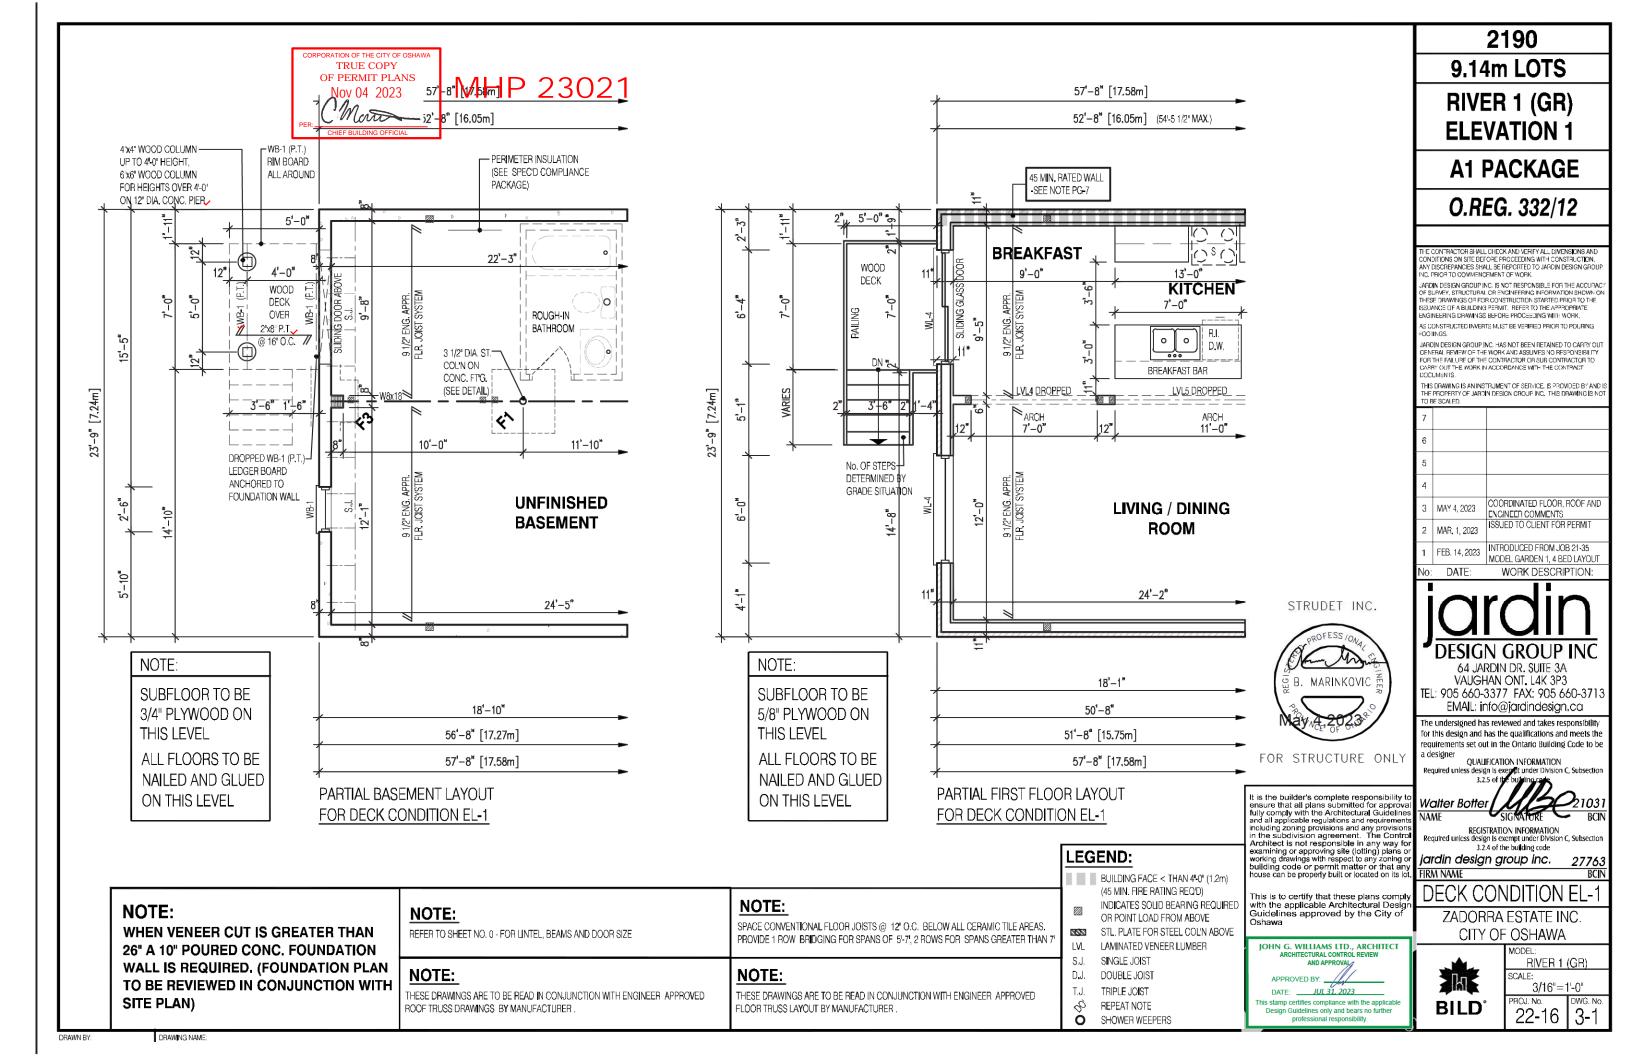


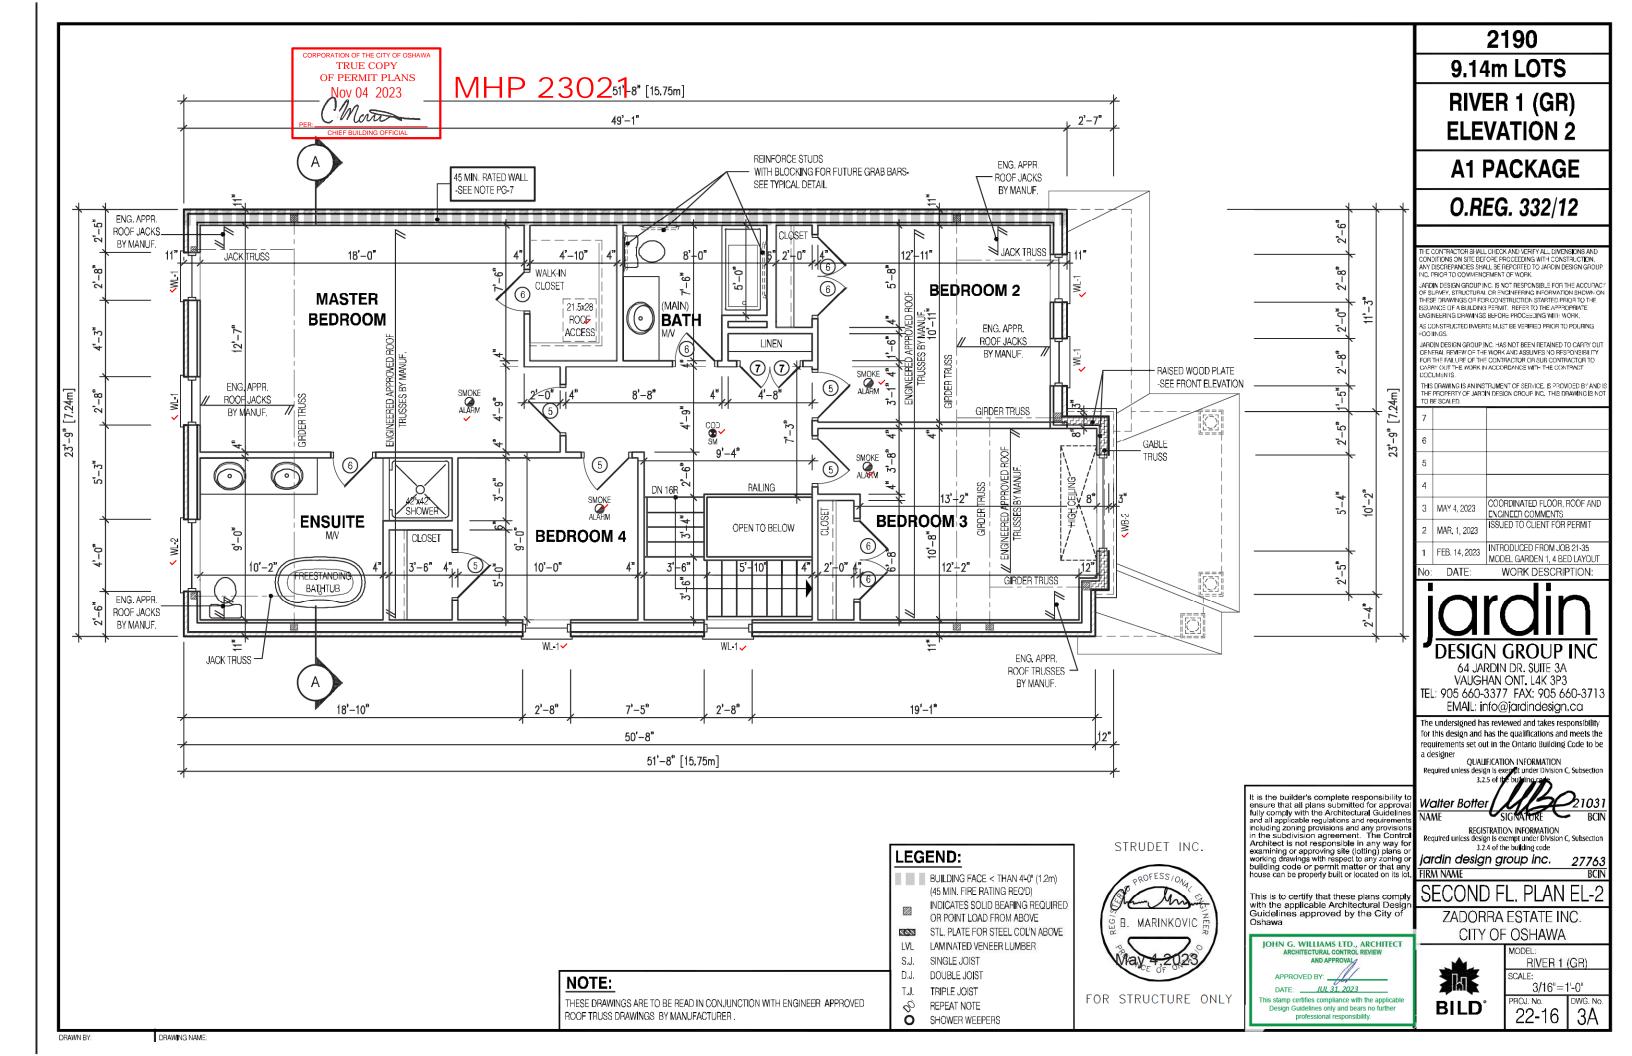


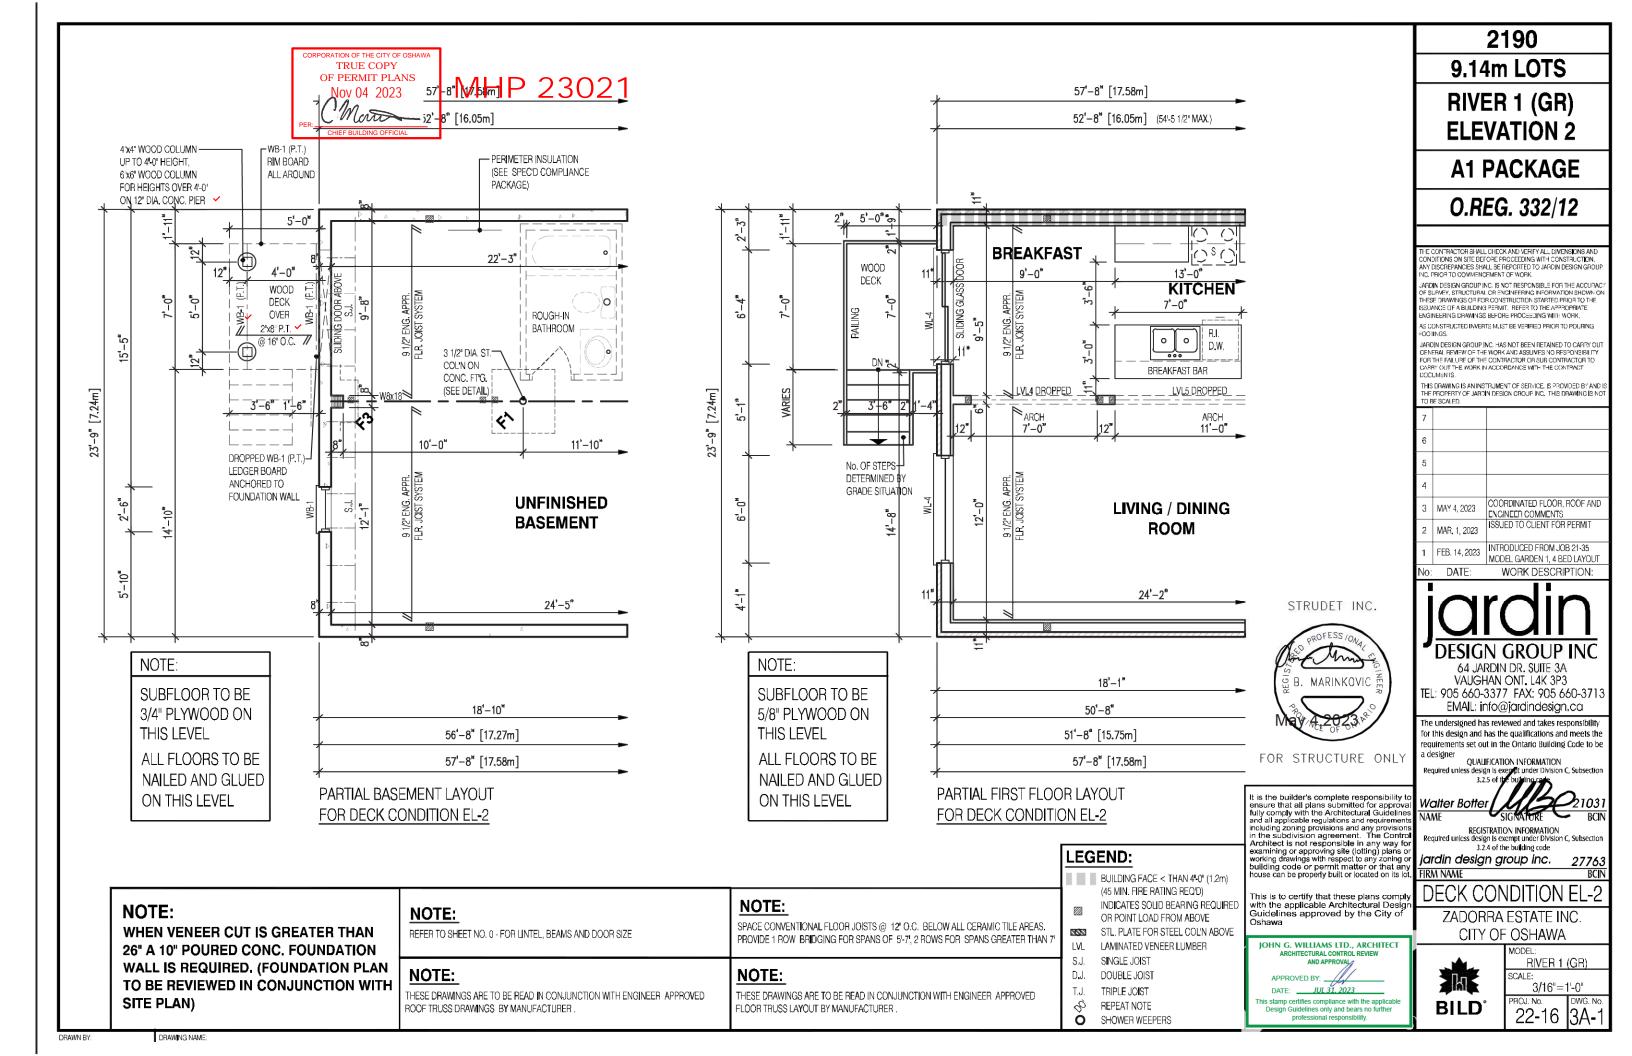

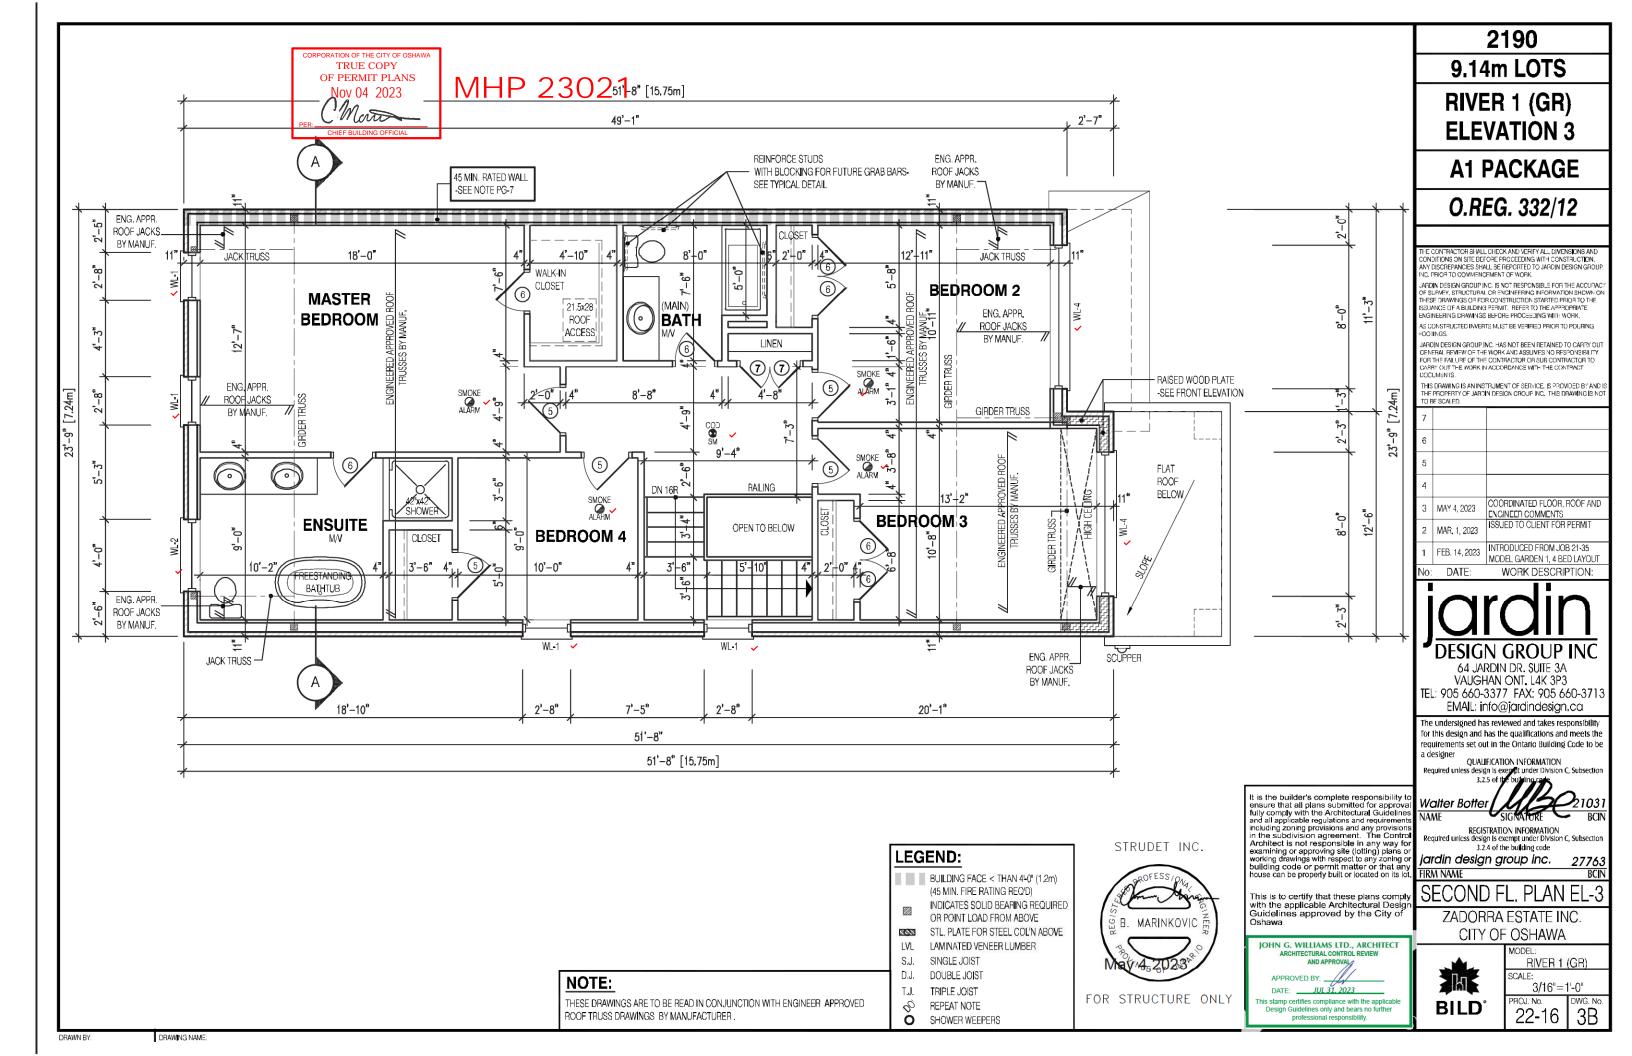

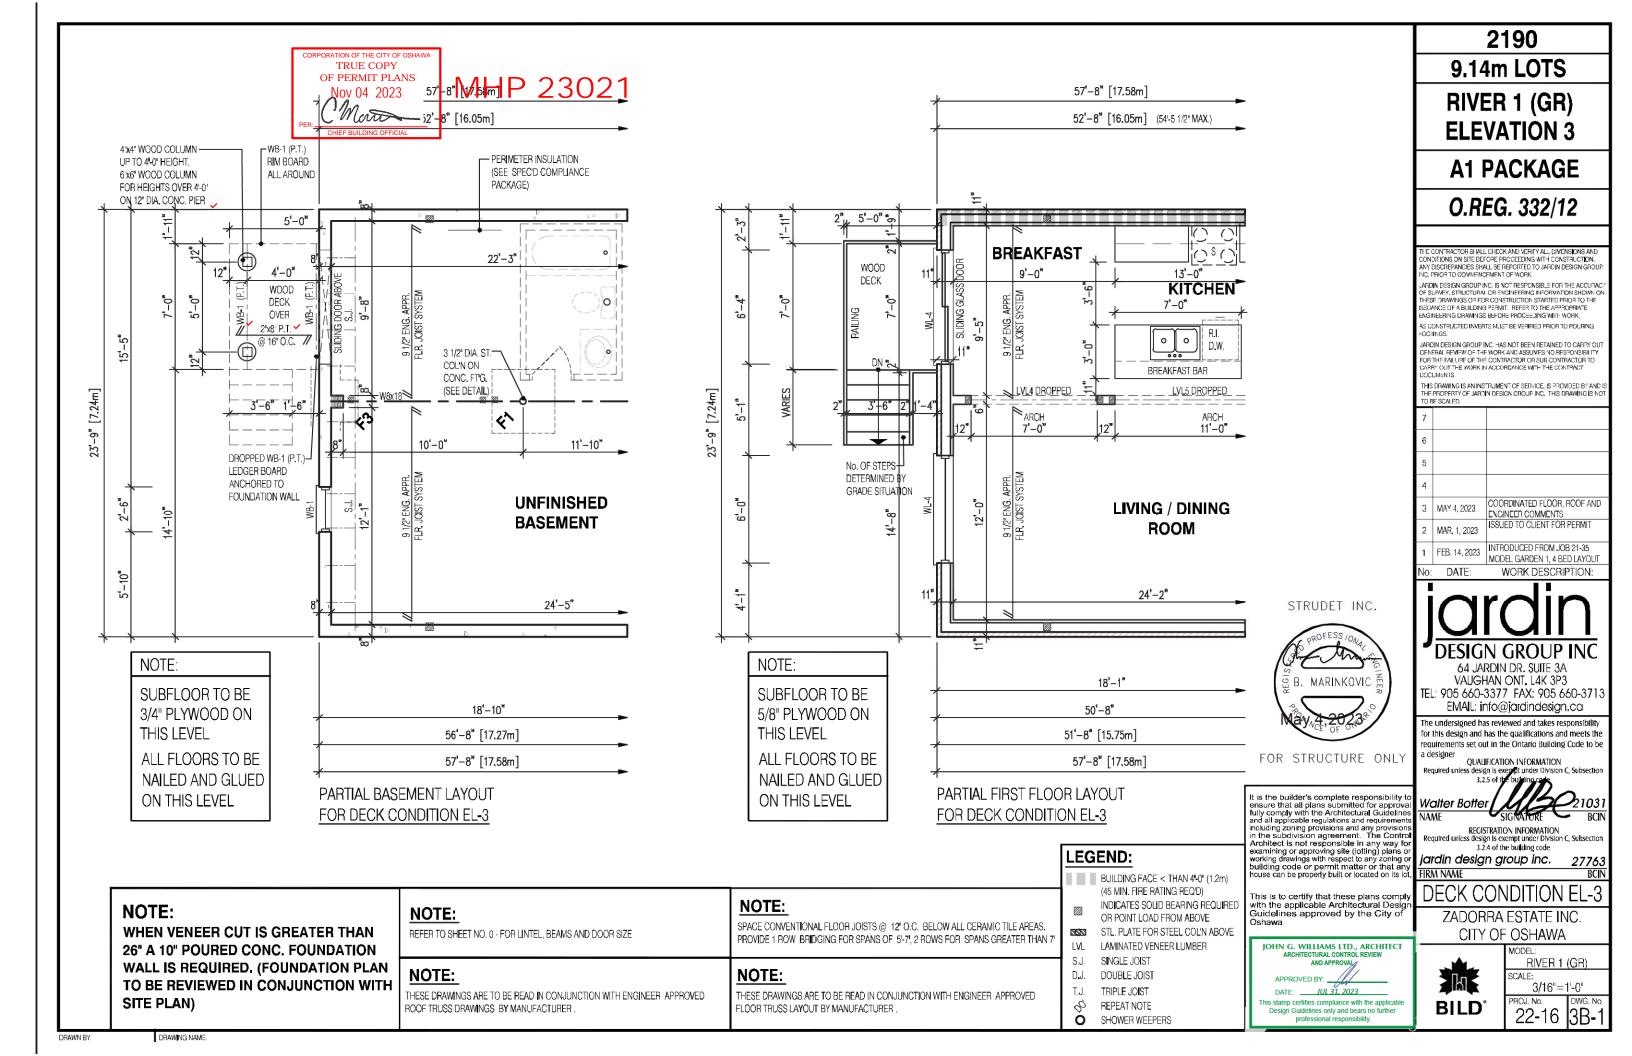

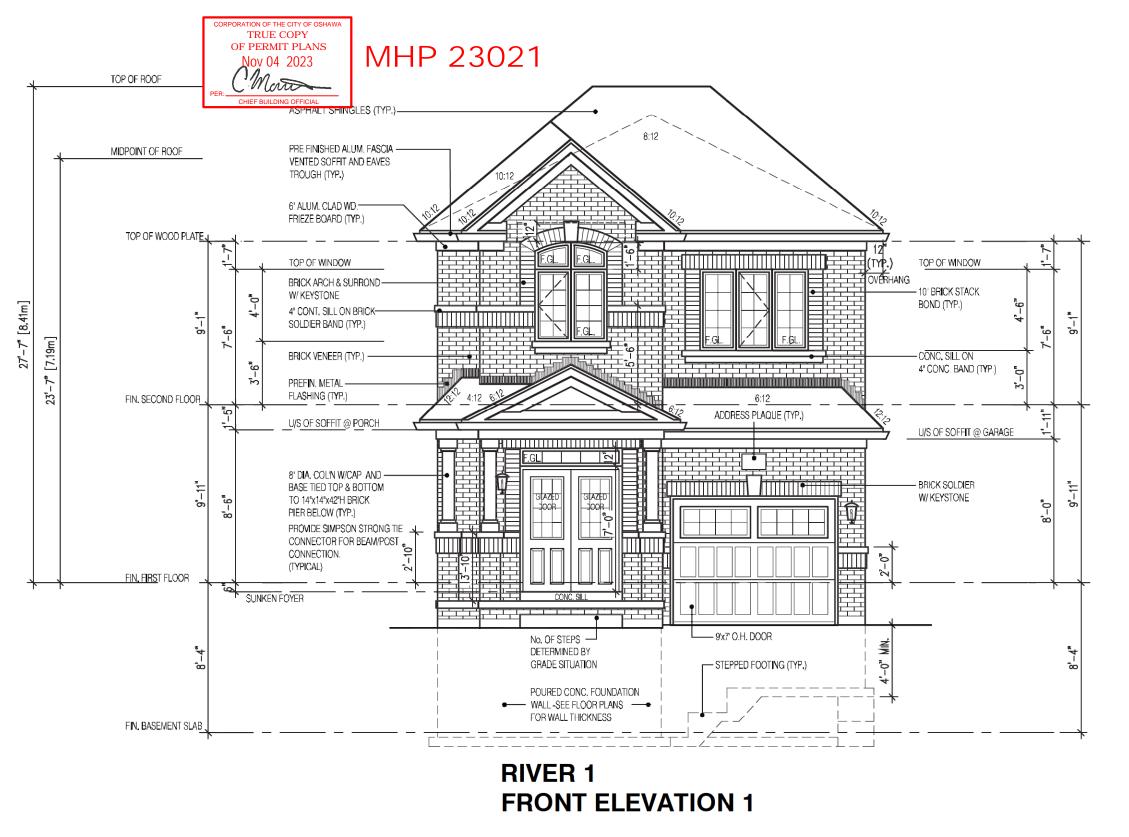

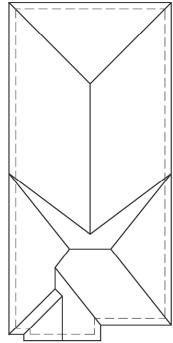

ROOF PLAN EL-1

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This is to certify that these plans comply with the applicable Architectural Design . Guidelines approved by the City of Oshawa

JOHN G. WILLIAMS LTD., ARCHITECT ARCHITECTURAL CONTROL REVIEW AND APPROVAL

APPROVED BY:

DATE: JUL 31, 2023

This stamp certifies compliance with the applicable Design Guidelines only and bears no further professional responsibility.

RIVER 1 (GR) ELEVATION 1

2190

9.14m LOTS

A1 PACKAGE

O.REG. 332/12

THE CON HACTOR STRALL CHILCK AND VEHITY ALL DIVENSIONS AND CONDITIONS ON SITE BEFORE PROCEEDING WITH CONSTRUCTION. ANY DISCREPANCIES SHALL BE REPORTED TO JARDIN DESIGN GROUP INC. PRIOR TO COVIMENCEMENT OF WORK.

JARDIN DESIGN GROUP INC. IS NOT RESPONSIBLE FOR THE ACCUPAC OF SURVEY, STRUCTURAL OR ENCONCERNING INFORMATION SHOWN ON THE STRUCTURAL OR ENCONCERNING INFORMATION STORT STUDINGS OR FOR CONSTRUCTION STRATED PRIOR TO THE INSURANCE OF A BUILDING PERMIT. REPER TO THE APPROPRIATE ENGINEERING DRAWINGS BEFORE PROCEEDING WITH WORK,

AS CONSTRUCTED INVERTS MUST BE VERIFIED PRIOR TO POURING FOOTINGS.

JARDIN DESIGN GROUP INC. HAS NOT BEEN RETAINED TO CARRY OUT CENERAL REVIEW OF THE WORK AND ASSUVES NO RESPONSIBILITY FOR THE FAILURE OF THE CONTRACTOR OR SUB-CONTRACTOR TO CARRY OUT THE WORK IN ACCORDANCE WITH THE CONTRACT COCUMENTS.

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	3	MAY 4, 2023	COORDINATED FLOOR, ROOF AND ENGINEER COMMENTS
	2	MAR. 1, 2023	ISSUED TO CLIENT FOR PERMIT
	1	FEB. 14, 2023	INTRODUCED FROM JOB 21-35 MODEL GARDEN 1, 4 BED LAYOUT
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jardin DESIGN GROUP IN

64 JARDIN DR. SUITE 3A VAUGHAN ONT. L4K 3P3 TEL: 905 660-3377 FAX: 905 660-3713 EMAIL: info@jardindesign.ca

The undersigned has reviewed and takes responsibility for this design and has the qualifications and meets the requirements set out in the Ontario Building Code to be a designer

QUALIFICATION INFORMATION ed unless design is exempt under Division C, Subsed 3.2.5 of the building code

Walter Botter Signature B

REGISTRATION INFORMATION
Required unless design is exempt under Division C, Subsection
3.2.4 of the building code

3.2.4 of the building code jardin design group inc.

iardin design group TRM NAME


FRONT ELEVATION 1


ZADORRA ESTATE INC. CITY OF OSHAWA

BILD'

MODEL: RIVER 1 (GR) SCALE: 3/16"=1'-0"

SCALE: 3/16"=1'-0" PROJ. No. DWG. No. 22-16 4

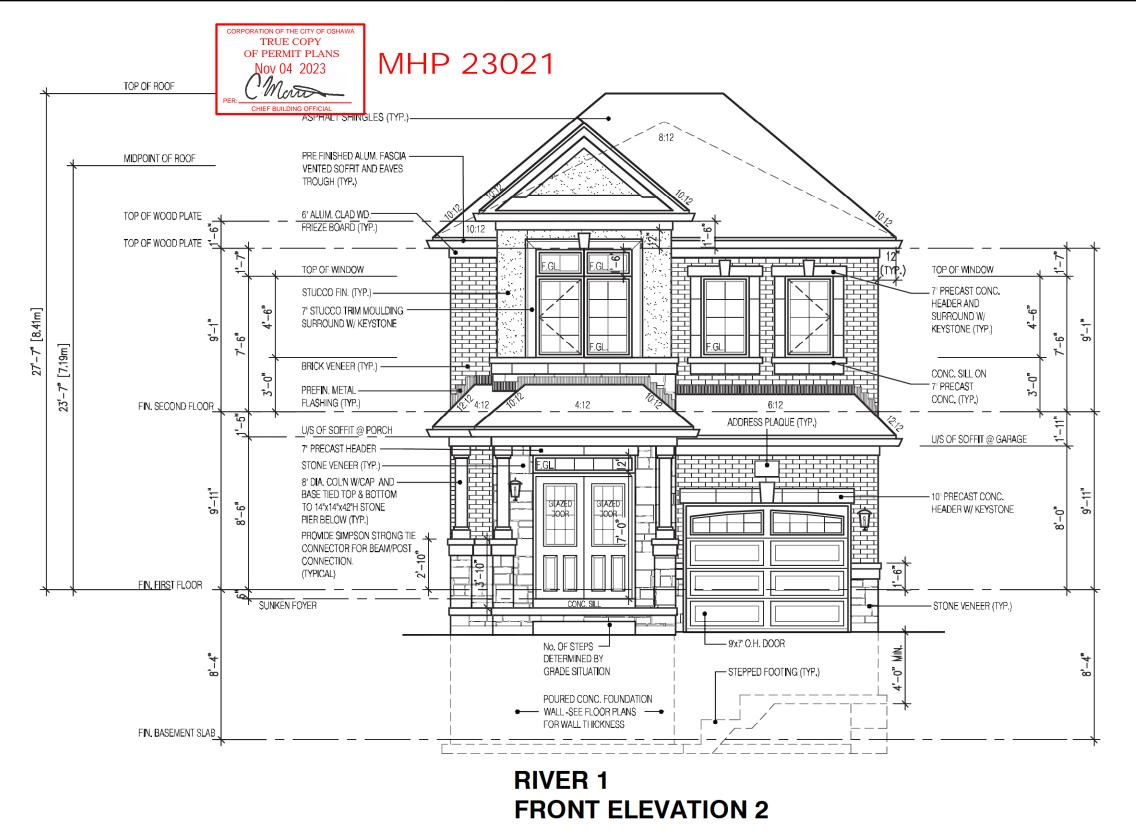

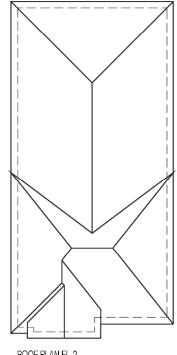

ROOF PLAN EL-2 N.T.S.

2190

9.14m LOTS

RIVER 1 (GR) **ELEVATION 2** 

A1 PACKAGE

O.REG. 332/12

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2	MAR, 1, 2023	ISSUED TO CLIENT FOR PERMIT
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No:	DATE:	WORK DESCRIPTION:



64 JARDIN DR. SUITE 3A VAUGHAN ONT, L4K 3P3 TEL: 905 660-3377 FAX: 905 660-3713 EMAL: info@jardindesign.ca

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QUALIFICATION INFORMATION

Walter Botter NAME

REGISTRATION INFORMATION
Required unless design is exempt under Division C, Subsection

3.2.4 of the building code jardin design group inc.

IRM NAME

FRONT ELEVATION 2

ZADORRA ESTATE INC. CITY OF OSHAWA

RIVER 1 (GR)

3/16"=1'-0"




SCALE: PROJ. No. 22-16


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t is the builder's complete responsibility

JOHN G. WILLIAMS LTD., ARCHITECT AND APPROVAL APPROVED BY:

JUL 31, 2023 This stamp certifies compliance with the applicable Design Guidelines only and bears no further



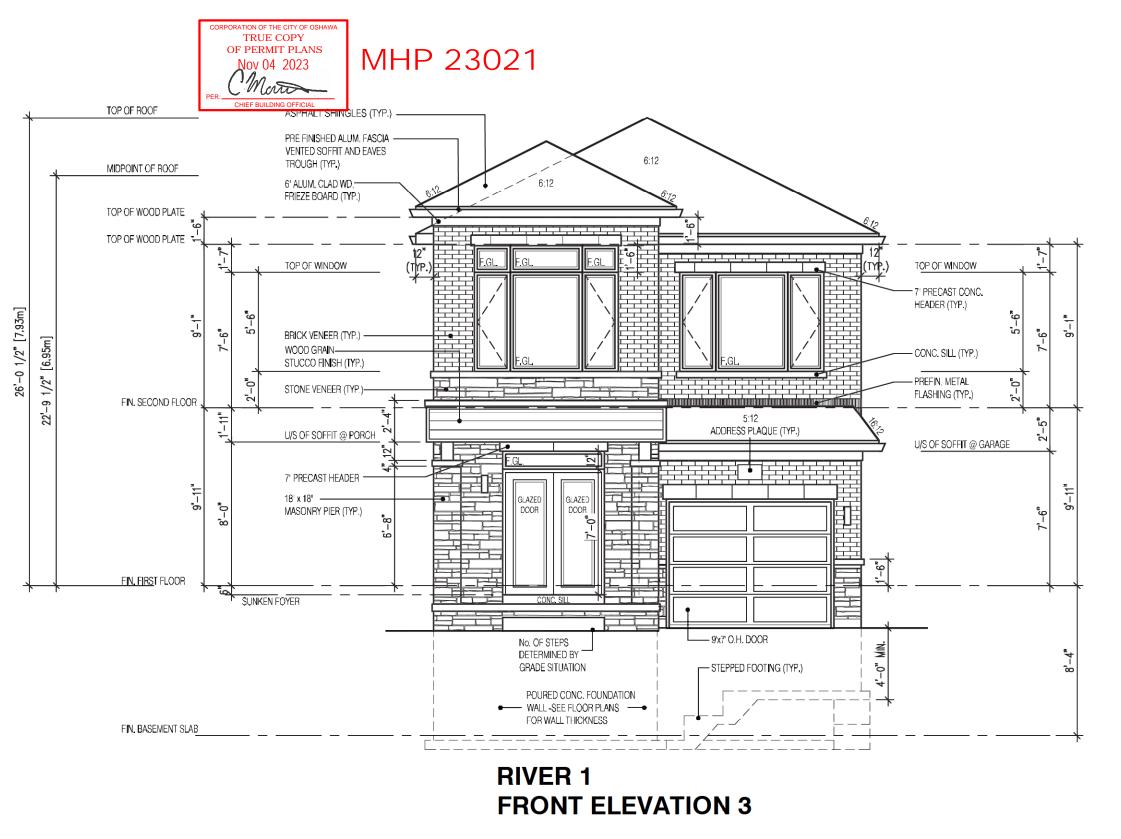

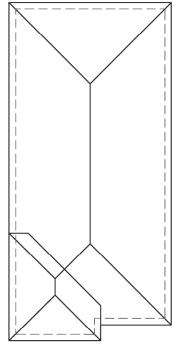ROOF PLAN EL-3

9.14m LOTS

2190

RIVER 1 (GR) **ELEVATION 3** 

A1 PACKAGE

O.REG. 332/12

CONDITIONS ON SITE BEFORE PROCEEDING WITH CONSTRUCTION, ANY DISCREPANCIES SHALL BE REPORTED TO JARDIN DESIGN GROUING. PRIOR TO COMMENCEMENT OF WORK.

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3	MAY 4, 2023	COORDINATED FLOOR, ROOF AND ENGINEER COMMENTS
2	MAR. 1, 2023	ISSUED TO CLIENT FOR PERMIT
1	FEB. 14, 2023	INTRODUCED FROM JOB 21-35 MODEL GARDEN 1, 4 BED LAYOUT
No:	DATE:	WORK DESCRIPTION:

64 JARDIN DR. SUITE 3A VAUGHAN ONT. L4K 3P3 TEL: 905 660-3377 FAX: 905 660-3713 EMAL: info@jardindesign.ca

The undersigned has reviewed and takes responsibility for this design and has the qualifications and meets the requirements set out in the Ontario Building Code to be a designer

QUALIFICATION INFORMATION

Walter Botter NAME

REGISTRATION INFORMATION
Required unless design is exempt under Division C, Subsection 3.2.4 of the building code

jardin design group inc.

IRM NAME

FRONT ELEVATION 3

RIVER 1 (GR)

3/16"=1'-0"

4B

PROJ. No.

ZADORRA ESTATE INC. CITY OF OSHAWA



This is to certify that these plans comply with the applicable Architectural Design Guidelines approved by the City of JOHN G. WILLIAMS LTD., ARCHITECT

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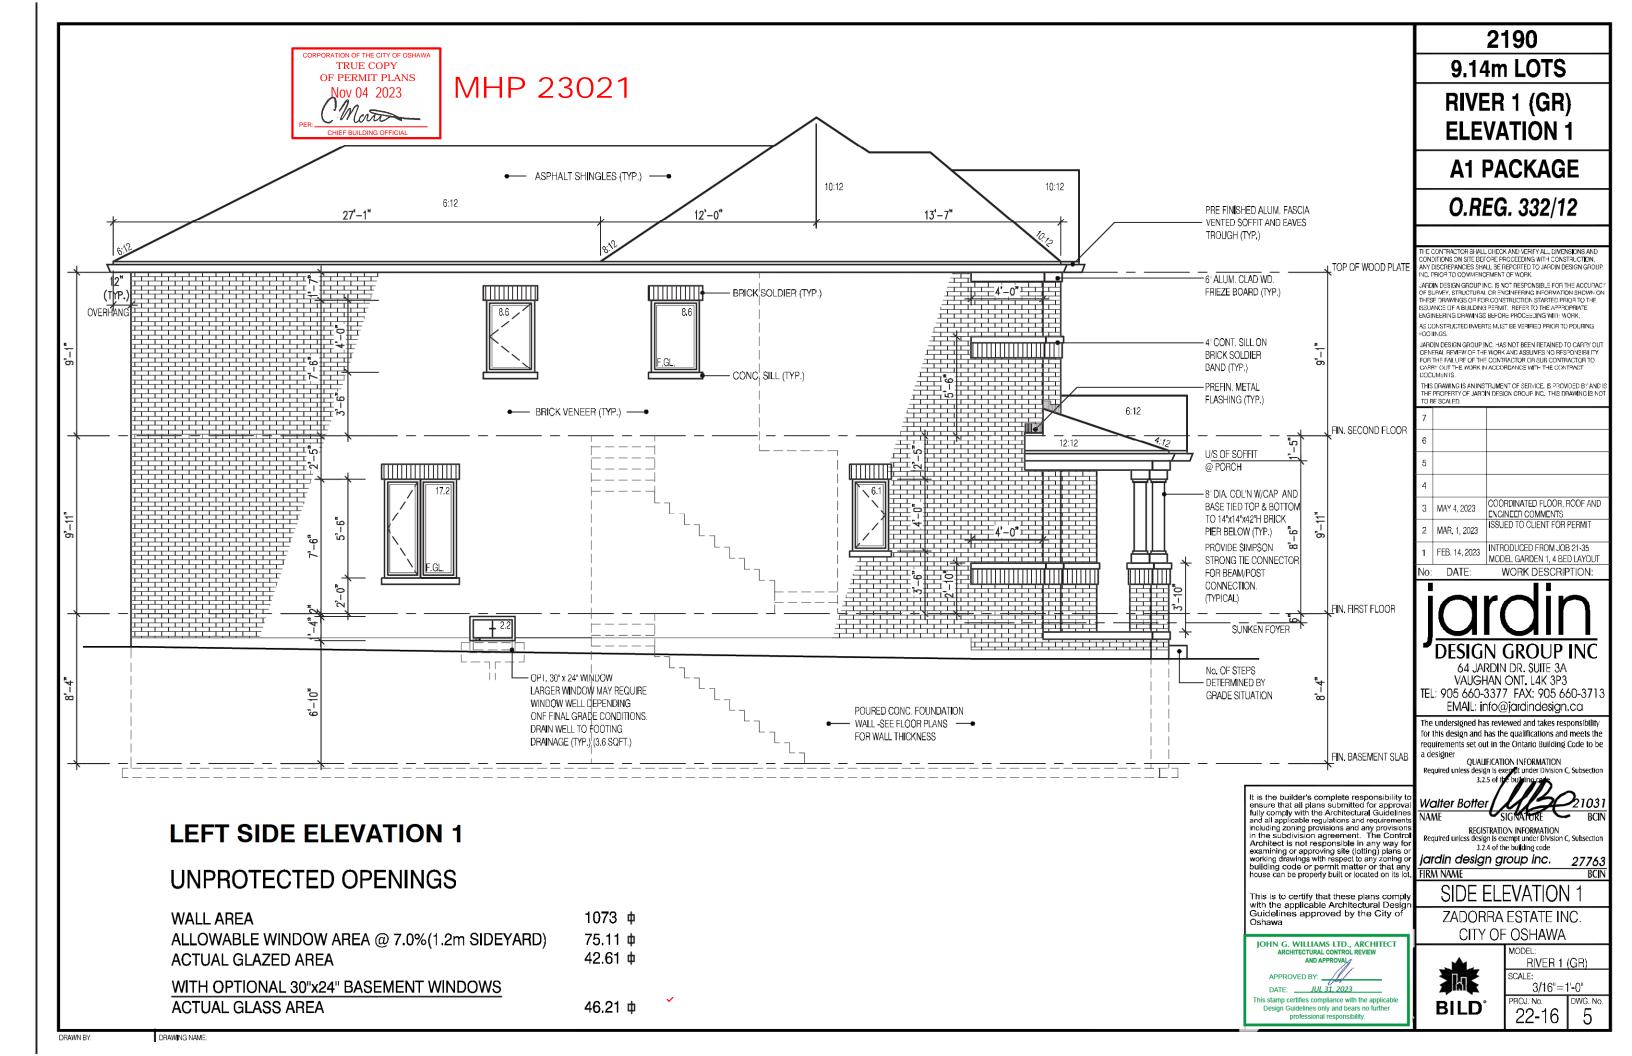
house can be properly built or located on its I


AND APPROVAL


JUL 31, 2023 his stamp certifies compliance with the applicable Design Guidelines only and bears no further


professional responsibility.

SCALE: 22-16



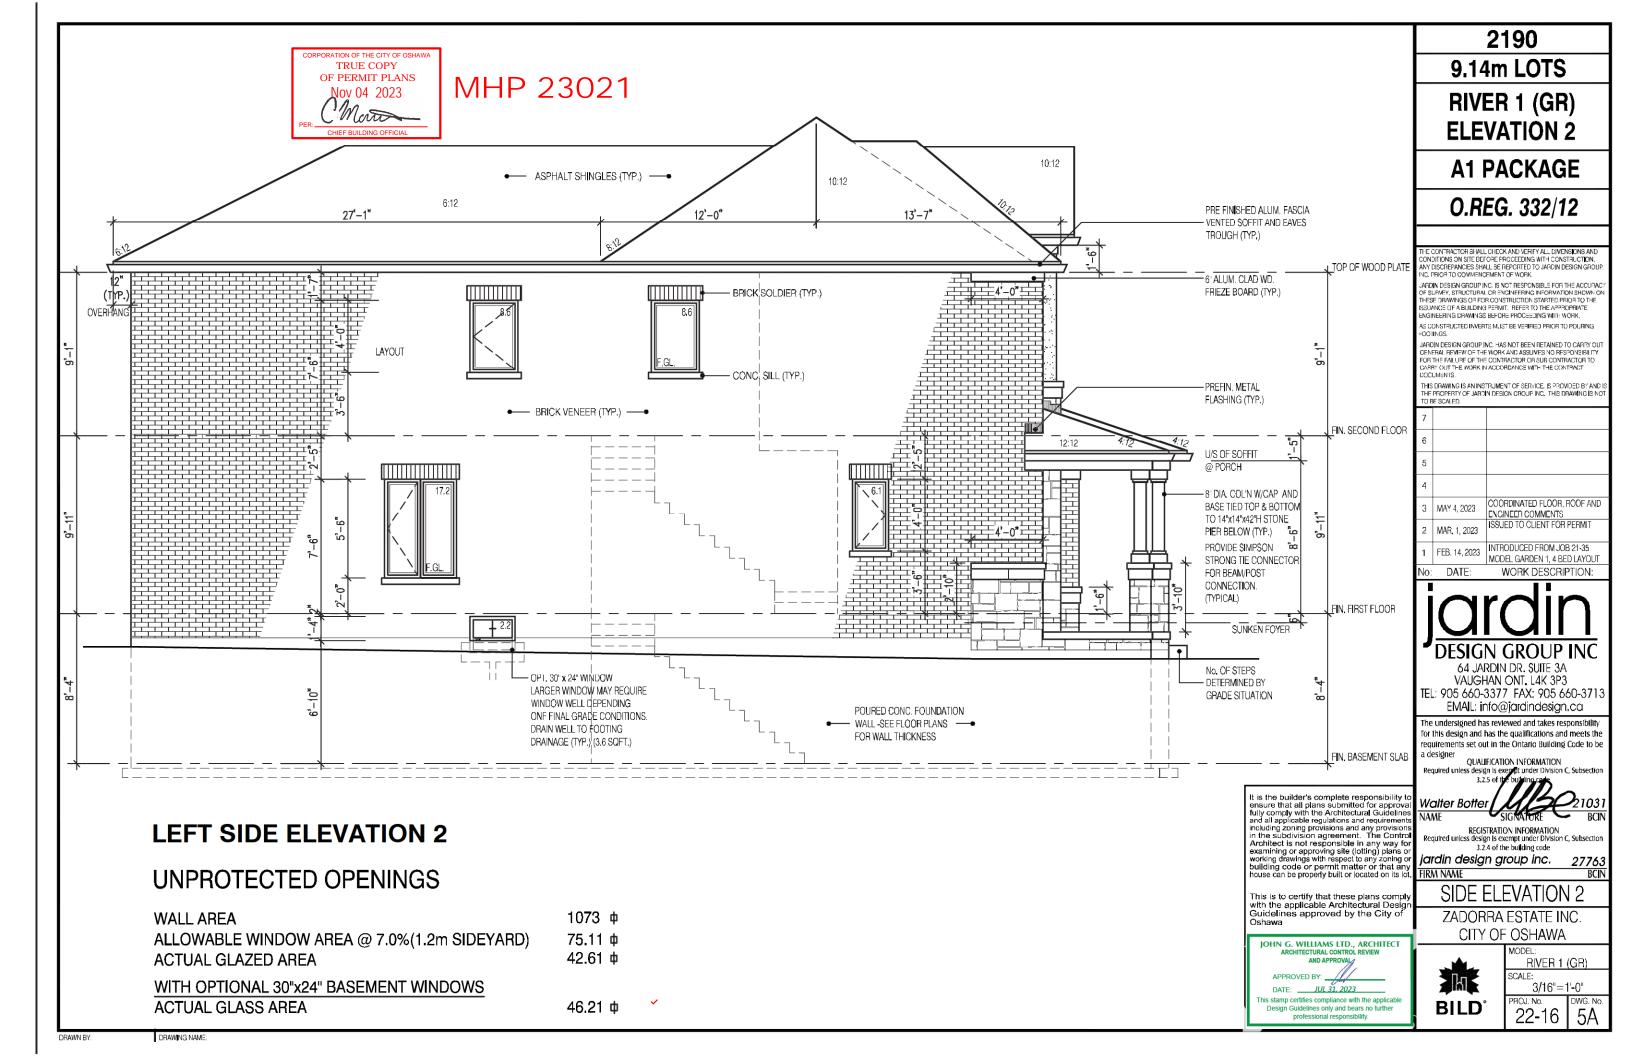

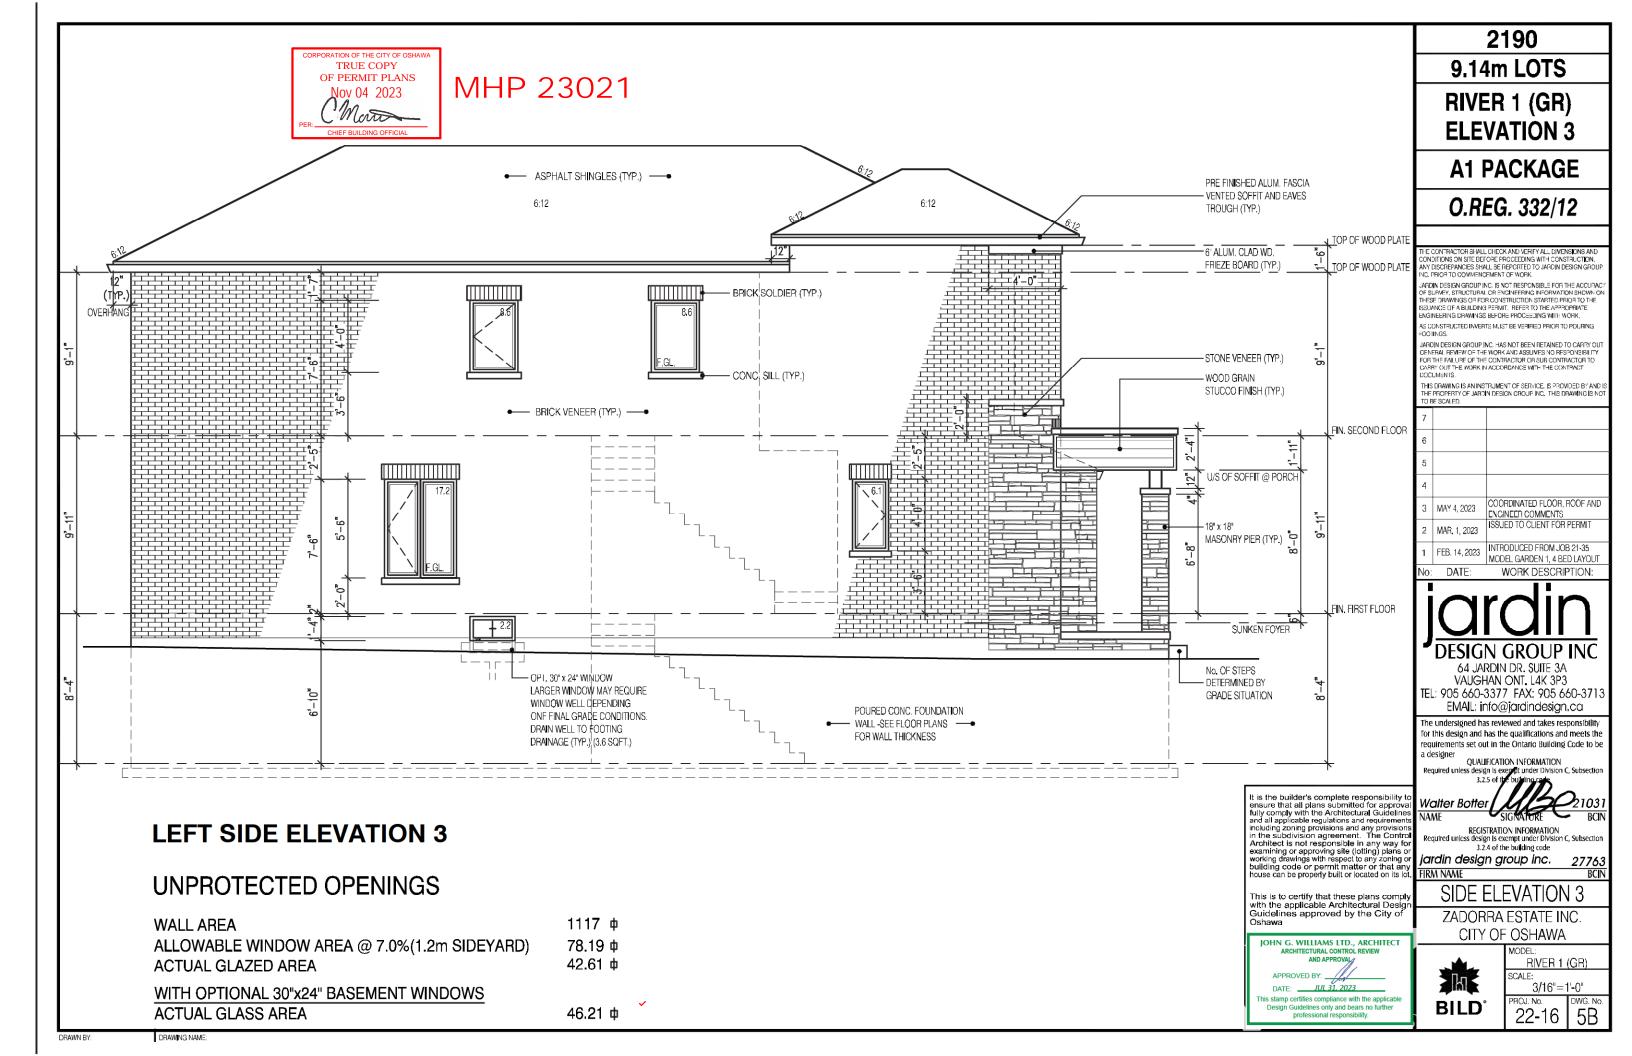

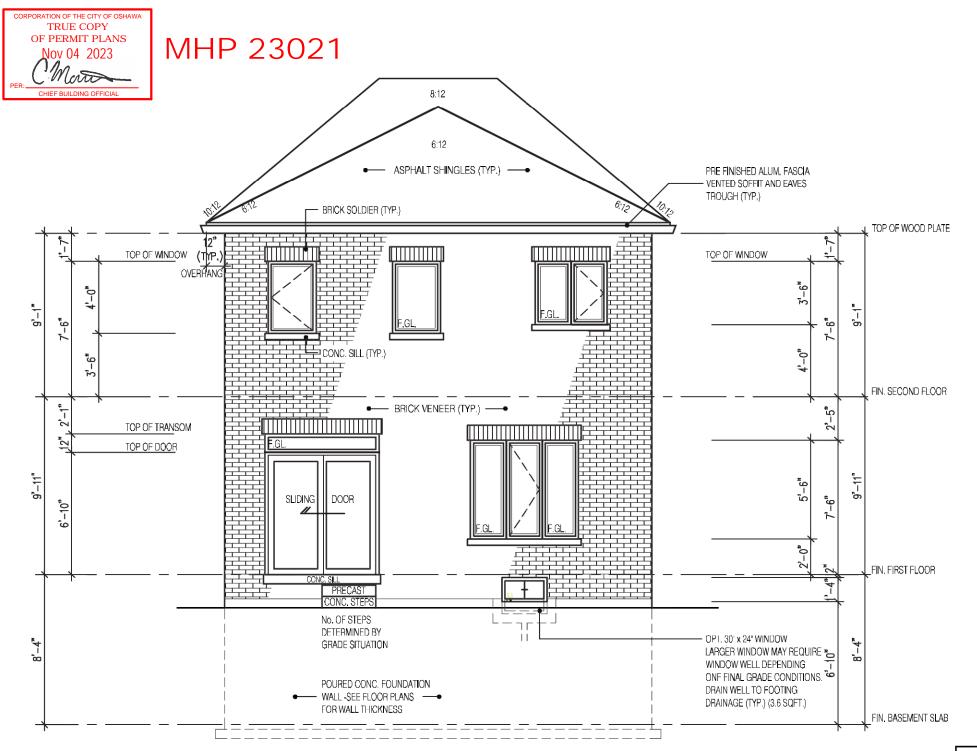

## **REAR ELEVATION 1**

t is the builder's complete responsibility t It is the builder's complete responsibility to ensure that all plans submitted for approva fully comply with the Architectural Guidelines and all applicable regulations and requirements including zoning provisions and any provisions in the subdivision agreement. The Control Architect is not responsible in any way for examining or approving site (lotting) plans or working drawings with respect to any zoning or building code or permit matter or that any house can be properly built or located on its lot

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JOHN G. WILLIAMS LTD., ARCHITECT AND APPROVAL APPROVED BY: DATE: JUL 31, 2023 his stamp certifies compliance with the applicable Design Guidelines only and bears no further professional responsibility

2190

9.14m LOTS

RIVER 1 (GR) **ELEVATION 1** 

**A1 PACKAGE** 

O.REG. 332/12

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3	MAY 4, 2023	COORDINATED FLOOR, ROOF ANI ENGINEER COMMENTS
2	MAR. 1, 2023	ISSUED TO CLIENT FOR PERMIT
1	FEB. 14, 2023	INTRODUCED FROM JOB 21-35 MODEL GARDEN 1, 4 BED LAYOUT
No:	DATE:	WORK DESCRIPTION:

64 JARDIN DR. SUITE 3A VAUGHAN ONT. L4K 3P3 TEL: 905 660-3377 FAX: 905 660-3713 EMAIL: info@jardindesign.ca

The undersigned has reviewed and takes responsibility for this design and has the qualifications and meets the requirements set out in the Ontario Building Code to be a designer QUALIFICATION INFORMATION

Walter Botter NAME

REGISTRATION INFORMATION
Required unless design is exempt under Division C, Subsection 3.2.4 of the building code

jardin design group inc. FIRM NAME


**REAR ELEVATION 1** 

ZADORRA ESTATE INC. CITY OF OSHAWA



RIVER 1 (GR) SCALE:

3/16"=1'-0" DWG. No PROJ. No. 22-16

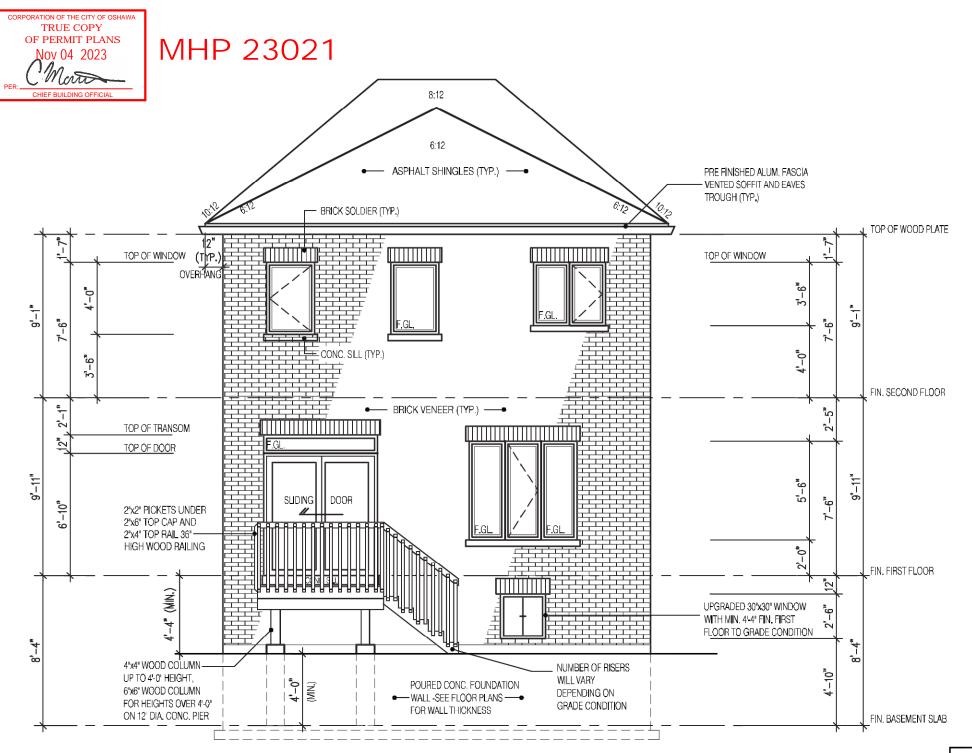

**REAR ELEVATION 1 DECK CONDITION** 

FOR ADDITIONAL DECK STRUCTURE REFER TO PAGE 7 OF THE DETAIL PACKAGE

## NOTE:

WHEN VENEER CUT IS GREATER THAN 26" A 10" POURED CONC. FOUNDATION WALL IS REQUIRED. (FOUNDATION PLAN TO BE REVIEWED IN CONJUNCTION WITH SITE PLAN)

t is the builder's complete responsibility It is the builder's complete responsibility tensure that all plans submitted for approve fully comply with the Architectural Guideline and all applicable regulations and requirement including zoning provisions and any provision in the subdivision agreement. The Control Architect is not responsible in any way for examining or approving site (lotting) plans or working drawings with respect to any zoning obuilding code or permit matter or that any buses can be propedly thill refused on its for

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IOHN G. WILLIAMS LTD., ARCHITECT DATE: JUL 31, 2023 This stamp certifies compliance with the applicable Design Guidelines only and bears no furthe

house can be properly built or located on its

2190 9.14m LOTS

RIVER 1 (GR) **ELEVATION 1** 

A1 PACKAGE

O.REG. 332/12

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	3	MAY 4, 2023	COORDINATED FLOOR, ROOF AND ENGINEER COMMENTS	
	2	MAR. 1, 2023	ISSUED TO CLIENT FOR PERMIT	
	1	FEB. 14, 2023	INTRODUCED FROM JOB 21-35 MODEL GARDEN 1, 4 BED LAYOUT	
ı	No:	DATE:	WORK DESCRIPTION:	

64 JARDIN DR. SUITE 3A VAUGHAN ONT. L4K 3P3 TEL: 905 660-3377 FAX: 905 660-371 EMAL: info@jardindesign.ca

The undersigned has reviewed and takes responsibility for this design and has the qualifications and meets the requirements set out in the Ontario Building Code to be QUALIFICATION INFORMATION

Walter Bo<u>tter</u> REGISTRATION INFORMATION
Required unless design is exempt under Division C, Subsection

3.2.4 of the building code

iardin design group inc. FIRM NAME


**DECK CONDITION EL-1** 

ZADORRA ESTATE INC. CITY OF OSHAWA



RIVER 1 (GR) SCALE: 3/16"=1'-0"

PROJ. No. DWG. No. 6-1

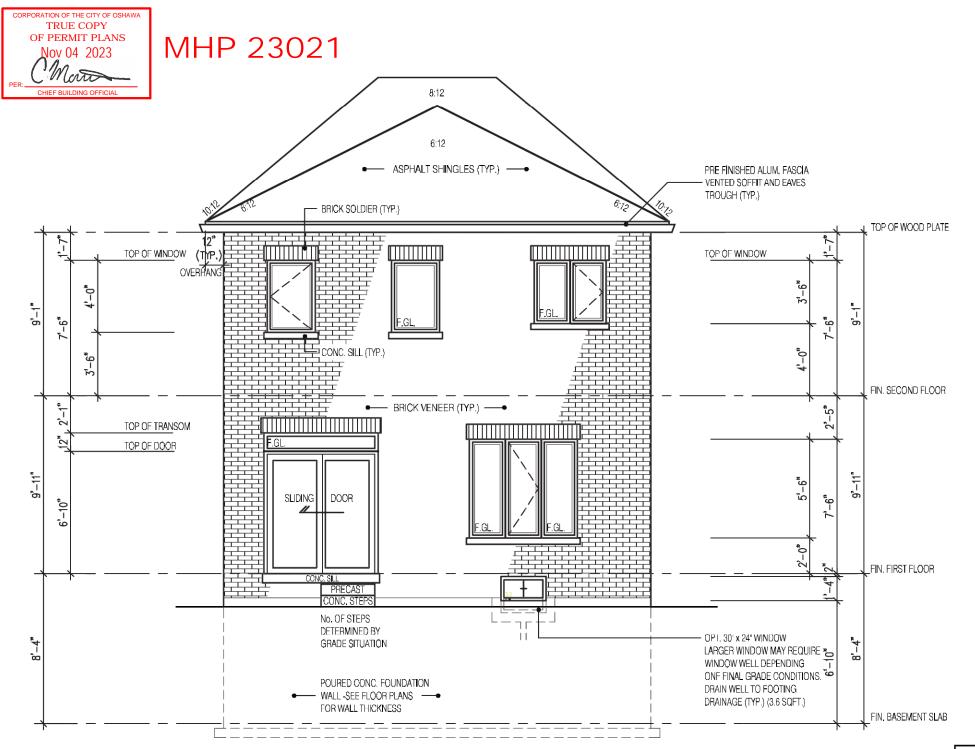

## **REAR ELEVATION 2**

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JOHN G. WILLIAMS LTD., ARCHITECT ARCHITECTURAL CONTROL REVIEW AND APPROVAL	
APPROVED BY:	
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2190

9.14m LOTS

RIVER 1 (GR) **ELEVATION 2** 

**A1 PACKAGE** 

O.REG. 332/12

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64 JARDIN DR. SUITE 3A VAUGHAN ONT. L4K 3P3 TEL: 905 660-3377 FAX: 905 660-3713 EMAL: info@jardindesign.ca

The undersigned has reviewed and takes responsibility for this design and has the qualifications and meets the requirements set out in the Ontario Building Code to be a designer QUALIFICATION INFORMATION

Walter Botter NAME

REGISTRATION INFORMATION
Required unless design is exempt under Division C, Subsection 3.2.4 of the building code

jardin design group inc.

FIRM NAME


**REAR ELEVATION 2** 

ZADORRA ESTATE INC. CITY OF OSHAWA



RIVER 1 (GR) SCALE: 3/16"=1'-0" PROJ. No. 22-16

DWG. No

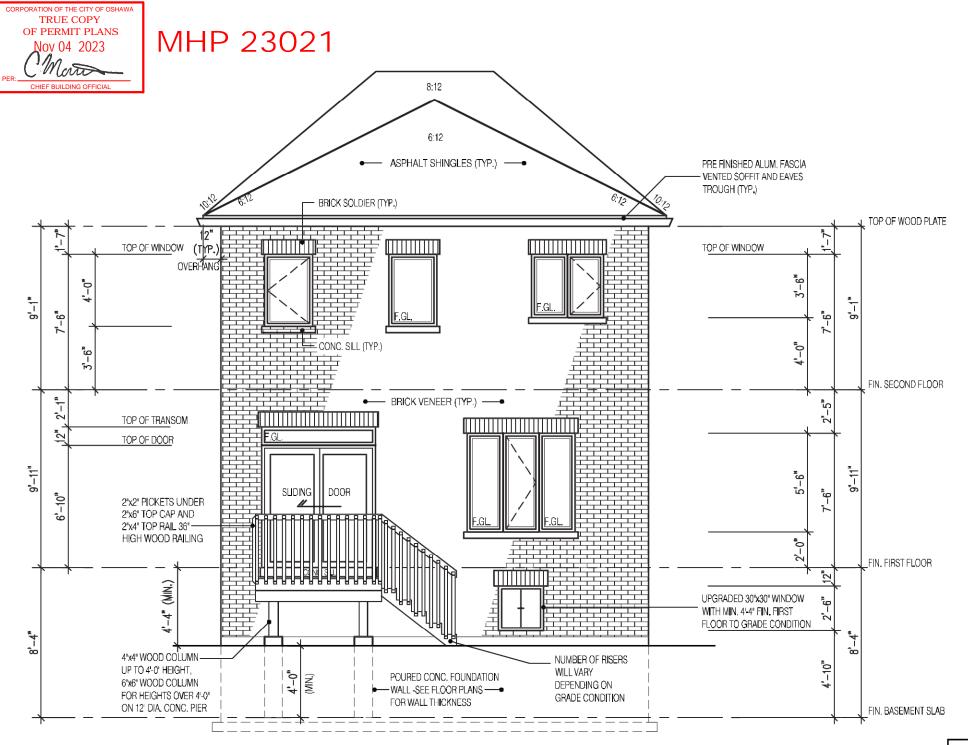

**REAR ELEVATION 2 DECK CONDITION** 

FOR ADDITIONAL DECK STRUCTURE REFER TO PAGE 7 OF THE DETAIL PACKAGE

## NOTE:

WHEN VENEER CUT IS GREATER THAN 26" A 10" POURED CONC. FOUNDATION WALL IS REQUIRED. (FOUNDATION PLAN TO BE REVIEWED IN CONJUNCTION WITH SITE PLAN)

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house can be properly built or located on its

2190

9.14m LOTS

RIVER 1 (GR) **ELEVATION 2** 

A1 PACKAGE

O.REG. 332/12

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64 JARDIN DR. SUITE 3A VAUGHAN ONT. L4K 3P3 TEL: 905 660-3377 FAX: 905 660-3713 EMAL: info@jardindesign.ca

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QUALIFICATION INFORMATION

Walter Botter

REGISTRATION INFORMATION
Required unless design is exempt under Division C, Subsection 3.2.4 of the building code

iardin design group inc.

FIRM NAME

**DECK CONDITION EL-2** 

ZADORRA ESTATE INC. CITY OF OSHAWA




RIVER 1 (GR) SCALE:

3/16"=1'-0" PROJ. No. 22-16 6A-



# MHP 23021

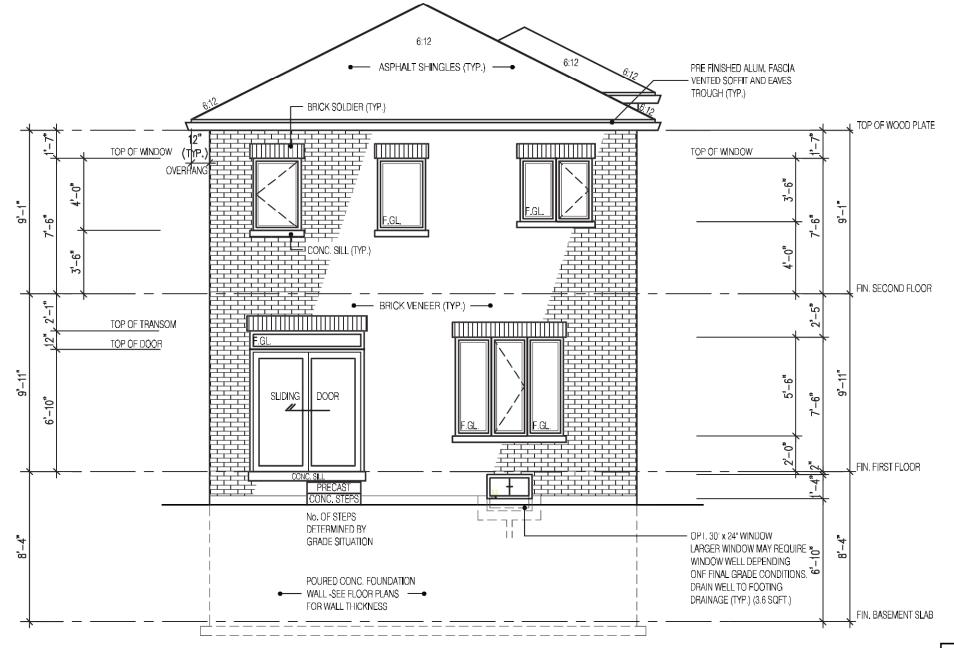

**REAR ELEVATION 3** 

t is the builder's complete responsibility It is the builder's complete responsibility to ensure that all plans submitted for approva fully comply with the Architectural Guidelines and all applicable regulations and requirements including zoning provisions and any provisions in the subdivision agreement. The Control Architect is not responsible in any way for examining or approving site (lotting) plans or working drawings with respect to any zoning or building code or permit matter or that any house can be properly built or located on its lot

This is to certify that these plans comply with the applicable Architectural Design Guidelines approved by the City of

JOHN G. WILLIAMS LTD., ARCHITECT APPROVED BY DATE: JUL 31, 2023 his stamp certifies compliance with the applicable Design Guidelines only and bears no further

2190

9.14m LOTS

RIVER 1 (GR) **ELEVATION 3** 

A1 PACKAGE

O.REG. 332/12

CONDITIONS ON SITE BEFORE PROCEEDING WITH CONSTRUCTION, ANY DISCREPANCIES SHALL BE REPORTED TO JARDIN DESIGN GROUP INC. PRIOR TO COVMENCEMENT OF WORK.

JARDIN DESIGN GROUP INC. IS NOT RESPONSIBLE FOR THE ACCUPAC OF SURVEY, STRUCTURAL OR ENGINEERING INFORMATION SHOWN ON THESE DRAWINGS OR FOR CONSTRUCTION STARTED PRIOR TO THE ISSUANCE OF A BUILDING PERMIT. REFER TO THE APPROPRIATE ENGINEERING DRAWINGS BEFORE PROCEEDING WITH WORK,

AS CONSTRUCTED INVERTS MUST BE VERIFIED PRIOR TO POURING

JARDIN DESIGN GROUP INC. HAS NOT BEEN RETAINED TO CARRY OUT GENERAL REVIEW OF THE WORK AND ASSUMES NO RESPONSIBILITY FOR THE FAILURE OF THE CONTRACTOR OR SUB CONTRACTOR TO CHARP OUT THE WORK IN ACCORDANCE WITH THE CONTRACT

THIS DRAWING IS AN INSTRUMENT OF SERVICE, IS PROVIDED BY AND I

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	3	MAY 4, 2023	COORDINATED FLOOR, ROOF AN ENGINEER COMMENTS
	2	MAR. 1, 2023	ISSUED TO CLIENT FOR PERMIT
	1	FEB. 14, 2023	INTRODUCED FROM JOB 21-35 MODEL GARDEN 1, 4 BED LAYOU
	No:	DATE:	WORK DESCRIPTION:

64 JARDIN DR. SUITE 3A VAUGHAN ONT. L4K 3P3 TEL: 905 660-3377 FAX: 905 660-3713 EMAL: info@jardindesign.ca

The undersigned has reviewed and takes responsibility for this design and has the qualifications and meets the requirements set out in the Ontario Building Code to be a designer

QUALIFICATION INFORMATION

Walter Botter NAME

REGISTRATION INFORMATION
Required unless design is exempt under Division C, Subsection 3.2.4 of the building code

jardin design group inc.

FIRM NAME **REAR ELEVATION 3** 

ZADORRA ESTATE INC. CITY OF OSHAWA




RIVER 1 (GR) SCALE: 3/16"=1'-0" PROJ. No. 22-16

6B



# MHP 23021

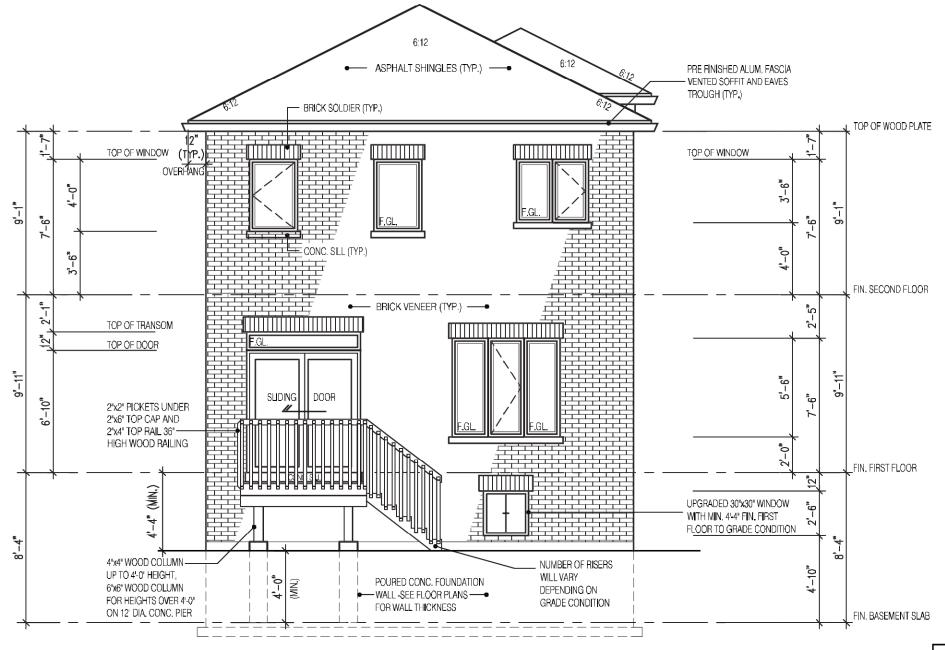

REAR ELEVATION 3
DECK CONDITION

FOR ADDITIONAL DECK STRUCTURE REFER TO PAGE 7 OF THE DETAIL PACKAGE

## NOTE:

WHEN VENEER CUT IS GREATER THAN 26" A 10" POURED CONC. FOUNDATION WALL IS REQUIRED.
(FOUNDATION PLAN TO BE REVIEWED IN CONJUNCTION WITH SITE PLAN)

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This is to certify that these plans comply with the applicable Architectural Design Guidelines approved by the City of Oshawa

JOHN G. WILLIAMS LTD., ARCHITECT ARCHITECTURAL CONTROL REVIEW AND APPROVAL
APPROVED BY:
This stamp certifies compliance with the applicable Design Guidelines only and bears no further professional responsibility.

2190

9.14m LOTS RIVER 1 (GR)

**ELEVATION 3** 

A1 PACKAGE O.REG. 332/12

THE CONTRACTOR SHALL CHECK AND VERIFY ALL DIVENSIONS AND CONDITIONS ON SITE DEFORE PROCEEDING WITH CONSTRUCTION, ANY DISCREPANCIES SHALL SE REPORTED TO JARDIN DESIGN GROUING, PRIOR TO COMMENCEMENT OF WORK.

JARDIN DESIGN GROUP INC. IS NOT RESPONSIBLE FOR THE ACCUPACY OF SURVEY, STRUCTURAL OR ENGINEERING INFORMATION SHOWN ON THESE DRAWINGS OR FOR CONSTRUCTION STARTED PRIOR TO THE ISSUANCE OF A BUILDING PERMIT. REFER TO THE APPROPRIATE ENGINEERING DRAWINGS BEFORE PROCESSING WITH WORK.

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JARDIN DESIGN GROUP INC. HAS NOT BEEN RETAINED TO CARRY OUT GENERAL REVIEW OF THE WORK AND ASSUMES NO RESPONSIBILITY FOR THE FALLEY OF THE CONTRACTION OF BUILD CONTRACTOR TO CARRY OUT THE WORK IN ACCORDANCE WITH THE CONTRACT DOCUMENTS.

THIS DRAWING IS AN INSTRUMENT OF SERVICE, IS PROVIDED BY AND IT THE PROPERTY OF JARDIN DESIGN GROUP INC. THIS DRAWING IS NOT TO BE SCALED.

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3	MAY 4, 2023	COORDINATED FLOOR, ROOF AN ENGINEER COMMENTS
2	MAR. 1, 2023	ISSUED TO CLIENT FOR PERMIT
1	FEB. 14, 2023	INTRODUCED FROM JOB 21-35 MODEL GARDEN 1, 4 BED LAYOU
No:	DATE:	WORK DESCRIPTION:

# Jardin DESIGN GROUP INC

64 JARDIN DR. SUITE 3A VAUGHAN ONT. L4K 3P3 TEL: 905 660-3377 FAX: 905 660-3713 EMAIL; info@jardindesign.ca

The undersigned has reviewed and takes responsibility for this design and has the qualifications and meets the requirements set out in the Ontario Building Code to be a designer

QUALIFICATION INFORMATION quired unless design is exempt under Division C, Subsec 3.2.5 of the building case.

Walter Botter SIGNATURE B

REGISTRATION INFORMATION Required unless design is exempt under Division C, Subsection 3.2.4 of the building code

jardin design group inc.

FIRM NAME BCIN
DECK CONDITION EL-3


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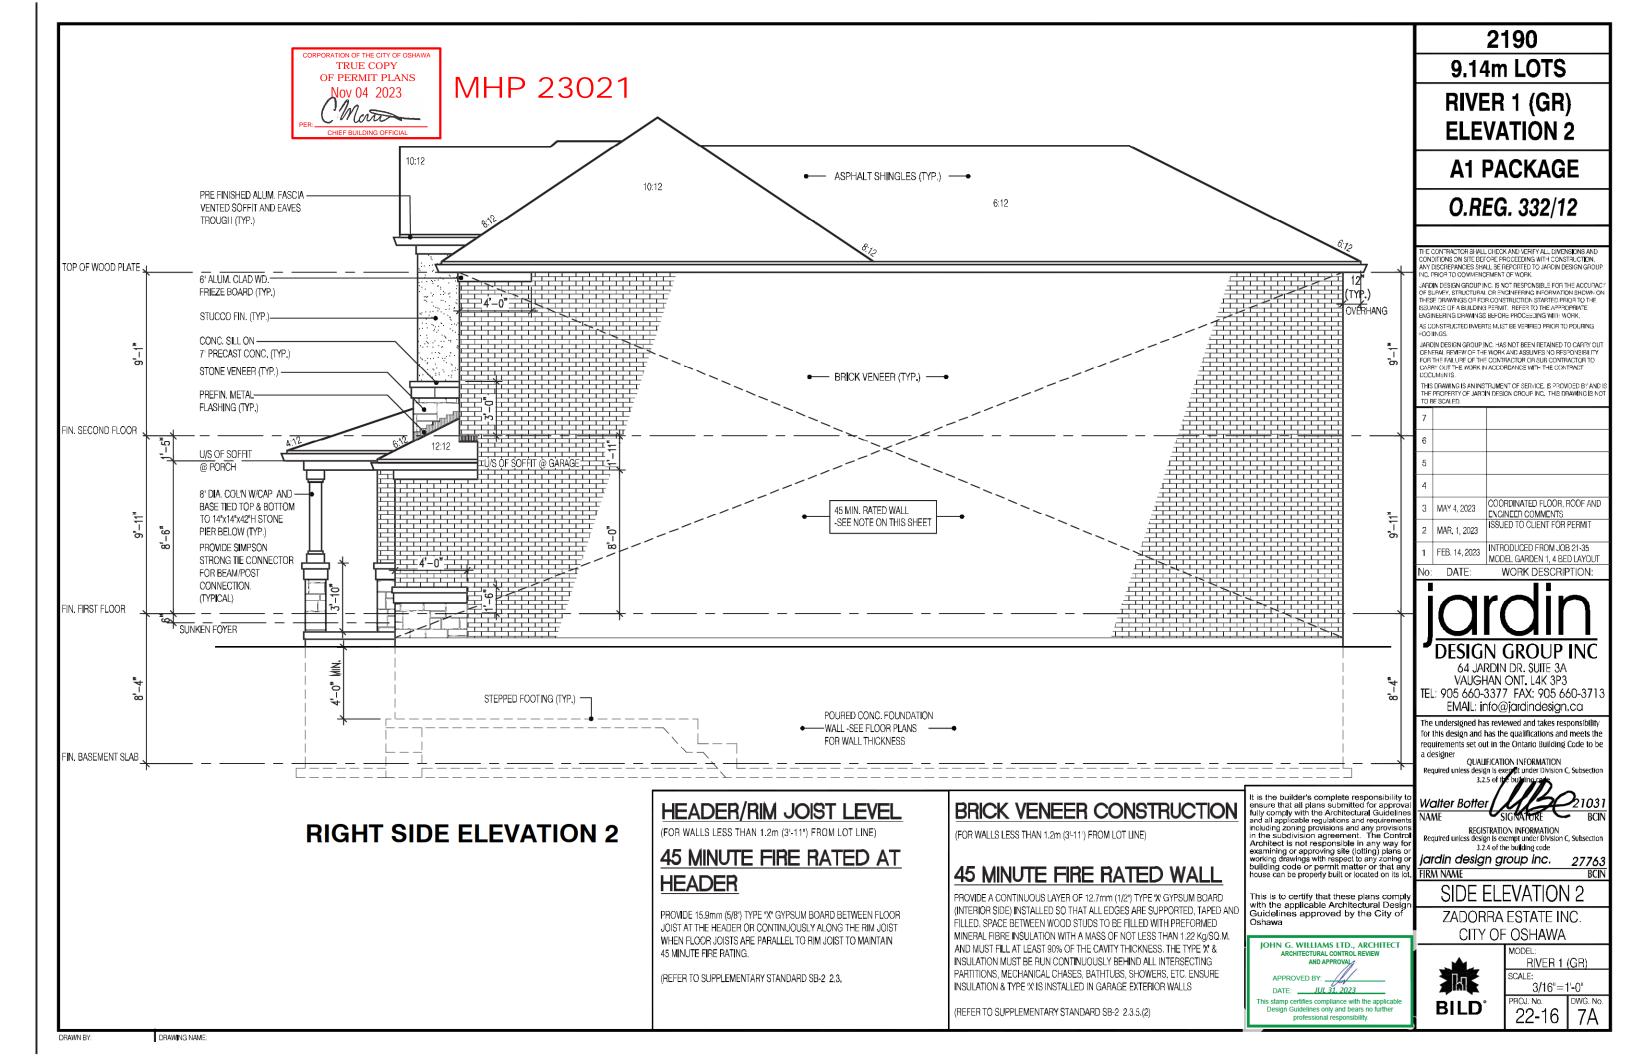
CITY OF OSHAWA





RIVER 1 (GR) SCALE: 3/16"=1'-0"

PROJ. No. DWG. No. 6B-1



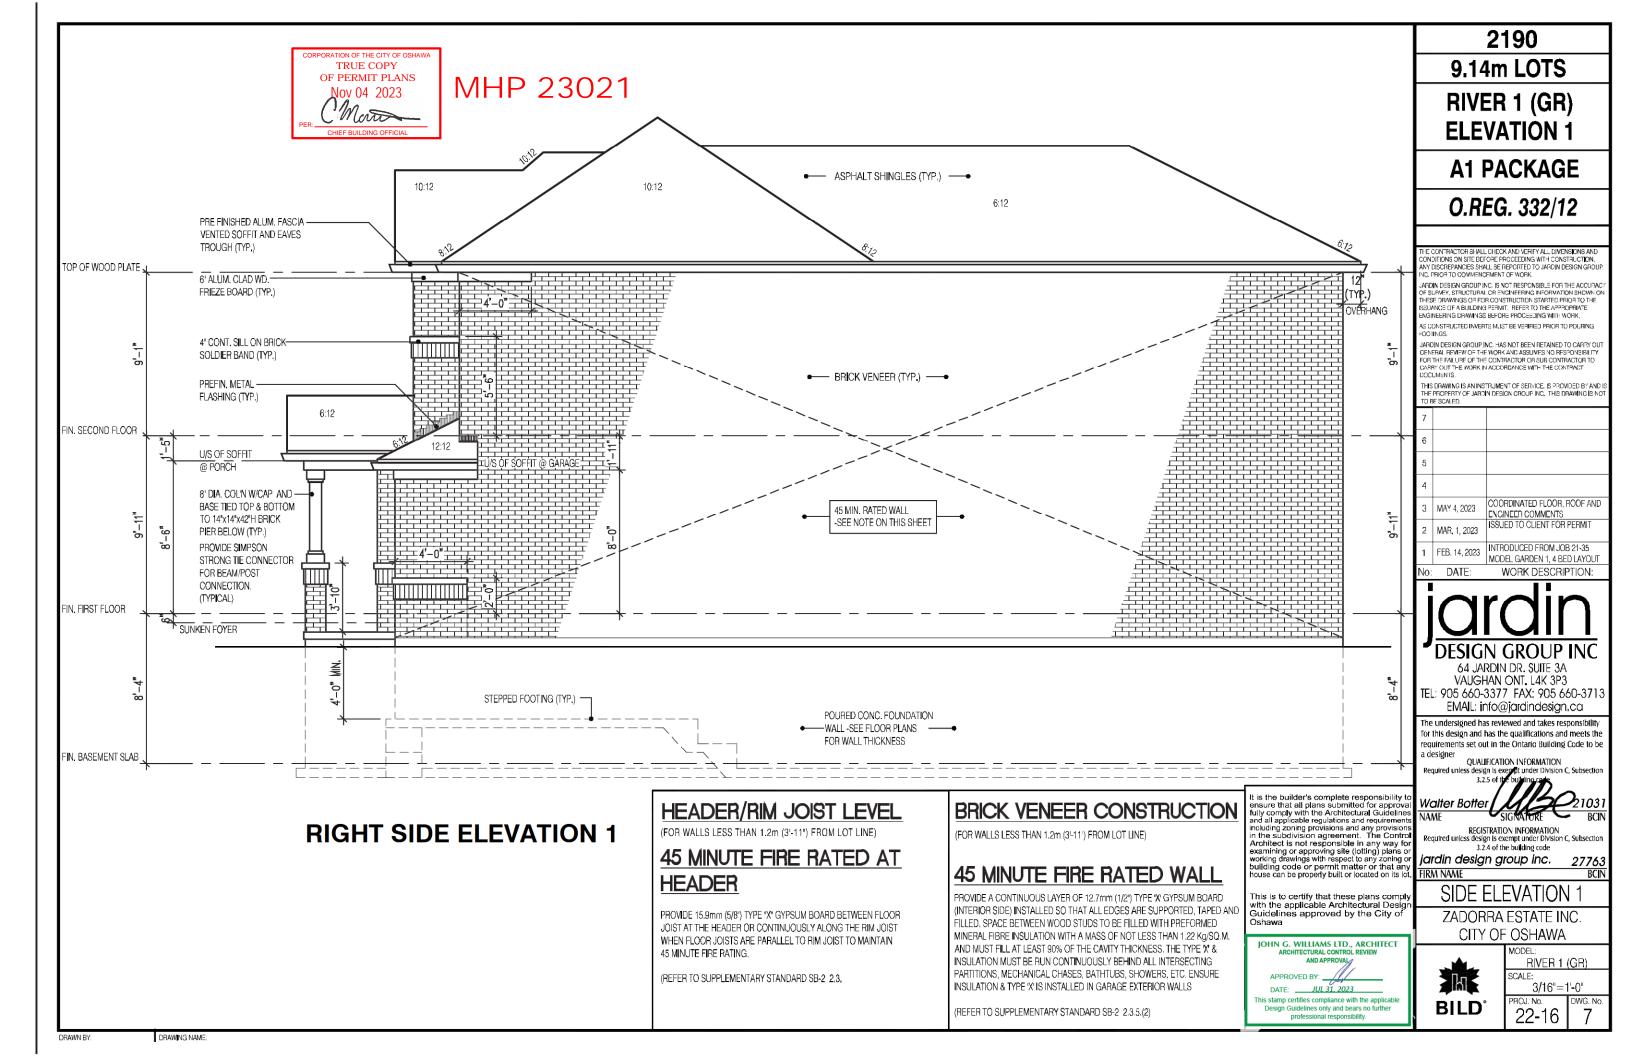

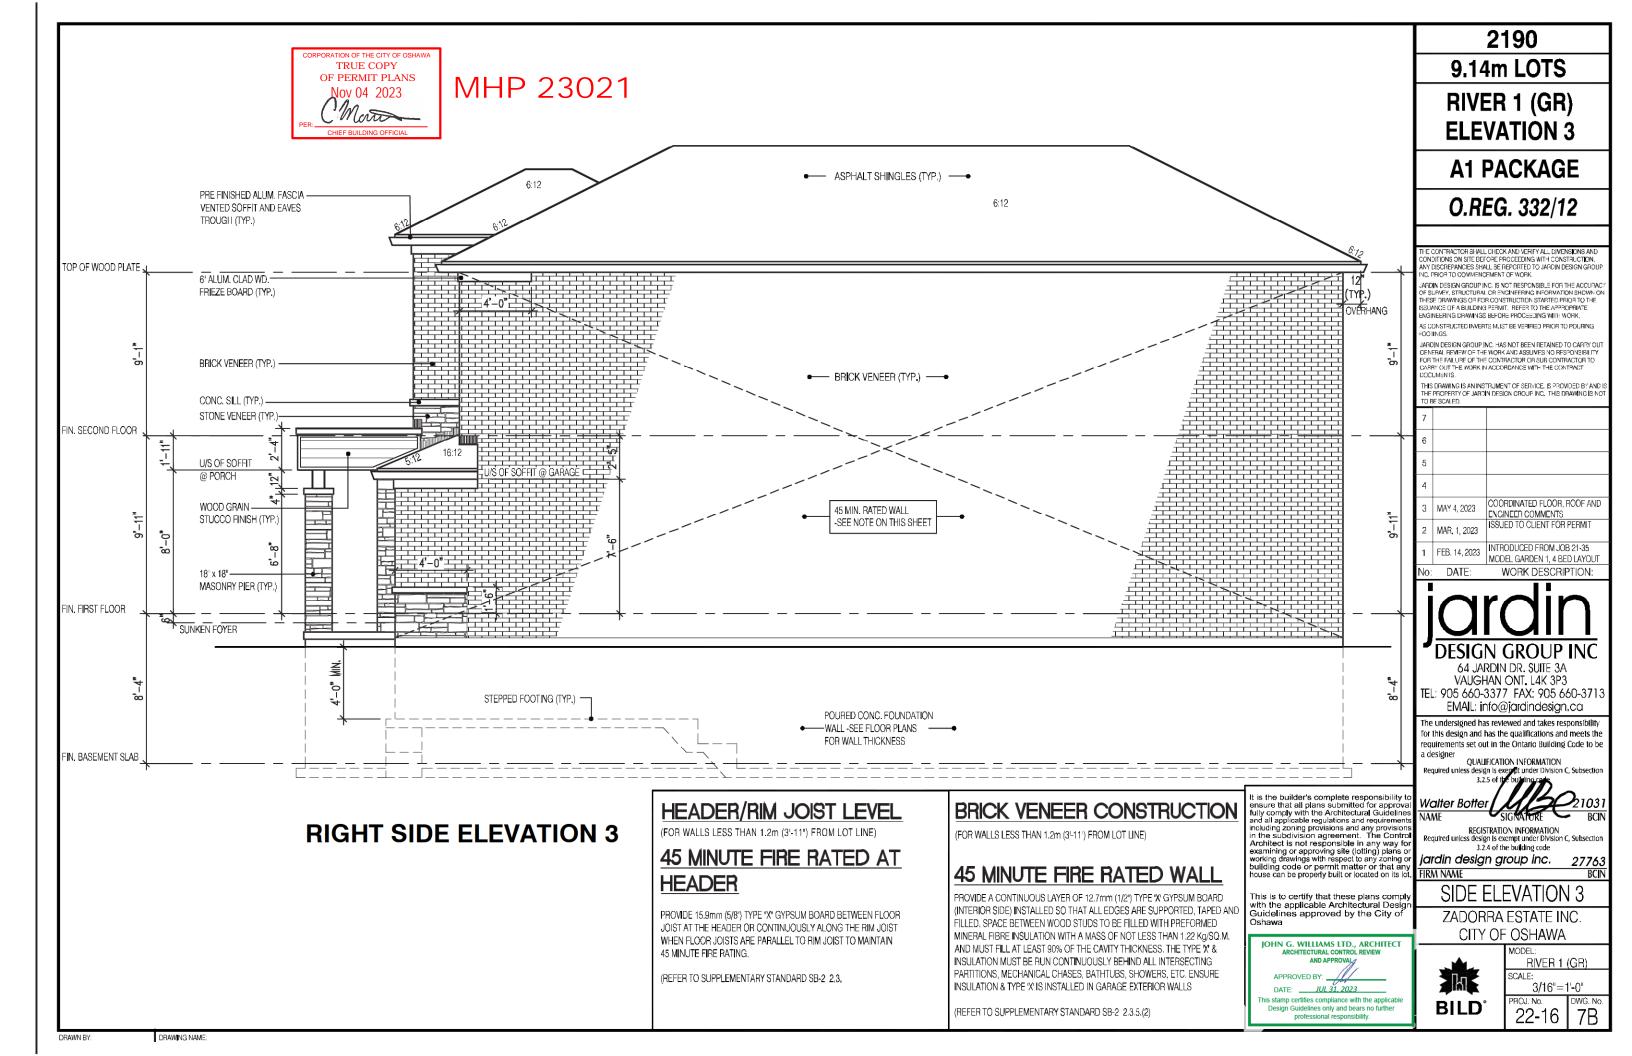

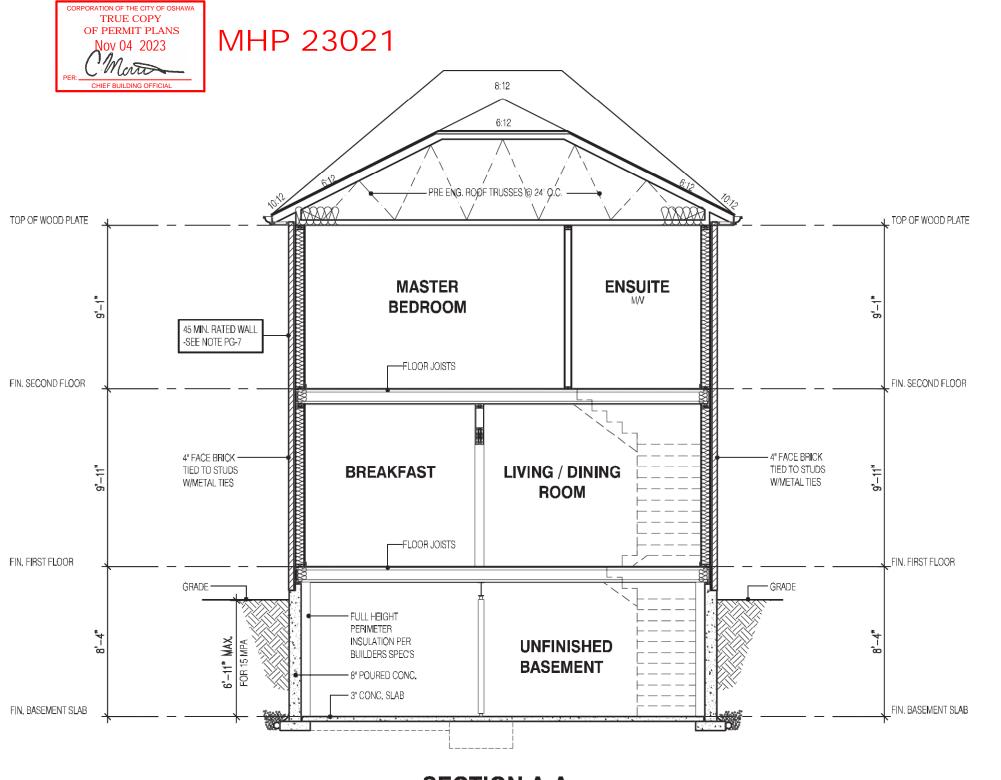

**SECTION A-A ELEVATION 1** 

STRUDET INC.



FOR STRUCTURE ONLY

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2190

9.14m LOTS

RIVER 1 (GR) **ELEVATION 1** 

**A1 PACKAGE** 

O.REG. 332/12

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	2	MAR. 1, 2023	ISSUED TO CLIENT FOR PERMIT
	1	FEB. 14, 2023	INTRODUCED FROM JOB 21-35

WORK DESCRIPTION:



64 JARDIN DR. SUITE 3A VAUGHAN ONT. L4K 3P3 TEL: 905 660-3377 FAX: 905 660-3713 EMAL: info@jardindesign.ca

The undersigned has reviewed and takes responsibility for this design and has the qualifications and meets the requirements set out in the Ontario Building Code to be a designer

QUALIFICATION INFORMATION



REGISTRATION INFORMATION
Required unless design is exempt under Division C, Subsection 3.2.4 of the building code

jardin design group inc.

FIRM NAME


SECTION ELEVATION 1

ZADORRA ESTATE INC. CITY OF OSHAWA



RIVER 1 (GR) SCALE: 3/16"=1'-0"

> DWG. No PROJ. No. 22-16

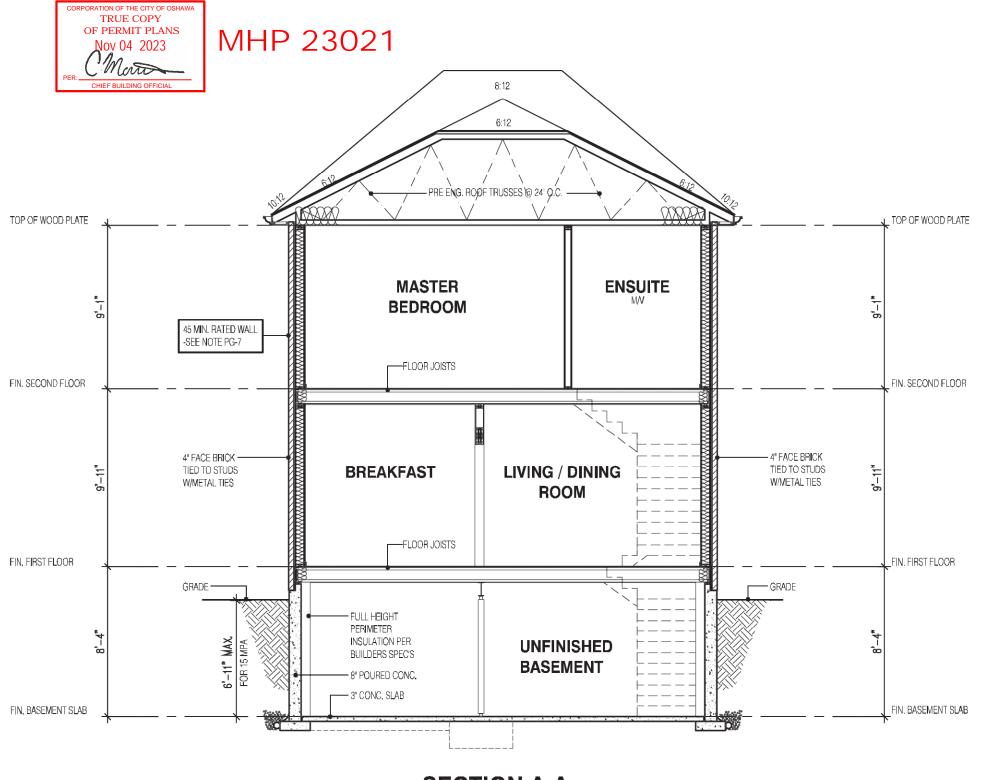

**SECTION A-A ELEVATION 2** 

STRUDET INC.



FOR STRUCTURE ONLY

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2190

9.14m LOTS

RIVER 1 (GR) **ELEVATION 2** 

**A1 PACKAGE** 

O.REG. 332/12

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	1	FEB. 14, 2023	INTRODUCED FROM JOB 21-35

WORK DESCRIPTION: DATE:



VAUGHAN ONT. L4K 3P3 TEL: 905 660-3377 FAX: 905 660-3713 EMAL: info@jardindesign.ca

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QUALIFICATION INFORMATION



REGISTRATION INFORMATION
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jardin design group inc.

FIRM NAME

**SECTION ELEVATION 2** 

ZADORRA ESTATE INC. CITY OF OSHAWA




RIVER 1 (GR) SCALE:

3/16"=1'-0" PROJ. No. DWG. NO 22-16



# MHP 23021

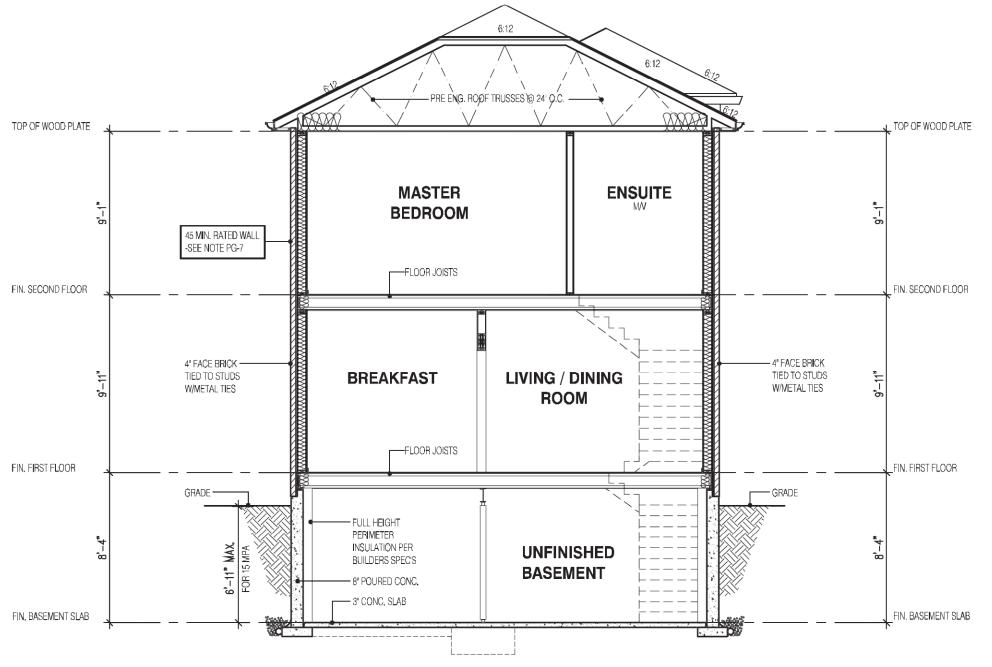

**SECTION A-A ELEVATION 3** 

STRUDET INC.



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2190

9.14m LOTS

RIVER 1 (GR) **ELEVATION 3** 

**A1 PACKAGE** 

O.REG. 332/12

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WORK DESCRIPTION:

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QUALIFICATION INFORMATION



REGISTRATION INFORMATION
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3.2.4 of the building code jardin design group inc.

FIRM NAME

**SECTION ELEVATION 3** 

ZADORRA ESTATE INC. CITY OF OSHAWA



RIVER 1 (GR) SCALE: 3/16"=1'-0"

PROJ. No. 22-16 8B