



CORPORATION OF THE CITY OF OSHAWA  
TRUE COPY  
OF PERMIT PLANS  
NOV 04 2023  
PER: C. Morris  
CHIEF BUILDING OFFICIAL

# BUILDING PERMIT COVER PAGE

MHP 23021

Development Services Department  
Building Permit and Inspection Services

BUILDING PERMIT PLANS REVIEW	ACCEPTED AS NOTED	
	REVIEWED BY	DATE
ZONING		
PLANNING		
ARCHITECTURAL	CM	NOV 4, 2023
STRUCTURAL		
FIRE		
PLUMBING	CARD	
MECHANICAL		
PLANS REVIEW COMPLETED	CM	NOV 4, 2023

## SOIL CONDITIONS

SOIL CONDITIONS SHALL BE VERIFIED BY A PROFESSIONAL ENGINEER COMPETENT IN THE FIELD OF SOIL ENGINEERING, PRIOR TO PLACING ANY FOUNDATION.

THE PERMIT PLANS HAVE BEEN REVIEWED FOR ONE (1) DWELLING UNIT. ANY FUTURE CHANGES WILL REQUIRE A SEPARATE BUILDING PERMIT

## PLUMBING INSTALLATIONS

ALL PLUMBING INSTALLATIONS ARE TO BE DONE BY A PLUMBING CONTRACTOR POSSESSING AN ONTARIO COLLEGE OF TRADES MEMBERSHIP. NO PLUMBING IS TO BE COVERED UNTIL INSPECTED AND APPROVED BY A PLUMBING INSPECTOR. TELEPHONE 905-436-5658 WHEN READY FOR AN INSPECTION AND TESTING.

ALL STANDARDS REFERRED TO IN THESE BUILDING PERMIT DOCUMENTS SHALL BE THE EDITION DESIGNATED IN OBC 2012 AS AMENDED.

## FUTURE ALTERATIONS

A SEPARATE BUILDING PERMIT IS REQUIRED FOR ANY PROPOSED INTERIOR PARTITIONS AND/OR ALTERATIONS.

## NOTE:

IT IS RECOMMENDED THAT CRUSHED CONCRETE OR SLAG AGGREGATE **NOT** TO BE USED FOR BACKFILL UNDER CONCRETE SLABS, AROUND SEWER LATERALS OR WEEPERS.

RAIN WATER DOWNSPOUTS ARE TO BE DISCHARGED AT GRADE AND NOT CONNECTED TO WEEPING TILES.

COPY OF THE STAMPED/REVIEWED DRAWINGS MUST REMAIN ON SITE DURING CONSTRUCTION.

## MHP CERTIFICATION

ALL MARKUPS AND STAMPS APPLIED TO BASE MODEL AND BASE ELEVATION SHALL APPLY AS APPLICABLE TO THE ENTIRE MODEL HOUSE PLAN

## AS BUILT SURVEY

UPON COMPLETION OF THE FOUNDATION, A SURVEY PREPARED BY AN ONTARIO LAND SURVEYOR INDICATING THE LOCATION OF THE BUILDING TO ALL PROPERTY LINES IS REQUIRED TO BE SUBMITTED TO THE BUILDING DEPARTMENT

## IMPORTANT NOTE

NEITHER THE ISSUANCE OF A PERMIT NOR THE CARRYING OUT OF INSPECTIONS BY THE CITY RELIEVE THE APPLICANT FROM FULL RESPONSIBILITY FOR COMPLIANCE WITH THE PROVISIONS OF THE BUILDING CODE ACT AND THE ONTARIO BUILDING CODE, BOTH AS AMENDED, AS WELL AS OTHER APPLICABLE STATUTES AND REGULATIONS OF THE PROVINCE OF ONTARIO AND ALL RELEVANT BY-LAWS OF THE CITY OF OSHAWA AND THE REGIONAL MUNICIPALITY OF DURHAM.

ALL ELECTRICAL WIRING MUST BE INSPECTED BY THE ELECTRICAL SAFETY AUTHORITY. SEPARATE INSPECTION APPLICATIONS (PERMITS) MUST BE FILED. WE RECOMMEND YOU USE A QUALIFIED ELECTRICAL CONTRACTOR. FOR MORE INFORMATION PLEASE CALL:



1-877-ESA-SAFE  
OR VISIT  
WWW.ESASAFE.COM

## INTERIOR FINISH OF EXITS

THE FLAME SPREAD RATING OF WALL OR CEILING FINISH IN AN EXIT MUST NOT EXCEED 25.

## INTERIOR FINISH (EXCEPT EXITS)

FLAME SPREAD RATING OF INTERIOR FINISH MATERIALS SHALL NOT EXCEED 150 ON WALLS AND 150 ON CEILINGS. COMBUSTIBLE WALL AND CEILING FINISHES SUCH AS WOOD, PLYWOOD, PLASTIC, FABRIC, CARPET, ETC. MUST BE APPROVED BY THE INSPECTOR PRIOR TO THE INSTALLATION.

## OBC 9.10.14.5 - CLADDING

CLADDING ON THE EXPOSING BUILDING FACE IS PERMITTED TO BE VINYL WHEN WITHIN 600mm OF PROPERTY LINE, PROVIDED THAT THE VINYL CONFORMS TO OBC DIV. B. 9.27.13, IS INSTALLED OVER SHEATHING PAPER AND 12.7mm DRYWALL, HAS A FLAME SPREAD RATING NOT GREATER THAN 25, AND IS NOT MORE THAN 2mm THICK AND THE ENTIRE EXTERIOR WALL HAS A MINIMUM FIRE RESISTANCE RATING OF  $\frac{1}{2}$  HOURS.

PREFABRICATED WOOD TRUSSES  
FABRICATION AND ERECTION DRAWINGS WITH DESIGN DATA PREPARED AND SEALED BY A PROFESSIONAL ENGINEER, MUST BE AVAILABLE ON SITE FOR REVIEW BY THE BUILDING INSPECTOR

## RETURN AIR INLET FROM ANYROOM

PROVISIONS SHALL BE MADE FOR THE RETURN OF AIR FROM ANY ROOM OR SPACE WITHOUT A RETURN AIR INLET, BY LEAVING GAPS BENEATH DOORS, USING LOUVERED DOORS, OR INSTALLING RETURN AIR DUCT INLETS.

## ROOF CEILING INSULATION

ROOF FRAMING OR TRUSS HEEL JOINT MUST PERMIT SUFFICIENT SPACE FOR THE EXTENSION OF THE ROOF-CEILING INSULATION OVER EXTERIOR WALLS. MINIMIZE THERMAL BRIDGES. AN UNOBSTRUCTED VENTILATION SPACE MUST BE PROVIDED OVER EXTERIOR WALLS TO ALLOW UNIMPEDED AIR FLOW FORM SOFFIT VENTS TO ROOF VENTS.

ATTIC HATCHES SHALL NOT BE LESS THAN 550mm (21  $\frac{5}{8}$ ) BY 900mm (35")

## OBC 9.26.4.1.

FLASHING REQUIRED AT ALL ROOF-WALL JUNCTIONS

## ATTACHED OR BUILT-IN GARAGE

THE SEPARATION BETWEEN THE GARAGE AND DWELLING UNIT SHALL BE CONSTRUCTED AS AN EFFECTIVE BARRIER TO GAS AND EXHAUST FUMES. THE DOOR BETWEEN THE GARAGE AND DWELLING UNIT SHALL BE EXTERIOR TYPE, TIGHT FITTING AND WEATHER-STRIPPED TO PROVIDE AN EFFECTIVE BARRIER AGAINST THE PASSAGE OF GAS AND EXHAUST FUMES, AND SHALL BE FITTED WITH AN APPROVED SELF CLOSING DEVICE

## DIV.B. 9.10.14.1 EXPOSING BUILDING FACE OF HOUSES

UNPROTECTED OPENINGS IN THE EXPOSING BUILDING FACE SHALL NOT BE PERMITTED IF THE LIMITING DISTANCE IS LESS THAN 1.2m (3'11") AND SHALL BE LIMITED IN CONFORMANCE WITH THE REQUIREMENTS FOR UNPROTECTED OPENINGS IN DIV. B ARTICLE 9.10.15.1. WHERE THE LIMITING DISTANCE IS 1.2m (3'11") OR GREATER.

THE EXPOSING BUILDING FACE SHALL HAVE A FIRE RESISTANCE RATING OF NOT LESS THAN 45 MINUTES WHERE THE LIMITING DISTANCE IS LESS THAN 1.2m.

A return air inlet shall be located in any room where at least 1/2 of the floor area is located over an unconditioned space (e.g. room over a garage)

## RESISTANCE TO FORCED ENTRY

2012 O.B.C. DIV B. 9.7.5.2. & 9.7.5.3.

1. SWINGING DOORS PROVIDING ACCESS TO DWELLING UNITS SHALL SATISFY THE REQUIREMENTS FOR RESISTANCE TO FORCED ENTRY AS DESCRIBED IN SUBSECTION 9.7.5.2.

2. WINDOWS IN DWELLING UNITS THAT ARE LOCATED WITHIN 2M OF ADJACENT GROUND LEVEL SHALL CONFORM TO THE REQUIREMENTS FOR RESISTANCE TO FORCED ENTRY AS DESCRIBED IN CLAUSE 5.3.5.OF AAMA/WDMA/CSA 101/I.S.2/A440.

2012 Code

## 9.8.8.1.(8)(a)(b) Windows over Stairs, Ramps and Landings

(2) In dwelling units, glazing installed over stairs, ramps and landings that extend to less than 900 mm (2 ft 11 in) above the surface to the treads, ramp or landing shall be,

- protected by guards, in accordance with this Subsection, or
- non-openable and designed to withstand the specified lateral loads for guards as provided in Article 4.1.5.14.

## 9.5.2.3. STUD WALL REINFORCEMENT

- IF WOOD WALL STUDS OR SHEET STEEL WALL STUDS ENCLOSE THE MAIN BATHROOM IN A DWELLING UNIT, REINFORCEMENT SHALL BE INSTALLED TO PERMIT THE FUTURE INSTALLATION OF A GRAB BAR ON A WALL ADJACENT TO,
  - A WATER CLOSET IN THE LOCATION REQUIRED BY CLAUSE 3.8.3.8.(1)(d), AND
  - A SHOWER OR BATHTUB IN THE LOCATION BY CLAUSE 3.8.3.13.(1)(f).

(SEE APPENDIX A.)

## STRUCTURAL ALTERATIONS

ALL STRUCTURAL ALTERATIONS MUST BE FIELD REVIEWED BY A PROFESSIONAL ENGINEER IF REQUIRED BY THE BUILDING INSPECTOR

## FINISHED SITE GRADING

THE BUILDING SHALL BE LOCATED AND THE BUILDING SITE GRADED SO THAT WATER WILL NOT ACCUMULATE AT OR NEAR THE BUILDING AND WILL NOT ADVERSELY AFFECT ANY ADJACENT PROPERTIES.

A CURSORY REVIEW OF THE STRUCTURAL ELEMENTS HAS BEEN COMPLETED AND IS RELIANT ON ENGINEER'S CERTIFICATION OF DRAWINGS

The Corporation of the City of Oshawa, 50 Centre Street South, Oshawa, Ontario L1H 3Z7

Phone 905.436.5658 1.800.667.4292 Fax 905.436.5623

[www.oshawa.ca](http://www.oshawa.ca)

2190

9.14m LOTS

RIVER 1 (GR)  
ELEVATION 1, 2 & 3

A1 PACKAGE

O.REG. 332/12

THE CONTRACTOR SHALL CHECK AND VERIFY ALL DIMENSIONS AND CONDITIONS ON SITE BEFORE PROCEEDING WITH CONSTRUCTION. ANY DISCREPANCIES SHALL BE REPORTED TO JARDIN DESIGN GROUP INC. PRIOR TO COMMENCEMENT OF WORK.

JARDIN DESIGN GROUP INC. IS NOT RESPONSIBLE FOR THE ACCURACY OF SURVEY, STRUCTURAL OR ENGINEERING INFORMATION SHOWN ON THIS DRAWINGS OR FOR CONSTRUCTION STARTED PRIOR TO THE ISSUANCE OF A BUILDING PERMIT. REFER TO THE APPROPRIATE ENGINEERING DRAWINGS BEFORE PROCEEDING WITH WORK.

AS CONSTRUCTED INVERTS MUST BE VERIFIED PRIOR TO POLING COATINGS.

JARDIN DESIGN GROUP INC. HAS NOT BEEN RETAINED TO CARRY OUT GENERAL REVIEW OF THE WORK AND ASSUMES NO RESPONSIBILITY FOR THE FAILURE OF THE CONTRACTOR OR SUB CONTRACTOR TO CARRY OUT THE WORK IN ACCORDANCE WITH THE CONTRACT DOCUMENTS.

THIS DRAWING IS AN INSTRUMENT OF SERVICE, IS PROVIDED BY AND IS THE PROPERTY OF JARDIN DESIGN GROUP INC. THIS DRAWING IS NOT TO BE SCALED.

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3 MAY 4, 2023 COORDINATED FLOOR, ROOF AND ENGINEER COMMENTS


2 MAR. 1, 2023 ISSUED TO CLIENT FOR PERMIT

1 FEB. 14, 2023 INTRODUCED FROM JOB 21-35 MODEL GARDEN 1, 4 BED LAYOUT

No: DATE: WORK DESCRIPTION:

**jardin**  
DESIGN GROUP INC64 JARDIN DR. SUITE 3A  
VAUGHAN ONT. L4K 3P3TEL: 905 660-3377 FAX: 905 660-3713  
EMAIL: info@jardindesign.ca

The undersigned has reviewed and takes responsibility for this design and has the qualifications and meets the requirements set out in the Ontario Building Code to be a designer

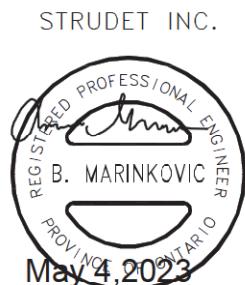QUALIFICATION INFORMATION  
Required unless design is exempt under Division C, Subsection 3.2 of the building code

FOR STRUCTURE ONLY

<b>STRIP FOOTINGS FOR SINGLES AND SEMIS UP TO 2 STOREY</b> <small>DRAWINGS OF PERMIT PLANS</small>	
120 KPa NATIVE SOIL  20'x6' CONCRETE STRIP FOOTINGS BELOW FOUNDATION WALLS. 24'x8' CONCRETE STRIP FOOTINGS BELOW PARTY WALLS.	Nov 04 2023 <i>C. Mart</i> PER: CHIEF BUILDING OFFICER ENGINEERED FILL SOIL INC. CONCRETE STRIP FOOTINGS WITH REINFORCING BELOW FOUNDATION WALLS. INC. CONCRETE STRIP FOOTINGS WITH REINFORCING BELOW PARTY WALLS.
100 KPa NATIVE SOIL  22'x8' CONCRETE STRIP FOOTINGS BELOW FOUNDATION WALLS. 28'x10' CONCRETE STRIP FOOTINGS BELOW PARTY WALLS OR 28'x8' CONCRETE STRIP FOOTINGS WITH REINFORCING BELOW PARTY WALLS	GENERAL NOTE:  ASSUMED 120/100 KPa NATIVE SOIL BEARING CAPACITY OR 90 KPa FOR ENGINEERED FILL, TO BE VERIFIED ON SITE. REFER TO ENGINEERED FILL FOOTING DETAIL FOR REINFORCEMENT.  (REFER TO ENG. FILL FOOTING DETAIL)

**PAD FOOTING**

120 KPa NATIVE SOIL      90 KPa ENGINEERED FILL SOIL

F1 = 42'x42"x18" CONCRETE PAD  
F2 = 36'x36"x16" CONCRETE PAD  
F3 = 30'x30"x12" CONCRETE PAD  
F4 = 24'x24"x12" CONCRETE PAD  
F5 = 16'x16"x8" CONCRETE PAD

100 KPa NATIVE SOIL

F1 = 48'x48"x20" CONCRETE PAD  
F2 = 40'x40"x16" CONCRETE PAD  
F3 = 34'x34"x14" CONCRETE PAD  
F4 = 28'x28"x12" CONCRETE PAD  
F5 = 17'x17"x8" CONCRETE PAD

(REFER TO FLOOR PLAN FOR UNUSUAL SIZE PADS NOT ON CHART)

**NOTE:**

WHEN VENEER CUT IS GREATER THAN 26" A 10" POURED CONC. FOUNDATION WALL IS REQUIRED.

**NOTE:**ALL GARAGE SLABS, PORCH SLABS, STAIRS (EXPOSED CONC. FLAT WORK) TO BE 32 MPa  
WITH 5-8% AIR ENTRAPMENT.**BRICK VENEER LINTELS:**WL1 = 3 1/2" x 3 1/2" x 1 1/4" (90x90x6) + 2-2" x 8" SPR.  
WL2 = 4" x 3 1/2" x 5 1/8" (100x90x8) - 2-2" x 8" SPR.  
WL3 = 5" x 3 1/2" x 5 1/8" (125x90x8) - 2-2" x 10" SPR.  
WL4 = 6" x 3 1/2" x 3 1/8" (150x90x10) - 2-2" x 12" SPR.  
WL5 = 6" x 4" x 3 1/8" (150x100x10) + 2-2" x 12" SPR.WL6 = 5" x 3 1/2" x 5 1/8" (125x90x8) - 2-2" x 12" SPR.  
WL7 = 5" x 3 1/2" x 5 1/8" (125x90x8) - 3-2" x 10" SPR.  
WL8 = 5" x 3 1/2" x 5 1/8" (125x90x8) + 3-2" x 12" SPR.  
WL9 = 6" x 4" x 3 1/8" (150x100x10) + 3-2" x 12" SPR.**WOOD LINTELS:**WB1 = 2-2" x 8" SPRUCE BEAM  
WB2 = 3-2" x 8" SPRUCE BEAM  
WB3 = 2-2" x 10" SPRUCE BEAM  
WB4 = 3-2" x 10" SPRUCE BEAM  
WB5 = 2-2" x 12" SPRUCE BEAMWB6 = 3-2" x 12" SPRUCE BEAM  
WB7 = 5-2" x 12" SPRUCE BEAM  
WB10 = 4-2" x 8" SPRUCE BEAM  
WB11 = 4-2" x 10" SPRUCE BEAM**STEEL LINTELS:**L1 = 3 1/2" x 3 1/2" x 1 1/4" (90 x 90 x 6)  
L2 = 4" x 3 1/2" x 5 1/8" (100 x 90 x 8)  
L3 = 5" x 3 1/2" x 5 1/8" (125 x 90 x 8)L4 = 6" x 3 1/2" x 3 1/8" (150 x 90 x 10)  
L5 = 6" x 4" x 3 1/8" (150 x 100 x 10)  
L6 = 7" x 4" x 3 1/8" (180 x 100 x 10)**LAMINATED VENEER LUMBER (LVL BEAMS)**LVL1A = 1-1 3/4" x 7 1/4" (1-45x184)  
LVL1 = 2-1 3/4" x 7 1/4" (2-45x184)  
LVL2 = 3-1 3/4" x 7 1/4" (3-45x184)  
LVL3 = 4-1 3/4" x 7 1/4" (4-45x184)  
LVL4A = 1-1 3/4" x 9 1/2" (1-45x240)  
LVL4 = 2-1 3/4" x 9 1/2" (2-45x240)  
LVL5 = 3-1 3/4" x 9 1/2" (3-45x240)  
LVL5A = 4-1 3/4" x 9 1/2" (4-45x240)  
LVL6A = 1-1 3/4" x 11 7/8" (1-45x300)  
LVL6 = 2-1 3/4" x 11 7/8" (2-45x300)  
LVL7 = 3-1 3/4" x 11 7/8" (3-45x300)

MHP 23021

**AREA CALCULATIONS EL-1**


FIRST FLOOR AREA	= 995 Sq. Ft.
SECOND FLOOR AREA	= 1177 Sq. Ft.
TOTAL FLOOR AREA	= 2172 Sq. Ft.
ADD OPEN AREAS	= 18 Sq. Ft.
ADD FIN. BASEMENT AREA	= 0 Sq. Ft.
GROSS FLOOR AREA	= 2190 Sq. Ft.
GROUND FLOOR COVERAGE	= 995 Sq. Ft.
GARAGE COVERAGE / AREA	= 242 Sq. Ft.
PORCH COVERAGE / AREA	= 74 Sq. Ft.
COVERAGE W/ PORCH	= 1311 Sq. Ft.
	= 121.80 Sq. m.
COVERAGE W/O PORCH	= 1237 Sq. Ft.
	= 114.92 Sq. m.

**AREA CALCULATIONS EL-2**


FIRST FLOOR AREA	= 995 Sq. Ft.
SECOND FLOOR AREA	= 1177 Sq. Ft.
TOTAL FLOOR AREA	= 2172 Sq. Ft.
ADD OPEN AREAS	= 18 Sq. Ft.
ADD FIN. BASEMENT AREA	= 0 Sq. Ft.
GROSS FLOOR AREA	= 2190 Sq. Ft.
GROUND FLOOR COVERAGE	= 995 Sq. Ft.
GARAGE COVERAGE / AREA	= 242 Sq. Ft.
PORCH COVERAGE / AREA	= 74 Sq. Ft.
COVERAGE W/ PORCH	= 1311 Sq. Ft.
	= 121.80 Sq. m.
COVERAGE W/O PORCH	= 1237 Sq. Ft.
	= 114.92 Sq. m.

**AREA CALCULATIONS EL-3**

FIRST FLOOR AREA	= 997 Sq. Ft.
SECOND FLOOR AREA	= 1179 Sq. Ft.
TOTAL FLOOR AREA	= 2176 Sq. Ft.
ADD OPEN AREAS	= 18 Sq. Ft.
ADD FIN. BASEMENT AREA	= 0 Sq. Ft.
GROSS FLOOR AREA	= 2194 Sq. Ft.
GROUND FLOOR COVERAGE	= 997 Sq. Ft.
GARAGE COVERAGE / AREA	= 242 Sq. Ft.
PORCH COVERAGE / AREA	= 74 Sq. Ft.
COVERAGE W/ PORCH	= 1313 Sq. Ft.
	= 121.98 Sq. m.
COVERAGE W/O PORCH	= 1239 Sq. Ft.
	= 115.11 Sq. m.

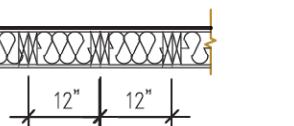2-2"x6 STUD WALL NAILED TOGETHER AND SPACED @12" O.C.  
FULL HT C/W SOLID BLOCKING 4'-0" O.C. VERTICAL AND 7/16" EXT. PLYWOOD SHEATHING.MAXIMUM HEIGHT OF WALL FOR THIS DETAIL IS 18'-0" AND  
MAXIMUM SUPPORTED LENGTH OF TRUSS IS 40'-0"**TWO STOREY HEIGHT WALL DETAIL**

2 - 1 1/2" x 5 1/2" TIMBERSTRAND (LSL) 1.5E STUD WALL GLUED AND NAILED TOGETHER AND SPACED MAX. @10" O.C. FULL HT C/W SOLID BLOCKING MAX. 8'-0" O.C. VERTICAL AND 7/16" EXT. OSB SHEATHING.

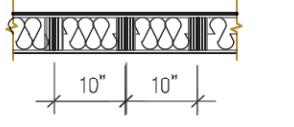MAXIMUM HEIGHT OF WALL FOR THIS DETAIL IS 20'-2" AND  
MAXIMUM SUPPORTED LENGTH OF TRUSS IS 40'-0"**TWO STOREY HEIGHT WALL DETAIL****NOTE:**

THESE DRAWINGS ARE TO BE READ IN CONJUNCTION WITH ENGINEER APPROVED ROOF TRUSS DRAWINGS BY MANUFACTURER.

**NOTE:**

SPACE CONVENTIONAL FLOOR JOISTS @ 12 O.C. BELOW ALL CERAMIC TILE AREAS. PROVIDE 1 ROW BRIDGING FOR SPANS OF 5'-7", 2 ROWS FOR SPANS GREATER THAN 7'

**NOTE:**

THESE DRAWINGS ARE TO BE READ IN CONJUNCTION WITH ENGINEER APPROVED FLOOR TRUSS LAYOUT BY MANUFACTURER.

**NOTE:**PLANS NOT DRAWN TO ACTUAL GRADE.  
REFER TO FINAL GRADING PLAN.**RIVER 1 EL-1****ENERGY EFFICIENCY- A1 PACKAGE**

ELEVATION	WALL FT <sup>2</sup>	OPENING FT <sup>2</sup>	PERCENTAGE
FRONT	514.75	68.35	13.28 %
LEFT SIDE	1095.28	54.67	4.99 %
RIGHT SIDE	1076.39	0.00	0.00 %
REAR	494.79	121.28	24.51 %
TOTAL	3181.21	244.29	7.68 %

**RIVER 1 EL-2****ENERGY EFFICIENCY- A1 PACKAGE**

ELEVATION	WALL FT <sup>2</sup>	OPENING FT <sup>2</sup>	PERCENTAGE
FRONT	515.08	76.00	14.75 %
LEFT SIDE	1093.67	54.67	5.00 %
RIGHT SIDE	1076.39	0.00	0.0


2190

9.14m LOTS

RIVER 1 (GR)  
ELEVATION 1

## A1 PACKAGE

O.REG. 332/12

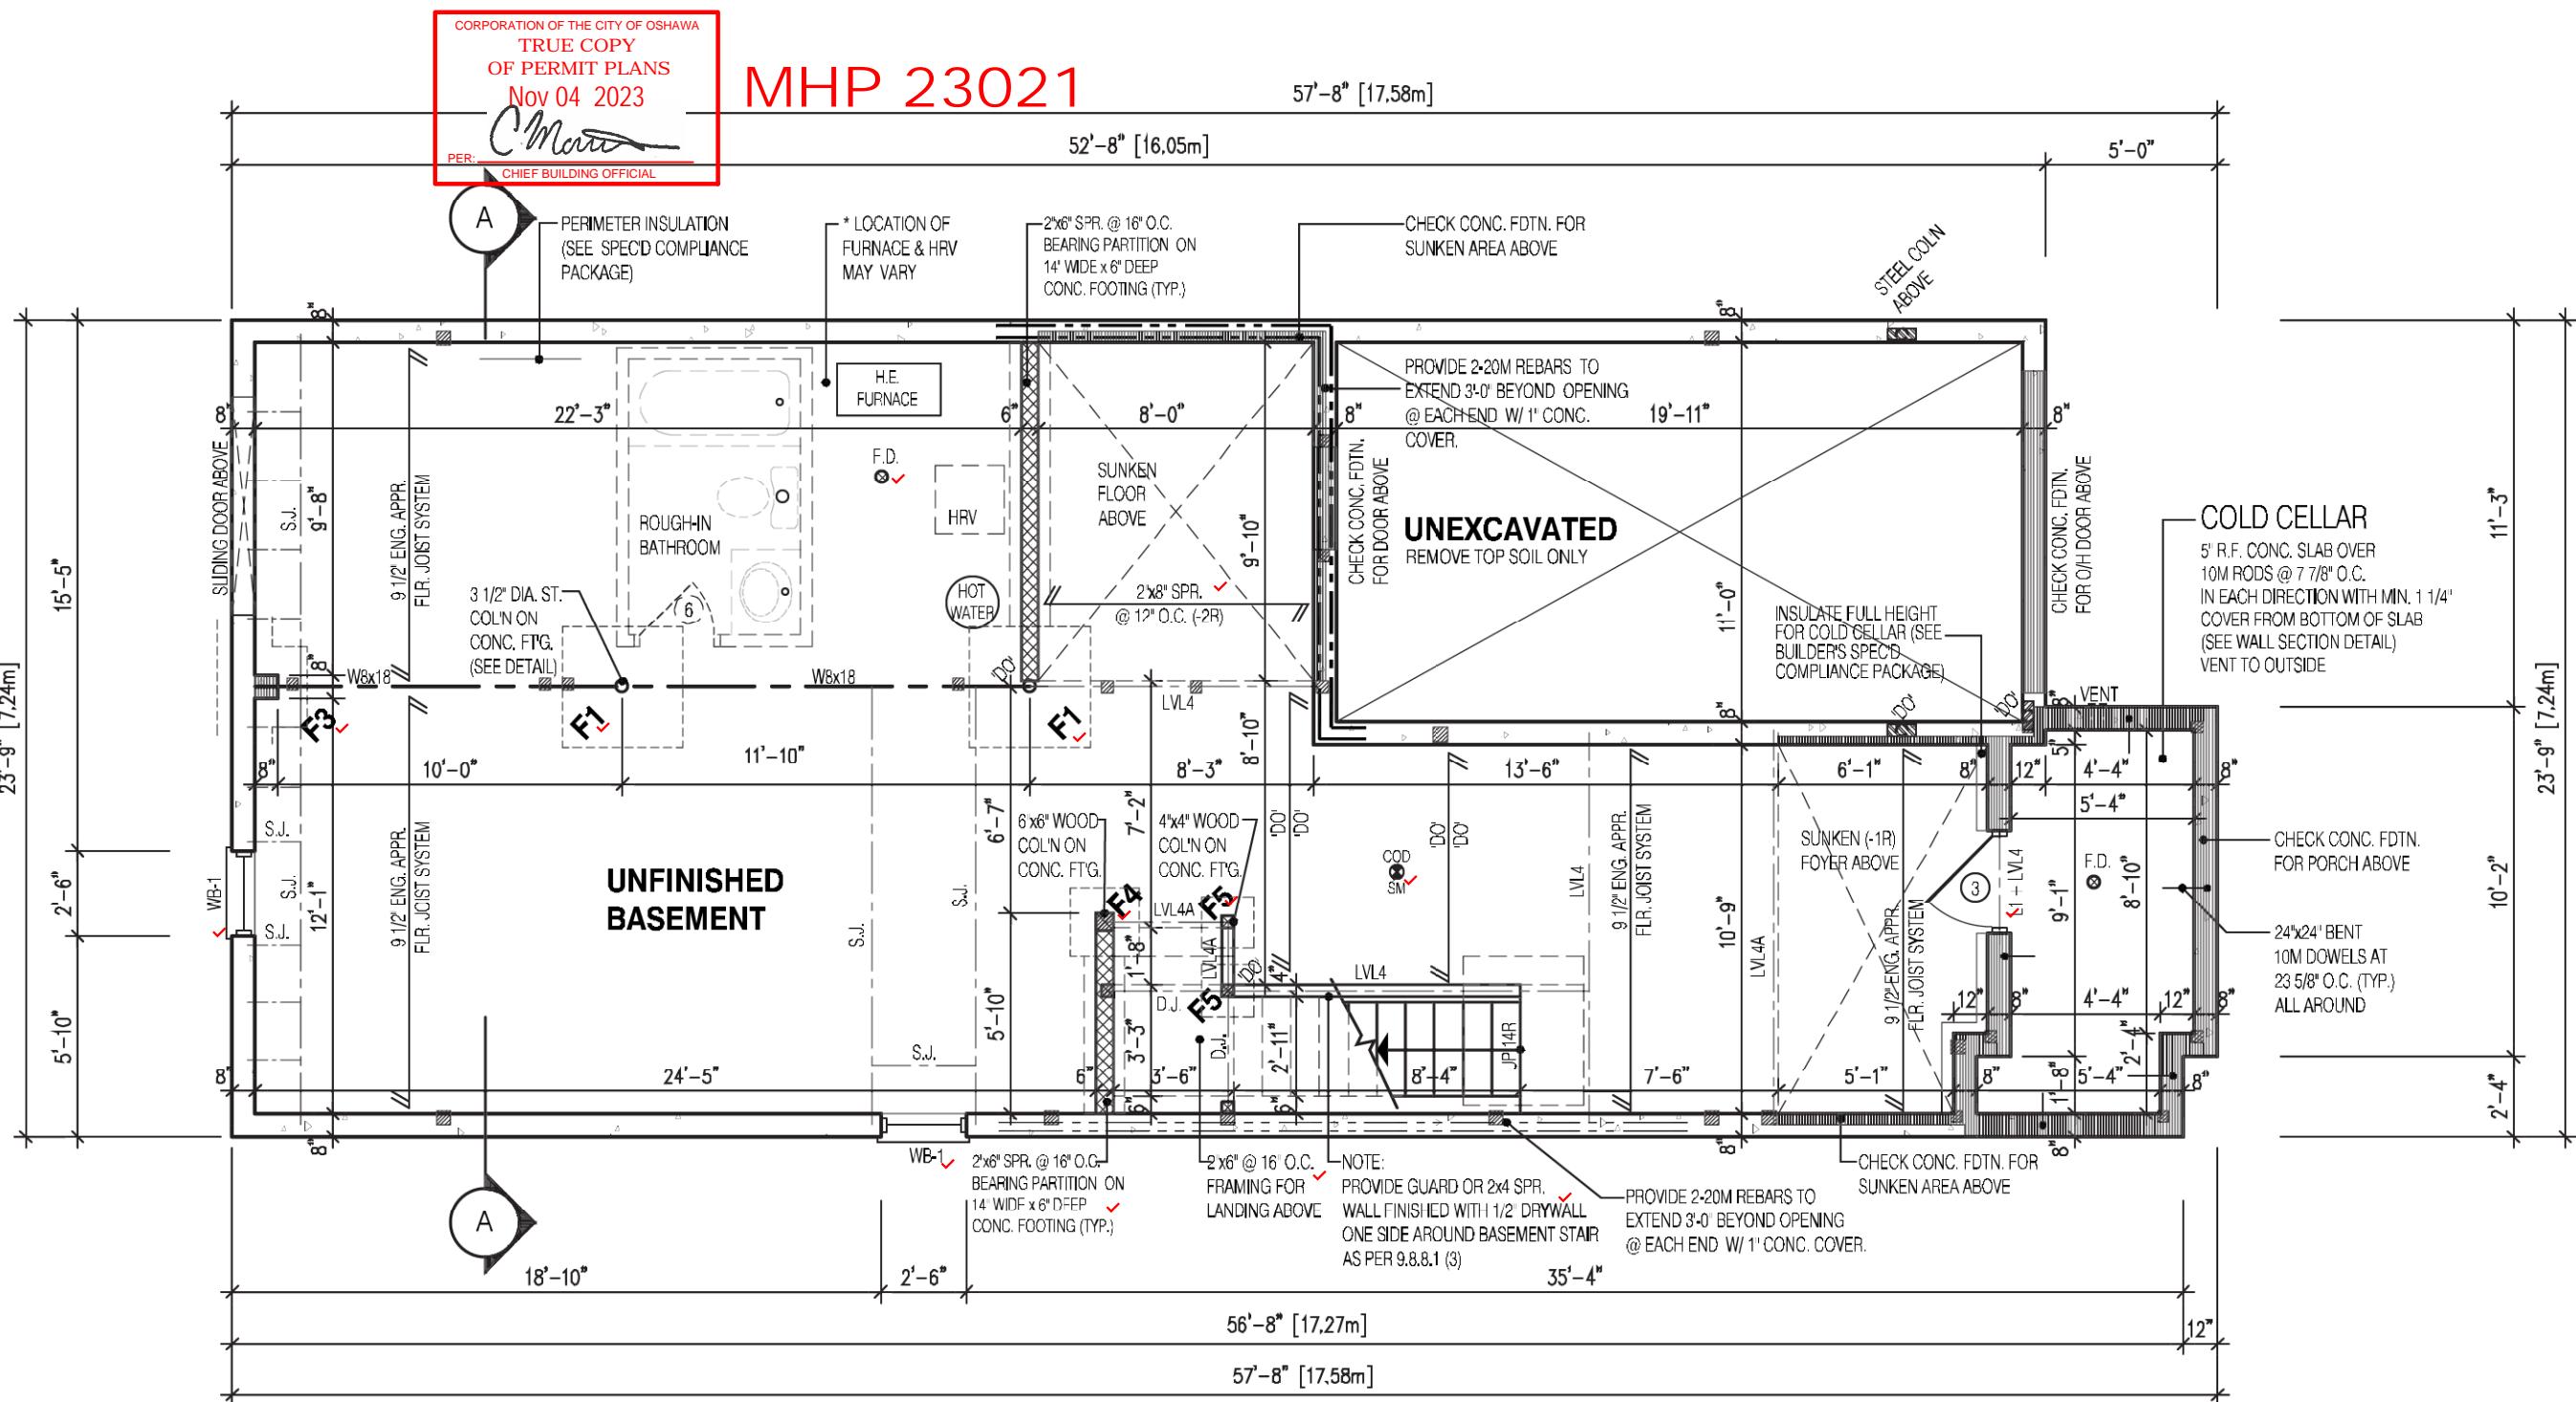





## RIVER 1 (GR) ELEVATION 1

A1 PACKAGE

O.REG. 332/12

**NOTE:**  
THESE DRAWINGS ARE TO BE READ IN  
CONJUNCTION WITH ENGINEER APPROVED  
ROOF TRUSS DRAWINGS BY MANUFACTURER

**NOTE:**  
REFER TO SHEET NO. 0-1 FOR LINTEL,  
BEAMS AND DOOR SIZE

**NOTE:**  
SPACE CONVENTIONAL FLOOR JOISTS @ 12"  
O.C. BELOW ALL CERAMIC TILE AREAS. PROVIDE  
1 ROW BRIDGING FOR SPANS OF 5'-7, 2 ROWS

**NOTE:**  
THESE DRAWINGS ARE TO BE READ IN  
CONJUNCTION WITH ENGINEER APPROVED  
EQUIPMENT LAYOUT BY MANUFACTURER

**NOTE:**

SUBFLOOR TO BE  
5/8" PLYWOOD ON  
THIS LEVEL

ALL FLOORS TO BE  
NAILED AND GLUED  
ON THIS LEVEL

**LEGEND:**

-  BUILDING FACE < THAN 4'-0" (1.2m)
  - (45 MIN. FIRE RATING REQD)
  -  INDICATES SOLID BEARING REQUIRED OR POINT LOAD FROM ABOVE
  -  STL. PLATE FOR STEEL COL'N ABOVE
  - LVL LAMINATED VENEER LUMBER
  - S.J. SINGLE JOIST
  - D.J. DOUBLE JOIST
  - T.J. TRIPLE JOIST
  -  REPEAT NOTE
  -  SHOWER WEEPERS

STRUDET INC.



## FOR STRUCTURE ONLY

It is the builder's complete responsibility to ensure that all plans submitted for approval fully comply with the Architectural Guidelines and all applicable regulations and requirements including zoning provisions and any provisions in the subdivision agreement. The Control Architect is not responsible in any way for examining or approving site (lotting) plans or working drawings with respect to any zoning or building code or permit matter or that any house can be properly built or located on its lot.

**JOHN G. WILLIAMS LTD., ARCHITECT**  
**ARCHITECTURAL CONTROL REVIEW**  
**AND APPROVAL**

APPROVED BY: JG

DATE: JULY 31, 2023

This stamp certifies compliance with the applicable Design Guidelines only and bears no further professional responsibility.

ZADORRA ESTATE INC.  
CITY OF OSHAWA

MODEL

MODEL: BIVEB 1 (GB)

RIVER (cm) SCALE:

**3/16"=1'-0"**

PROJ. No. DWG. No.


22-16 2

CORPORATION OF THE CITY OF OSHAWA  
TRUE COPY  
OF PERMIT PLANS  
Nov 04 2023  
*C. Marinovic*  
PER:  
CHIEF BUILDING OFFICIAL

MHP 23021

57'-8" [17.58m]

52'-8" [16.05m] (54'-5 1/2" MAX.)

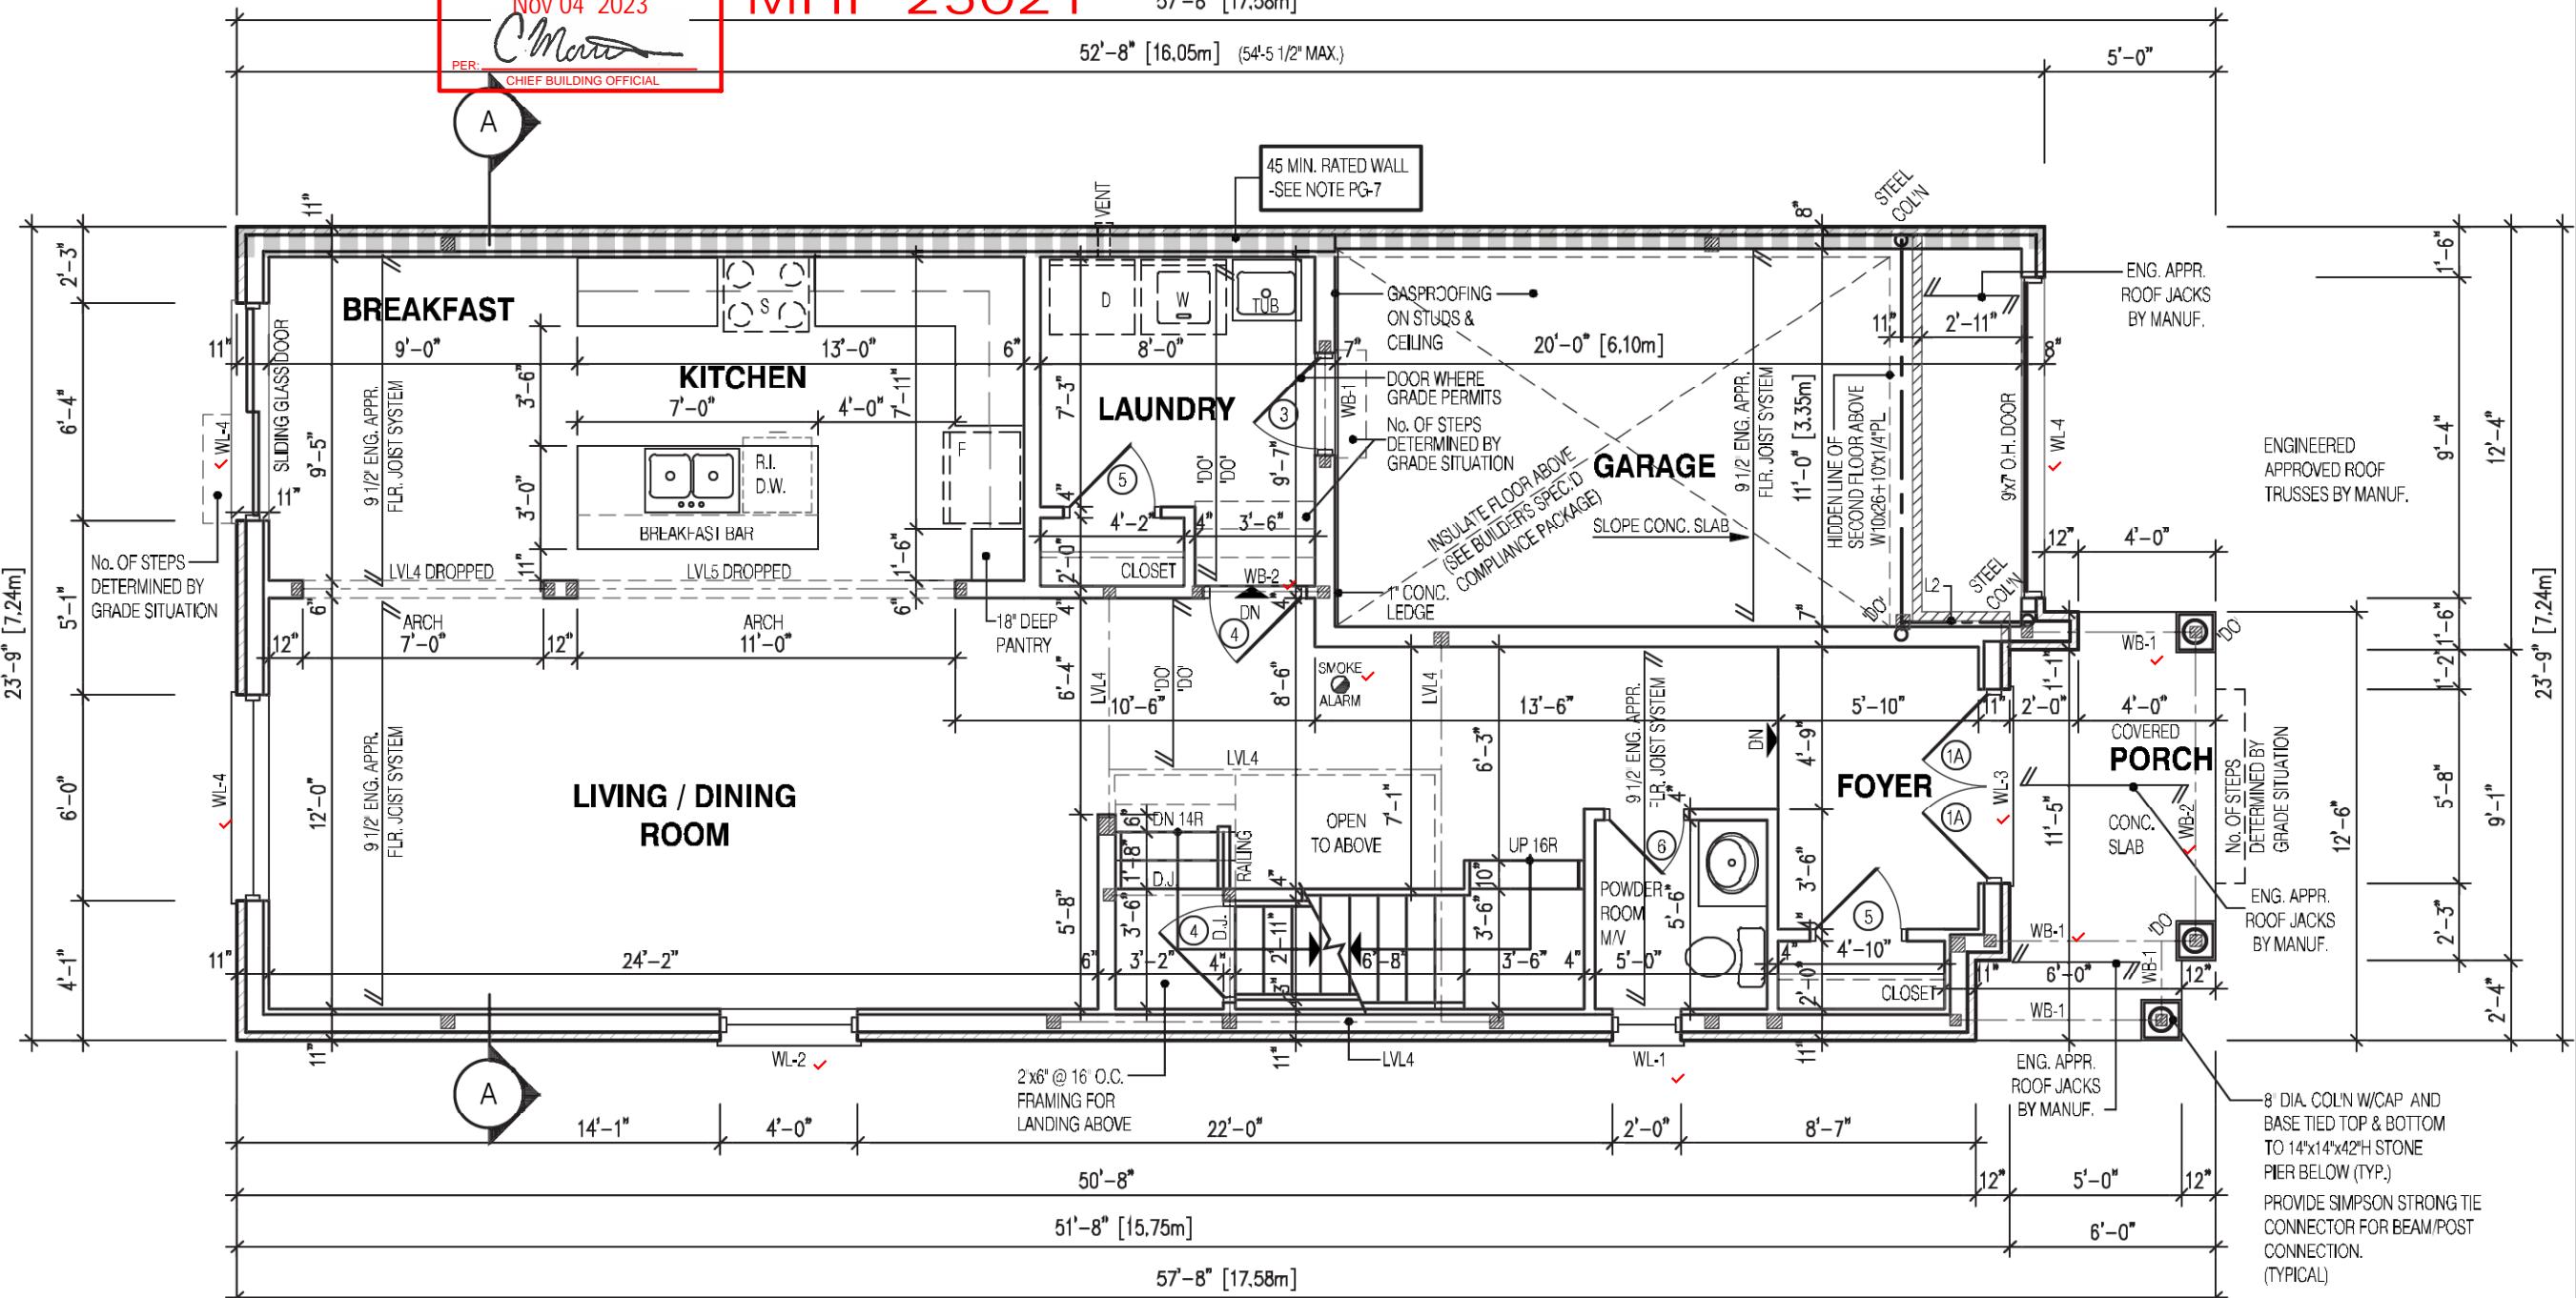

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3 MAY 4, 2023 COORDINATED FLOOR, ROOF AND ENGINEER COMMENTS  
2 MAR. 1, 2023 ISSUED TO CLIENT FOR PERMIT  
1 FEB. 14, 2023 INTRODUCED FROM JOB 21-35 MODEL GARDEN 1, 4 BED LAYOUT

No: DATE: WORK DESCRIPTION:  
**jardin**  
DESIGN GROUP INC  
64 JARDIN DR. SUITE 3A  
VAUGHAN ONT. L4K 3P3  
TEL: 905 660-3377 FAX: 905 660-3713  
EMAIL: info@jardindesign.ca

The undersigned has reviewed and takes responsibility for this design and has the qualifications and meets the requirements set out in the Ontario Building Code to be a designer

QUALIFICATION INFORMATION  
Required unless design is exempt under Division C, Subsection 3.2 of the building code

**Walter Botter** 21031  
NAME SIGNATURE BCIN

REGISTRATION INFORMATION  
Required unless design is exempt under Division C, Subsection 3.2 of the building code

**jardin design group inc.** 27763  
FIRM NAME BCIN

**FIRST FLOOR PLAN EL-2**  
ZADORRA ESTATE INC.  
CITY OF OSHAWA

STRUDET INC.



FOR STRUCTURE ONLY

JOHN G. WILLIAMS LTD., ARCHITECT  
ARCHITECTURAL CONTROL REVIEW  
AND APPROVAL

APPROVED BY: JUL 31, 2023

DATE: JUL 31, 2023

This stamp certifies compliance with the applicable Design Guidelines only and bears no further professional responsibility.

MODEL: RIVER 1 (GR)
SCALE: 3/16"=1'-0"
PROJ. No. 22-16
DWG. No. 2A

**NOTE:**  
THESE DRAWINGS ARE TO BE READ IN CONJUNCTION WITH ENGINEER APPROVED ROOF TRUSS DRAWINGS BY MANUFACTURER.

**NOTE:**  
REFER TO SHEET NO. 0-1 FOR LINTEL, BEAMS AND DOOR SIZE

**NOTE:**  
SPACE CONVENTIONAL FLOOR JOISTS @ 12 O.C. BELOW ALL CERAMIC TILE AREAS. PROVIDE 1 ROW BRIDGING FOR SPANS OF 5'-7", 2 ROWS FOR SPANS GREATER THAN 7'

**NOTE:**  
THESE DRAWINGS ARE TO BE READ IN CONJUNCTION WITH ENGINEER APPROVED FLOOR TRUSS LAYOUT BY MANUFACTURER.

**NOTE:**

SUBFLOOR TO BE 5/8" PLYWOOD ON THIS LEVEL  
ALL FLOORS TO BE NAILED AND GLUED ON THIS LEVEL

**LEGEND:**


- BUILDING FACE < THAN 4'-0" (1.2m) (45 MIN. FIRE RATING REQ'D)
- INDICATES SOLID BEARING REQUIRED OR POINT LOAD FROM ABOVE
- STL. PLATE FOR STEEL COLN ABOVE
- LVL LAMINATED VENEER LUMBER
- S.J. SINGLE JOIST
- D.J. DOUBLE JOIST
- T.J. TRIPLE JOIST
- REPEAT NOTE
- SHOWER WEEPERS

CORPORATION OF THE CITY OF OSHAWA	
TRUE COPY	
OF PERMIT PLANS	
Nov 04 2023	
	
PER:	CHIEF BUILDING OFFICIAL

MHP 23021

57'-8" [17.58m]

52'-8" [16.05m] (54'-5 1/2" MAX.)

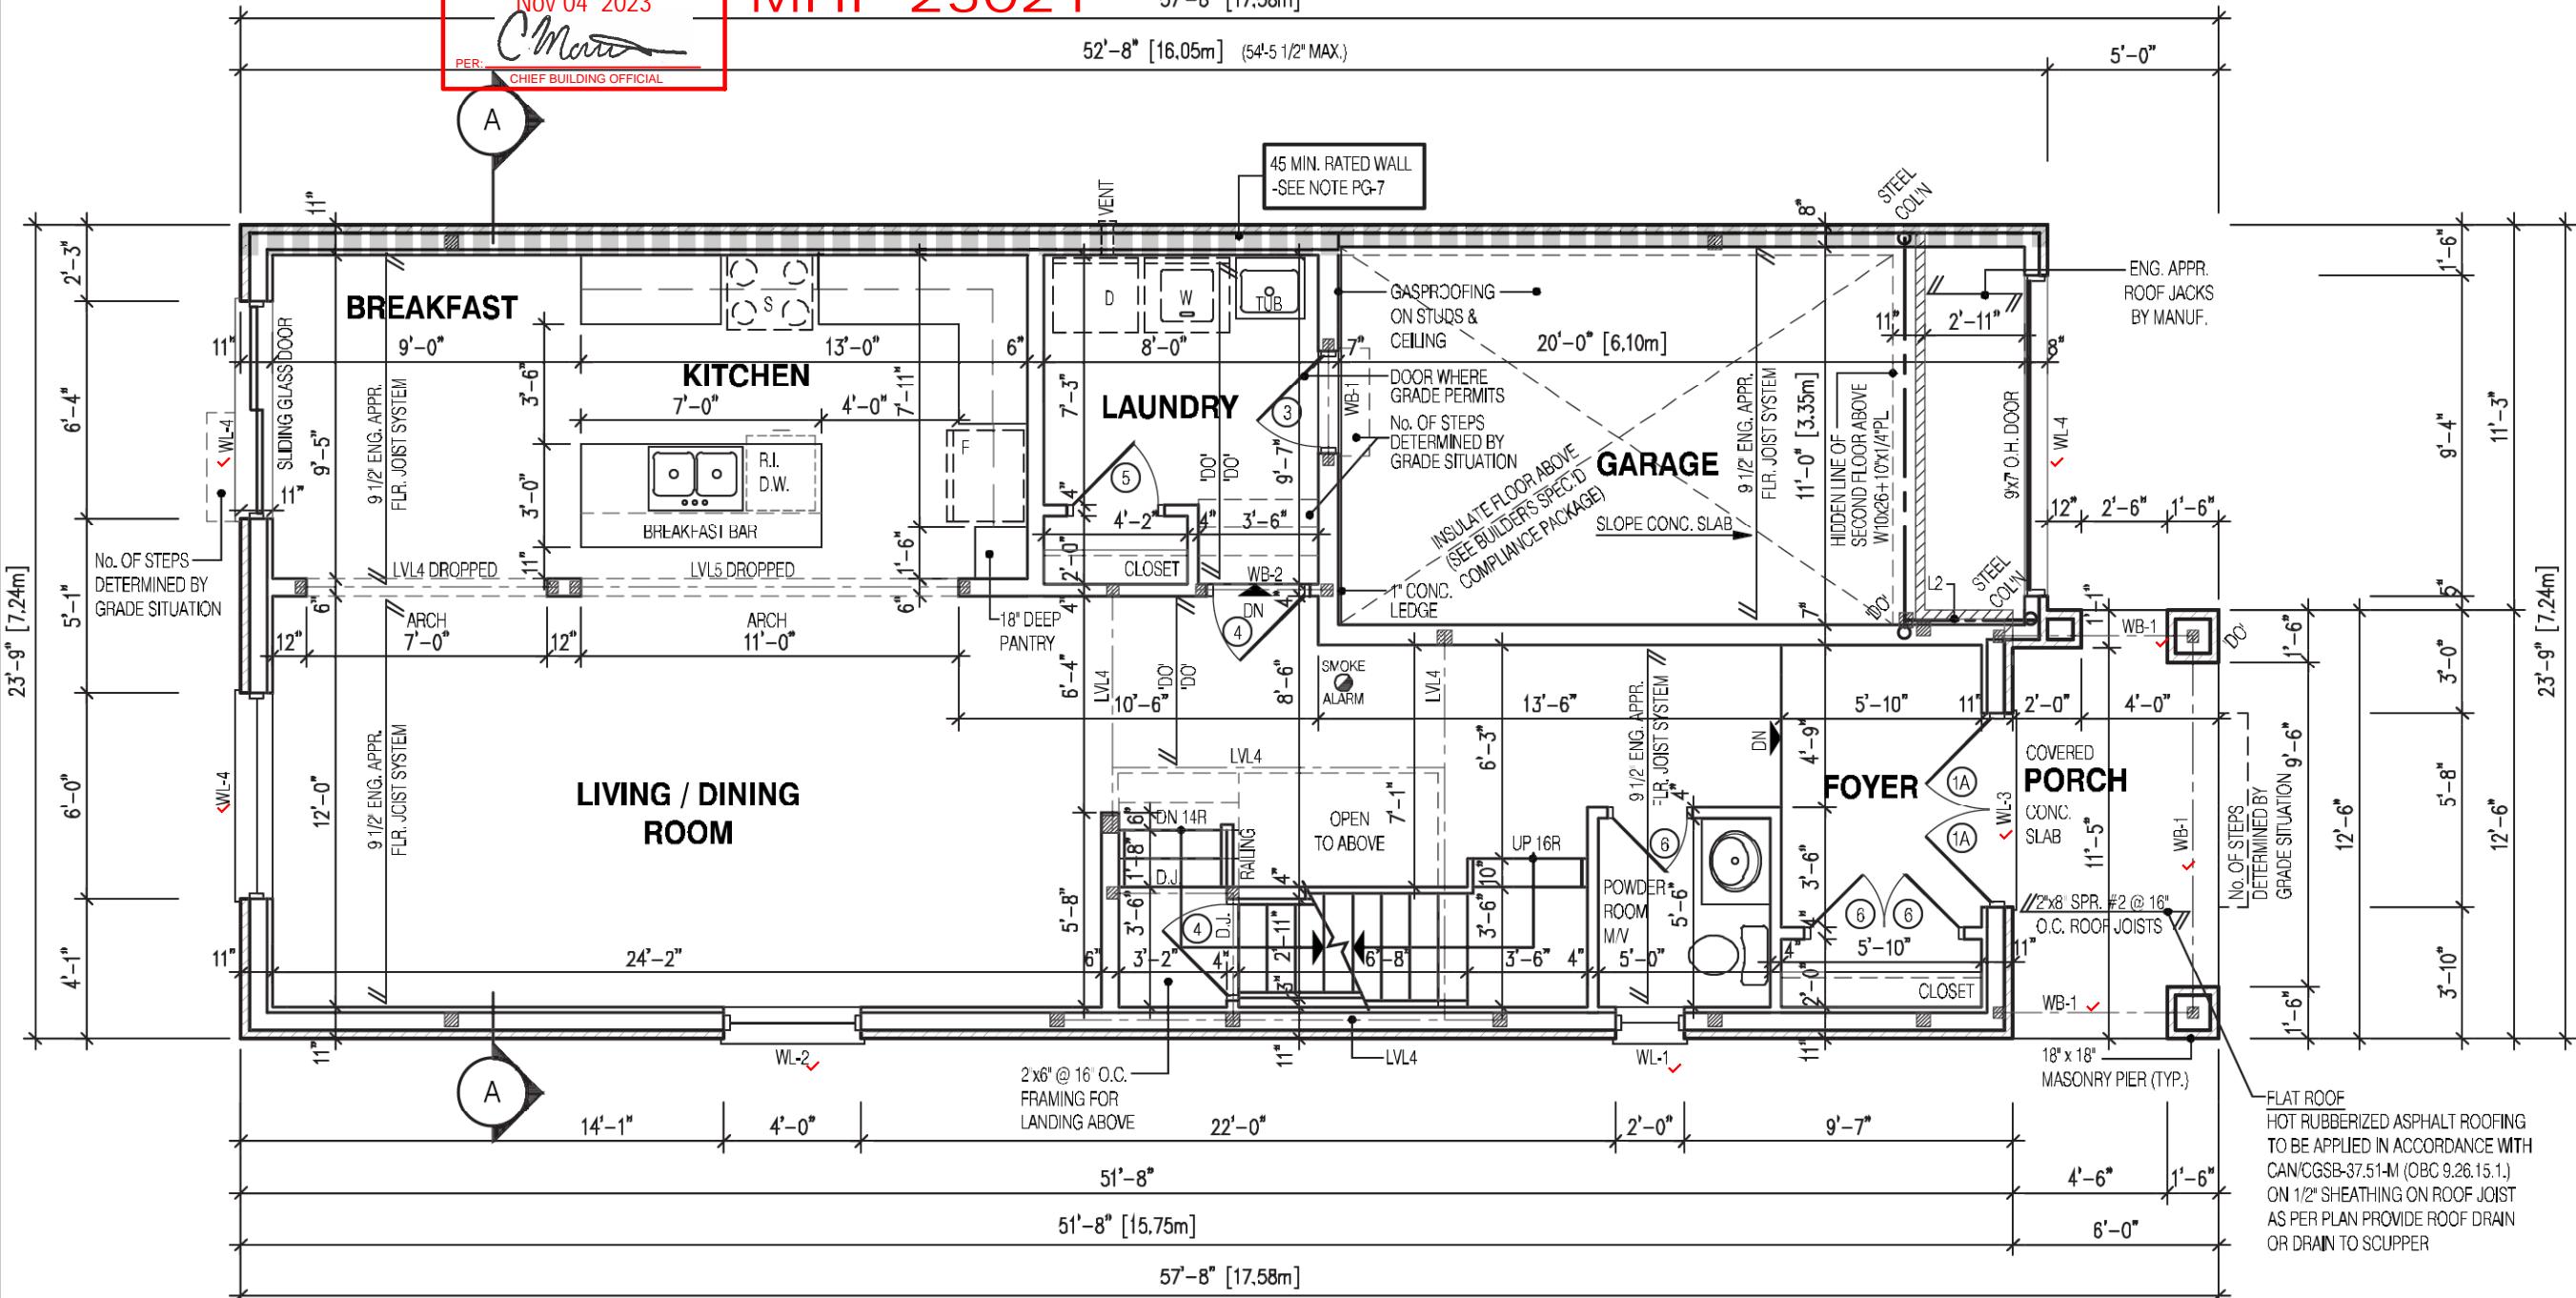

## **NOTE**

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CONJUNCTION WITH ENGINEER APPROVED  
ROOF TRUSS DRAWINGS BY MANUFACTURER

**NOTE**

**REFER TO SHEET NO. 0-1 FOR LINTEL  
BEAMS AND DOOR SIZE**

NOT

SPACE CONVENTIONAL FLOOR JOISTS @ 12' O.C. BELOW ALL CERAMIC TILE AREAS. PROVIDE 1 ROW BRIDGING FOR SPANS OF 5'-7", 2 ROWS FOR SPANS GREATER THAN 7'.

NOTE

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CONJUNCTION WITH ENGINEER APPROVED  
FLOOR TRUSS LAYOUT BY MANUFACTURER**

**NOTE:**

**LEGEND:**

- |      |  |
|------|--|
|      | BUILDING FACE < THAN 4'-0" (1.2m)<br>(45 MIN. FIRE RATING REQ'D) |
|      | INDICATES SOLID BEARING REQUIRED<br>OR POINT LOAD FROM ABOVE     |
|      | STL. PLATE FOR STEEL COLN ABOVE                                  |
| LVL  | LAMINATED VENEER LUMBER  |
| S.J. | SINGLE JOIST   |
| D.J. | DOUBLE JOIST   |
| T.J. | TRIPLE JOIST   |
|      | REPEAT NOTE  |
|      | SHOWER WEEPERS   |

FOR STRUCTURE ONLY



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This is to certify that these plans comply  
with the applicable Architectural Design  
Guidelines approved by the City of  
Oshawa

JOHN G. WILLIAMS LTD., ARCHITECT

#### **ARCHITECTURAL CONTROL REVIEW AND APPROVAL**



APPROVED BY: 

DATE: JUL 31, 2023

This stamp certifies compliance with the applicable

**Design Guidelines only and bears no further professional responsibility.**

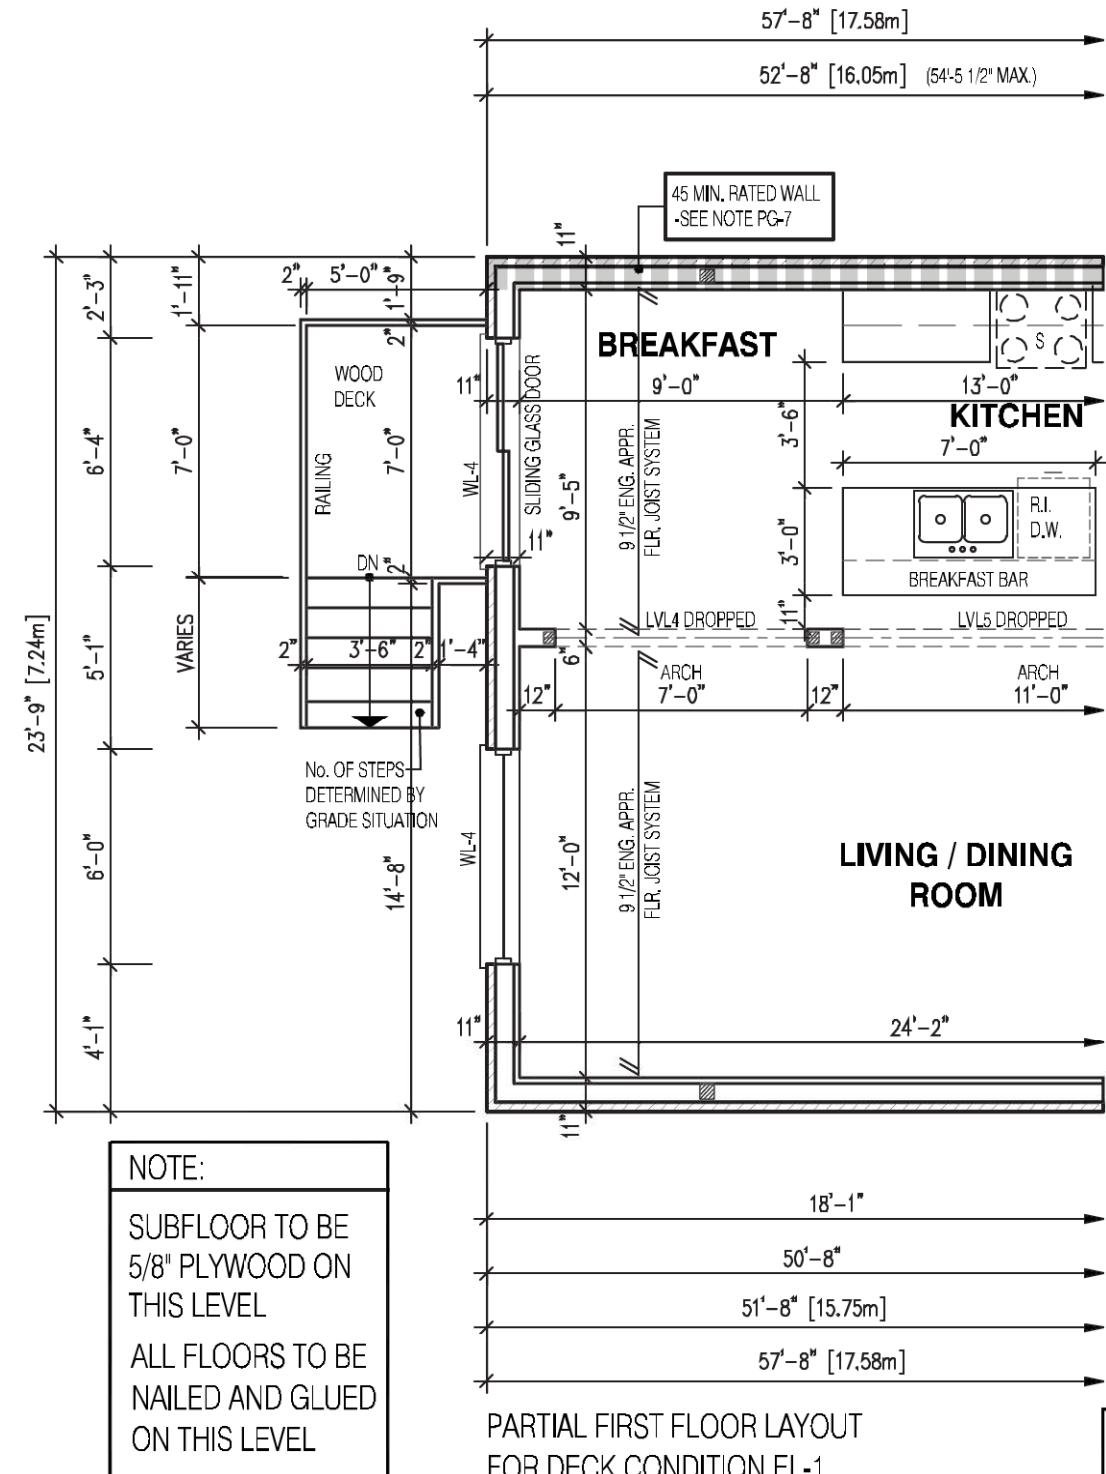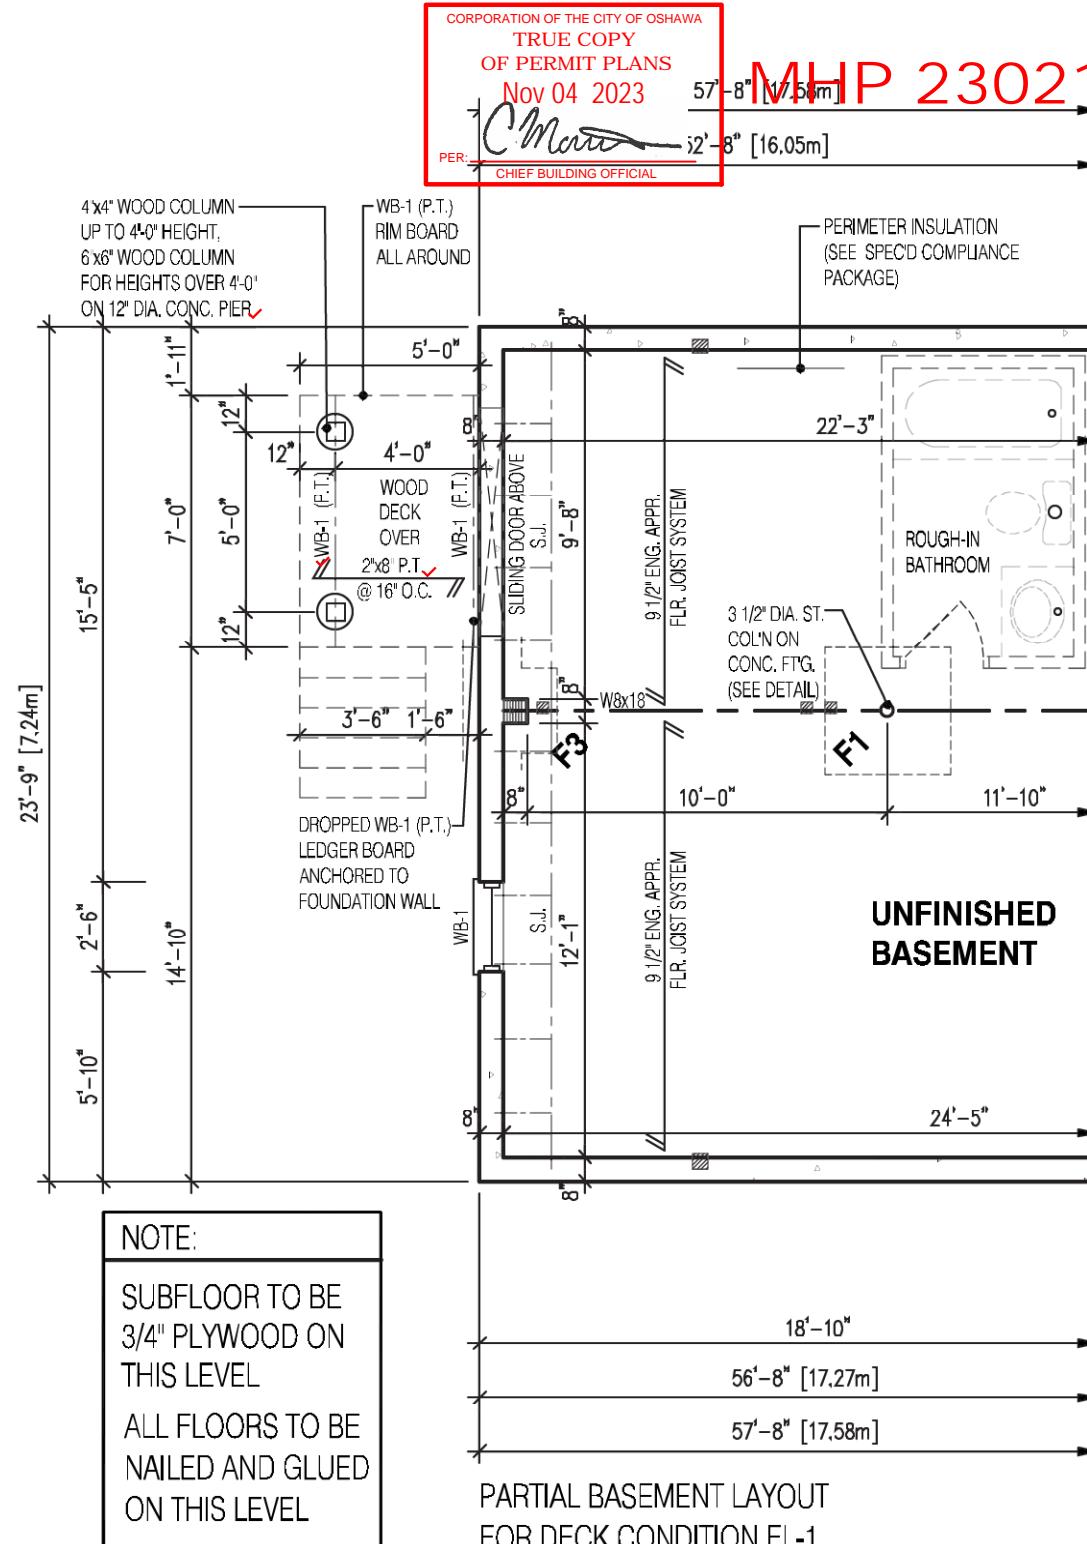

**LEGEND:**


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- T.J. TRIPLE JOIST
- REPEAT NOTE
- SHOWER WEEPERS

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**JOHN G. WILLIAMS LTD., ARCHITECT  
ARCHITECTURAL CONTROL REVIEW  
AND APPROVAL**

APPROVED BY: *[Signature]*  
DATE: JUL 31, 2023

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3 MAY 4, 2023 COORDINATED FLOOR, ROOF AND ENGINEER COMMENTS  
2 MAR. 1, 2023 ISSUED TO CLIENT FOR PERMIT  
1 FEB. 14, 2023 INTRODUCED FROM JOB 21-35 MODEL GARDEN 1, 4 BED LAYOUT

No: DATE: WORK DESCRIPTION:

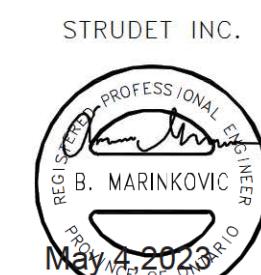**jardin**  
DESIGN GROUP INC  
64 JARDIN DR. SUITE 3A  
VAUGHAN ONT. L4K 3P3  
TEL: 905 660-3377 FAX: 905 660-3713  
EMAIL: info@jardindesign.ca

The undersigned has reviewed and takes responsibility for this design and has the qualifications and meets the requirements set out in the Ontario Building Code to be a designer

QUALIFICATION INFORMATION  
Required unless design is exempt under Division C, Subsection 3.2.5 of the building code

**Walter Botter** *[Signature]* 21031  
NAME SIGNATURE BCIN

REGISTRATION INFORMATION  
Required unless design is exempt under Division C, Subsection 3.2.4 of the building code

**jardin design group inc.** 27763  
FIRM NAME BCIN

**DECK CONDITION EL-1**

ZADORRA ESTATE INC.  
CITY OF OSHAWA

MODEL: RIVER 1 (GR)
SCALE: 3/16"=1'-0"
PROJ. No. 22-16
DWG. No 3-1

**NOTE:**  
**WHEN VENEER CUT IS GREATER THAN 26" A 10" POURED CONC. FOUNDATION WALL IS REQUIRED. (FOUNDATION PLAN TO BE REVIEWED IN CONJUNCTION WITH SITE PLAN)**

**NOTE:**  
REFER TO SHEET NO. 0 - FOR LINTEL, BEAMS AND DOOR SIZE

**NOTE:**  
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**NOTE:**


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CORPORATION OF THE CITY OF OSHAWA  
TRUE COPY  
OF PERMIT PLANS  
Nov 04 2023  
*C. Marinkovic*  
PER:  
CHIEF BUILDING OFFICIAL

MHP 23021 51'-8" [15.75m]

**NOTE:**

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- S.J. SINGLE JOIST
- D.J. DOUBLE JOIST
- T.J. TRIPLE JOIST
- REPEAT NOTE
- SHOWER WEEPERS

STRUDET INC.

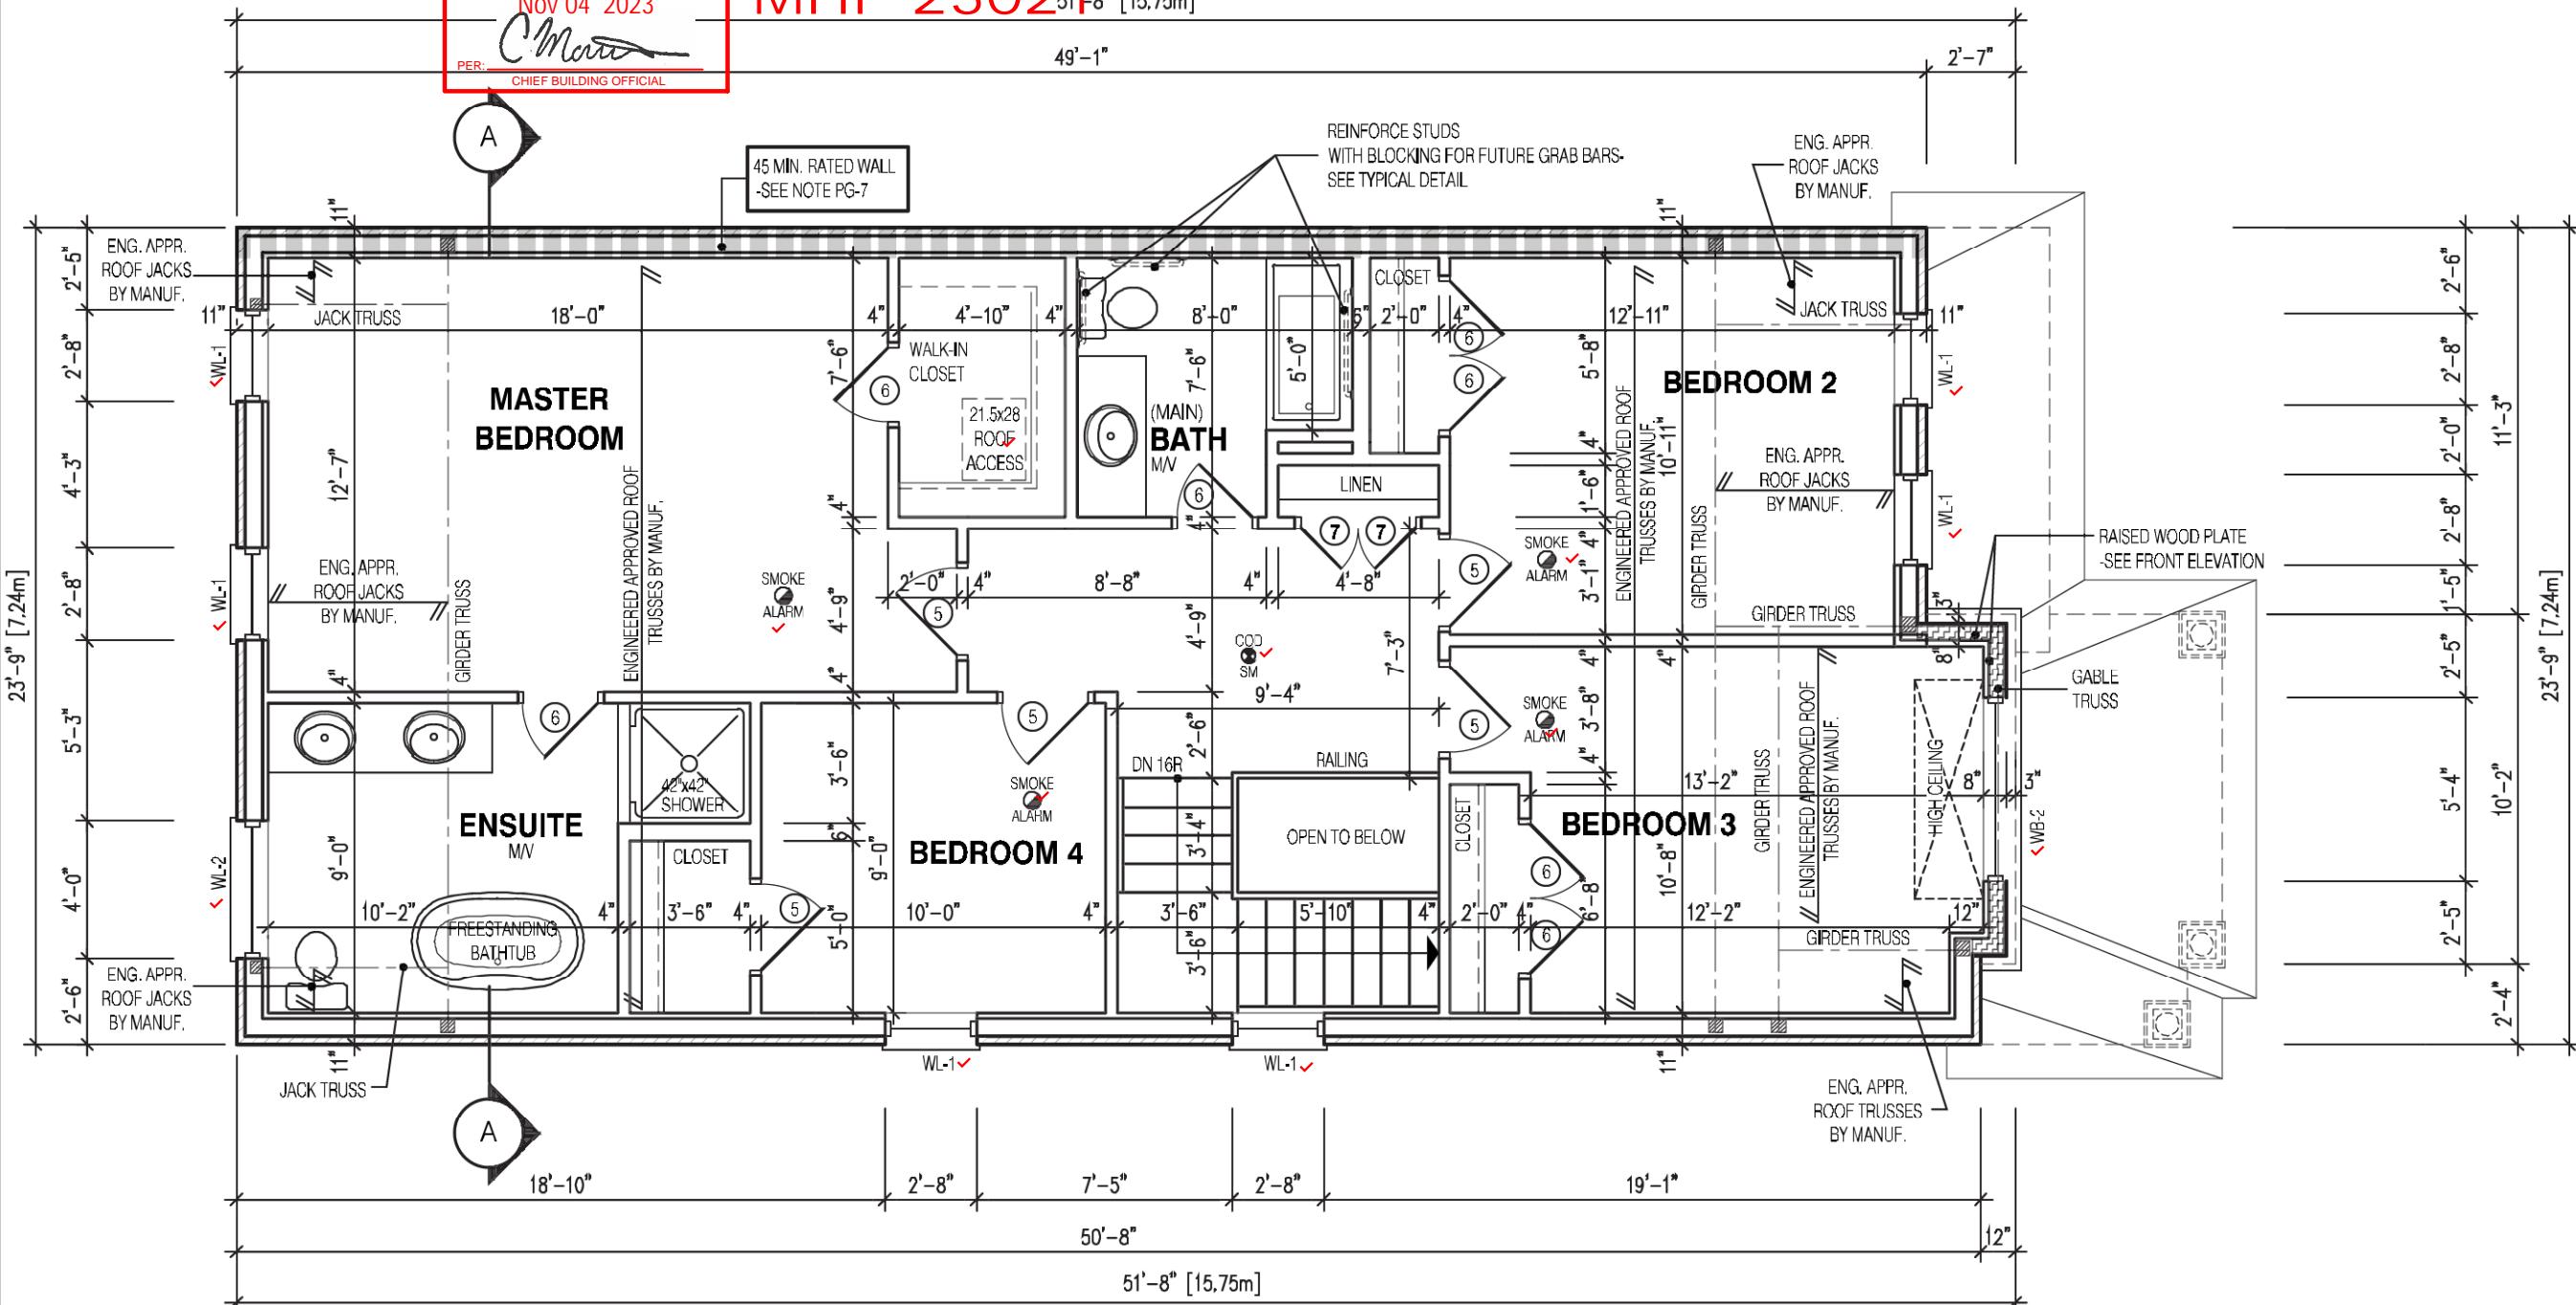

FOR STRUCTURE ONLY

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JOHN G. WILLIAMS LTD., ARCHITECT  
ARCHITECTURAL CONTROL REVIEW  
AND APPROVAL  
APPROVED BY: *[Signature]*  
DATE: JUL 31, 2023  
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MODEL: RIVER 1 (GR)
SCALE: 3/16"=1'-0"
PROJ. No. 22-16 DWG. No. 3A

jardin  
DESIGN GROUP INC

64 JARDIN DR. SUITE 3A  
VAUGHAN ONT. L4K 3P3  
TEL: 905 660-3377 FAX: 905 660-3713  
EMAIL: info@jardindesign.ca

The undersigned has reviewed and takes responsibility for this design and has the qualifications and meets the requirements set out in the Ontario Building Code to be a designer

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Walter Botter *[Signature]* 21031  
NAME SIGNATURE BCIN

REGISTRATION INFORMATION  
Required unless design is exempt under Division C, Subsection 3.2.4 of the building code

jardin design group inc. 27763

FIRM NAME BCIN

SECOND FL. PLAN EL-2

ZADORRA ESTATE INC.  
CITY OF OSHAWA



2190

9.14m LOTS



RIVER 1 (GR)  
ELEVATION 3

## A1 PACKAGE

O.REG. 332/12



MHP 23021 51'-8" [15.75m]

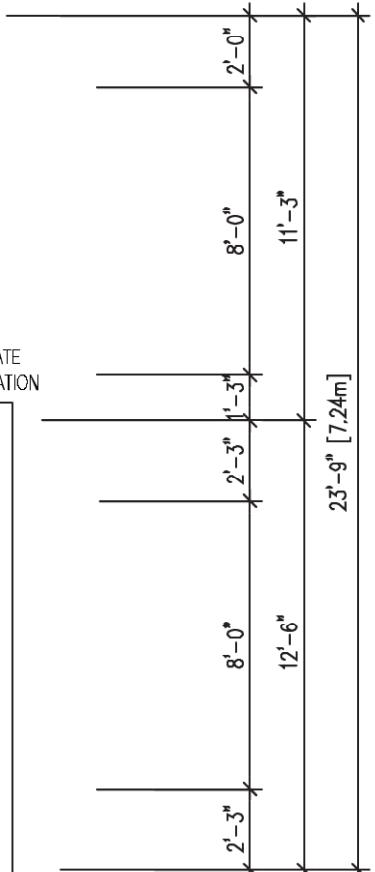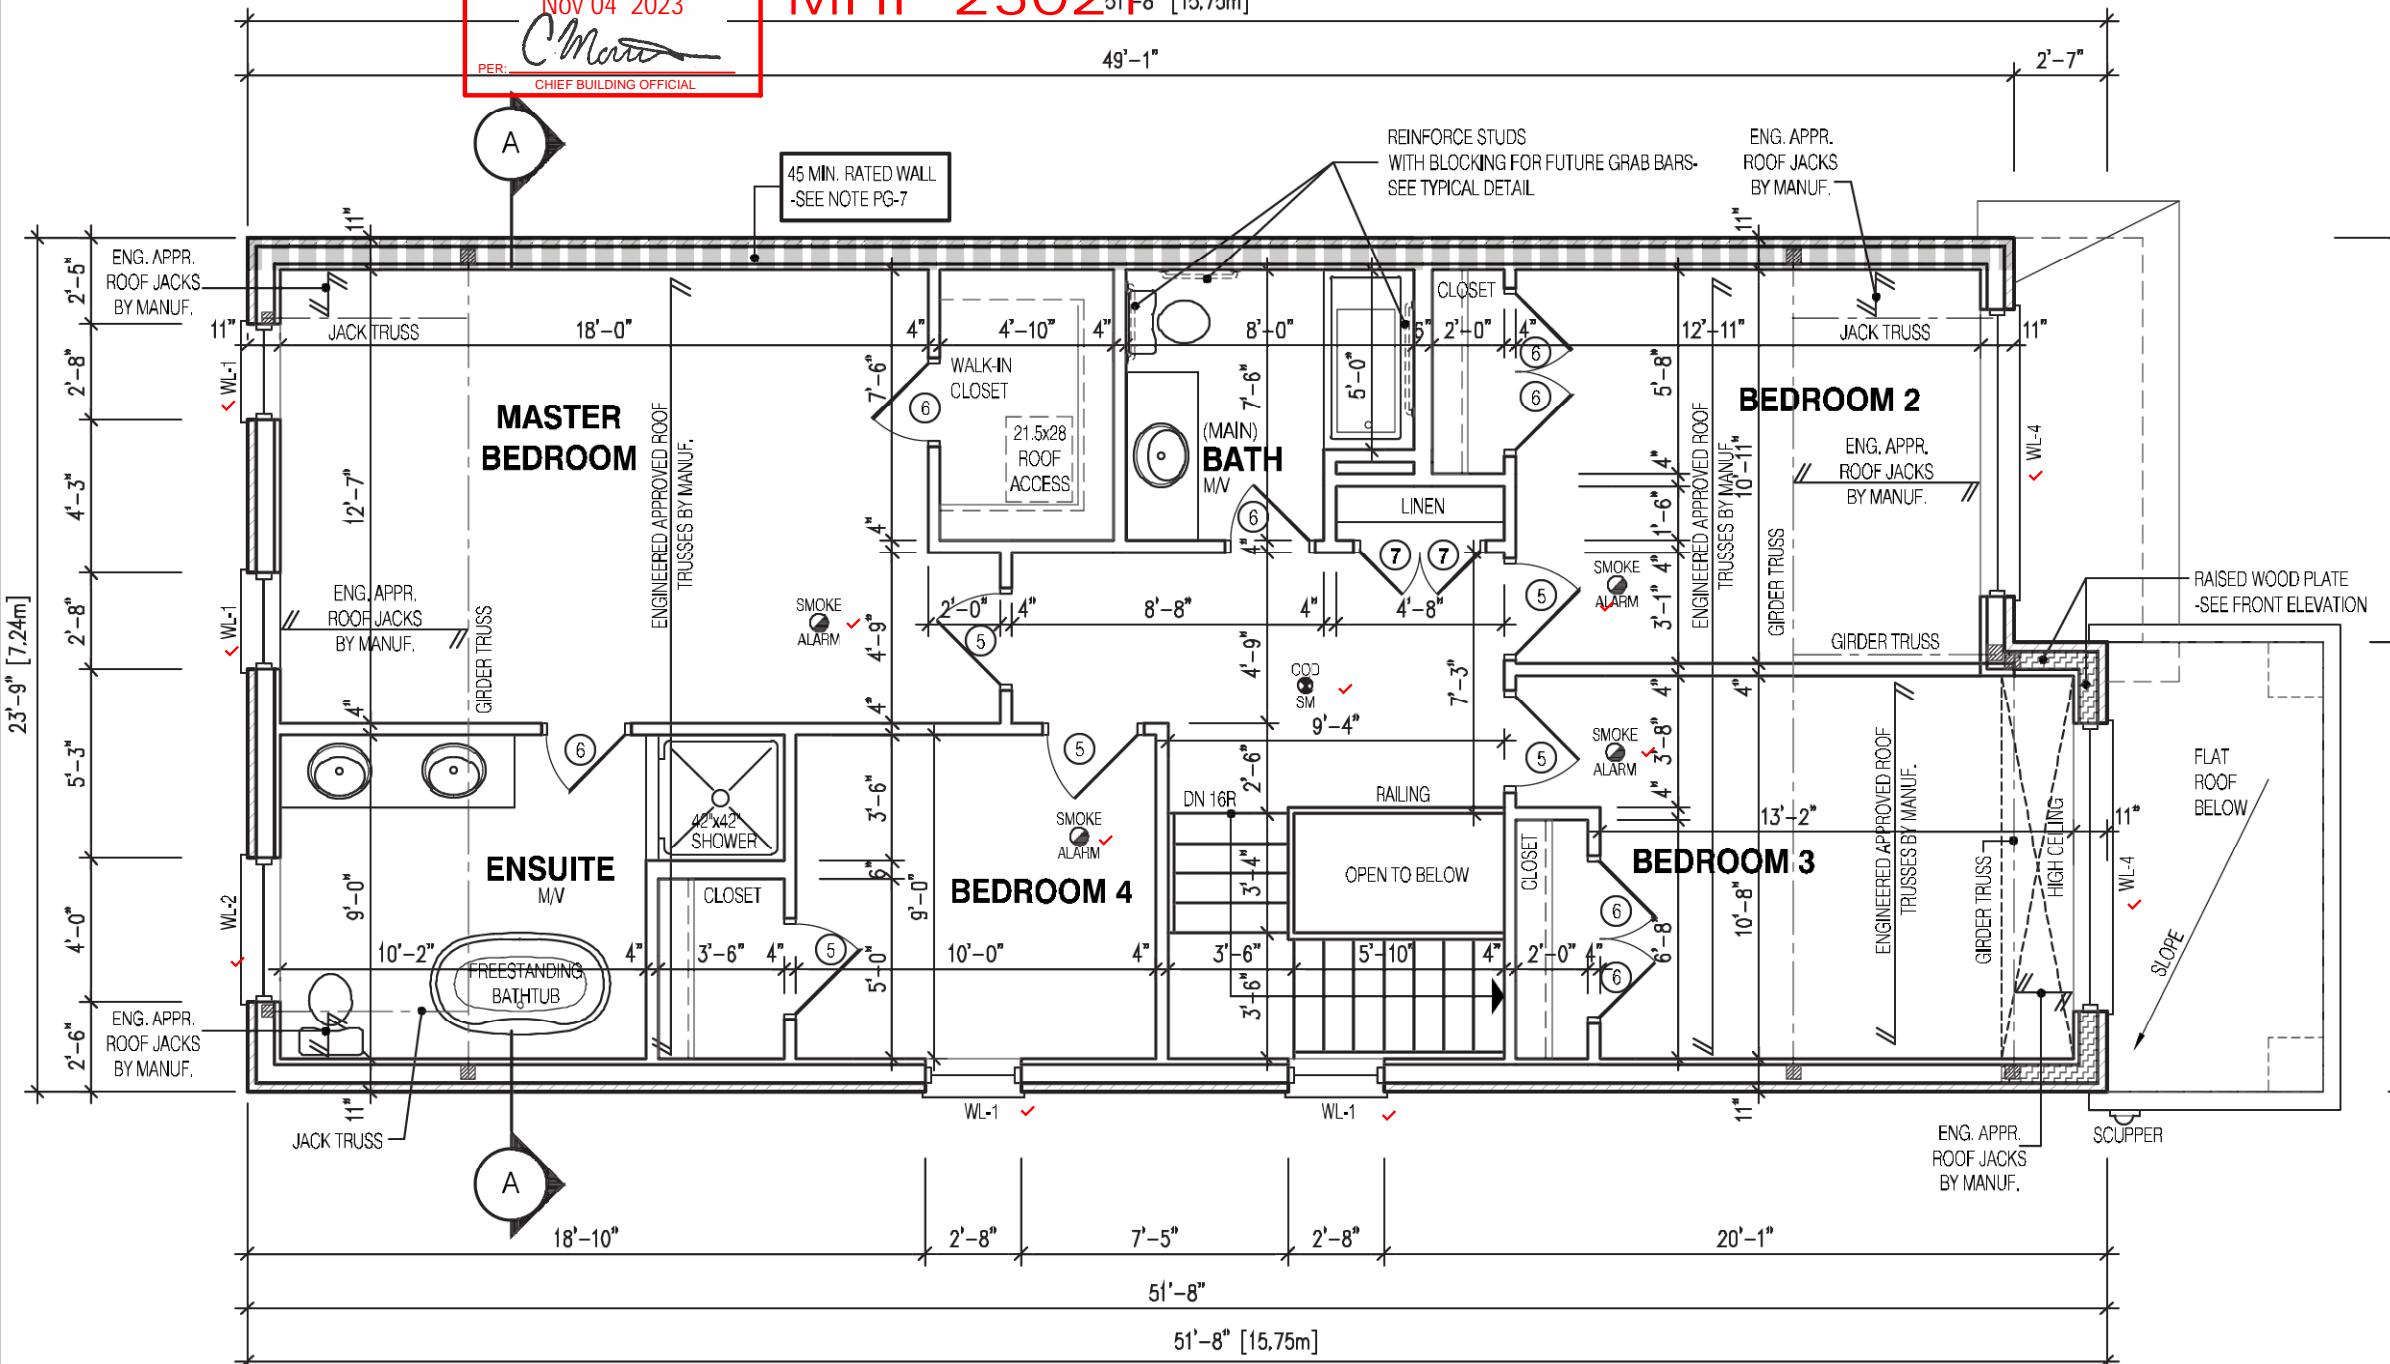

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MAY 4, 2023 COORDINATED FLOOR, ROOF AND ENGINEER COMMENTS  
MAR 1, 2023 ISSUED TO CLIENT FOR PERMIT  
FEB 14, 2023 INTRODUCED FROM JOB 21-35 MODEL GARDEN 1, 4 BED LAYOUT

No: DATE: WORK DESCRIPTION:

**jardin**  
DESIGN GROUP INC  
64 JARDIN DR. SUITE 3A  
VAUGHAN ONT. L4K 3P3  
TEL: 905 660-3377 FAX: 905 660-3713  
EMAIL: info@jardindesign.ca

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*Walter Botter* 21031  
NAME SIGNATURE BCIN


REGISTRATION INFORMATION  
Required unless design is exempt under Division C, Subsection 3.2.4 of the building code

*jardin design group inc.* 27763

FIRM NAME BCIN

## SECOND FL. PLAN EL-3

ZADORRA ESTATE INC.  
CITY OF OSHAWA

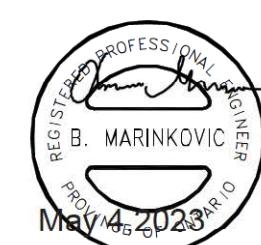

B. MARINKOVIC  
PROV. REG. OF ONTARIO  
May 4, 2023  
FOR STRUCTURE ONLY

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JOHN G. WILLIAMS LTD., ARCHITECT  
ARCHITECTURAL CONTROL REVIEW  
AND APPROVAL  
APPROVED BY: DATE: JUL 31, 2023  
This stamp certifies compliance with the applicable Design Guidelines only and bears no further professional responsibility.

MODEL: RIVER 1 (GR)
SCALE: 3/16"=1'-0"
PROJ. No. 22-16
DWG. No. 3B

**BILD**

## NOTE:

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2190

9.14m LOTS

RIVER 1 (GR)  
ELEVATION 3

A1 PACKAGE

O.REG. 332/12

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3 MAY 4, 2023 COORDINATED FLOOR, ROOF AND ENGINEER COMMENTS

2 MAR. 1, 2023 ISSUED TO CLIENT FOR PERMIT

1 FEB. 14, 2023 INTRODUCED FROM JOB 21-35 MODEL GARDEN 1, 4 BED LAYOUT

No: DATE: WORK DESCRIPTION:

**jardin**  
DESIGN GROUP INC

64 JARDIN DR. SUITE 3A  
VAUGHAN ONT. L4K 3P3  
TEL: 905 660-3377 FAX: 905 660-3713  
EMAIL: info@jardindesign.ca

The undersigned has reviewed and takes responsibility for this design and has the qualifications and meets the requirements set out in the Ontario Building Code to be a designer

QUALIFICATION INFORMATION  
Required unless design is exempt under Division C, Subsection 3.2.5 of the building code

**Walter Botter**   
NAME SIGNATURE BCIN

REGISTRATION INFORMATION  
Required unless design is exempt under Division C, Subsection 3.2.4 of the building code

**jardin design group inc.** 27763  
FIRM NAME BCIN


**FRONT ELEVATION 3**  
ZADORRA ESTATE INC.  
CITY OF OSHAWA

JOHN G. WILLIAMS LTD., ARCHITECT  
ARCHITECTURAL CONTROL REVIEW  
AND APPROVAL  
APPROVED BY:   
DATE: JUL 31, 2023  
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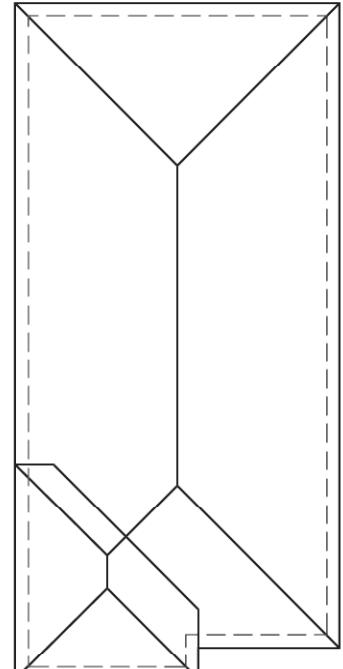
MODEL: RIVER 1 (GR)
SCALE: 3/16"=1'-0"
PROJ. No. 22-16
DWG. No. 4B

CORPORATION OF THE CITY OF OSHAWA  
TRUE COPY  
OF PERMIT PLANS  
Nov 04 2023  
  
PER: CHIEF BUILDING OFFICIAL

MHP 23021

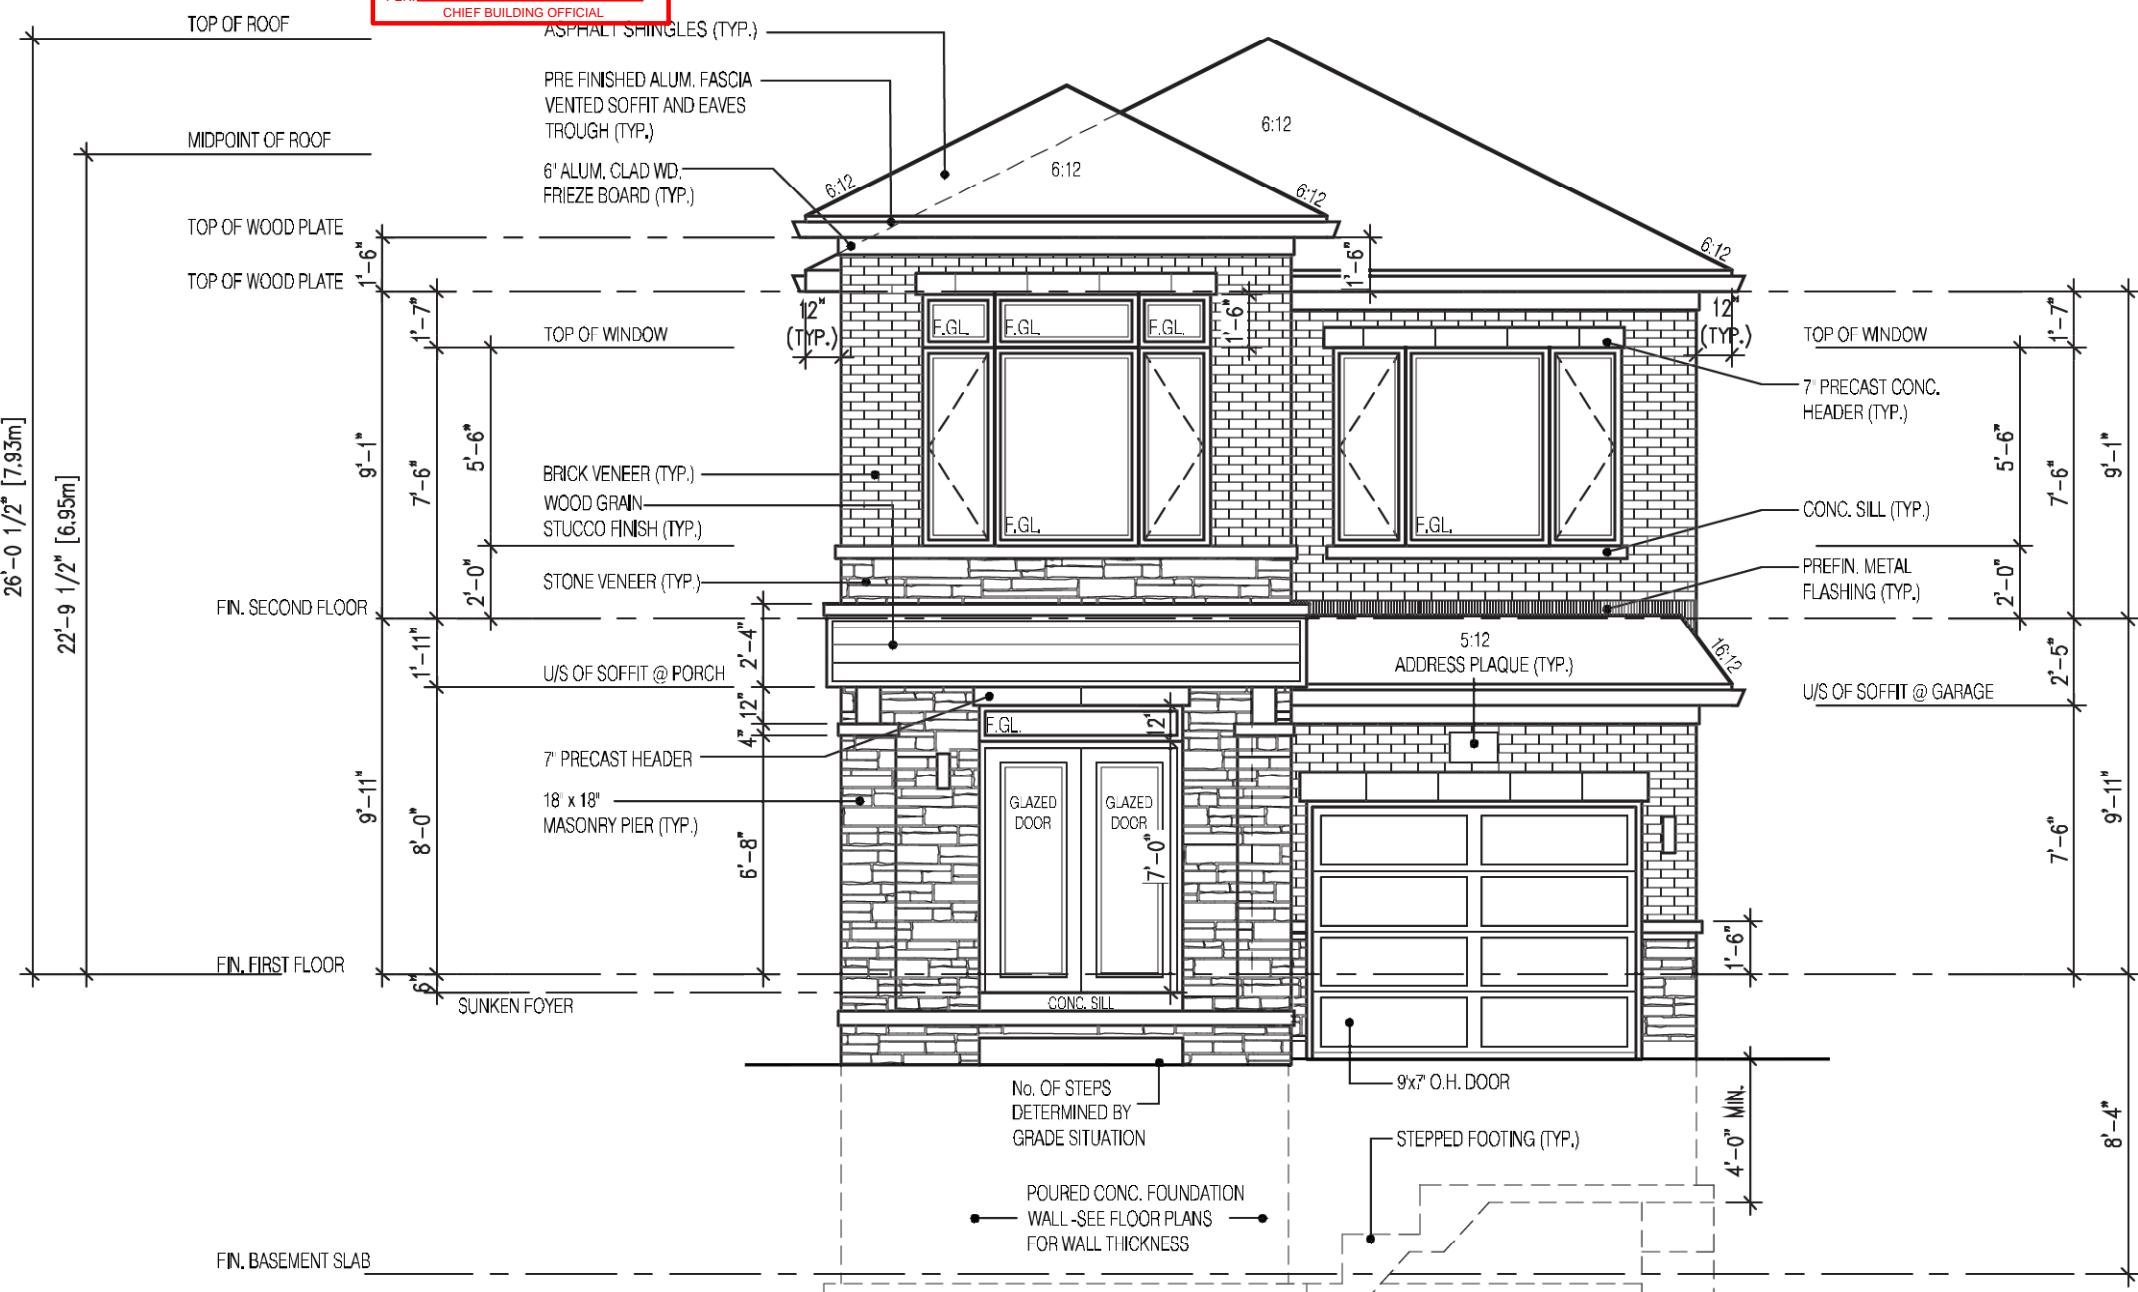

## RIVER 1 FRONT ELEVATION 3



ROOF PLAN EL-3  
N.T.S.

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2190

9.14m LOTS

RIVER 1 (GR)  
ELEVATION 2

A1 PACKAGE

O.REG. 332/12

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3	MAY 4, 2023 COORDINATED FLOOR, ROOF AND ENGINEER COMMENTS
2	MAR. 1, 2023 ISSUED TO CLIENT FOR PERMIT
1	FEB. 14, 2023 INTRODUCED FROM JOB 21-35 MODEL GARDEN 1, 4 BED LAYOUT

No: DATE: WORK DESCRIPTION:

**jardin**  
DESIGN GROUP INC  
64 JARDIN DR. SUITE 3A  
VAUGHAN ONT. L4K 3P3  
TEL: 905 660-3377 FAX: 905 660-3713  
EMAIL: info@jardindesign.ca

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Walter Botter   
NAME SIGNATURE BCIN

REGISTRATION INFORMATION  
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jardin design group inc. 27763

FIRM NAME BCIN


SIDE ELEVATION 2

ZADORRA ESTATE INC.  
CITY OF OSHAWA

	MODEL: RIVER 1 (GR)
	SCALE: 3/16"=1'-0"
	PROJ. No. DWG. No 22-16 5A
JOHN G. WILLIAMS LTD., ARCHITECT ARCHITECTURAL CONTROL REVIEW AND APPROVAL	
APPROVED BY: 	
DATE: JUL 31, 2023	
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CORPORATION OF THE CITY OF OSHAWA  
TRUE COPY  
OF PERMIT PLANS  
Nov 04 2023  
PER:   
CHIEF BUILDING OFFICIAL

MHP 23021

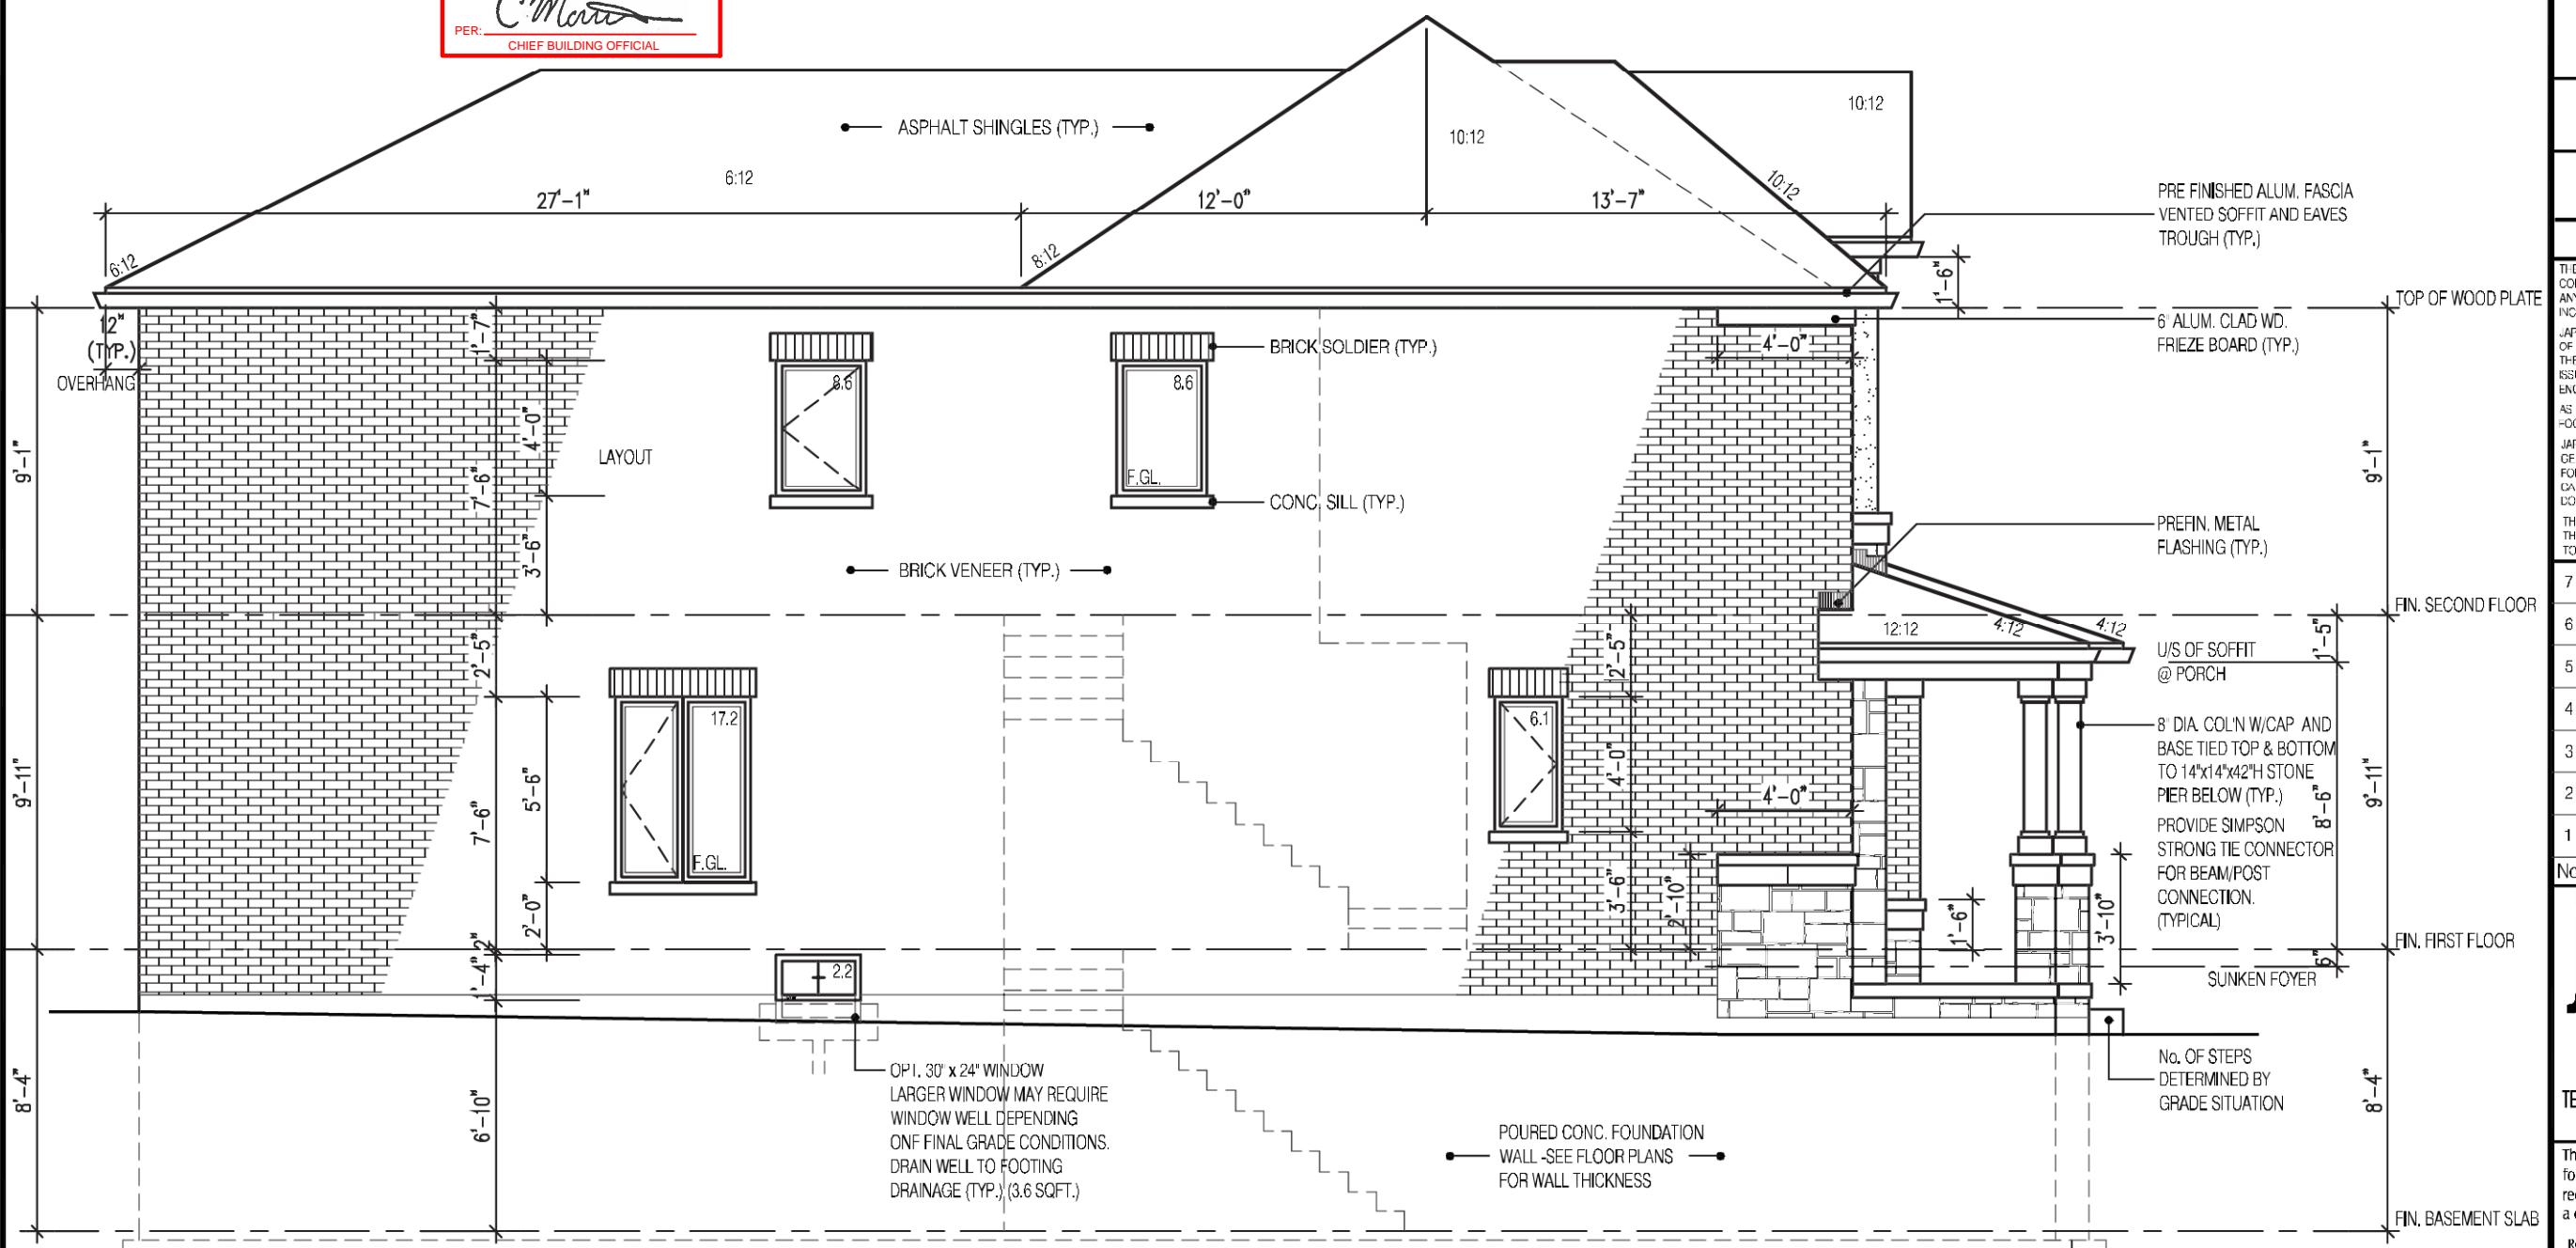

## LEFT SIDE ELEVATION 2

## UNPROTECTED OPENINGS

## WALL AREA

1073 □

## ALLOWABLE WINDOW AREA @ 7.0%(1.2m SIDEYARD)

75.11 □

## ACTUAL GLAZED AREA

42.61 □

## WITH OPTIONAL 30"x24" BASEMENT WINDOWS

46.21 □

## ACTUAL GLASS AREA

2190

9.14m LOTS


**RIVER 1 (GR)  
ELEVATION 3**

A1 PACKAGE

O.REG. 332/12

CORPORATION OF THE CITY OF OSHAWA  
TRUE COPY  
OF PERMIT PLANS  
Nov 04 2023  
  
C. Morris  
ER:  
CHIEF BUILDING OFFICIAL

MHP 23021

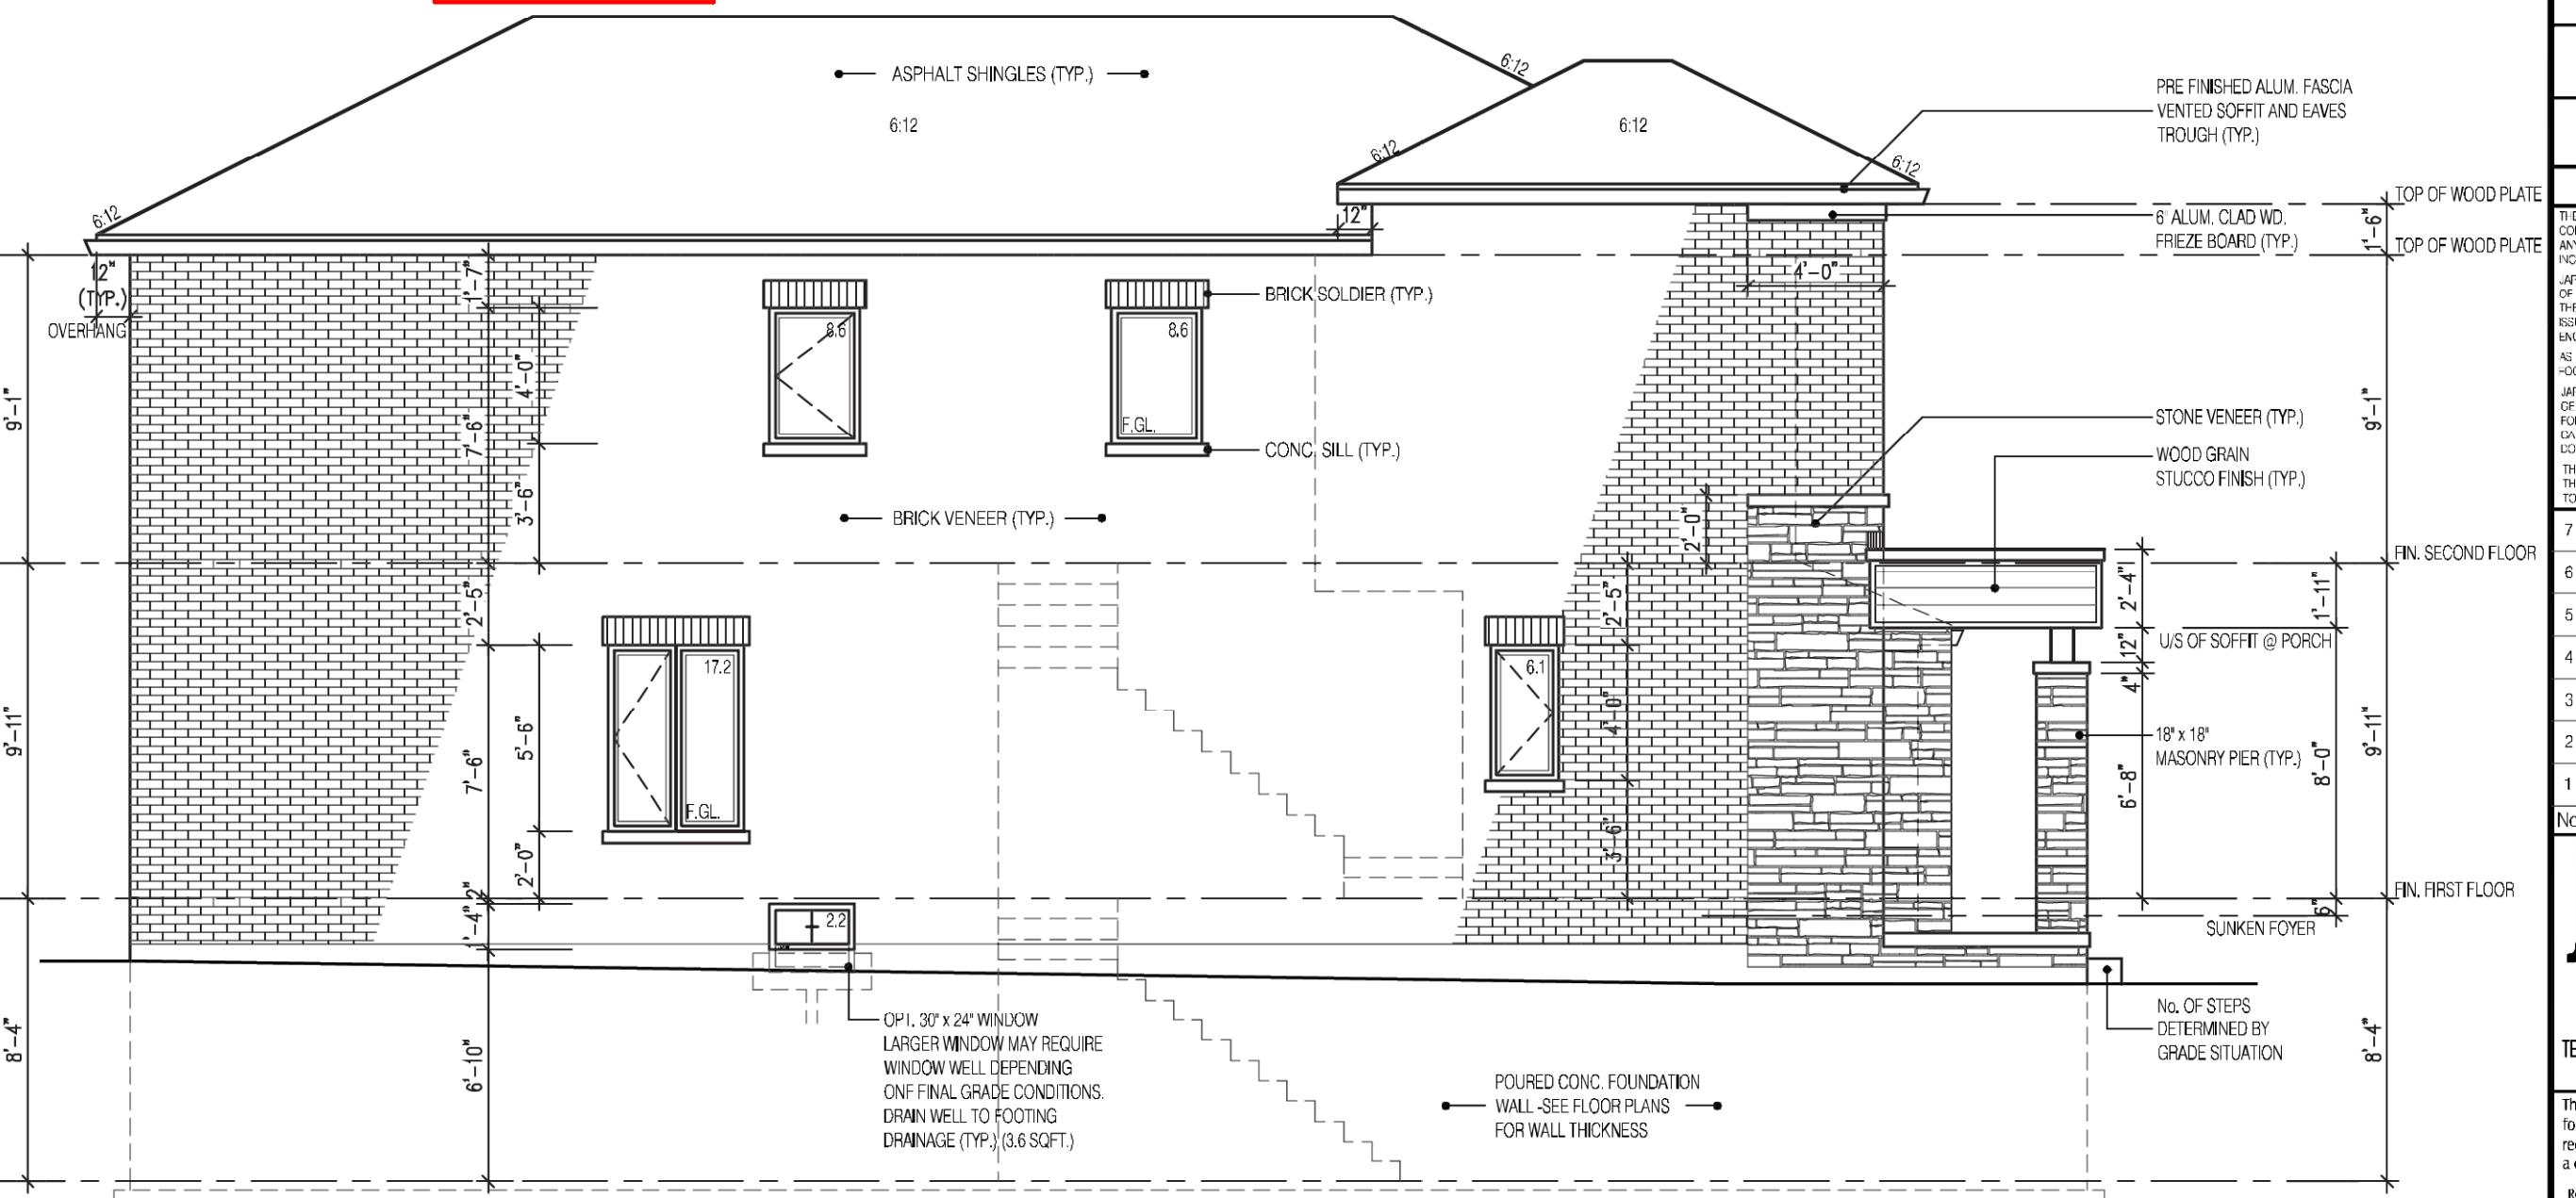

## **LEFT SIDE ELEVATION 3**

## UNPROTECTED OPENINGS

## WALL AREA

**ALLOWABLE WINDOW AREA @ 7.0%(1.2m SIDEYARD)**

### ACTUAL GLAZED AREA

WITH OPTIONAL 30"x24" BASEMENT WINDOWS

---

**ACTUAL GLASS AREA**

1117 中

78.19 中

42.61 中

46.21 ✓

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**JOHN G. WILLIAMS LTD., ARCHITECT**  
**ARCHITECTURAL CONTROL REVIEW**  
**AND APPROVAL**

APPROVED BY: 

DATE: JULY 31, 2023

This stamp certifies compliance with the applicable  
Design Guidelines only and bears no further  
professional responsibility.

	MODEL: RIVER 1 (GR)
SCALE: 3/16"=1'-0"	
PROJ. No. 22-16	DWG. No. 5B

2190

9.14m LOTS

RIVER 1 (GR)  
ELEVATION 1

A1 PACKAGE

O.REG. 332/12

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3	MAY 4, 2023 COORDINATED FLOOR, ROOF AND ENGINEER COMMENTS
2	MAR. 1, 2023 ISSUED TO CLIENT FOR PERMIT
1	FEB. 14, 2023 INTRODUCED FROM JOB 21-35 MODEL GARDEN 1, 4 BED LAYOUT

No: DATE: WORK DESCRIPTION:

**jardin**  
DESIGN GROUP INC

64 JARDIN DR. SUITE 3A  
VAUGHAN ONT. L4K 3P3  
TEL: 905 660-3377 FAX: 905 660-3713  
EMAIL: info@jardindesign.ca

The undersigned has reviewed and takes responsibility for this design and has the qualifications and meets the requirements set out in the Ontario Building Code to be a designer

QUALIFICATION INFORMATION  
Required unless design is exempt under Division C, Subsection 3.2.5 of the building code

**Walter Botter**   
NAME SIGNATURE BCIN

REGISTRATION INFORMATION  
Required unless design is exempt under Division C, Subsection 3.2.4 of the building code

**jardin design group inc.** 27763  
FIRM NAME BCIN


**REAR ELEVATION 1**  
ZADORRA ESTATE INC.  
CITY OF OSHAWA

JOHN G. WILLIAMS LTD., ARCHITECT ARCHITECTURAL CONTROL REVIEW AND APPROVAL	
APPROVED BY: 	
DATE: JUL 31, 2023	
This stamp certifies compliance with the applicable Design Guidelines only and bears no further professional responsibility.	

MODEL: RIVER 1 (GR)
SCALE: 3/16"=1-0"
PROJ. No. 22-16
DWG. No. 6



MHP 23021

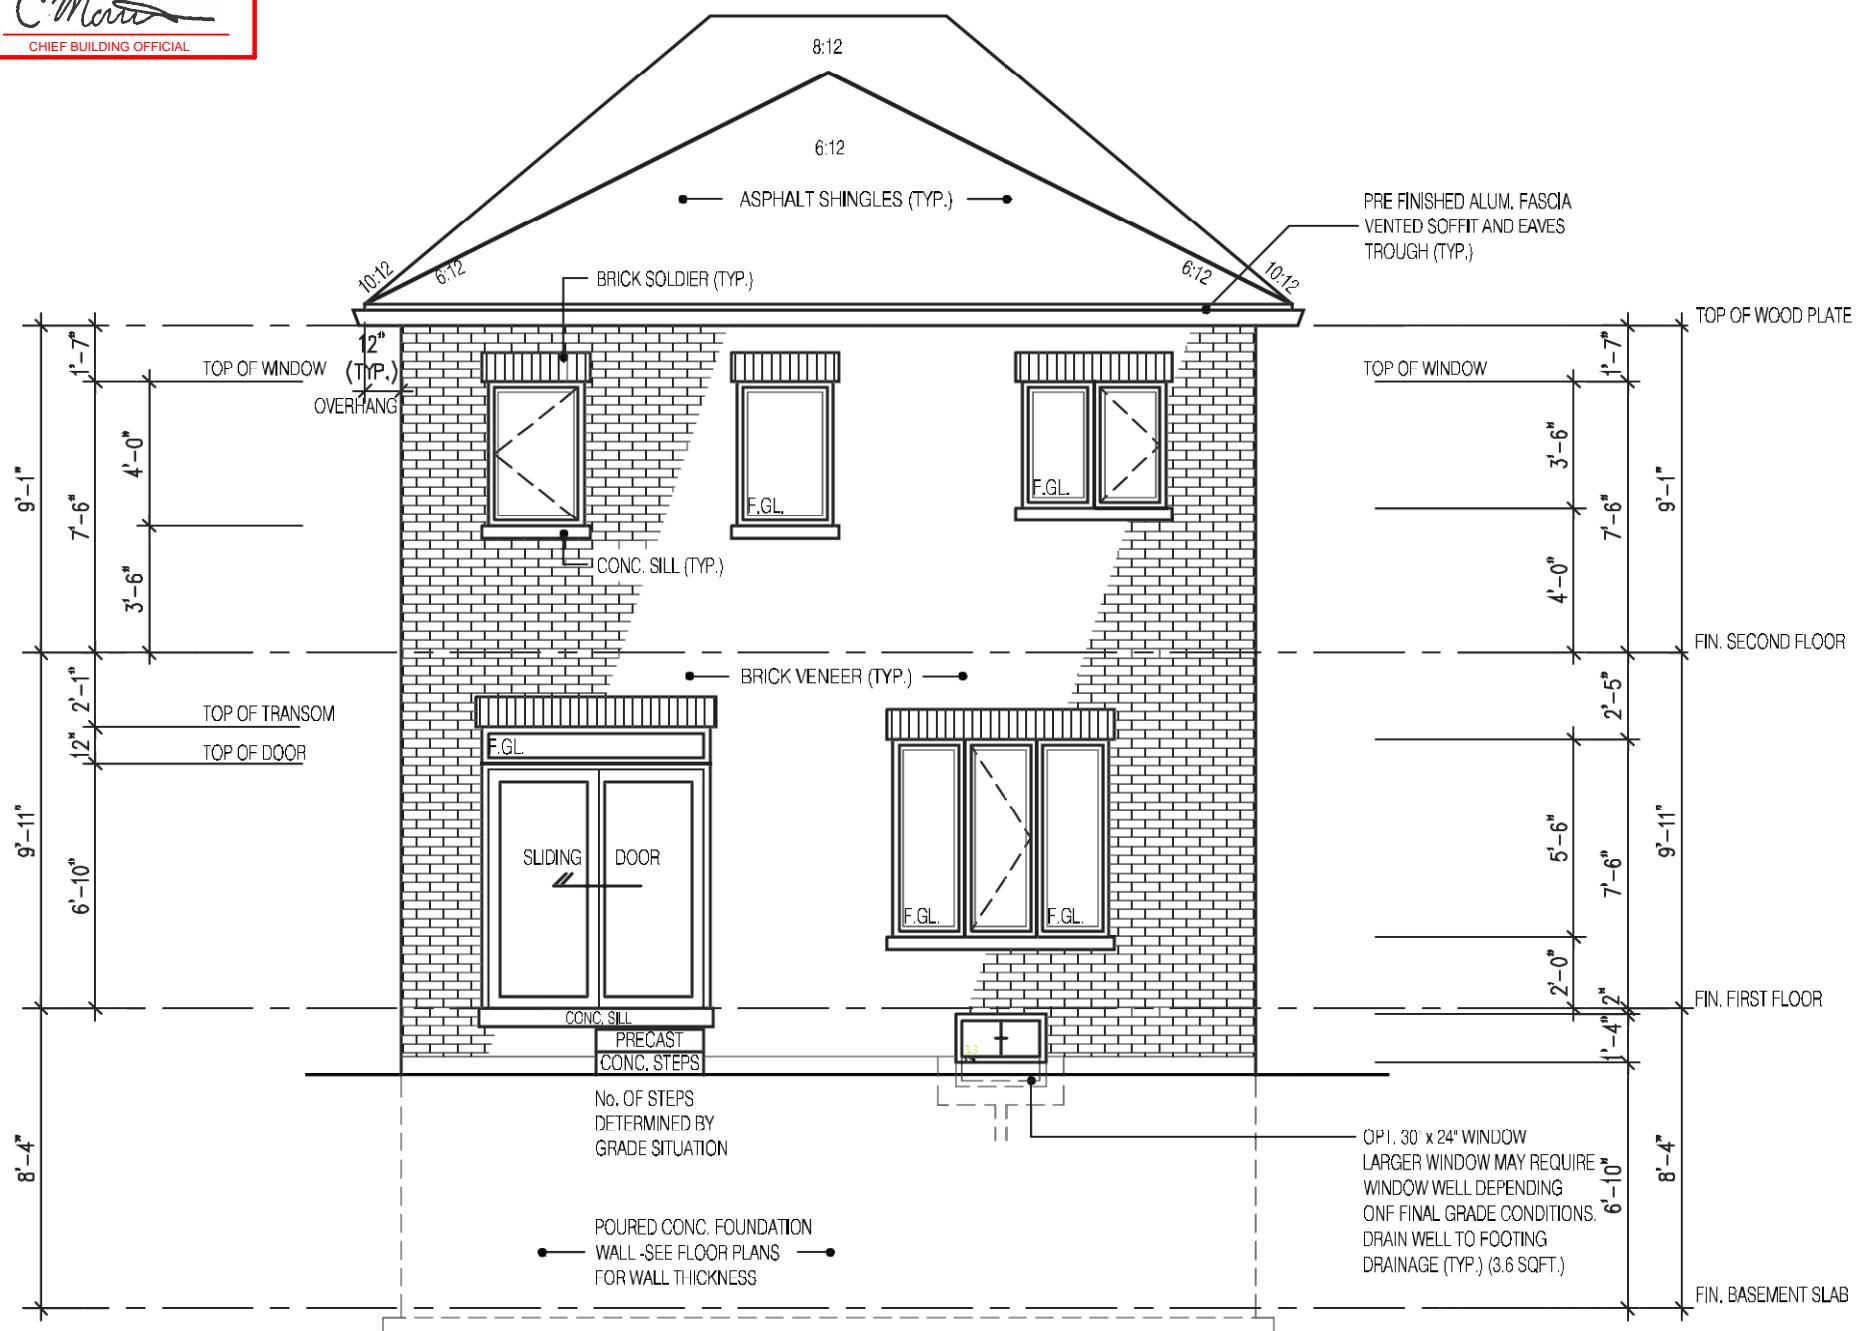



2190

9.14m LOTS

RIVER 1 (GR)  
ELEVATION 2

A1 PACKAGE

O.REG. 332/12

THE CONTRACTOR SHALL CHECK AND VERIFY ALL DIMENSIONS AND CONDITIONS ON SITE BEFORE PROCEEDING WITH CONSTRUCTION. ANY DISCREPANCIES SHALL BE REPORTED TO JARDIN DESIGN GROUP INC. PRIOR TO COMMENCEMENT OF WORK.

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AS CONSTRUCTED INVERTS MUST BE VERIFIED PRIOR TO POURING COATINGS.

JARDIN DESIGN GROUP INC. HAS NOT BEEN RETAINED TO CARRY OUT GENERAL REVIEW OF THE WORK AND ASSUMES NO RESPONSIBILITY FOR THE FAILURE OF THE CONTRACTOR OR SUB CONTRACTOR TO CARRY OUT THE WORK IN ACCORDANCE WITH THE CONTRACT DOCUMENTS.

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2	MAR. 1, 2023 ISSUED TO CLIENT FOR PERMIT
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jardin design group inc. 27763  
FIRM NAME BCIN


REAR ELEVATION 2  
ZADORRA ESTATE INC.  
CITY OF OSHAWA

JOHN G. WILLIAMS LTD., ARCHITECT ARCHITECTURAL CONTROL REVIEW AND APPROVAL	
APPROVED BY: 	
DATE: JUL 31, 2023	
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MODEL: RIVER 1 (GR)
SCALE: 3/16"=1-0"
PROJ. No. 22-16
DWG. No 6A



MHP 23021

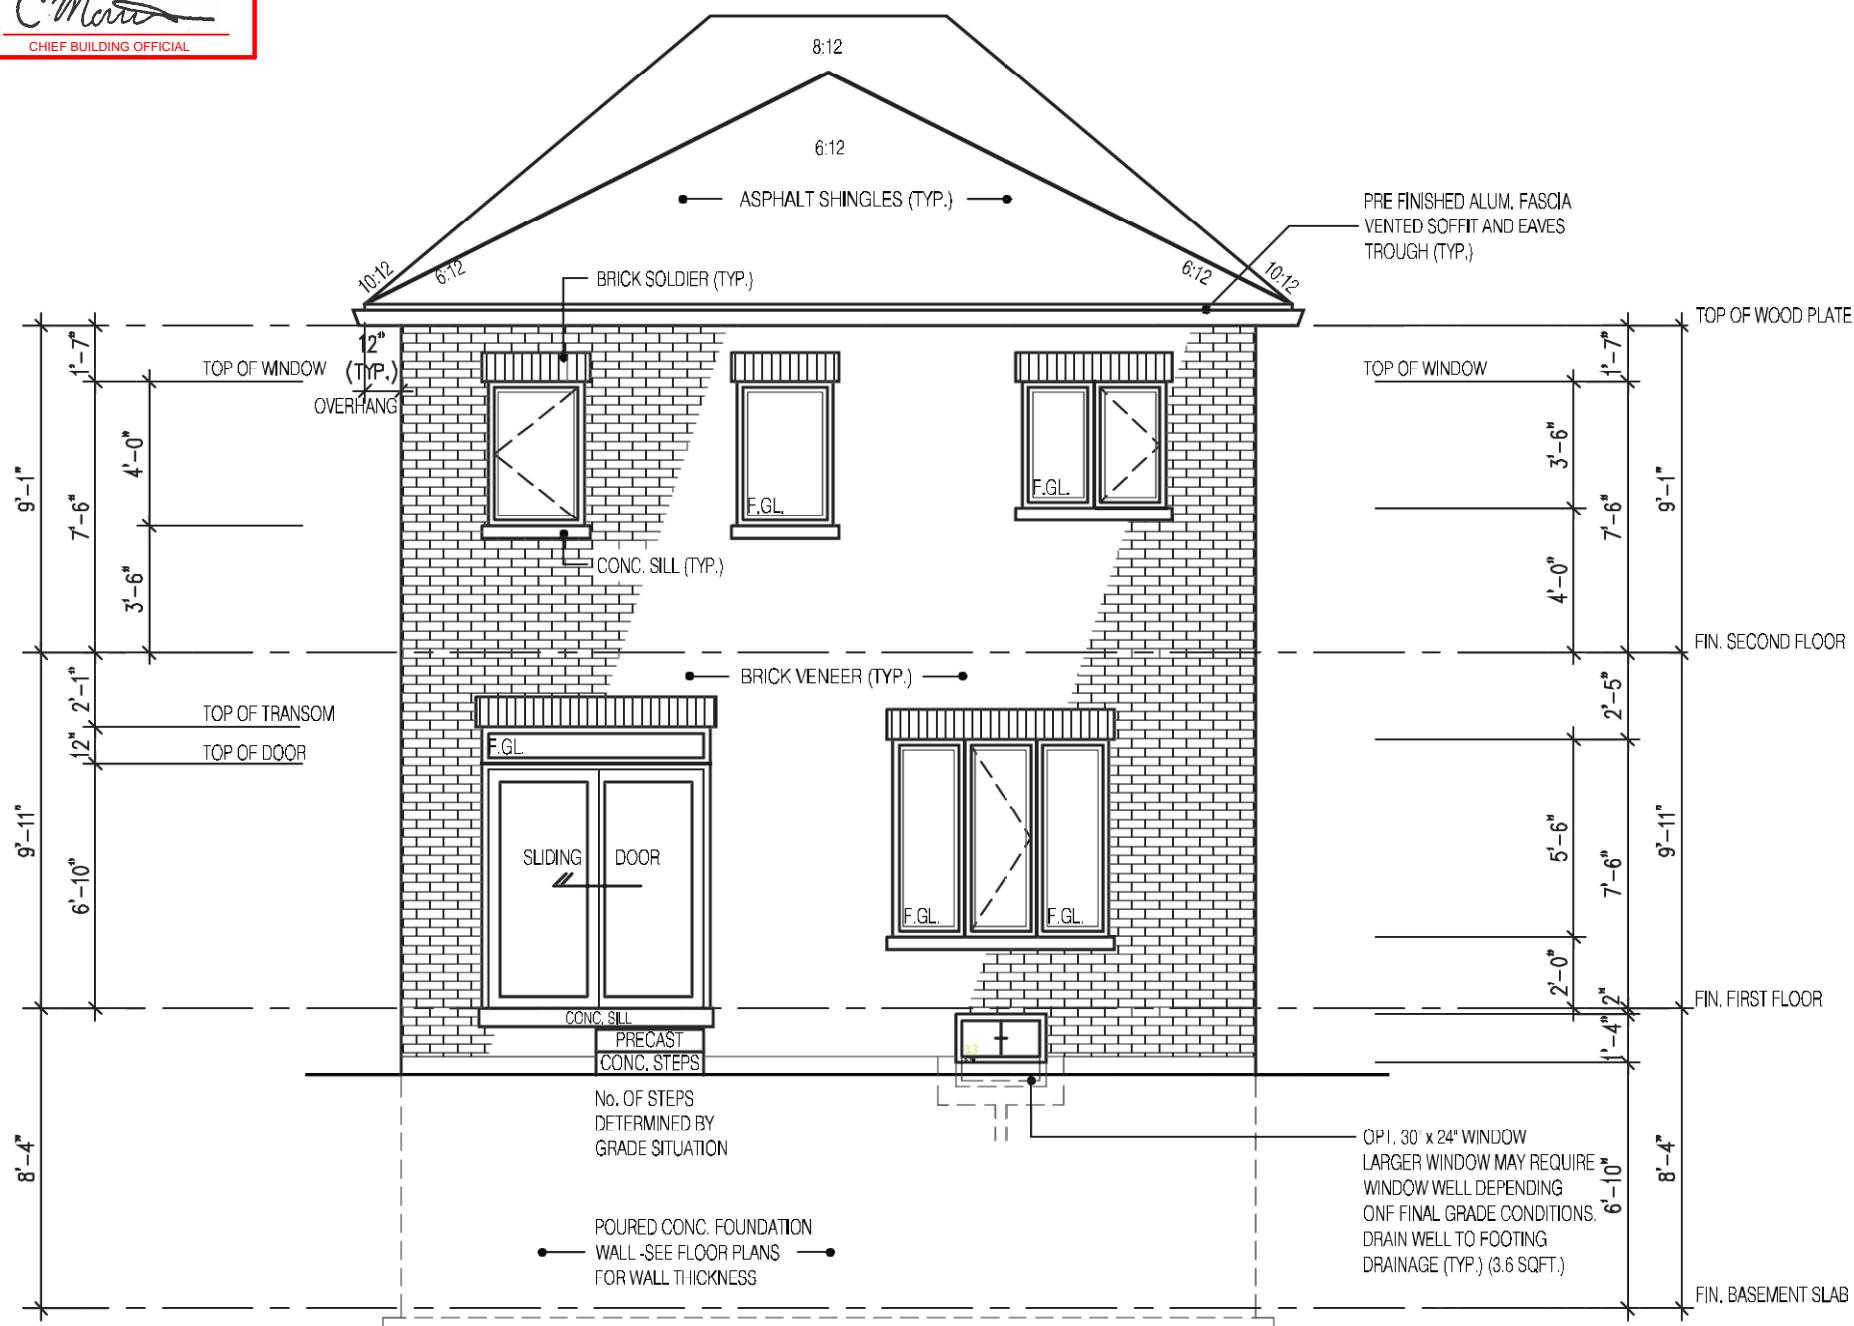

## REAR ELEVATION 2

2190

**9.14m LOTS**


## RIVER 1 (GR) ELEVATION 2

A1 PACKAGE

O.REG. 332/12

CORPORATION OF THE CITY OF OSHAWA  
TRUE COPY  
OF PERMIT PLANS  
Nov 04 2023  
  
C. Morris  
ER:  
CHIEF BUILDING OFFICIAL

MHP 23021

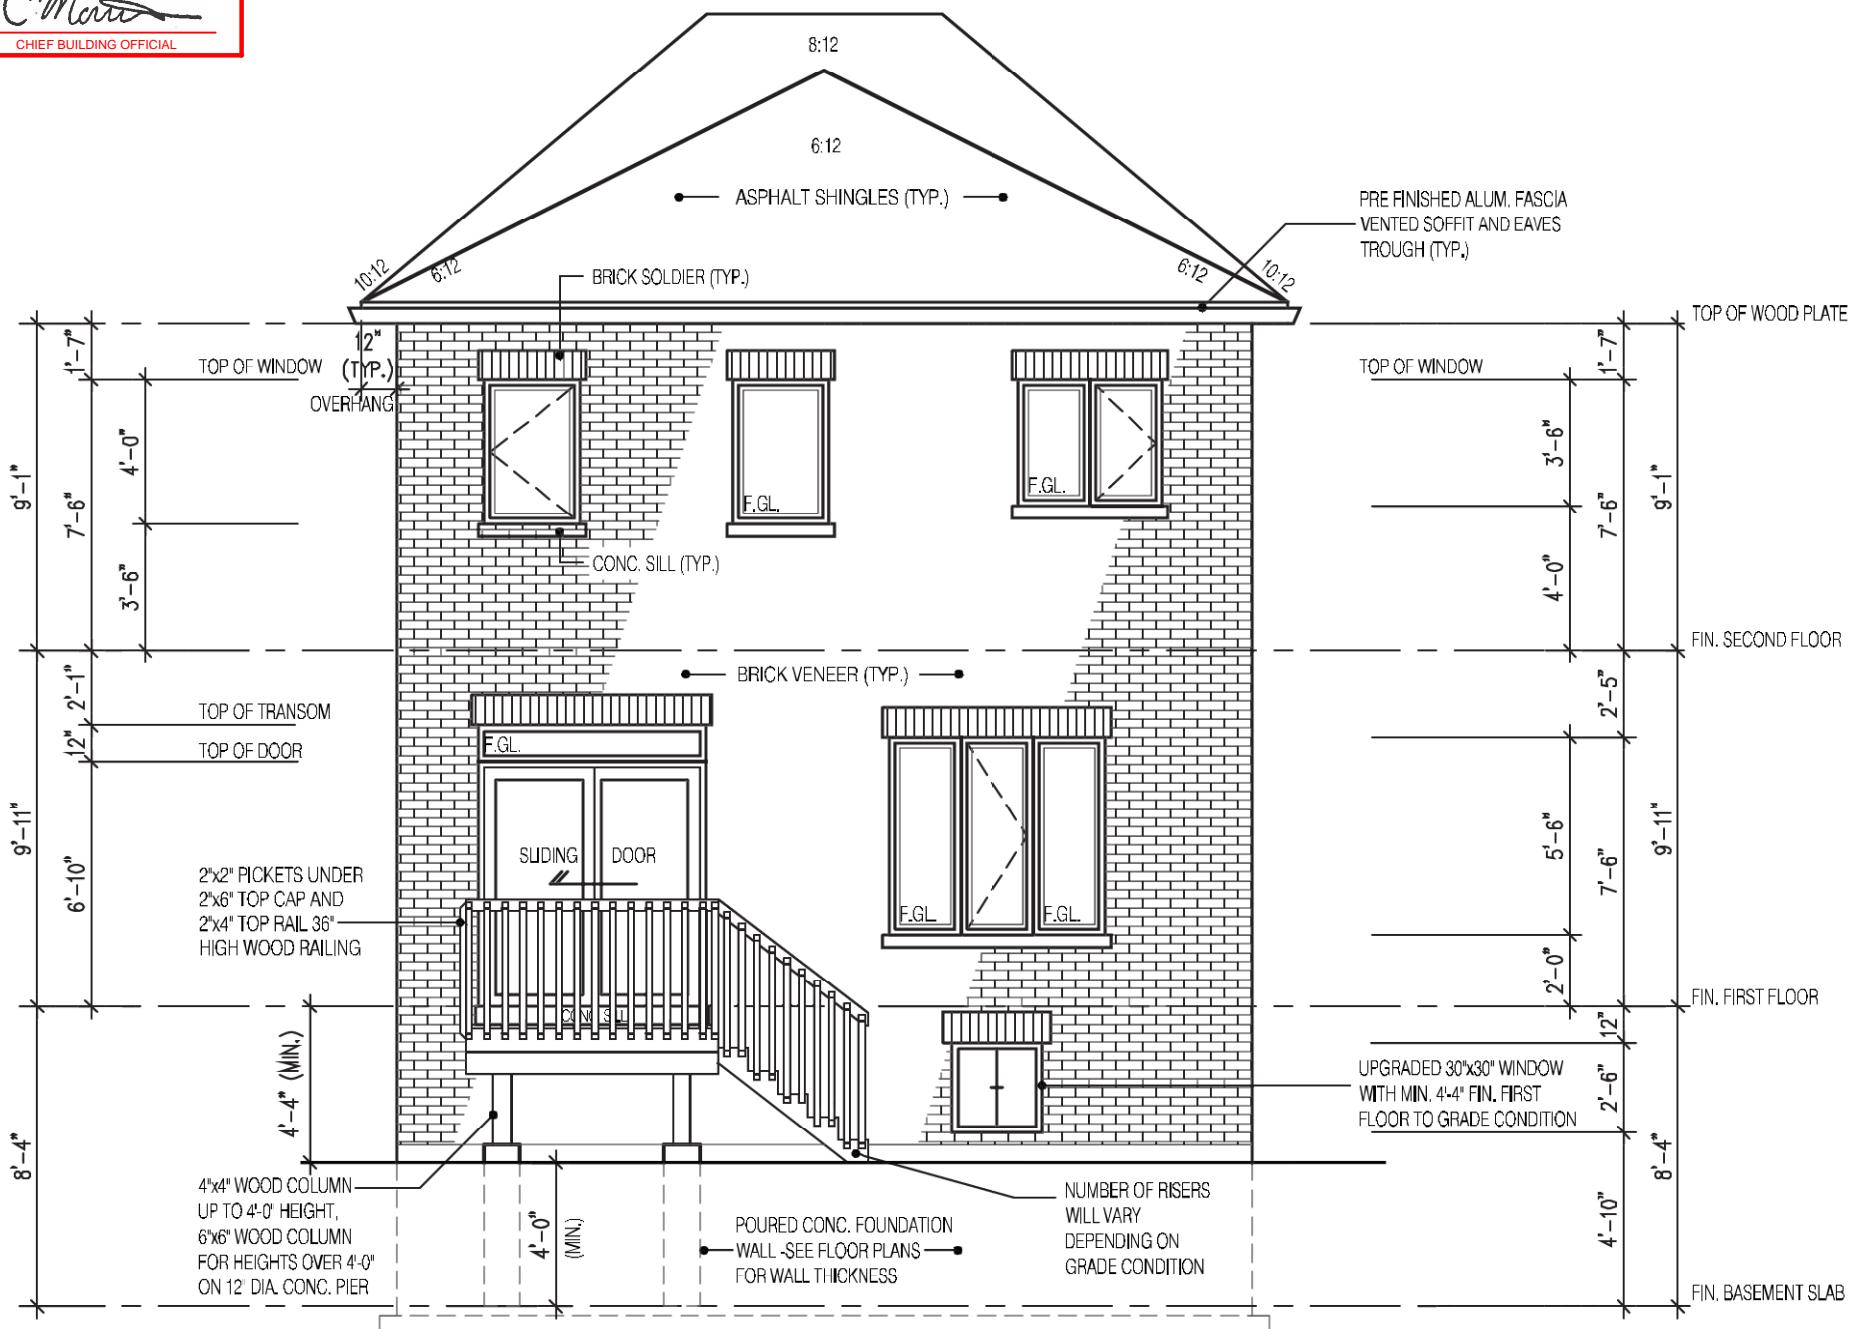

## **REAR ELEVATION 2 DECK CONDITION**

FOR ADDITIONAL DECK STRUCTURE  
REFER TO PAGE 7 OF THE DETAIL PACKAGE

**NOTE:**

**WHEN VENEER CUT IS GREATER THAN  
26" A 10" POURED CONC. FOUNDATION  
WALL IS REQUIRED.  
(FOUNDATION PLAN TO BE REVIEWED  
IN CONJUNCTION WITH SITE PLAN)**

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This is to certify that these plans comply  
with the applicable Architectural Design  
guidelines approved by the City of  
Shawnee.

<b>JOHN G. WILLIAMS LTD., ARCHITECT</b>	
<b>ARCHITECTURAL CONTROL REVIEW</b>	
<b>AND APPROVAL</b>	
APPROVED BY: <u></u>	
DATE: <u>JUL 31, 2023</u>	
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TRACTOR SHALL CHECK AND VERIFY ALL DIMENSIONS AND  
LINES ON SITE BEFORE PROCEEDING WITH CONSTRUCTION.  
DISCREPANCIES SHALL BE REPORTED TO JARDIN DESIGN GROUP  
BEFORE COMMENCEMENT OF WORK.

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OF STRUCTURAL OR ENGINEERING INFORMATION SHOWN ON  
DRAWINGS OR FOR CONSTRUCTION STARTED PRIOR TO THE  
ISSUANCE OF A BUILDING PERMIT. REFER TO THE APPROPRIATE  
STRUCTURAL DRAWINGS BEFORE PROCEEDING WITH WORK.  
STRUCTURED INVERTS MUST BE VERIFIED PRIOR TO POURING  
CONCRETE.

DESIGN GROUP INC. HAS NOT BEEN RETAINED TO CARRY OUT  
REVIEW OF THE WORK AND ASSUMES NO RESPONSIBILITY  
FAILURE OF THE CONTRACTOR OR SUB CONTRACTOR TO  
PUT THE WORK IN ACCORDANCE WITH THE CONTRACT  
NIS.

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AY 4, 2023	COORDINATED FLOOR, ROOF AND ENGINEER COMMENTS
AR. 1, 2023	ISSUED TO CLIENT FOR PERMIT
EB. 14, 2023	INTRODUCED FROM JOB 21-35 MODEL GARDEN 1, 4 BED LAYOUT

**jardin**  
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VAUGHAN ONT. L4K 3P3  
905 660-3377 FAX: 905 660-3713  
EMAIL: [info@jardindesign.ca](mailto:info@jardindesign.ca)

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er Botter  21031

SIGNATURE BCIN  
REGISTRATION INFORMATION  
ed unless design is exempt under Division C, Subsection  
3.2.4 of the building code

*In design group inc.* 27763  
NAME BCIN

## CK CONDITION EL-2

ZADORRA ESTATE INC.

CITY OF OSHAWA

MODEL:  
RIVER 1 (GR)  
SCALE:

**SCALE:** 3/16"=1'-0"

**BILD®** PROJ. No. DWG. No.  
22-16 6A-1

EE 1010 0A-1

2190

9.14m LOTS

RIVER 1 (GR)  
ELEVATION 3

A1 PACKAGE

O.REG. 332/12

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VAUGHAN ONT. L4K 3P3  
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EMAIL: info@jardindesign.ca

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Walter Botter   
NAME SIGNATURE BCIN

REGISTRATION INFORMATION  
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jardin design group inc. 27763  
FIRM NAME BCIN

REAR ELEVATION 3

ZADORRA ESTATE INC.  
CITY OF OSHAWA

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JOHN G. WILLIAMS LTD., ARCHITECT  
ARCHITECTURAL CONTROL REVIEW  
AND APPROVAL


APPROVED BY:   
DATE: JUL 31, 2023

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MODEL: RIVER 1 (GR)
SCALE: 3/16"=1'-0"
PROJ. No. 22-16
DWG. No 6B



MHP 23021

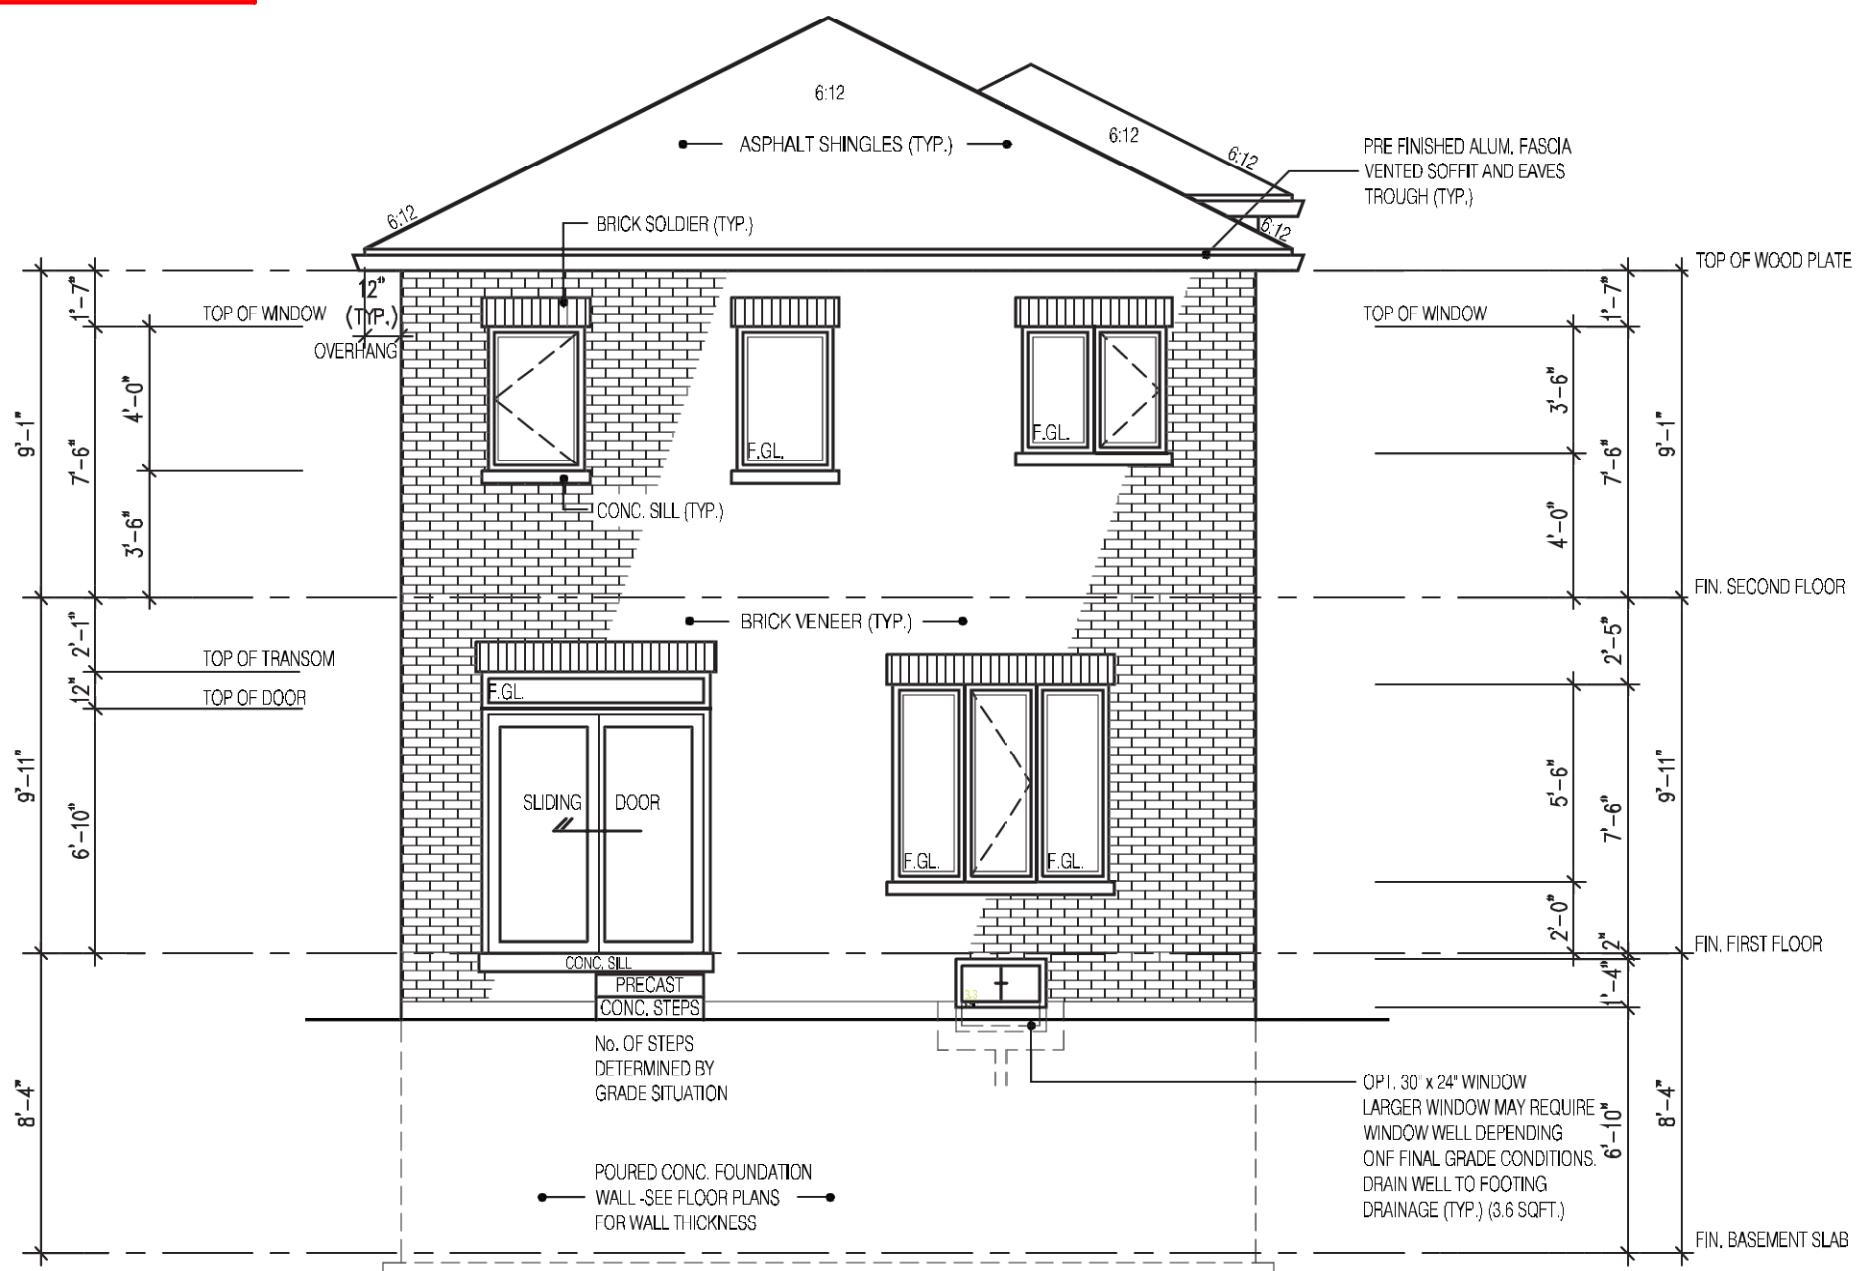

2190

9.14m LOTS


RIVER 1 (GR)  
ELEVATION 3

A1 PACKAGE

O.REG. 332/12



MHP 23021

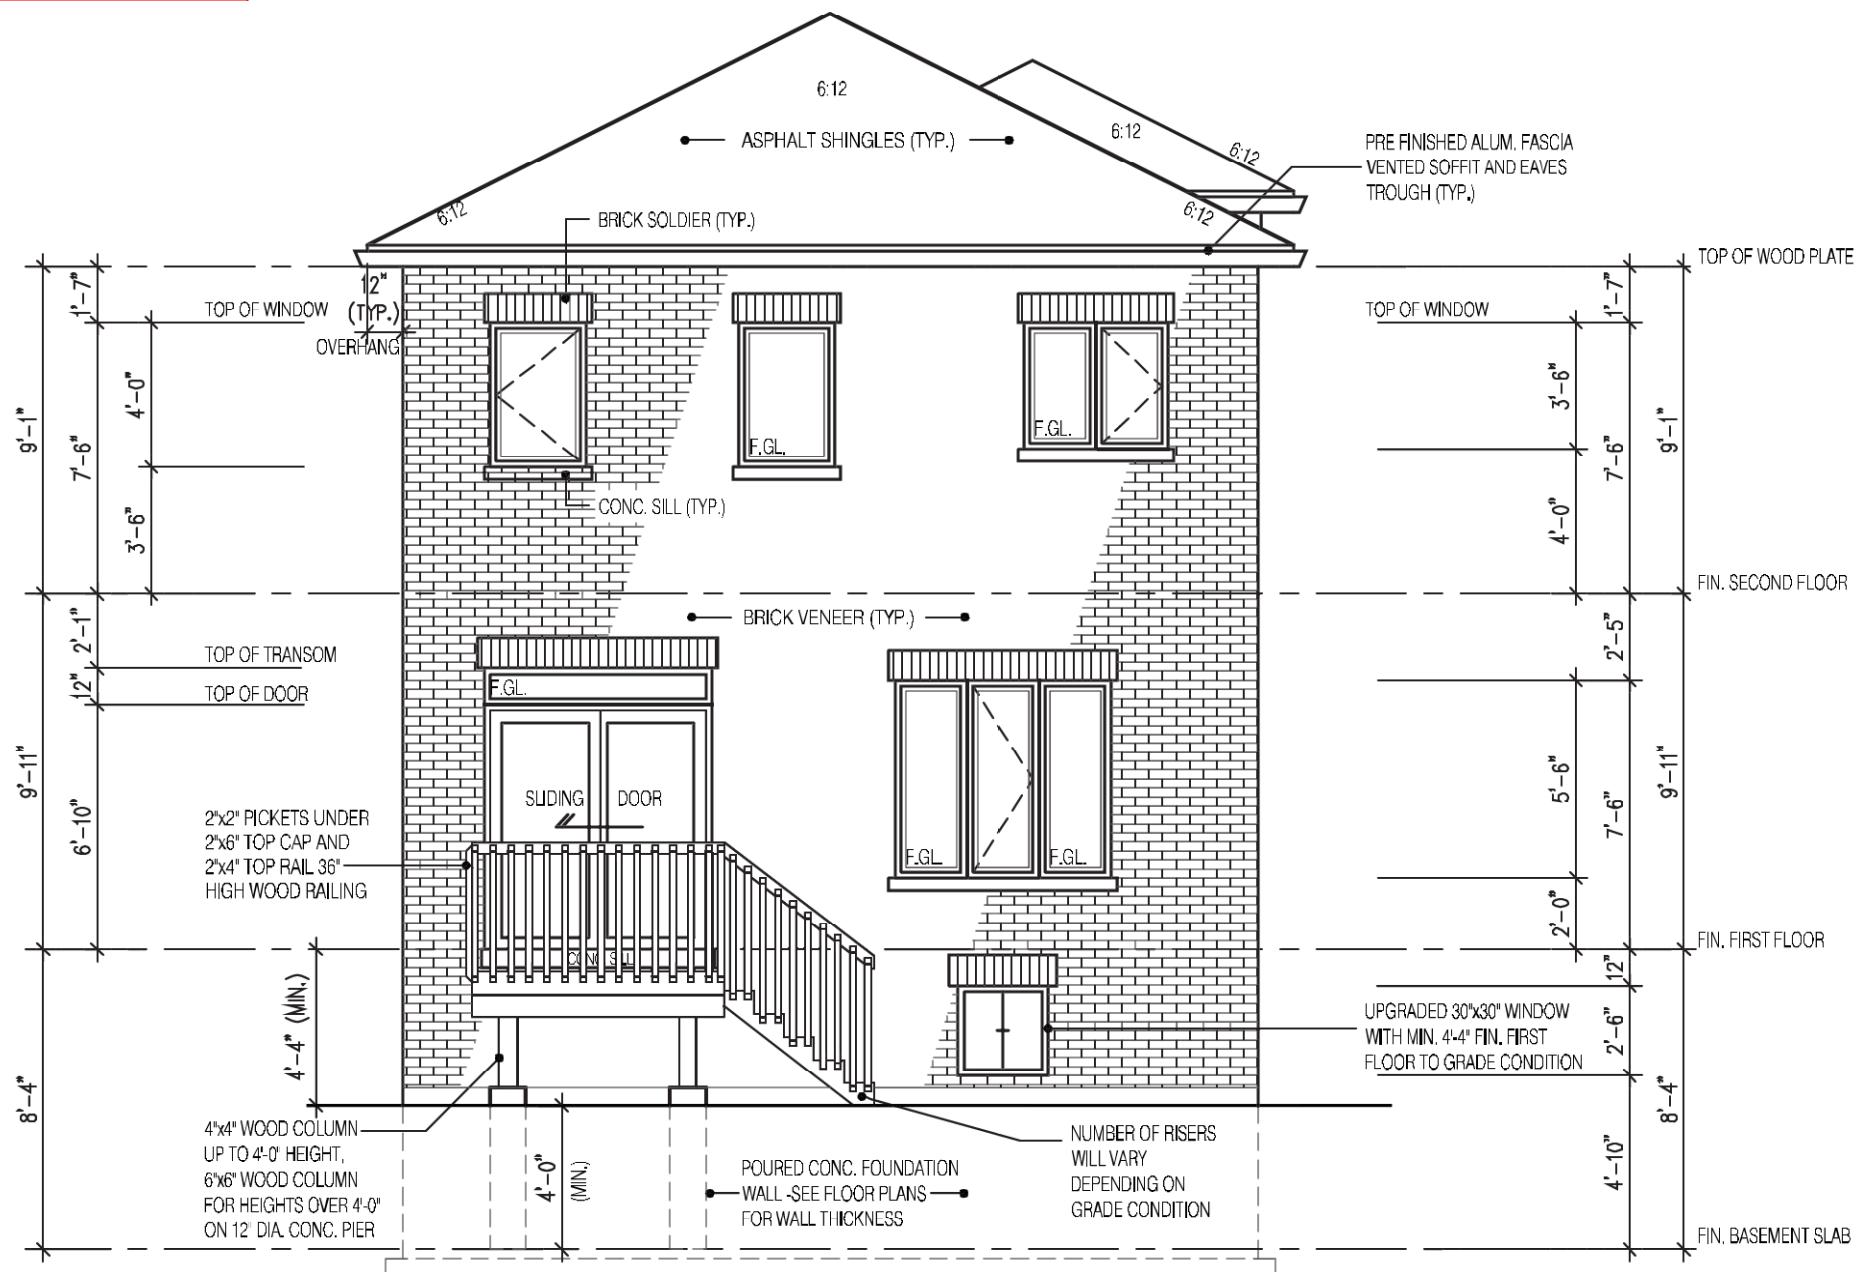

## REAR ELEVATION 3 DECK CONDITION

FOR ADDITIONAL DECK STRUCTURE  
REFER TO PAGE 7 OF THE DETAIL PACKAGE

### NOTE:

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26" A 10" POURED CONC. FOUNDATION  
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JOHN G. WILLIAMS LTD., ARCHITECT  
ARCHITECTURAL CONTROL REVIEW  
AND APPROVAL  
APPROVED BY: *[Signature]*  
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2	MAR. 1, 2023 ISSUED TO CLIENT FOR PERMIT
1	FEB. 14, 2023 INTRODUCED FROM JOB 21-35 MODEL GARDEN 1, 4 BED LAYOUT

No: DATE: WORK DESCRIPTION:

**jardin**  
DESIGN GROUP INC  
64 JARDIN DR. SUITE 3A  
VAUGHAN ONT. L4K 3P3  
TEL: 905 660-3377 FAX: 905 660-3713  
EMAIL: info@jardindesign.ca

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Walter Botter *[Signature]* 21031  
NAME SIGNATURE BCIN

REGISTRATION INFORMATION  
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jardin design group inc. 27763  
FIRM NAME BCIN

DECK CONDITION EL-3

ZADORRA ESTATE INC.  
CITY OF OSHAWA

MODEL: RIVER 1 (GR)
SCALE: 3/16"=1'-0"
PROJ. No. 22-16
DWG. No. 6B-1



2190

## **9.14m LOTS**

# RIVER 1 (GR) ELEVATION 2

# A1 PACKAGE

O.REG. 332/12

CORPORATION OF THE CITY OF OSHAWA  
TRUE COPY  
OF PERMIT PLANS  
Nov 04 2023  
  
ER: C. Morris  
CHIEF BUILDING OFFICIAL

MHP 23021

## **RIGHT SIDE ELEVATION 2**

## **HEADER/RIM JOIST LEVEL**

(FOR WALLS LESS THAN 1.2m (3'-11") FROM LOT LINE)

## 45 MINUTE FIRE RATED AT HEADER

PROVIDE 15.9mm (5/8") TYPE "X" GYPSUM BOARD BETWEEN FLOOR JOIST AT THE HEADER OR CONTINUOUSLY ALONG THE RIM JOIST WHEN FLOOR JOISTS ARE PARALLEL TO RIM JOIST TO MAINTAIN 45 MINUTE FIRE RATING.

(REFER TO SUPPLEMENTARY STANDARD SB-2 2.3.

## **BRICK VENEER CONSTRUCTION**

(FOR WALLS LESS THAN 1.2m (3'-11") FROM LOT LINE)

## **45 MINUTE FIRE RATED WALL**

PROVIDE A CONTINUOUS LAYER OF 12.7mm (1/2") TYPE 'X' GYPSUM BOARD (INTERIOR SIDE) INSTALLED SO THAT ALL EDGES ARE SUPPORTED, TAPE AND FILLED, SPACE BETWEEN WOOD STUDS TO BE FILLED WITH PREFORMED MINERAL FIBRE INSULATION WITH A MASS OF NOT LESS THAN 1.22 Kg/SQM. AND MUST FILL AT LEAST 90% OF THE CAVITY THICKNESS. THE TYPE 'X' & INSULATION MUST BE RUN CONTINUOUSLY BEHIND ALL INTERSECTING PARTITIONS, MECHANICAL CHASES, BATHTUBS, SHOWERS, ETC. ENSURE INSULATION & TYPE 'X' IS INSTALLED IN GARAGE EXTERIOR WALLS.

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**JOHN G. WILLIAMS LTD., ARCHITECT**  
**ARCHITECTURAL CONTROL REVIEW**  
**AND APPROVAL**

APPROVED BY: 

DATE: JULY 31, 2023

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**CITY OF OSHAWA**

	MODEL:
	RIVER 1 (GR)
SCALE:	3/16" = 1'-0"
	PROJ. No.
22-16	
DWG. No. 7A	

2190

9.14m LOTS


RIVER 1 (GR)  
ELEVATION 3

A1 PACKAGE

O.REG. 332/12



MHP 23021

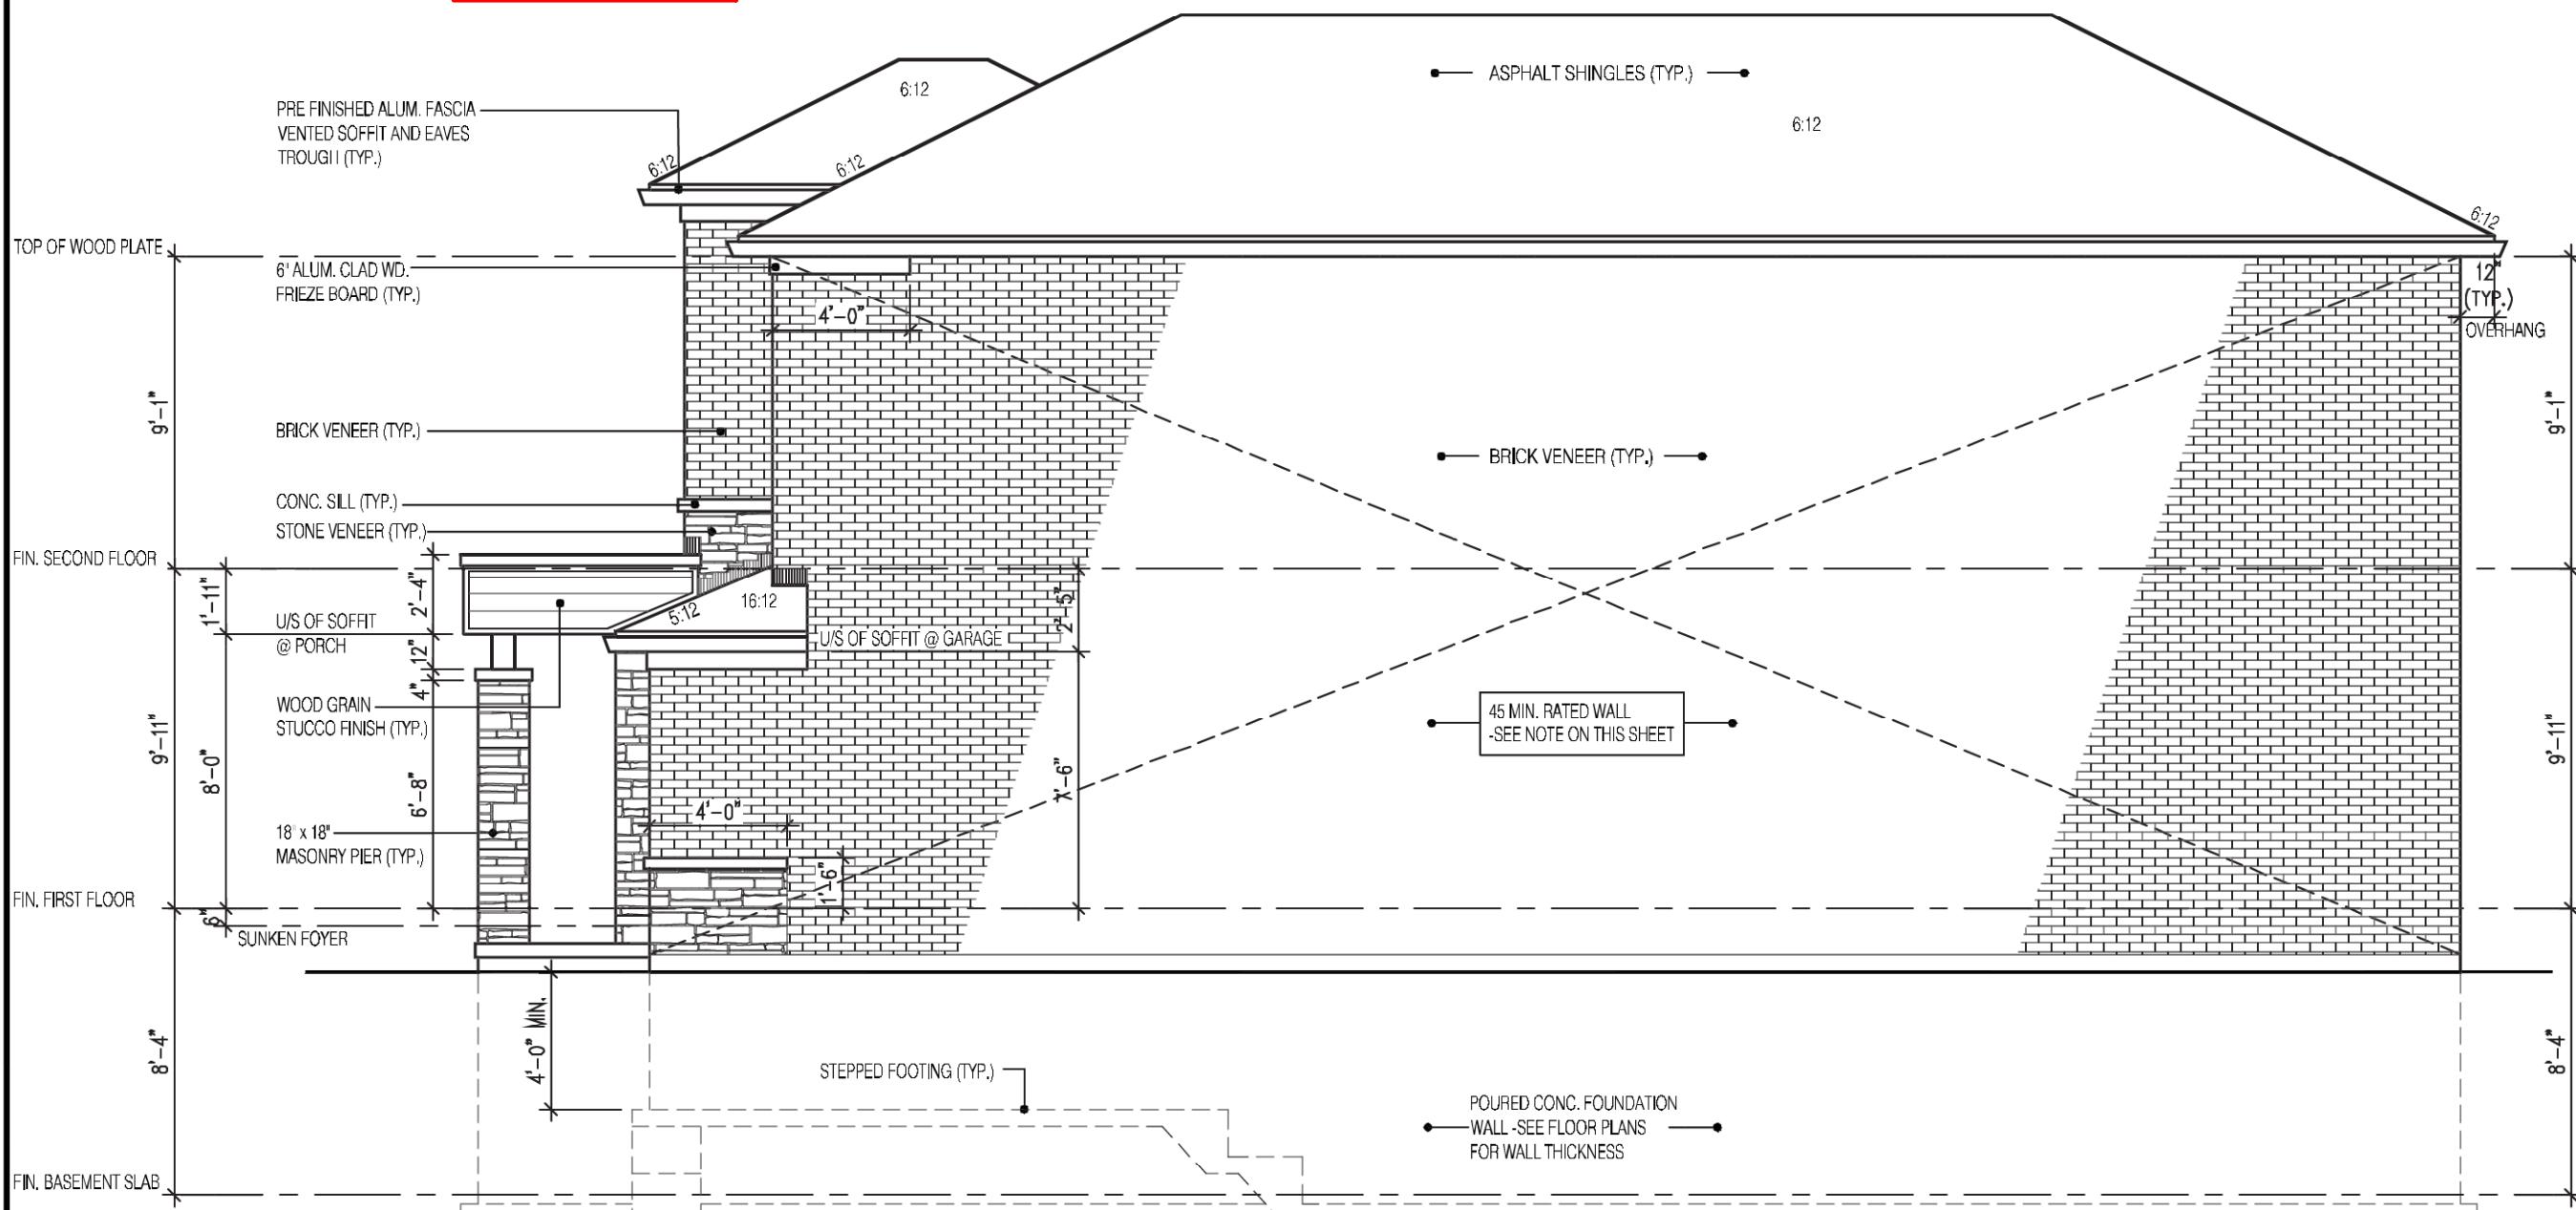

## RIGHT SIDE ELEVATION 3

**HEADER/RIM JOIST LEVEL**

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MODEL: RIVER 1 (GR)
SCALE: 3/16"=1'-0"
PROJ. No. 22-16

DWG. No  
7B

**jardin**  
DESIGN GROUP INC

64 JARDIN DR. SUITE 3A  
VAUGHAN ONT. L4K 3P3  
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EMAIL: info@jardindesign.ca

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**Walter Botter** *[Signature]* 21031  
NAME SIGNATURE BCIN

REGISTRATION INFORMATION  
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**jardin design group inc.** 27763  
FIRM NAME BCIN

**SIDE ELEVATION 3**

ZADORRA ESTATE INC.  
CITY OF OSHAWA

<b>BILD®</b>
MODEL: RIVER 1 (GR)
SCALE: 3/16"=1'-0"

2190

9.14m LOTS



RIVER 1 (GR)  
ELEVATION 1

A1 PACKAGE

O.REG. 332/12



MHP 23021

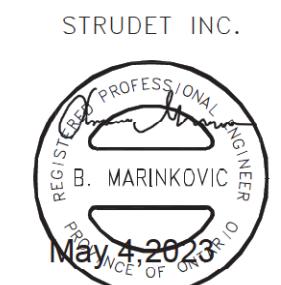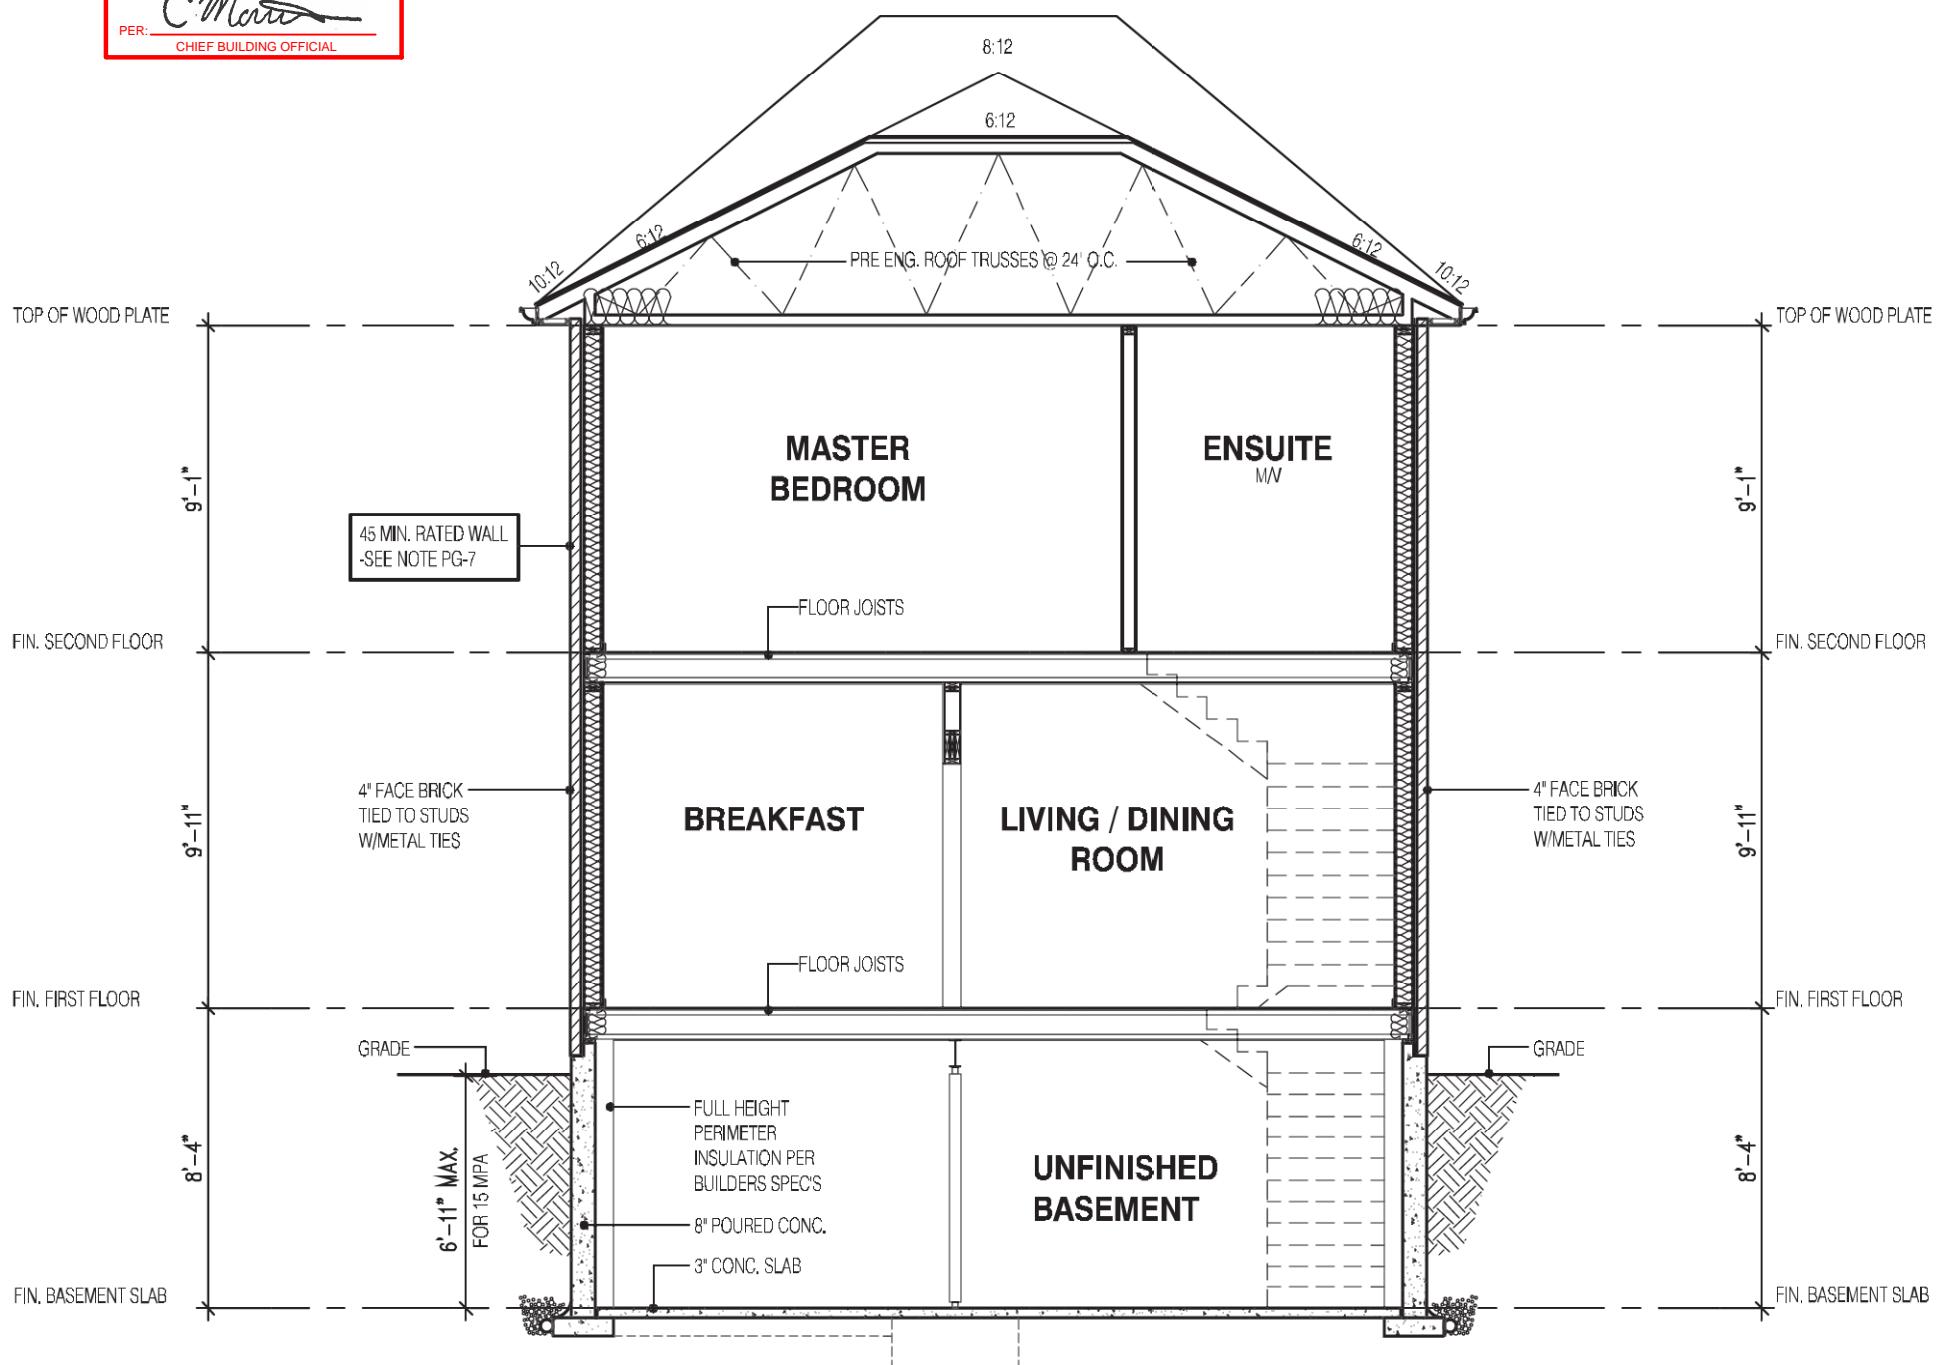

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Walter Botter *WB* 21031  
NAME SIGNATURE BCIN

REGISTRATION INFORMATION  
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jardin design group inc. 27763  
FIRM NAME BCIN

SECTION ELEVATION 1  
ZADORRA ESTATE INC.  
CITY OF OSHAWA

MODEL: RIVER 1 (GR)
SCALE: 3/16"=1'-0"
PROJ. No. 22-16
DWG. No. 8

2190

9.14m LOTS


RIVER 1 (GR)  
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A1 PACKAGE

O.REG. 332/12



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3	MAY 4, 2023 COORDINATED FLOOR, ROOF AND ENGINEER COMMENTS
2	MAR. 1, 2023 ISSUED TO CLIENT FOR PERMIT
1	FEB. 14, 2023 INTRODUCED FROM JOB 21-35 MODEL GARDEN 1, 4 BED LAYOUT

No: DATE: WORK DESCRIPTION:

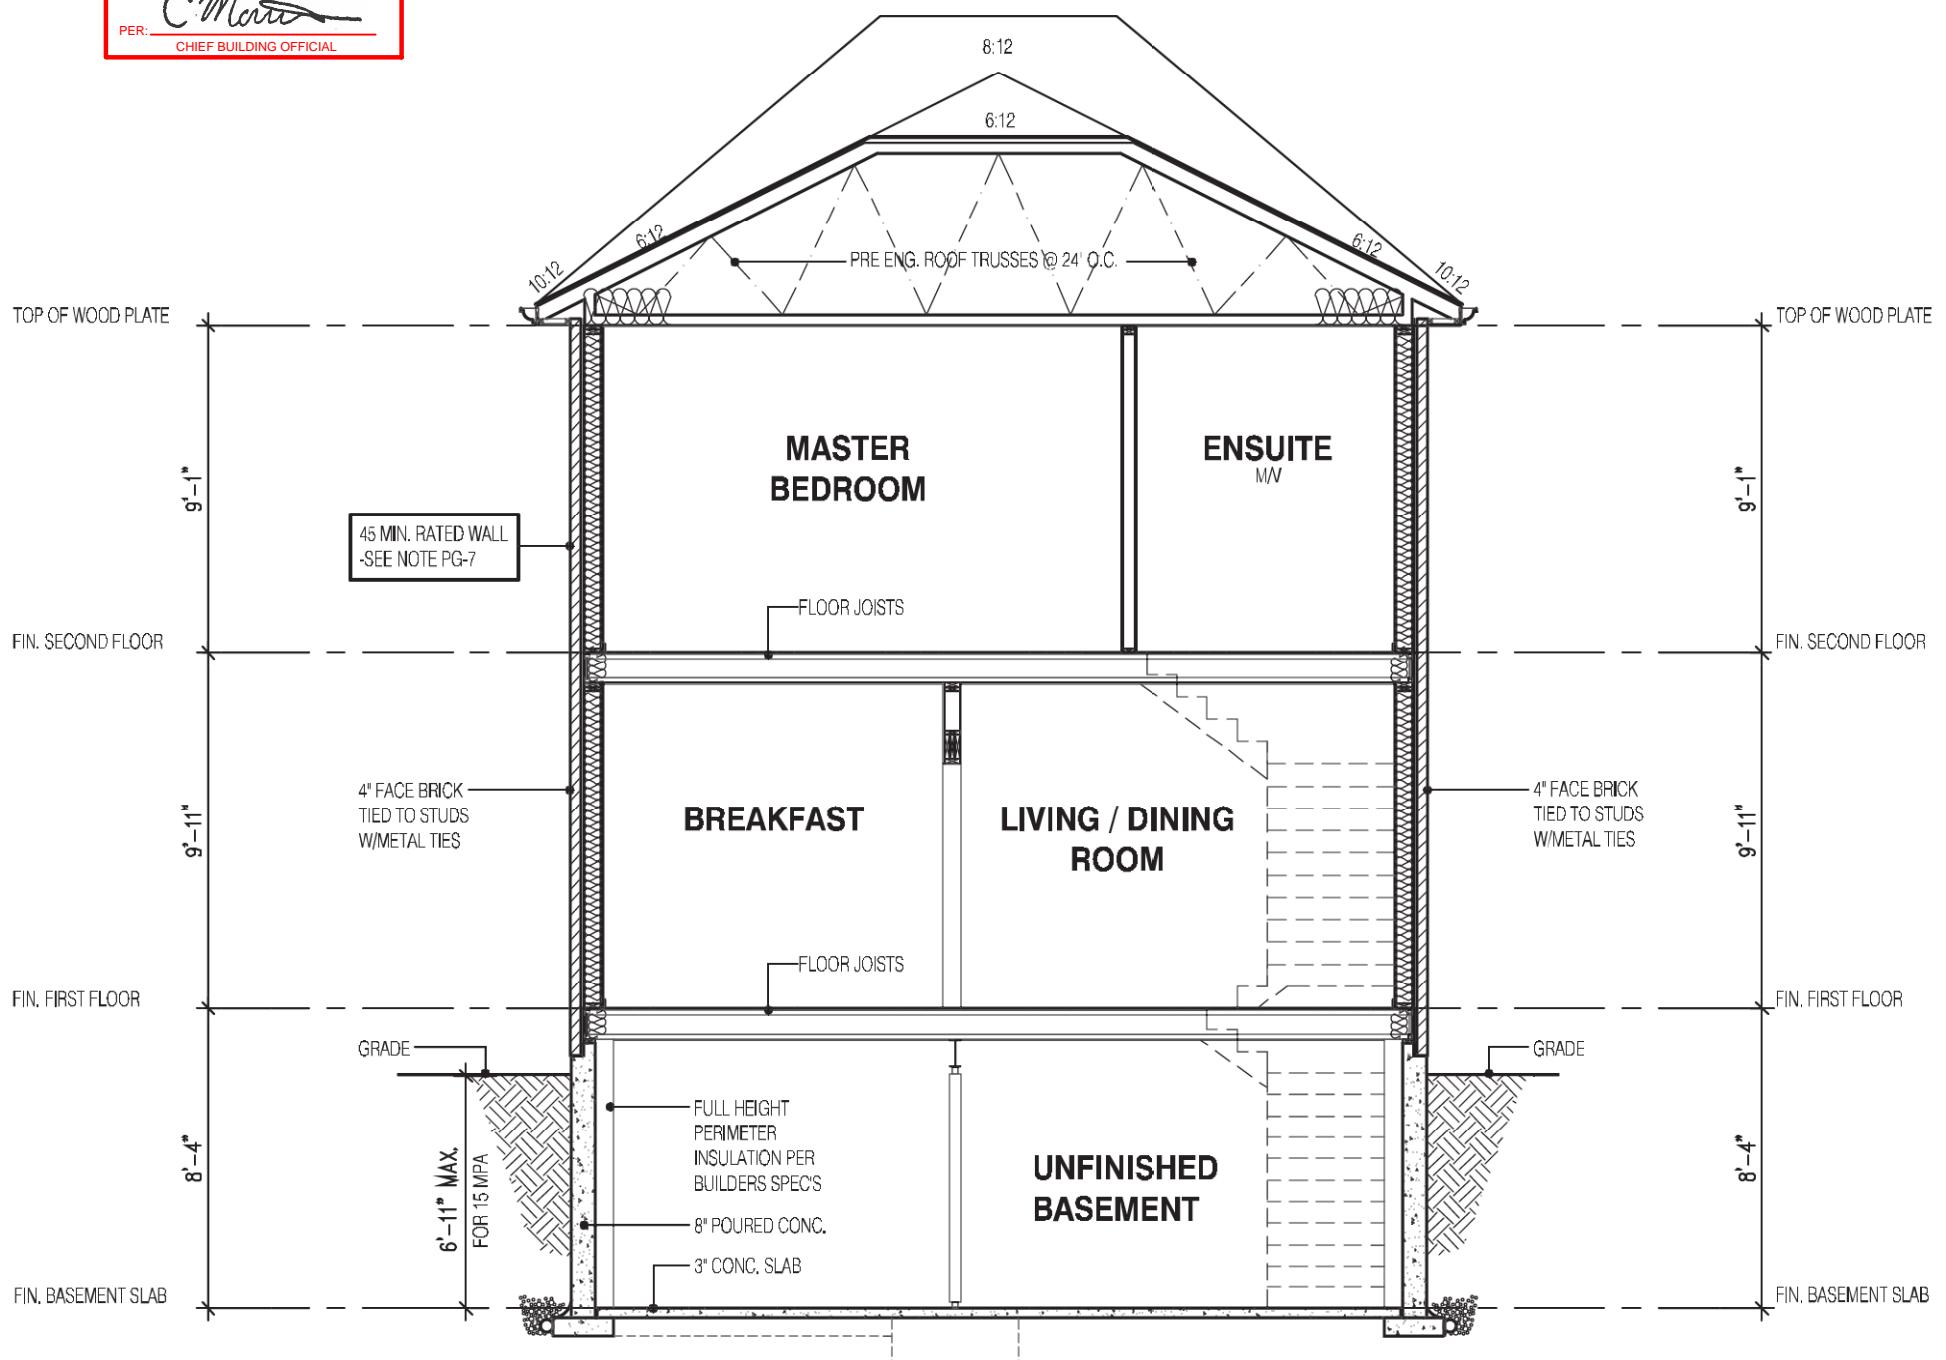jardin  
DESIGN GROUP INC  
64 JARDIN DR. SUITE 3A  
VAUGHAN ONT. L4K 3P3  
TEL: 905 660-3377 FAX: 905 660-3713  
EMAIL: info@jardindesign.ca

The undersigned has reviewed and takes responsibility for this design and has the qualifications and meets the requirements set out in the Ontario Building Code to be a designer

QUALIFICATION INFORMATION  
Required unless design is exempt under Division C, Subsection 3.2.5 of the building code

Walter Botter  
*WB* 21031  
NAME SIGNATURE BCIN

REGISTRATION INFORMATION  
Required unless design is exempt under Division C, Subsection 3.2.4 of the building code

jardin design group inc. 27763  
FIRM NAME BCIN

SECTION ELEVATION 2

ZADORRA ESTATE INC.  
CITY OF OSHAWA

MODEL: RIVER 1 (GR)
SCALE: 3/16"=1'-0"
PROJ. No. 22-16
DWG. No. 8A

2190

9.14m LOTS



RIVER 1 (GR)  
ELEVATION 3

A1 PACKAGE

O.REG. 332/12



MHP 23021

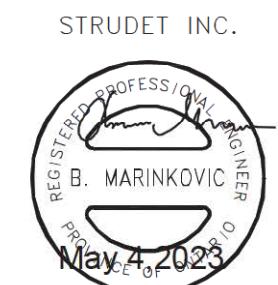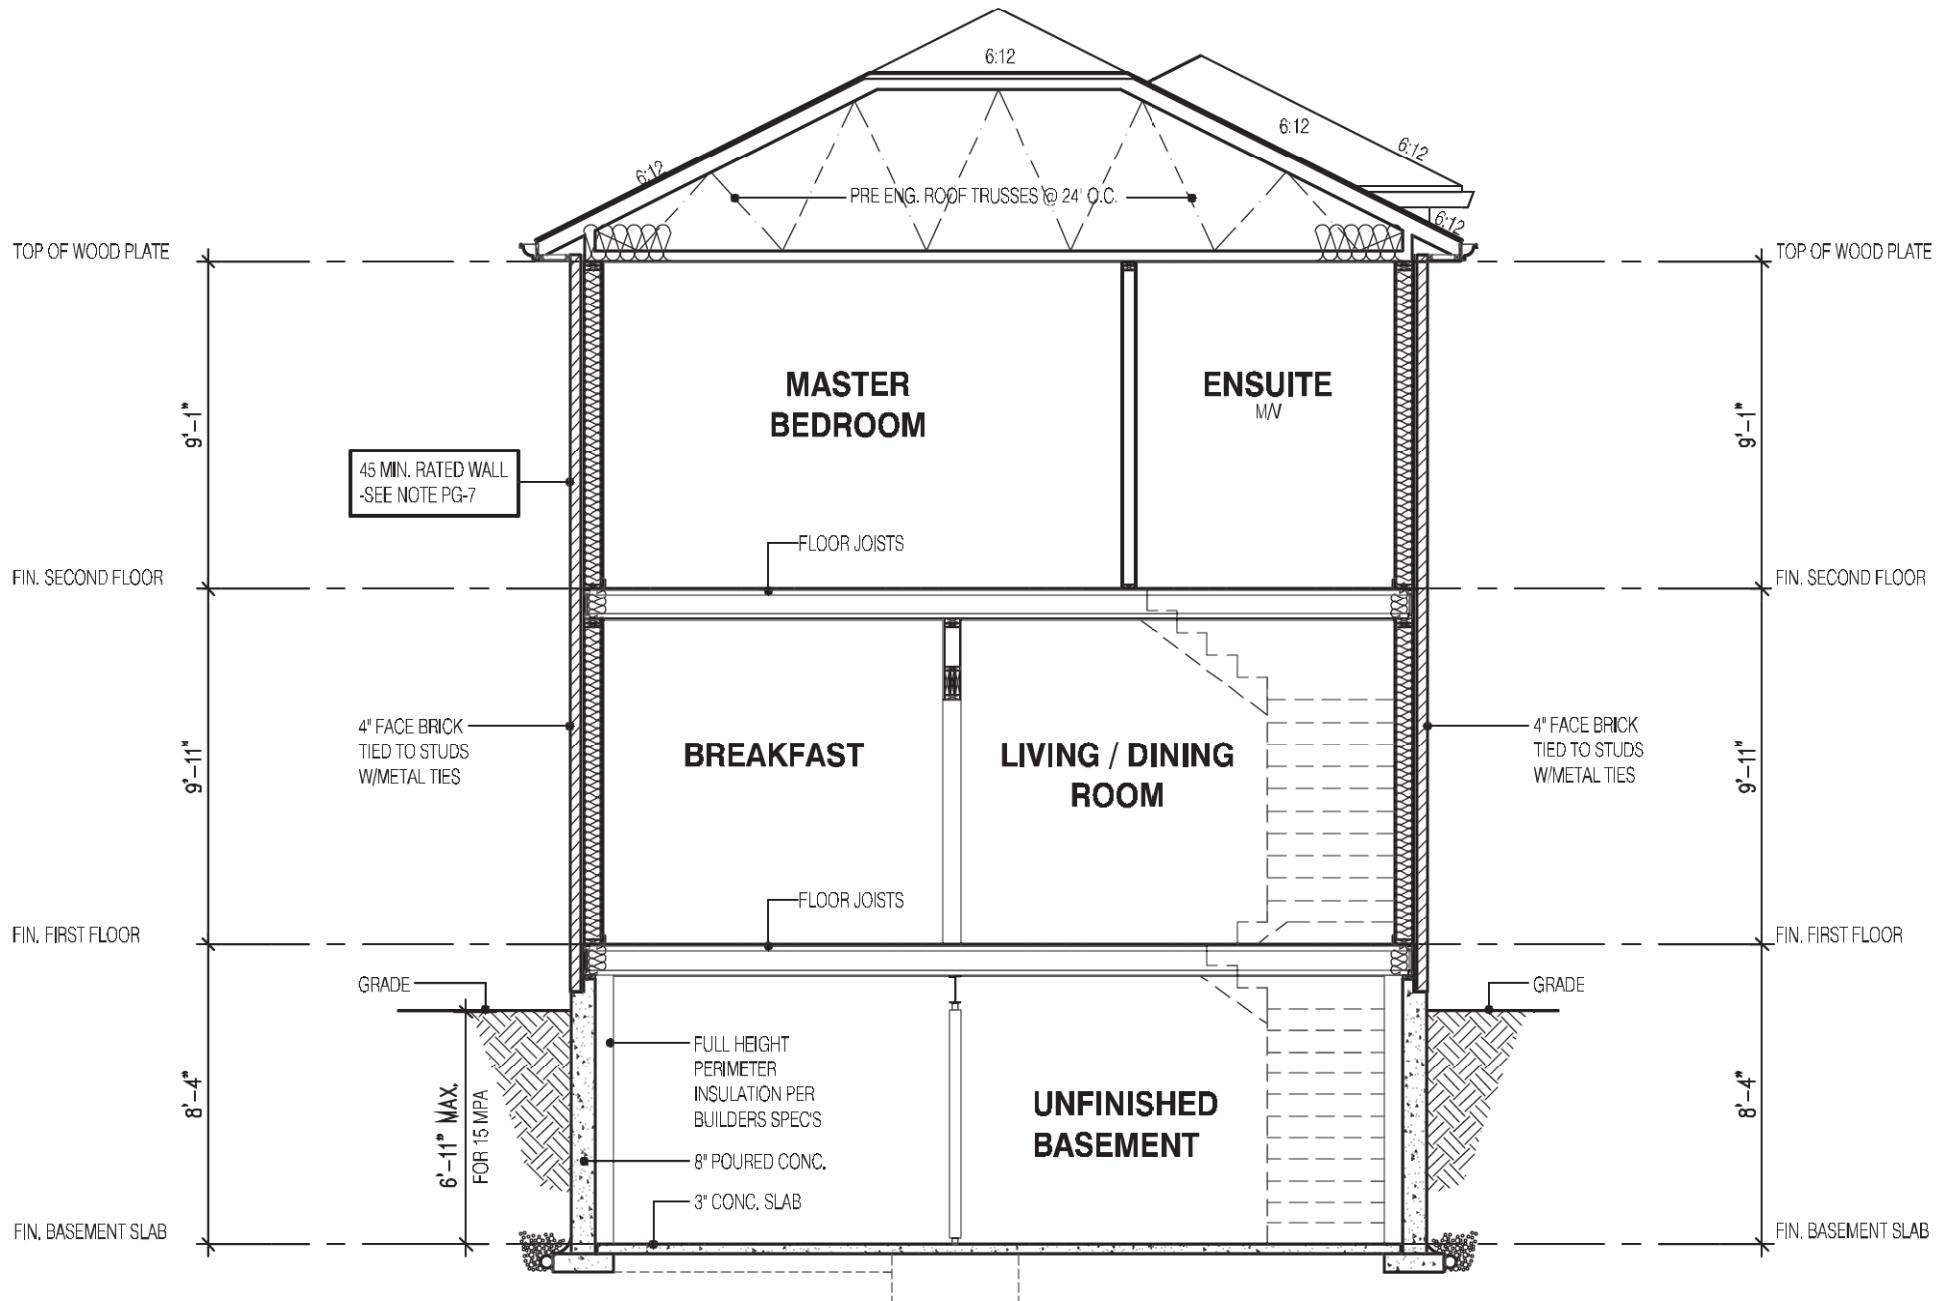

FOR STRUCTURE ONLY

THE CONTRACTOR SHALL CHECK AND VERIFY ALL DIMENSIONS AND CONDITIONS ON SITE BEFORE PROCEEDING WITH CONSTRUCTION. ANY DISCREPANCIES SHALL BE REPORTED TO JARDIN DESIGN GROUP INC. PRIOR TO COMMENCEMENT OF WORK.

JARDIN DESIGN GROUP INC. IS NOT RESPONSIBLE FOR THE ACCURACY OF SURVEY, STRUCTURAL OR ENGINEERING INFORMATION SHOWN ON THIS DRAWINGS OR FOR CONSTRUCTION STARTED PRIOR TO THE ISSUANCE OF A BUILDING PERMIT. REFER TO THE APPROPRIATE ENGINEERING DRAWINGS BEFORE PROCEEDING WITH WORK.

AS CONSTRUCTED INVERTS MUST BE VERIFIED PRIOR TO POLARING COATINGS.

JARDIN DESIGN GROUP INC. HAS NOT BEEN RETAINED TO CARRY OUT GENERAL REVIEW OF THE WORK AND ASSUMES NO RESPONSIBILITY FOR THE FAILURE OF THE CONTRACTOR OR SUB CONTRACTOR TO CARRY OUT THE WORK IN ACCORDANCE WITH THE CONTRACT DOCUMENTS.

THIS DRAWING IS AN INSTRUMENT OF SERVICE, IS PROVIDED BY AND IS THE PROPERTY OF JARDIN DESIGN GROUP INC. THIS DRAWING IS NOT TO BE SCALED.

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**Walter Botter** *Signature* 21031  
NAME SIGNATURE BCIN

REGISTRATION INFORMATION  
Required unless design is exempt under Division C, Subsection 3.2.4 of the building code

**jardin design group inc.** 27763  
FIRM NAME BCIN

**SECTION ELEVATION 3**  
ZADORRA ESTATE INC.  
CITY OF OSHAWA

MODEL: RIVER 1 (GR)	SCALE: 3/16"=1'-0"
PROJ. No. 22-16	DWG. No. 8B