



D1 PARTIAL BASEMENT PLAN
OPT. BASEMENT WALK-UP

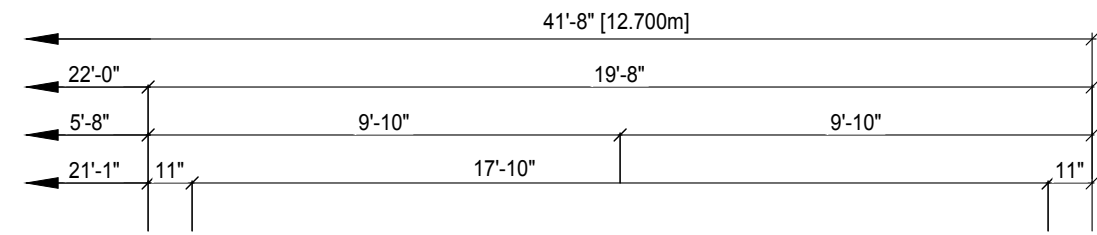

D1 PARTIAL GROUND FLOOR PLAN
OPT. BASEMENT WALK-UP

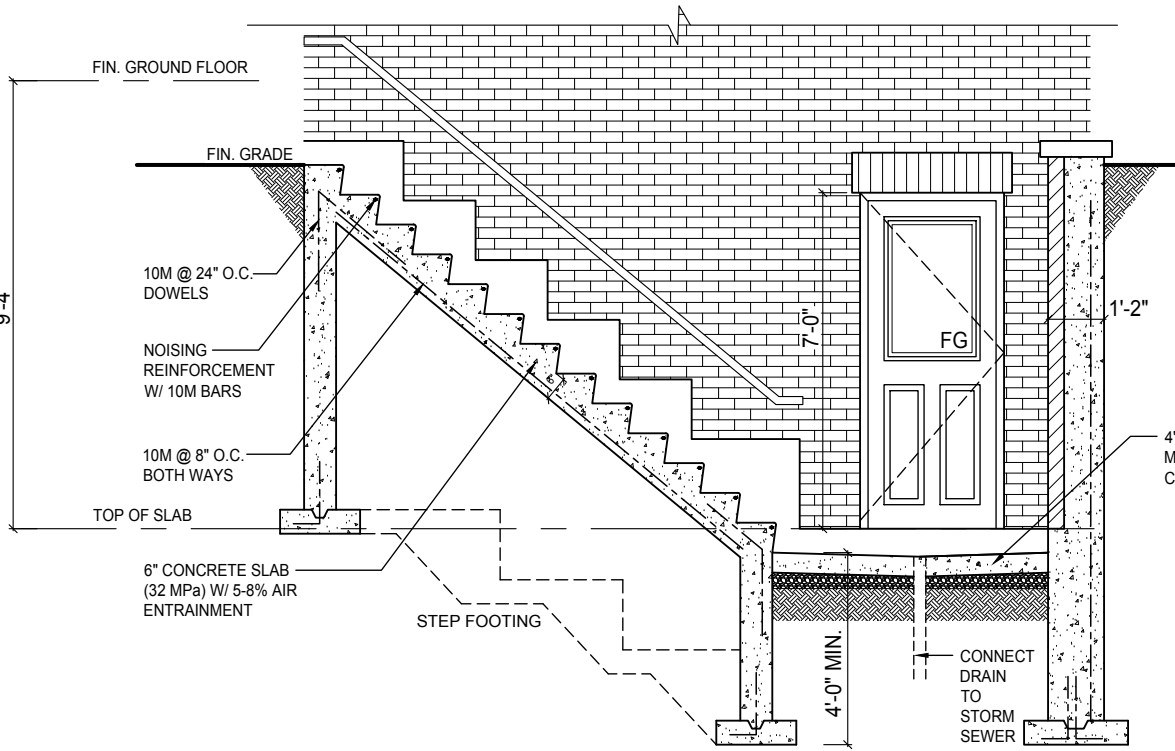

D1 WALK-UP DETAIL
SCALE: 1/4" = 1'-0"

NOTE: REFER TO FLOOR FRAMING SHOP
DRAWINGS FOR JOIST SIZING / SPACING &
BEAM SIZE INFORMATION

BASEMENT GENERAL NOTES

- ALL CONCRETE FOOTINGS SHALL REST ON UNDISTURBED SOIL WITH ALLOWABLE BEARING CAPACITY OF 150 KPA. (3135 PSF). (TO BE SITE VERIFIED) AND SHALL BE A MIN. OF 4" BELOW FINISHED GRADE.
- CONCRETE FOOTINGS AND FOUNDATION WALLS SHALL HAVE A MINIMUM COMPRESSIVE STRENGTH OF 25 MPa AFTER 28 DAYS
- STRUCTURAL STEEL MEMBERS AND INSERTS SHALL BE CSA G 40.21-A350 AND EMBEDDED PLATES SHALL BE GENERAL PURPOSE STEEL.
- BACKFILL SHALL BE PLACED AND COMPACTED EQUALLY ON BOTH SIDES OF GARAGE FOUNDATION WALLS TO AVOID LATERAL LOADING.
- ALL EXPOSED CONCRETE TO BE 32 MPa W/ 5-7% AIR ENTRAINMENT
- ALL FOOTINGS TO HAVE MIN. 2-15M BARS CONT.
- REFER TO FLOOR TRUSS SHOP DRAWINGS FOR ALL FLOOR FRAMING INFORMATION
- WHEN VENEER CUT IS GREATER THAN 26" A 10" POURED CONC. FDTN. WALL IS REQUIRED.
- SPACE CONVENTIONAL FLOOR JOISTS @ 12" O.C. BELOW ALL CERAMIC TILE AREAS. PROVIDE 1 ROW BRIDGING FOR SPANS OF 5'-7". 2 ROWS FOR SPANS GREATER THAN 7'

PAD FOOTING SCHEDULE

F1	24"x24"x12" POURED CONC. PAD
F2	36"x36"x16" POURED CONC. PAD
F3	42"x42"x16" POURED CONC. PAD
F4	48"x48"x16" POURED CONC. PAD
F5	54"x54"x16" POURED CONC. PAD
F6	60"x60"x18" POURED CONC. PAD

ASSUME SOIL BEARING CAPACITY 150 Kpa
TO BE SITE VERIFIED

STEEL COLUMN SCHEDULE

C1	4"x4"x14" H.S.S. W/ 6"x10"x12" BASE PLATE & 2-3/4" DIA. ANCHOR BOLTS W/ 4 BOLTS
C2	3 1/2"DIA. 1/4" THICK W/ 10"x10"x12" BASE PL. W/ 2-3/4" 4 - 1 DIA. ANCHOR BOLTS
C3	6" X 6" X 3/8" THICK W/ 12" X 12" X 1/2" BASE PLATE @ 4 - 3/4" DIA. ANCHOR BOLTS
C4	5" X 5" X 1/4" THICK W/ 10" X 10" X 1/2" BASE-PLATE @ 4 - 3/4" DIA. ANCHOR BOLTS
C5	4" X 4" X 1/4" THICK W/ 10" X 10" X 1/2" BASE-PLATE @ 4 - 3/4" DIA. ANCHOR BOLTS

1" 25KNm2 - USE 4 BOLTS FOR MOMENT CONNECTION

WOOD/STEEL LINTELS

WOOD/STEEL LINTELS	WOOD BEAMS
L1 2 - 2"x8" SP#2	WB1 2 - 2"x8" SP#2
L2 3 - 2"x8" SP#2	WB2 3 - 2"x8" SP#2
L3 2 - 2"x10" SP#2	WB3 4 - 2"x8" SP#2
L4 3 - 2"x10" SP#2	WB4 2 - 2"x10" SP#2
L5 2 - 2"x12" SP#2	WB5 3 - 2"x10" SP#2
L6 3 - 2"x12" SP#2	WB6 4 - 2"x10" SP#2
L7 3 1/2" x 3 1/2" x 1/4" (90x90x6) L	WB7 2 - 2"x12" SP#2
L8 3 1/2" x 3 1/2" x 5/16" (90x90x8) L	WB8 3 - 2"x12" SP#2
L9 4" x 3 1/2" x 1/4" (100x90x6) L	WB9 4 - 2"x12" SP#2
L10 5" x 3 1/2" x 5/16" (125x90x8) L	
L11 5" x 3 1/2" x 3/8" (125x90x10) L	
L12 6" x 4" x 3/8" (150x100x10) L	

CONC. 4-15m BARS OVER OPENING, EXTENDED BEAM 24" BELOW OPENING W/ 1RE 0m STIR-UPS @ 12" O/C

DOOR SCHEDULE - BASEMENT

1	2'-10" x 6'-8" - INSULATED ENTRANCE DOOR
1A	2'-8" x 6'-8" - INSULATED FRONT DOORS
2	2'-8" x 6'-8" - WOOD & GLASS DOOR
3	2'-8" x 6'-8" x 1-3/4" - EXTERIOR SLAB DOOR
3A	3'-0" x 6'-8" x 1-3/4" - EXTERIOR SLAB DOOR
4	2'-8" x 6'-8" x 1-3/8" - INTERIOR SLAB DOOR
5	2'-8" x 6'-8" x 1-3/8" - INTERIOR SLAB DOOR
6	2'-2" x 6'-8" x 1-3/8" - INTERIOR SLAB DOOR
7	1'-6" x 6'-8" x 1-3/8" - INTERIOR SLAB DOOR
8	2'-0" x 6'-8" x 1-3/8" - INTERIOR SLAB DOOR
9	2'-4" x 6'-8" x 1-3/8" - INTERIOR SLAB DOOR

REBAR NOTES

B.L.L.	BOTTOM LOWER LEVEL
B.U.L.	BOTTOM UPPER LEVEL
T.U.L.	TOP UPPER LEVEL
T.A.A.	TOP ALL AROUND
B.E.W.	BOTTOM EACH WAY

DESIGN LOADS - BASEMENT

LIVE LOAD	40 PSF
DEAD LOAD	20 PSF

ONE RISER DESIGNS
20 RIVERMEDE ROAD, UNIT 101
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L4K 3N3
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IAN ROBERTSON	27816
IAN ROBERTSON	32072

CLIENT: GREENYORK HOMES

Project: DEGREY DR.
CITY OF BRAMPTON

Model: YORK 2 EL.A

Sheet Title: BASEMENT PLAN
& DETAILS
ELEVATION 'A'

Drawn by: MT
Checked by: MS
Project No: 17-08
Scale: 3/16"=1'-0"
Page: 2 OF 9

It is the builder's complete responsibility to ensure that all plans submitted for approval fully comply with the Architectural Guidelines and all applicable regulations and requirements including zoning provisions and any provisions in the subdivision agreement. The Control Architect is not responsible in any way for examining or approving site (lotting) plans or working drawings with respect to any zoning or building code or permit matter or that any house can be properly built or located on its lot.

This is to certify that these plans comply with the applicable Architectural Design Guidelines approved by the City of BRAMPTON.



NOTE: REFER TO FLOOR FRAMING SHOP DRAWINGS FOR JOIST SIZING / SPACING & BEAM SIZE INFORMATION

GROUND FLOOR GENERAL NOTES

- ALL INTERIOR DOOR AND OPENING LINTEL NOT SHOWN TO BE A MIN. OF 2-2"x8" SPP#1
- ALL 4" & 6" PARTITIONS SHOWN (UNLESS OTHERWISE NOTED) TO BE 2"x4" OR 2"x6" @ 16" O.C. W/ 1/2" DRYWALL BOTH SIDES
- PROVIDE WALLS WITH DOUBLE TOP PLATE AND SINGLE BOTTOM PLATE, DOUBLE STUDS AT ALL OPENINGS AND TRIPLE STUDS @ CORNERS
- REFER TO FLOOR TRUSS SHOP DRAWINGS FOR ALL FLOOR FRAMING INFORMATION
- REFER TO TRUSS SHOP DRAWINGS FOR ALL ROOF FRAMING INFORMATION
- SPACE CONVENTIONAL FLOOR JOISTS @ 12" O.C. BELOW ALL CERAMIC TILE AREAS. PROVIDE 1 ROW BRIDGING FOR SPANS OF 5-7', 2 ROWS FOR SPANS GREATER THAN 7'
- CONTRACTOR TO VERIFY ALL FLOOR & ROOF TRUSSES, DIMENSIONS AND ENGINEERING. ANY DISCREPANCIES SHALL BE REPORTED TO 1 RISER DESIGNS PRIOR TO CONSTRUCTION.

STEEL COLUMN SCHEDULE

C1	4"x4"x1/4" H.S.S. W/ 6"x10"x1/2" BASE PLATE & 3/4" DIA. ANCHOR BOLTS W/ 4 BOLTS
C2	3 1/2" DIA. 1/4" THICK W/ 10"x10"x1/2" BASE PL. W/ 2-3/4" 4 - 1 DIA. ANCHOR BOLTS
C3	6" X 6" X 3/8" THICK W/ 12" X 12" X 1/2" BASE PLATE @ 4 - 3/4" DIA. ANCHOR BOLTS
C4	5" X 5" X 1/4" THICK W/ 10" X 10" X 1/2" BASE-PLATE @ 4 - 3/4" DIA. ANCHOR BOLTS
C5	4" X 4" X 1/4" THICK W/ 10" X 10" X 1/2" BASE-PLATE @ 4 - 3/4" DIA. ANCHOR BOLTS

M* 25KN/m2 - USE 4 BOLTS FOR MOMENT CONNECTION

WOOD/STEEL LINTELS

WOOD/STEEL LINTELS	WOOD BEAMS
L1 2 - 2"x8" SP#2	WB1 2 - 2"x8" SP#2
L2 3 - 2"x8" SP#2	WB2 3 - 2"x8" SP#2
L3 2 - 2"x10" SP#2	WB3 4 - 2"x8" SP#2
L4 3 - 2"x10" SP#2	WB4 2 - 2"x10" SP#2
L5 2 - 2"x12" SP#2	WB5 3 - 2"x10" SP#2
L6 3 - 2"x12" SP#2	WB6 4 - 2"x10" SP#2
L7 3 1/2" x 3 1/2" x 1/4" (90x90x6) L	WB7 2 - 2"x12" SP#2
L8 3 1/2" x 3 1/2" x 1/4" (100x90x6) L	WB8 3 - 2"x12" SP#2
L9 4" x 3 1/2" x 1/4" (100x90x6) L	WB9 4 - 2"x12" SP#2
L10 5" x 3 1/2" x 5/16" (125x90x8) L	
L11 5" x 3 1/2" x 3/8" (125x90x10) L	
L12 6" x 4" x 3/8" (150x100x10) L	

DOOR SCHEDULE - GROUND FLOOR

1	2'-10" x 8'-0" - INSULATED ENTRANCE DOOR
1A	2'-8" x 8'-0" - INSULATED FRONT DOORS
2	2'-8" x 8'-0" - WOOD & GLASS DOOR
3	2'-8" x 8'-0" x 1-3/4" - EXTERIOR SLAB DOOR
3A	3'-0" x 8'-0" x 1-3/4" - EXTERIOR SLAB DOOR
4	2'-8" x 8'-0" x 1-3/8" - INTERIOR SLAB DOOR
5	2'-8" x 8'-0" x 1-3/8" - INTERIOR SLAB DOOR
6	2'-2" x 8'-0" x 1-3/8" - INTERIOR SLAB DOOR
7	1'-6" x 8'-0" x 1-3/8" - INTERIOR SLAB DOOR
8	2'-0" x 8'-0" x 1-3/8" - INTERIOR SLAB DOOR
9	2'-4" x 8'-0" x 1-3/8" - INTERIOR SLAB DOOR

DESIGN LOADS - GROUND FLOOR

LIVE LOAD	40 PSF
DEAD LOAD	20 PSF

WALL LEGEND

	VARYING WALL HEIGHT
	DOUBLE VOLUME WALL
	LOAD BEARING WALL

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This is to certify that these plans comply with the applicable Architectural Design Guidelines approved by the City of BRAMPTON.

STRUDET INC.



ONE RISER
DESIGNS
20 RIVERMEDE ROAD, UNIT 101
CONCORD, ONTARIO
L4K 3N3
PHONE: (905) 669-2111
FAX: 1 (866) 602-1163
www.oneriser.ca

The undersigned has reviewed and takes responsibility for this design, and has the qualifications and meets the requirements set out in the Ontario Building Code to design the work shown on these documents.

QUALIFICATION REQUIREMENTS
REQUIRED UNDER DESIGN OR EXCEPT UNDER DESIGN
IAN ROBERTSON
REGISTRATION NUMBER
27816
1 RISER DESIGNS INC.
32072


CLIENT: GREENYORK HOMES

Project: DEGREY DR.
CITY OF BRAMPTON

Model: YORK 2 EL.A

Sheet Title: GROUND FLOOR PLAN
ELEVATION 'A'

Drawn by: MT
Checked by: MS
Project No: 17-08
Scale: 3/16"=1'0"
Page: 3 OF 9

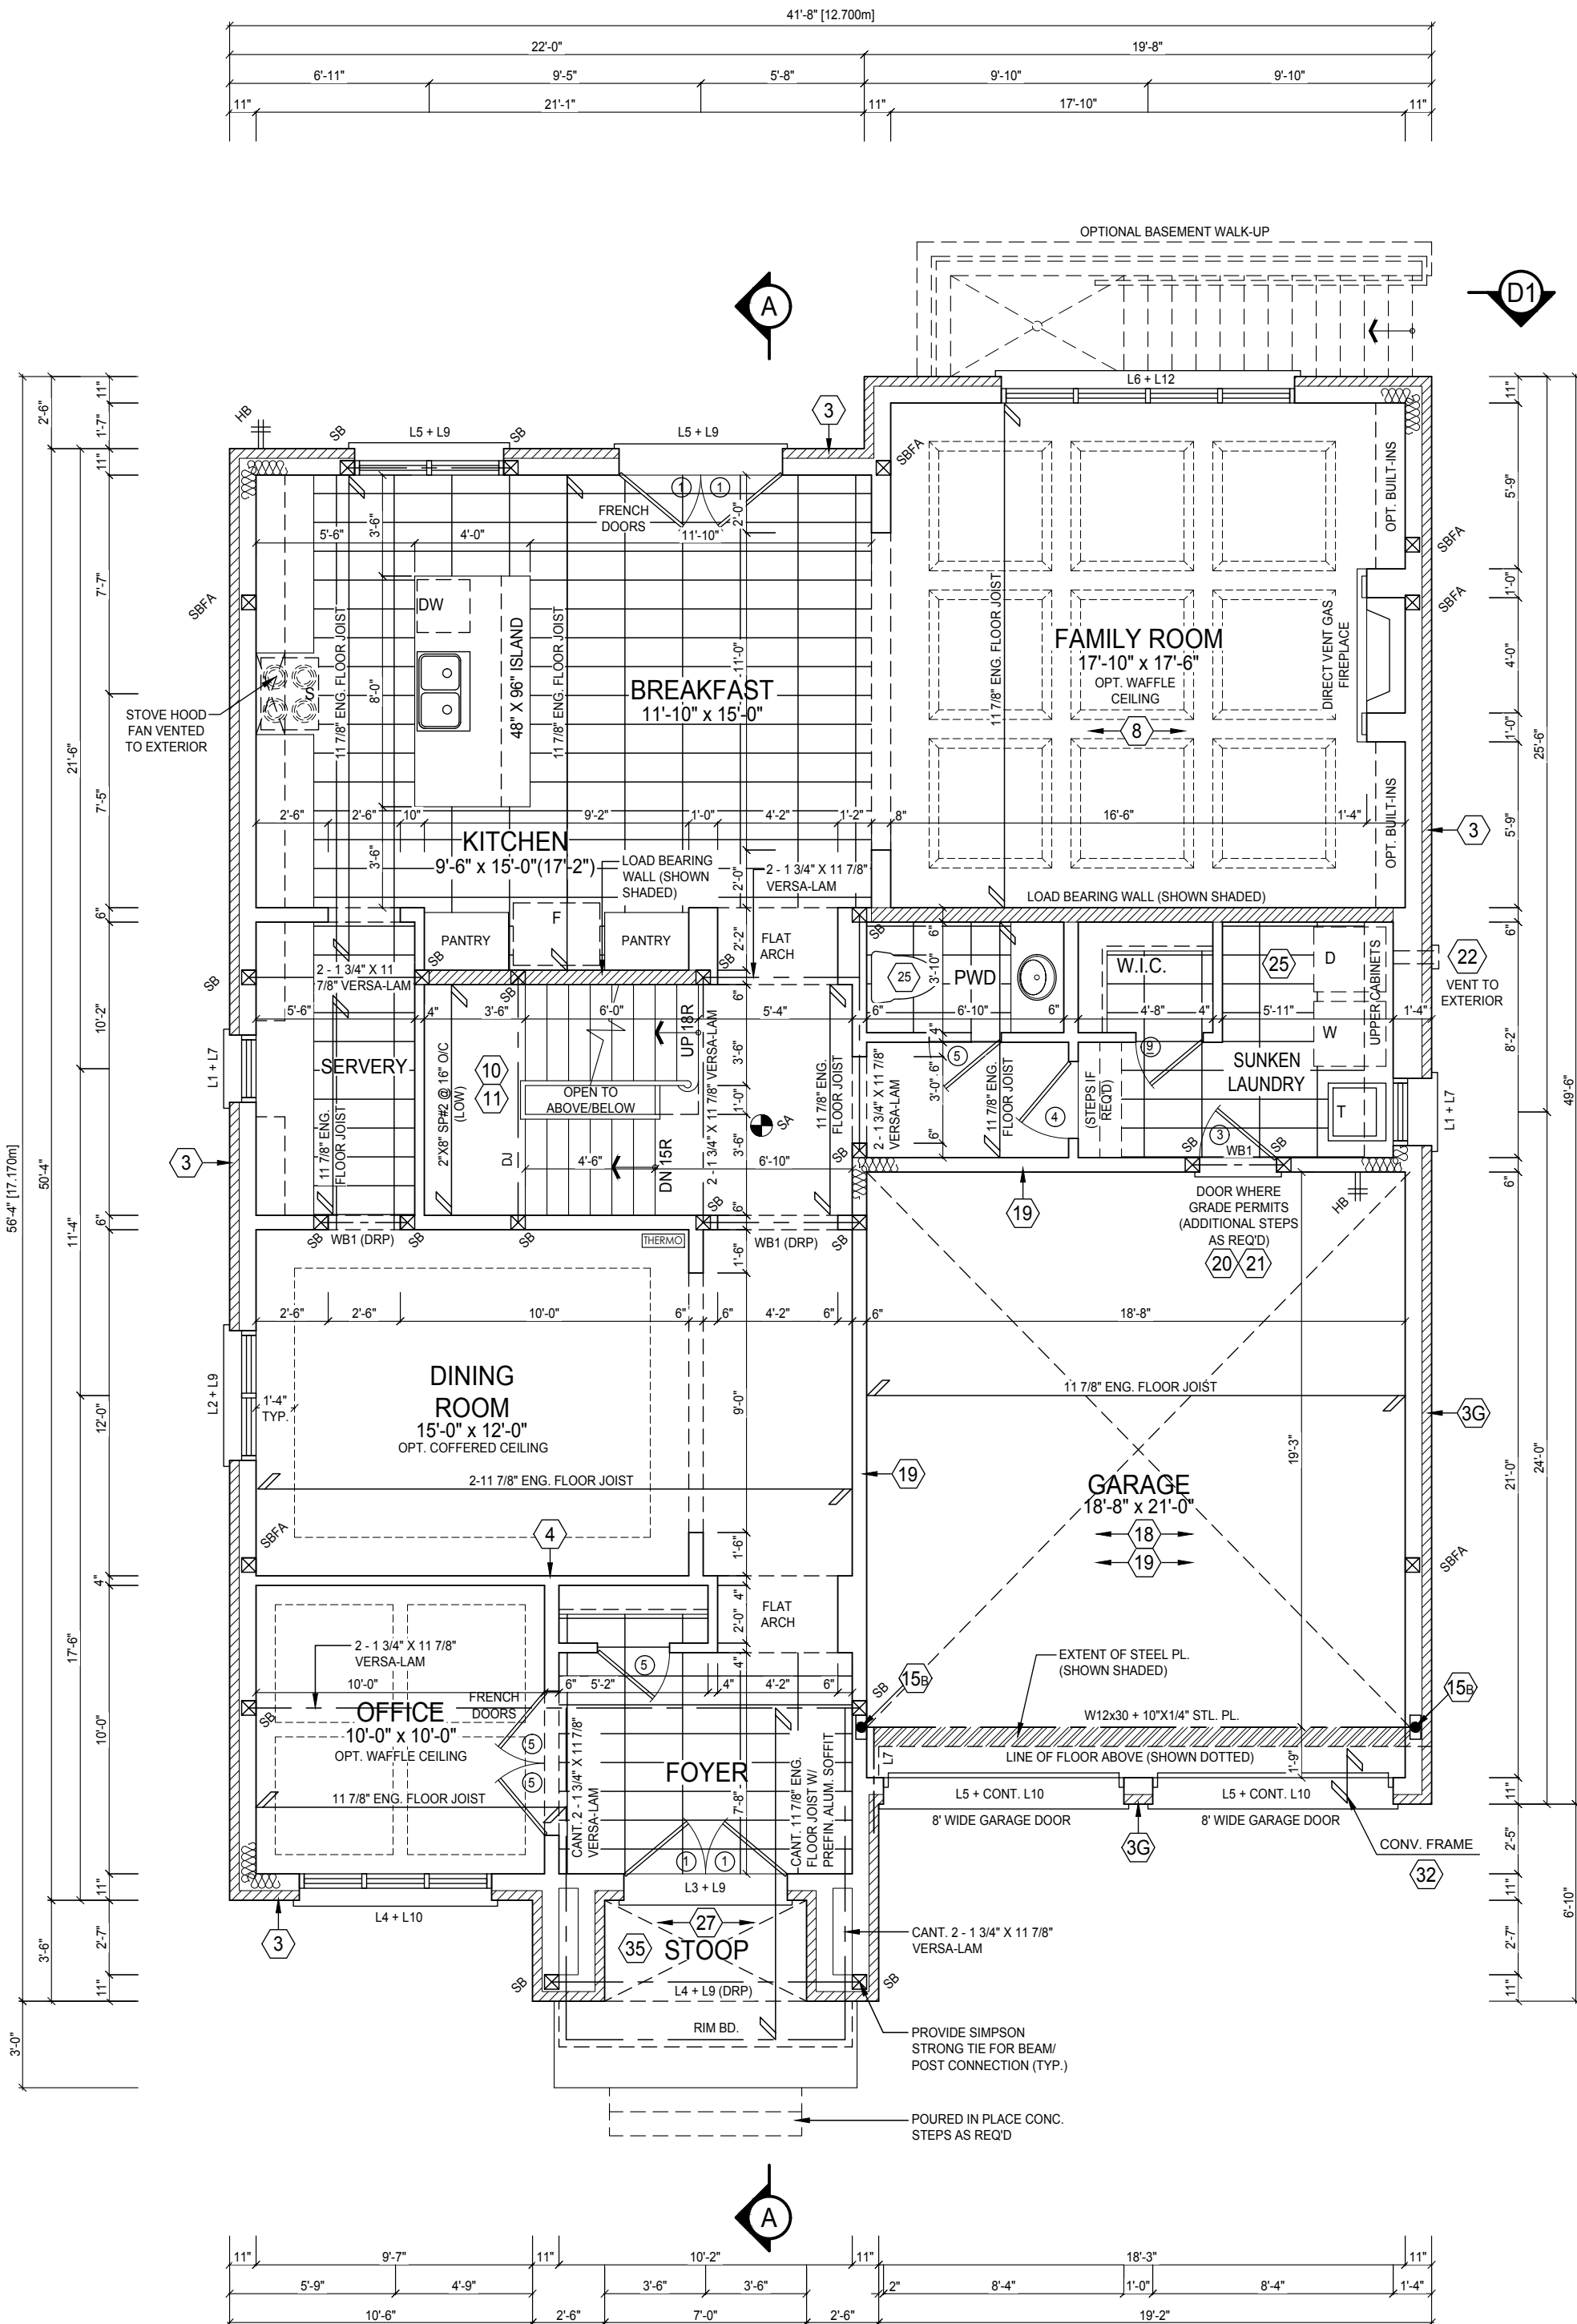

NOTE: REFER TO ROOF TRUSS SHOP DRAWINGS FOR ALL ROOF FRAMING INFORMATION

SECOND FLOOR GENERAL NOTES

- ALL INTERIOR DOOR AND OPENING LINTEL NOT SHOWN TO BE A MIN. OF 2-2"x8" SP#2
- ALL 4" & 6" PARTITIONS SHOWN (UNLESS OTHERWISE NOTED) TO BE 2"x4" OR 2"x6" @ 16" O/C W/ 1/2" DRYWALL BOTH SIDES
- PROVIDE WALLS WITH DOUBLE TOP PLATE AND SINGLE BOTTOM PLATE, DOUBLE STUDS AT ALL OPENINGS AND TRIPLE STUDS @ CORNERS
- REFER TO TRUSS SHOP DRAWINGS FOR ALL ROOF FRAMING INFORMATION
- CONTRACTOR TO VERIFY ALL FLOOR & ROOF TRUSSES, DIMENSIONS AND ENGINEERING. ANY DISCREPANCIES SHALL BE REPORTED TO 1 RISER DESIGNS PRIOR TO CONSTRUCTION.

STEEL COLUMN SCHEDULE

C1	4"x4"x1/4" H.S.S. W/ 6"x10"x1/2" BASE PLATE & 2-3/4" DIA. ANCHOR BOLTS W/ 4 BOLTS
C2	3 1/2" DIA. 1/4" THICK W/ 10"x10"x1/2" BASE PL. W/ 2-3/4" 4 - 1 DIA. ANCHOR BOLTS
C3	6" x 6" x 3/8" THICK W/ 12" x 12" x 1/2" BASE PLATE @ 4 - 3/4" DIA. ANCHOR BOLTS
C4	5" x 5" x 1/4" THICK W/ 10" x 10" x 1/2" BASE- PLATE @ 4 - 3/4" DIA. ANCHOR BOLTS
C5	4" x 4" x 1/4" THICK W/ 10" x 10" x 1/2" BASE- PLATE @ 4 - 3/4" DIA. ANCHOR BOLTS

M 25KN/m2 - USE 4 BOLTS FOR MOMENT CONNECTION

WOOD/STEEL LINTELS	WOOD BEAMS
L1 2 - 2"x8" SP#2	WB1 2 - 2"x8" SP#2
L2 3 - 2"x8" SP#2	WB2 3 - 2"x8" SP#2
L3 2 - 2"x10" SP#2	WB3 4 - 2"x8" SP#2
L4 3 - 2"x10" SP#2	WB4 2 - 2"x10" SP#2
L5 2 - 2"x12" SP#2	WB5 3 - 2"x10" SP#2
L6 3 - 2"x12" SP#2	WB6 4 - 2"x10" SP#2
L7 3 1/2" x 3 1/2" x 1/4" (90x90x6) L	WB7 2 - 2"x12" SP#2
L8 3 1/2" x 3 1/2" x 5/16" (90x90x8) L	WB8 3 - 2"x12" SP#2
L9 4" x 3 1/2" x 1/4" (100x90x6) L	WB9 4 - 2"x12" SP#2
L10 5" x 3 1/2" x 5/16" (125x90x8) L	
L11 5" x 3 1/2" x 3/8" (125x90x10) L	
L12 6" x 4" x 3/8" (150x100x10) L	

DOOR SCHEDULE - SECOND FLOOR

1	2'-10" x 7'-0" - INSULATED ENTRANCE DOOR
1A	2'-8" x 7'-0" - INSULATED FRONT DOORS
2	2'-8" x 7'-0" - WOOD & GLASS DOOR
3	2'-8" x 7'-0" x 1-3/4" - EXTERIOR SLAB DOOR
3A	3'-0" x 7'-0" x 1-3/4" - EXTERIOR SLAB DOOR
4	2'-8" x 7'-0" x 1-3/8" - INTERIOR SLAB DOOR
5	2'-6" x 7'-0" x 1-3/8" - INTERIOR SLAB DOOR
6	2'-2" x 7'-0" x 1-3/8" - INTERIOR SLAB DOOR
7	1'-6" x 7'-0" x 1-3/8" - INTERIOR SLAB DOOR
8	2'-0" x 7'-0" x 1-3/8" - INTERIOR SLAB DOOR
9	2'-4" x 7'-0" x 1-3/8" - INTERIOR SLAB DOOR

DESIGN LOADS - ASPHALT SHINGLES

DEAD LOAD	TOP CHORD = 15.00 PSF
	BOTTOM CHORD = 10.00 PSF
LIVE LOAD	TOP CHORD = 30.00 PSF
	BOTTOM CHORD = 7.00 PSF

WALL LEGEND

	VARYING WALL HEIGHT
	DOUBLE VOLUME WALL
	LOAD BEARING WALL

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This is to certify that these plans comply with the applicable Architectural Design Guidelines approved by the City of BRAMPTON.

STRUDET INC.



ONE RISER
DESIGNS
20 RIVERMEDE ROAD, UNIT 101
CONCORD, ONTARIO
L4K 3N3
PHONE: (905) 669-2111
FAX: 1 (866) 602-1163
www.oneriser.ca

The undersigned has reviewed and takes responsibility for this design, and has the qualifications and meets the requirements set out in the Ontario Building Code to design the work shown on these documents	
REQUIRED UNDER DESIGN OR EXEMPT UNDER CODE	REQUIRED UNDER DESIGN OR EXEMPT UNDER CODE
IAN ROBERTSON	27816
REGISTRATION NO.	32072
1 RISER DESIGNS INC.	

CLIENT: GREENYORK HOMES


Project: DEGREY DR.
CITY OF BRAMPTON




Model: YORK 2 EL.A

Sheet Title: SECOND FLOOR PLAN
ELEVATION 'A'

Drawn by: MT	Checked by: MS
Project No: 17-08	Page: 4 OF 9
Scale: 3/16"=1'0"	

REVISIONS		
#	Description	Date
1	ISSUED FOR PRICING	APR. 5/17
2	ISSUED FOR PERMIT & CONSTRUCTION	MAY. 29/17

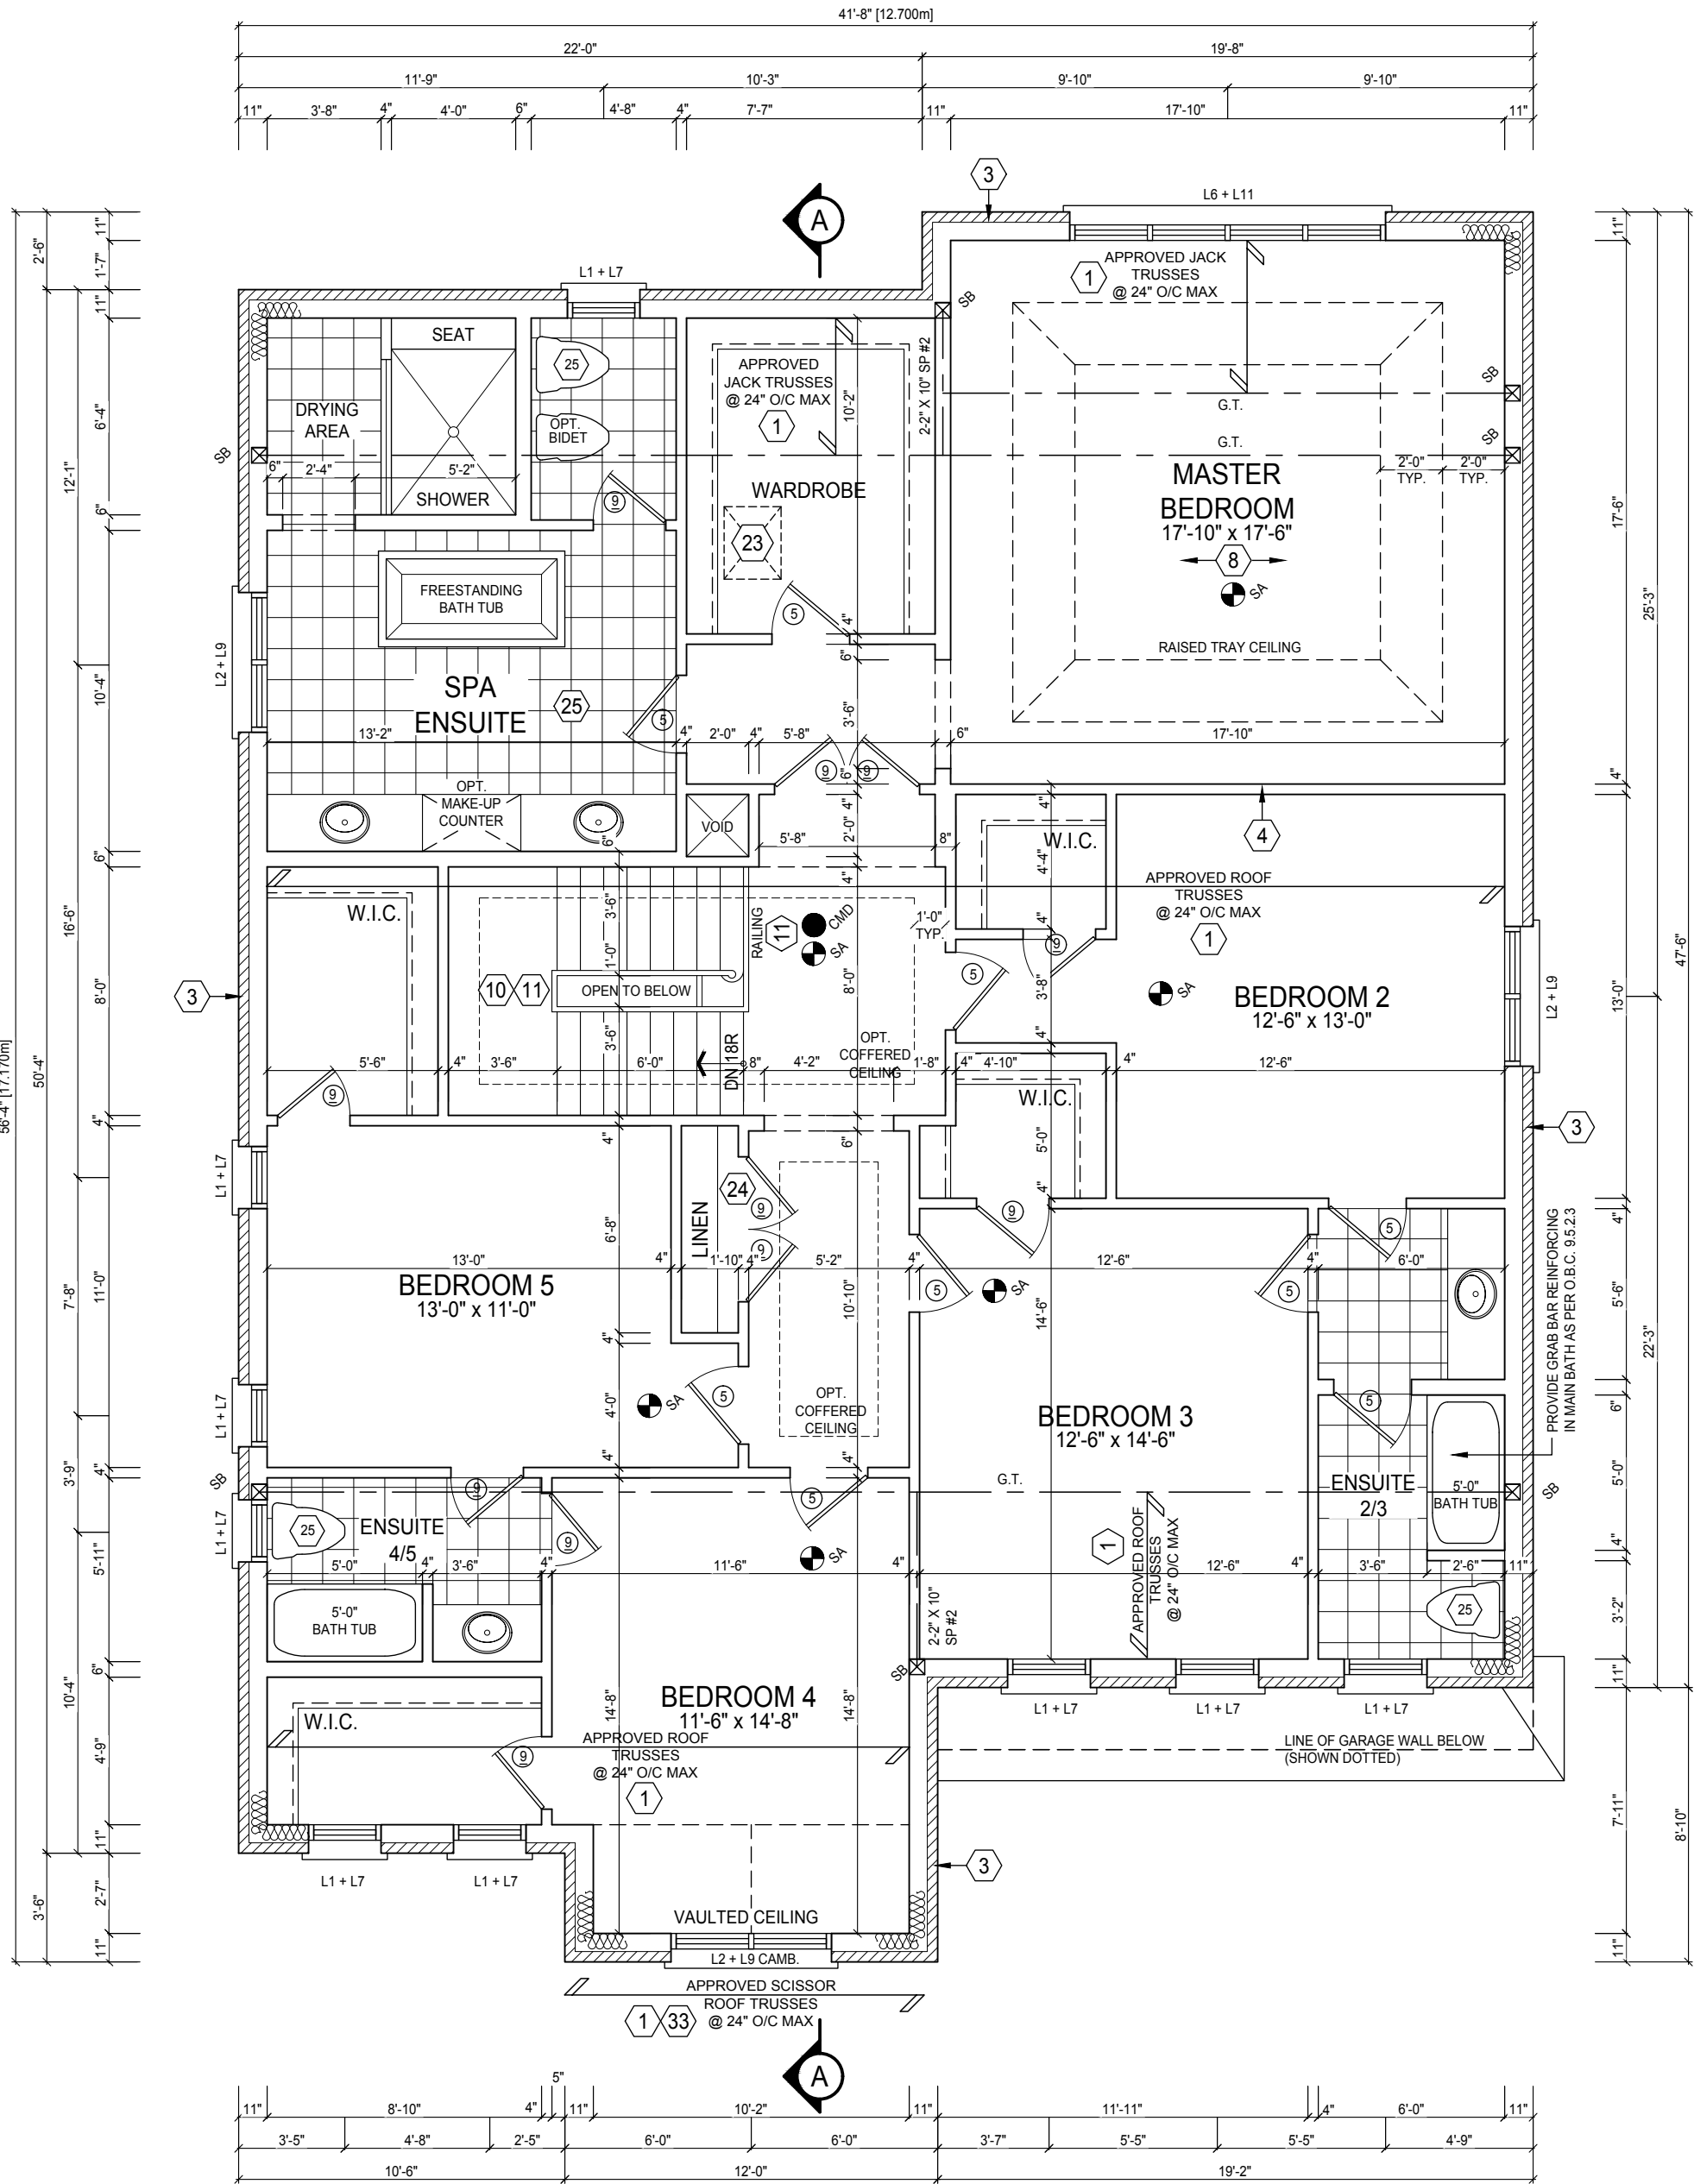

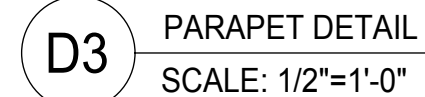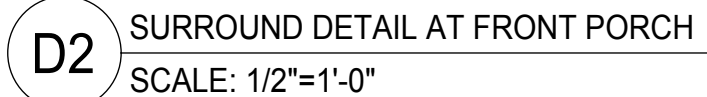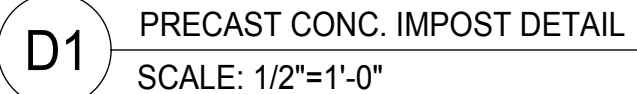


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ONERISER
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CONCORD, ONTARIO
L4K 3N3
PHONE: (905) 669-2111
FAX: 1 (866) 602-1163
www.oneriser.ca

The undersigned has reviewed and takes responsibility for this design, and has the qualifications and meets the requirements set forth in the Ontario Building Code to design the work shown on the attached documents.

QUALIFICATION INFORMATION
REQUIRED UNLESS DESIGN IS EXEMPT UNDER DIVISION 3, SUBSECTION 3.2.5 OF THE BUILDING CODE

IAN ROBERTSON  27816

REGISTRATION INFORMATION
REQUIRED UNLESS DESIGN IS EXEMPT UNDER DIVISION 3, SUBSECTION 3.2.4 OF THE BUILDING CODE

1 RISER DESIGNS Inc. 32072


Client: **GREENYORK HOMES**

Project: **DEGREY DR,
CITY OF BRAMPTON**

Model: **YORK 2 EL.A**

FRONT ELEVATION 'A'
ROOF PLAN & DETAILS

Drawn by: MT	Checked by: MS
Project No: 17-08	Page: 5 OF 9
Scale: 3/16"=1'0"	

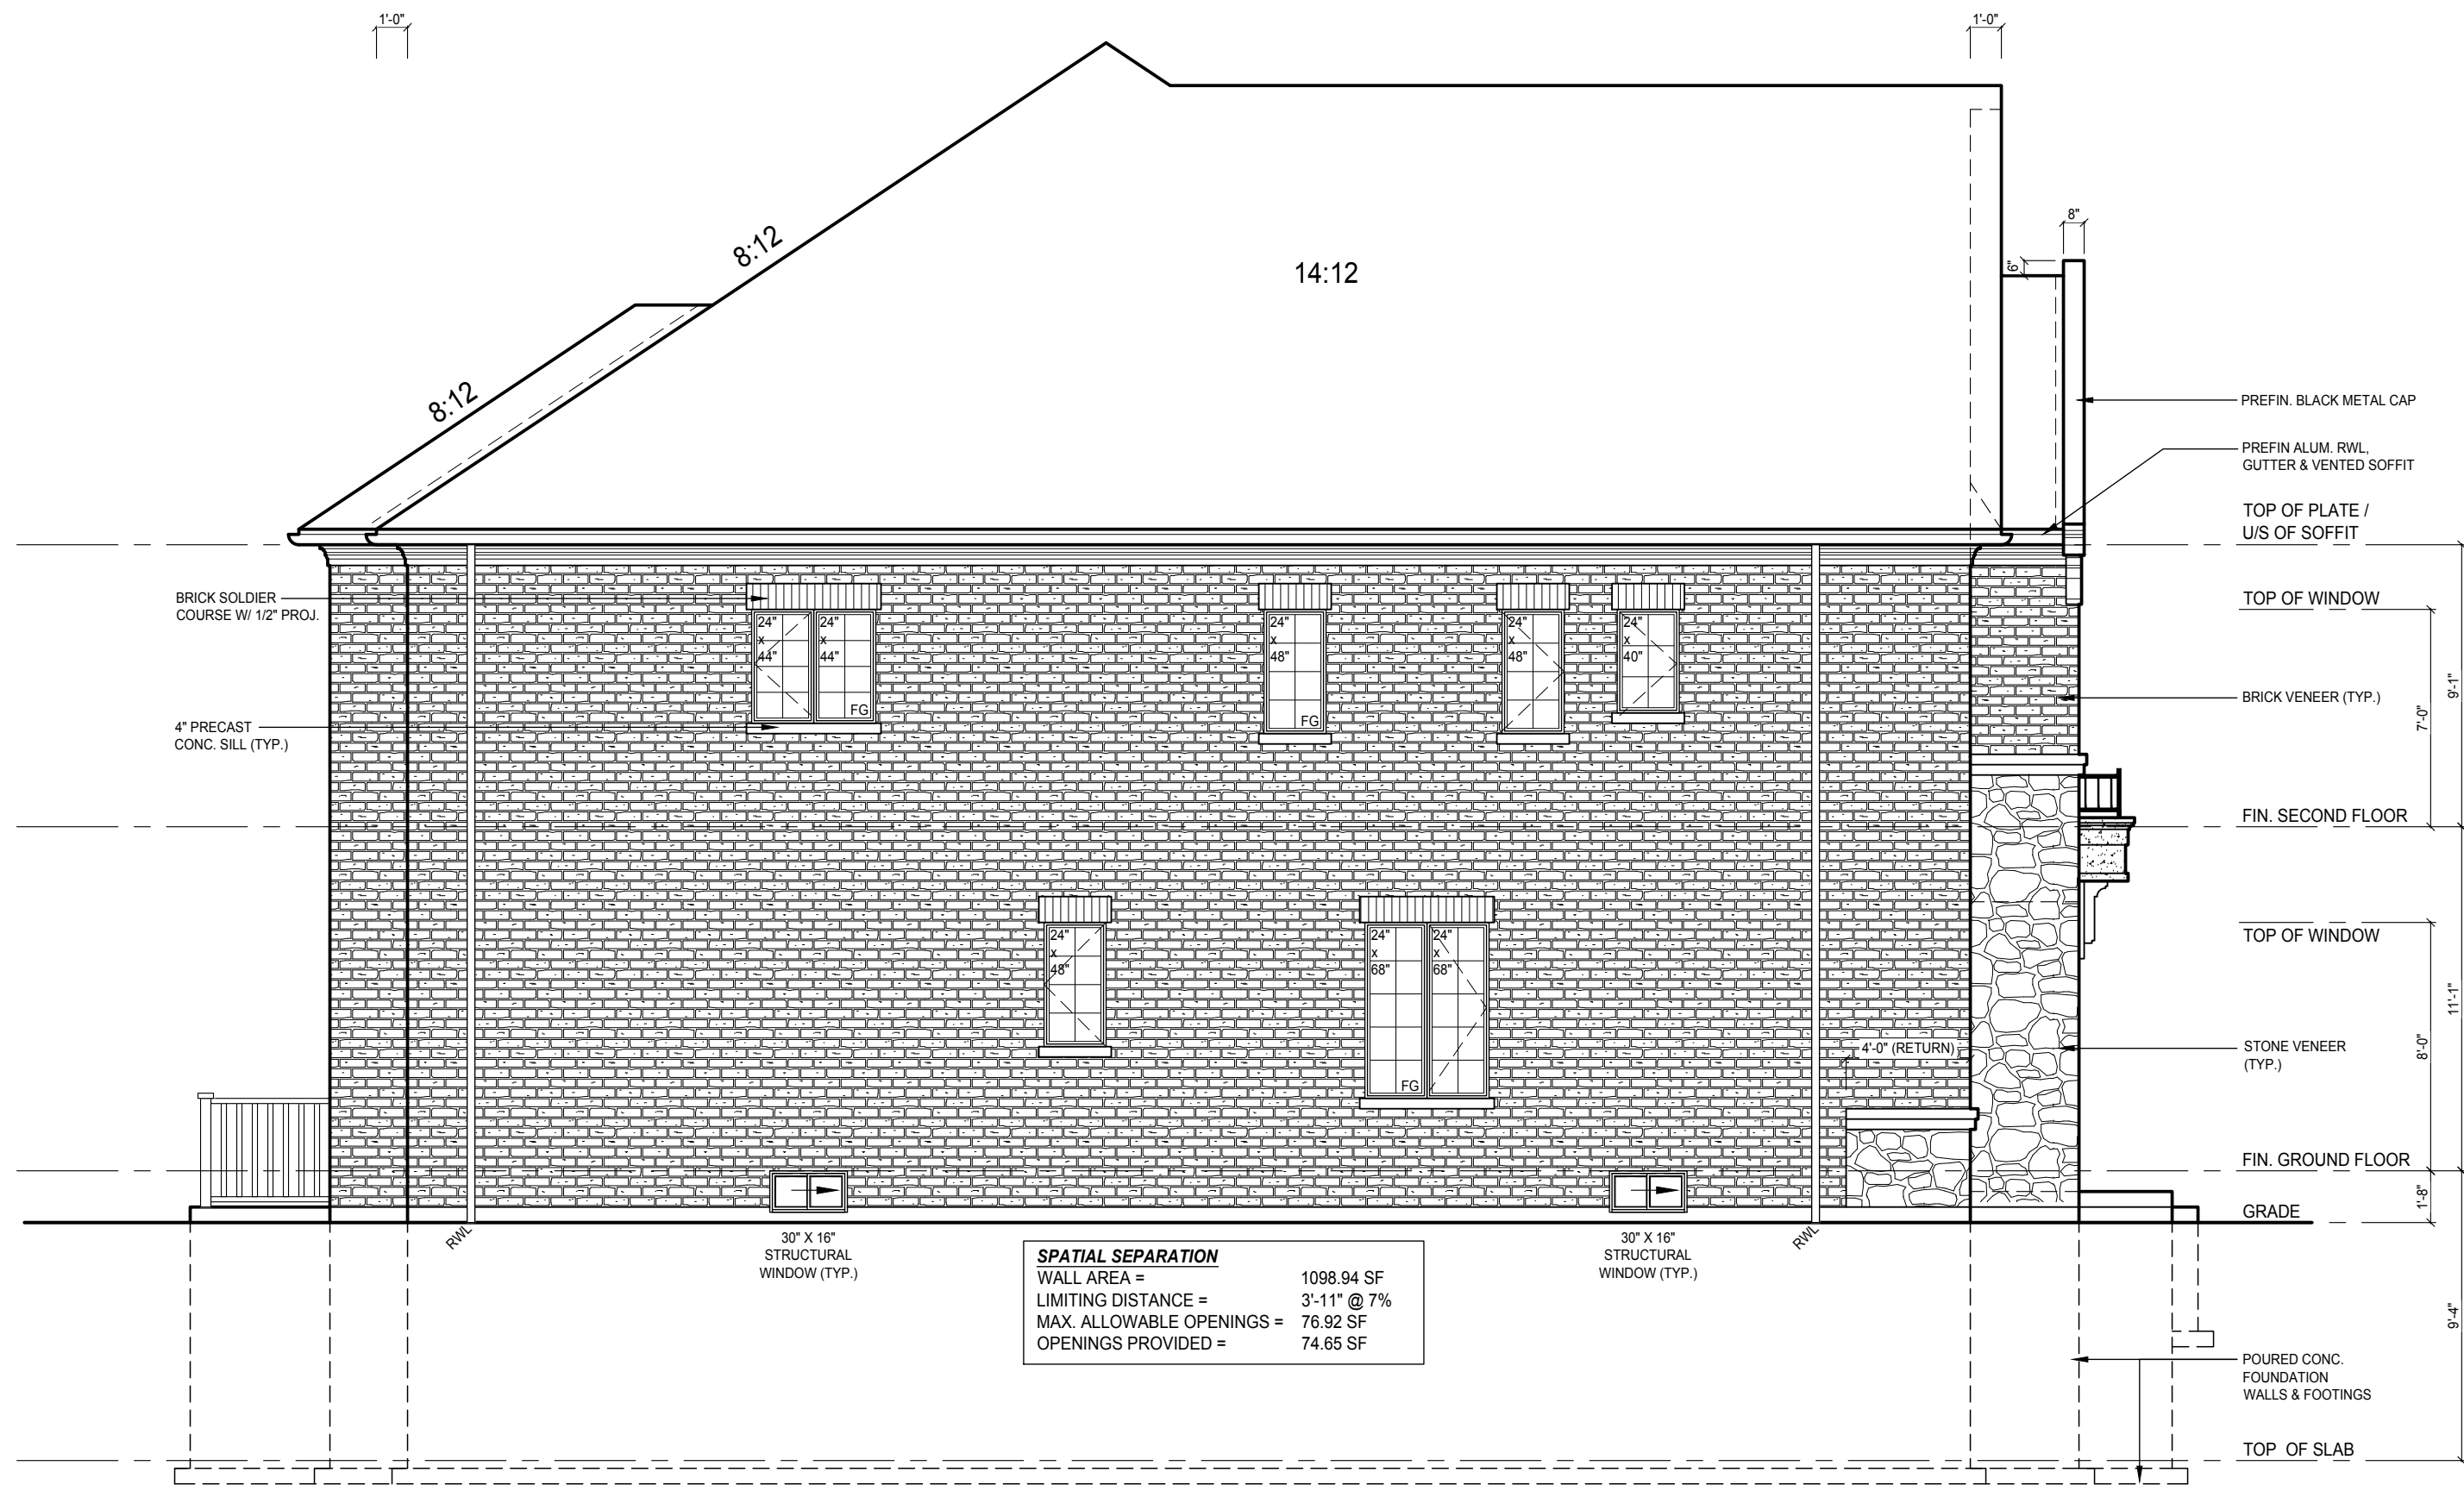

LEFT SIDE ELEVATION 'A'

ELEVATION GENERAL NOTES
- REFER TO FRONT ELEVATION FOR INFORMATION NOT SHOWN

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This is to certify that these plans comply with the applicable Architectural Design Guidelines approved by the City of BRAMPTON.

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CONCORD, ONTARIO
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www.oneriser.ca

The undersigned has reviewed and takes responsibility for this design, and has the qualifications and meets the requirements set out in the Ontario Building Code to design the work shown on these plans and documents.

QUALIFICATION NUMBER	27816
IAN ROBERTSON	REGISTERED ARCHITECT
1 RISER DESIGNS INC.	32072

Client: GREENYORK HOMES

Project: DEGREY DR.
CITY OF BRAMPTON


Model: YORK 2 EL.A

Sheet Title: LEFT SIDE ELEVATION 'A'

Drawn by: MT	Checked by: MS
Project No: 17-08	Page: 6 OF 9
Scale: 3/16"=1'0"	

REVISIONS			
#	Description	Date	By:
1	ISSUED FOR PRICING	APR. 5/17	MS
2	ISSUED FOR PERMIT & CONSTRUCTION	MAY. 29/17	MS

- REFER TO FRONT ELEVATION FOR INFORMATION NOT SHOWN

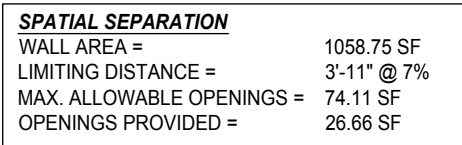


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This is to certify that these plans comply with the applicable Architectural Design Guidelines approved by the City of BRAMPTON.

The undersigned has reviewed and takes responsibility for this design, and has the qualifications and meets the requirements set forth by the Ontario Building Code to design the work shown on the attached documents

QUALIFICATION INFORMATION
REQUIRED UNLESS DESIGN IS EXEMPT UNDER DIVISION 3.2.4 OF THE BUILDING CODE

IAN ROBERTSON  27816

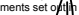REGISTRATION INFORMATION
REQUIRED UNLESS DESIGN IS EXEMPT UNDER DIVISION 3.2.4 OF THE BUILDING CODE

1 RISER DESIGN'S Inc. 32072

Sheet Title:


RIGHT SIDE ELEVATION 'A'

[illegible]

Drawn by: MT	Checked by: MS
Project No: 17-08	Page: 7 OF 9
Scale: 3/16"=1'0"	

ELEVATION GENERAL NOTES

- REFER TO FRONT ELEVATION FOR INFORMATION NOT SHOWN

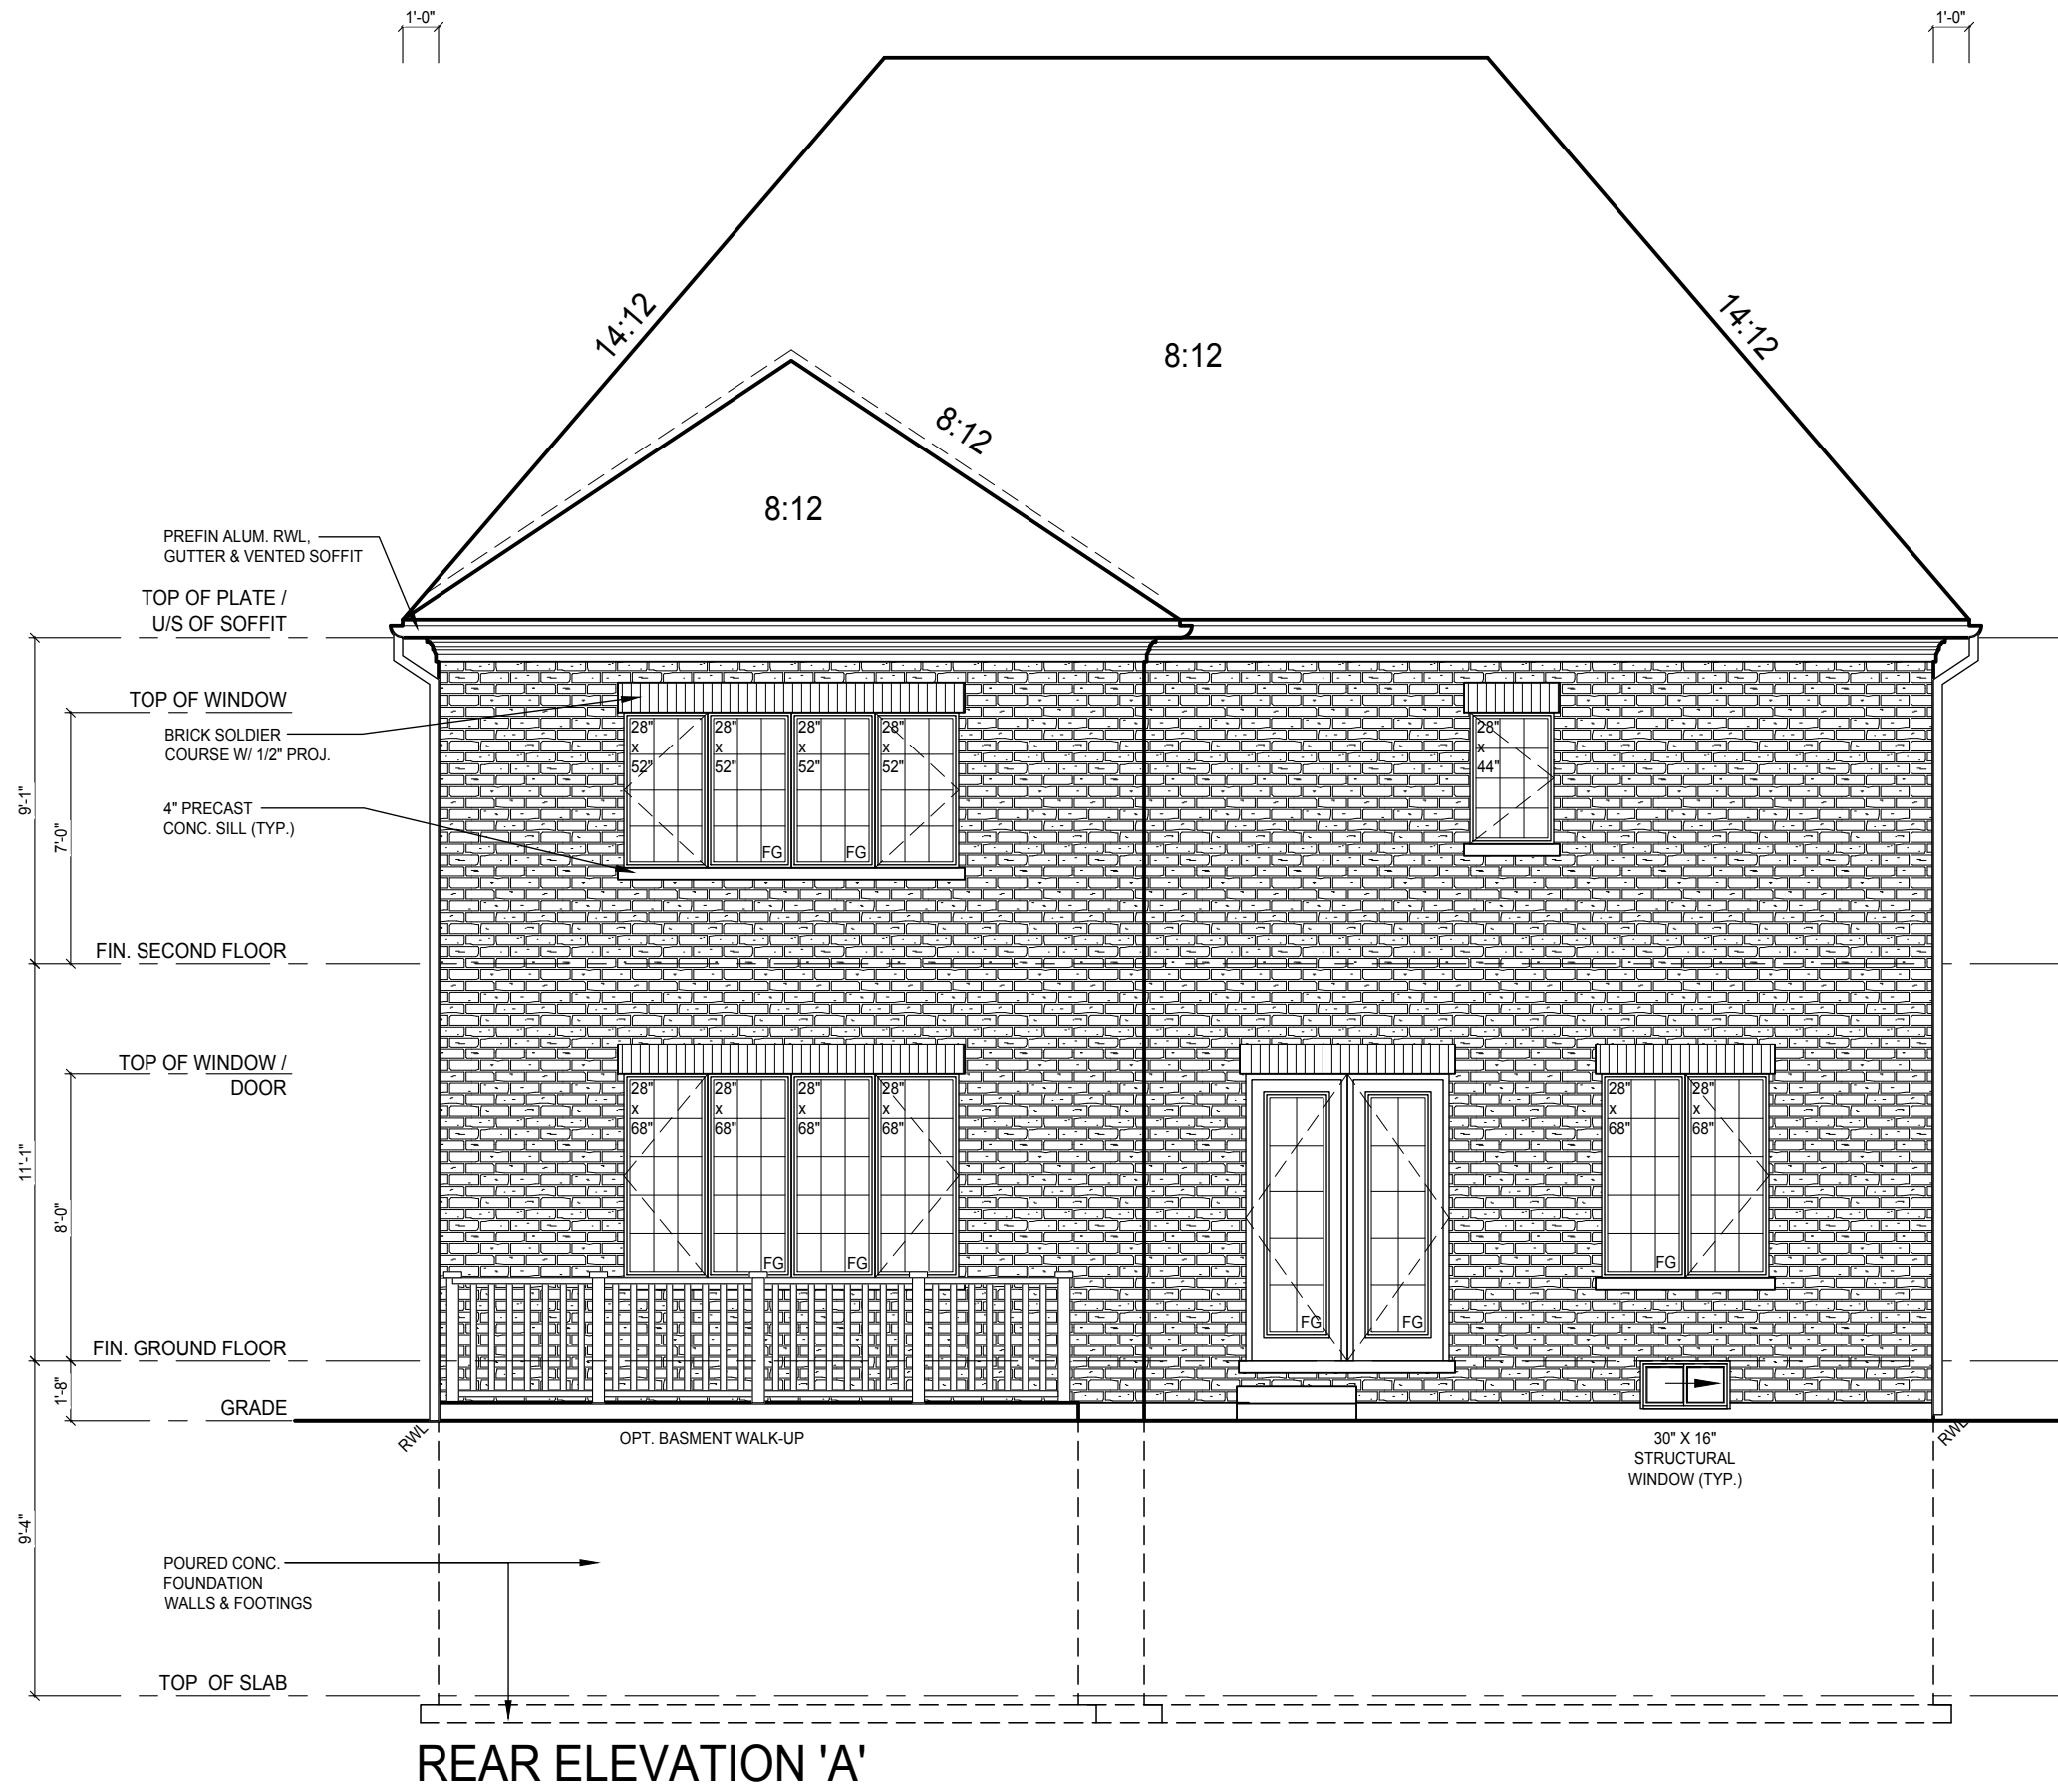

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CONCORD, ONTARIO
L4K 3N3
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QUALIFICATION NUMBER: 27816
IAN ROBERTSON
REGISTRATION NUMBER: 32072
ONE RISER DESIGNS INC.

CLIENT:
GREENYORK HOMES


Project:
DEGREY DR,
CITY OF BRAMPTON

Model:
YORK 2 EL.A

Sheet Title:
REAR ELEVATION 'A'

Drawn by: MT
Checked by: MS
Project No: 17-08
Scale: 3/16"=1'0"
Page: 8 OF 9

REVISIONS			
#	Description	Date	By:
1	ISSUED FOR PRICING	APR. 5/17	MS
2	ISSUED FOR PERMIT & CONSTRUCTION	MAY. 29/17	MS

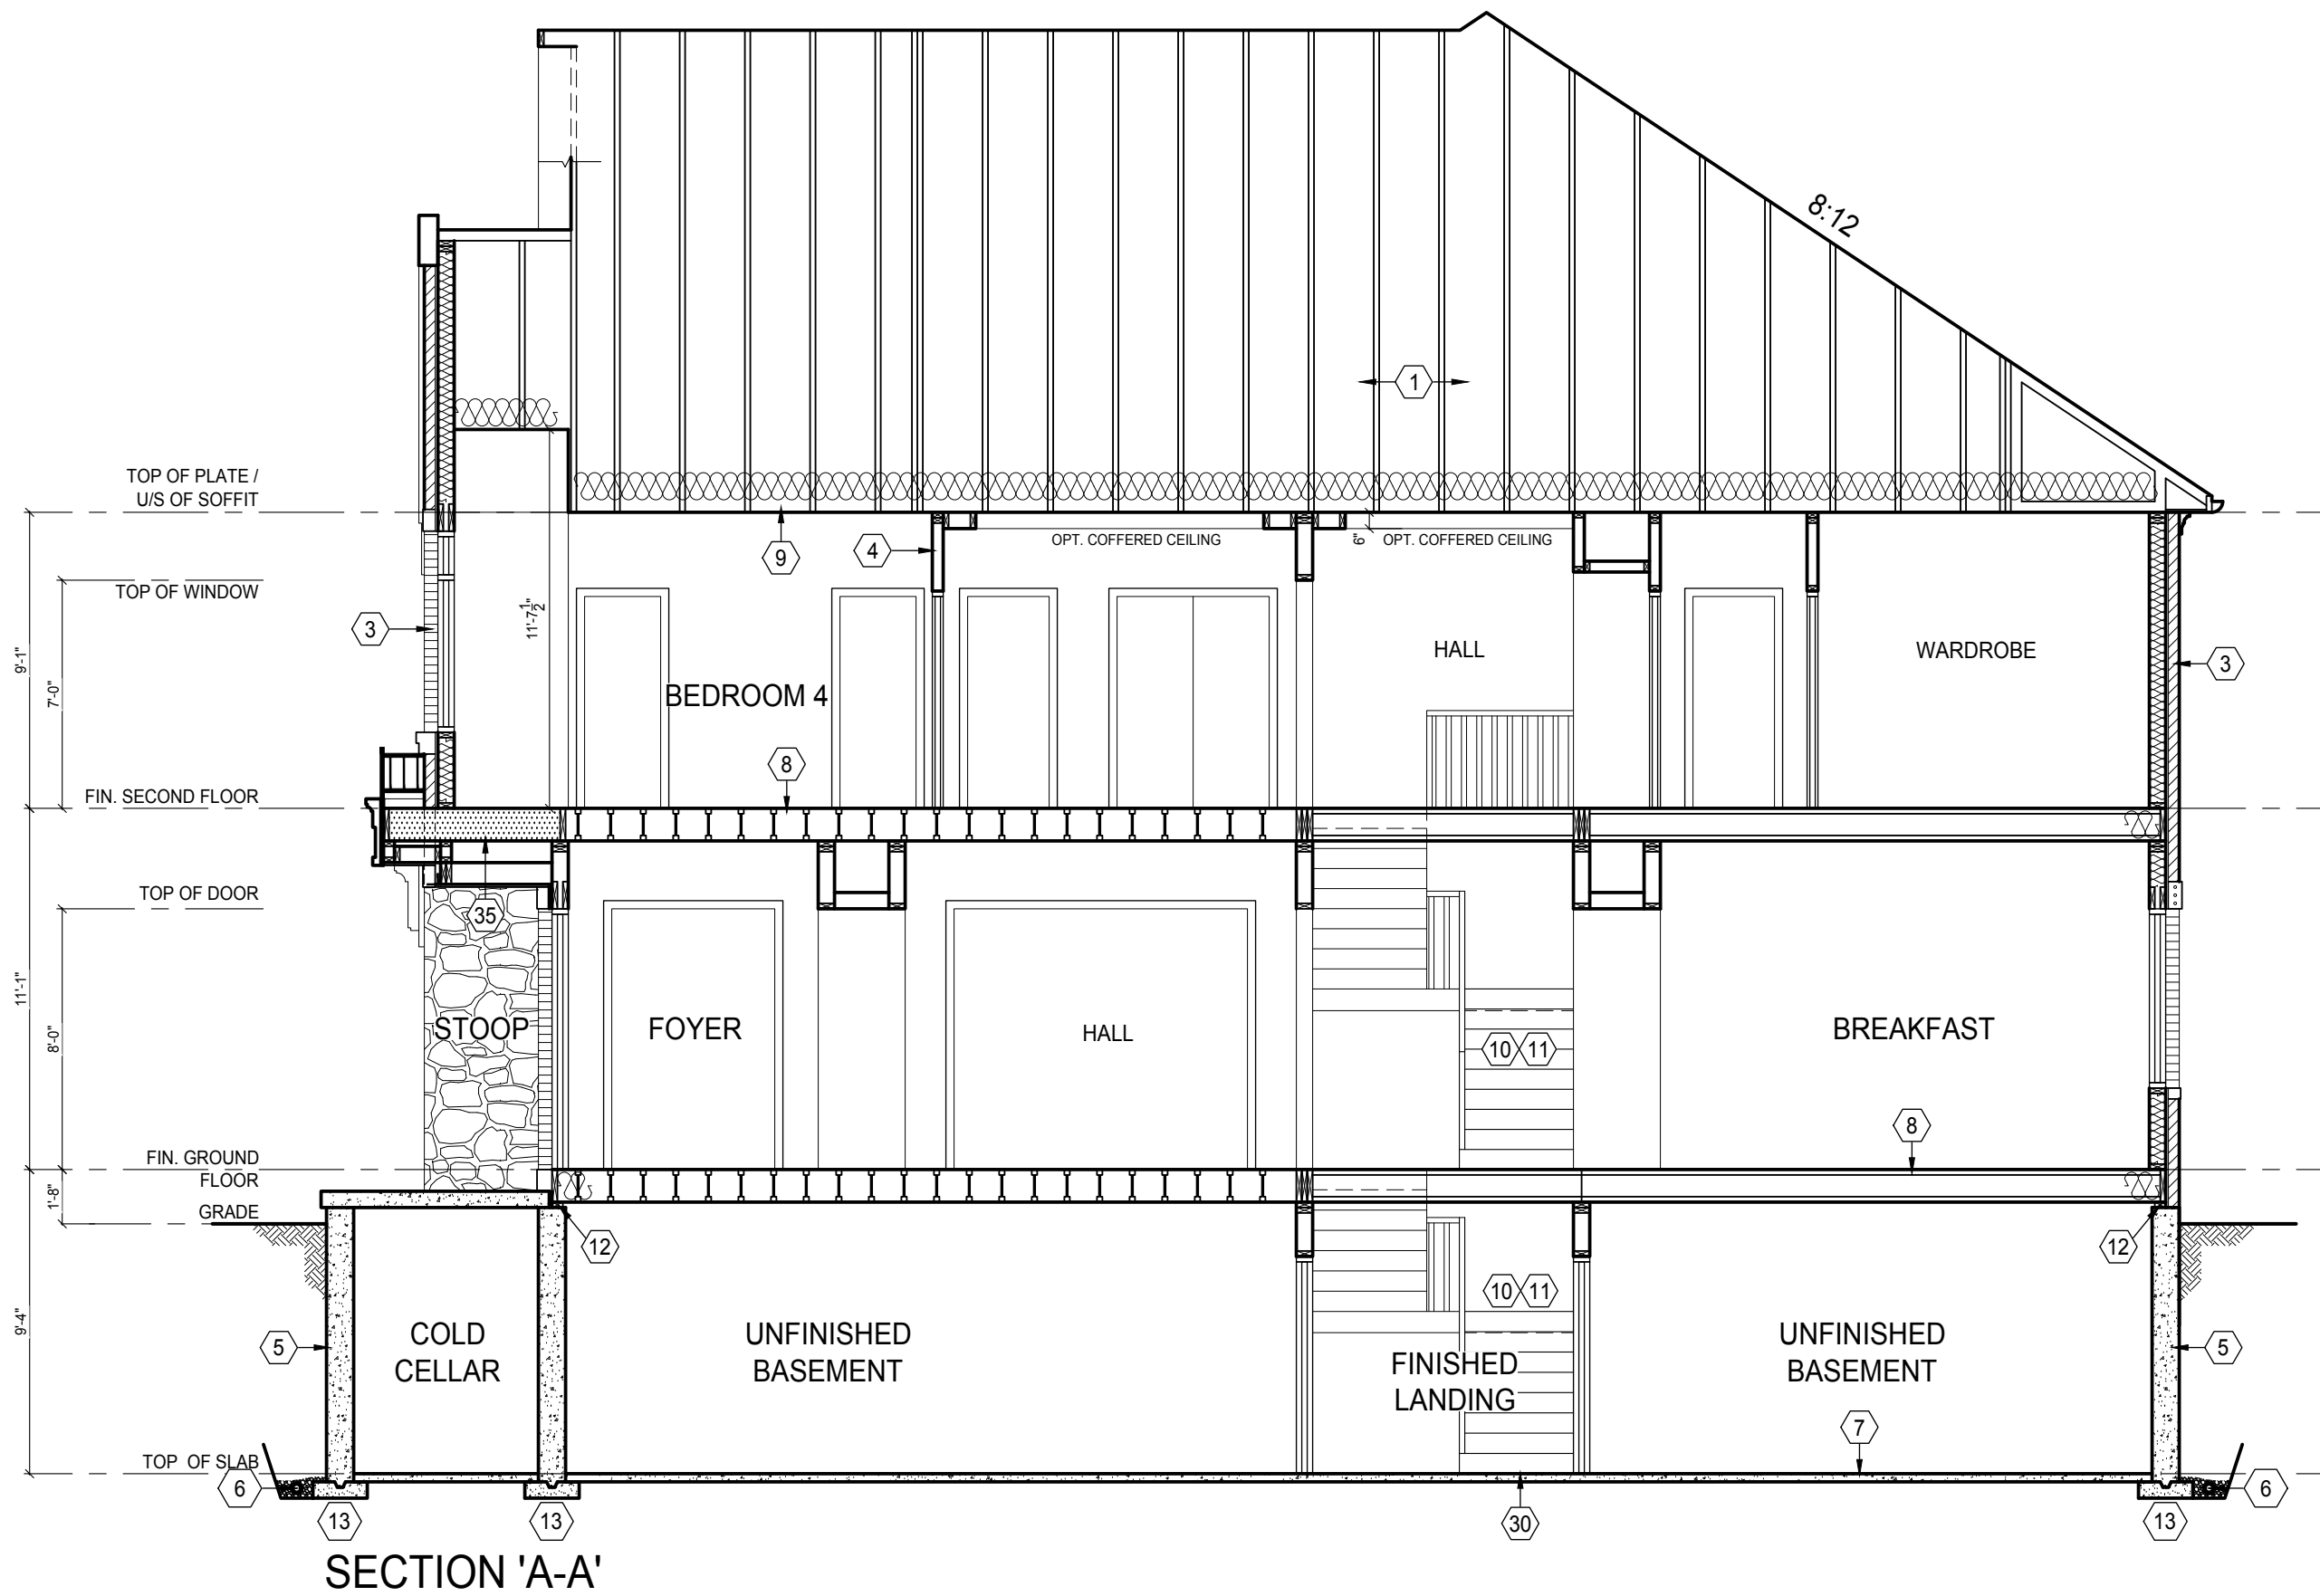

SECTION 'A-A'

It is the builder's complete responsibility to ensure that all plans submitted for approval fully comply with the Architectural Guidelines and all applicable regulations and requirements including zoning provisions and any provisions in the subdivision agreement. The Control Architect is not responsible in any way for examining or approving site (lotting) plans or working drawings with respect to any zoning or building code or permit matter or that any house can be properly built or located on its lot.

This is to certify that these plans comply with the applicable Architectural Design Guidelines approved by the City of BRAMPTON.



REVISIONS			Date		By	
#	Description					
1	ISSUED FOR PRICING		APR. 5/17		MS	
2	ISSUED FOR PERMIT & CONSTRUCTION		MAY. 29/17		MS	

ONE RISER
DESIGNS
20 RIVERMEDE ROAD, UNIT 101
CONCORD, ONTARIO
L4K 3N3
PHONE: (905) 669-2111
FAX: 1 (866) 602-1163
www.oneriser.ca

The undersigned has reviewed and takes responsibility for this design, and has the qualifications and meets the requirements set out in the Ontario Building Code to design the work shown on these plans.

QUALIFICATION NUMBER: 27816
IAN ROBERTSON
REGISTRATION EXPIRATION: 32072
ONE RISER DESIGNS INC.

CLIENT:
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Page:
9 OF 9

Scale:
3/16"=1'0"

Sheet Title:
SECTION 'A-A' & DETAILS
ELEVATION 'A'