

## **GENERAL NOTES:**

#### **FOOTING**

24"X8" POURED CONC. FOOTING. ALL FOOTINGS SHALL REST ON NATURAL UNDISTURBED SOIL OR COMPACTED GRANULAR FILL.

#### **CONCRETE**

MINIMUM COMPRESSIVE STRENGTH OF 32 MPa (4650 psi) @ 28 DAYS W/ 5% TO 8% AIR ENTRAINMENT.

#### **EXTERIOR STAIRS**

- 7 7/8" RISE MAXIMUM
- 8 1/4" RUN MINIMUM
- 9 1/4" TREAD MINIMUM

#### INSULATION

FOR INSULATION VALUE & VAPOUR BARRIER LOCATION REFER TO NOTE 13 OF STANDARD NOTES.

#### **RETAINING WALL**

10" POURED CONCRETE W/ NO REINFORCING REQUIRED FOR WALL HEIGHTS TO A MAX. OF 4'-7". PROVIDE 15M VERTICAL REINFORCEMENT @ 16" O.C. AND 15M HORIZONTAL REINFORCEMENT @ 24" O.C. FOR WALL HEIGHTS TO 7'-0". RETAINING WALL TO RESIST LATERAL DESIGN LOADS AS PER OBC DIVISION B SECTION 4.1.5.16. **GUARDS** 

3'-6" HIGH WHERE DISTANCE FROM GRADE TO BOTTOM OF WALKOUT EXCEEDS 5'-11": 2'-11" FOR LESSER HEIGHTS. MAXIMUM 4" BETWEEN VERTICAL PICKETS.

#### **BRICK VENEER LINTELS:**

 $WL1 = 3.1\2'' \times 3.1\2'' \times 1\4'' (90x90x6) + 2-2'' \times 8'' SPF$ WL2 = 4" x 3 1\2" x 5\16" (100x90x8) + 2-2" x 8" SPR.  $WL3 = 5" \times 3 1 \times " \times 5 \times " (125 \times 90 \times 8) + 2 - 2" \times 10" SPR.$  $WL4 = 6" \times 3 \ 1\ 2" \times 3\ 8" \ (150 \times 90 \times 10) + 2 - 2" \times 12" \ SPR.$  $WL5 = 6" \times 4" \times 3\8" (150 \times 100 \times 10) + 2 - 2" \times 12" SPR$  $WI 6 = 5" \times 3 \times 1/2" \times 5/16" (125 \times 90 \times 8) + 2 - 2" \times 12" SPR$ WL7 = 5" x 3 1\2" x 5\16" (125x90x8) + 3-2" x 10" SPR  $WL8 = 5" \times 3 \ 1\ 2" \times 5\ 16" \ (125 \times 90 \times 8) + 3 - 2" \times 12" \ SPR.$ 

 $WL9 = 6" \times 4" \times 3 \times (150 \times 100 \times 10) + 3 - 2" \times 12" SPR.$ 

#### WOOD LINTELS:

WB1 = 2-2" x 8" SPRUCE BEAM WB6 = 3-2" x 12" SPRLICE REAM WB2 = 3-2" x 8" SPRUCE BEAM WB7 = 5-2" x 12" SPRUCE BEAM WB3 = 2-2" x 10" SPRUCE BEAM WB10 = 4-2" x 8" SPRUCE BEAM WB4 = 3-2" x 10" SPRUCE BEAM WB11 = 4- 2" x 10" SPRUCE BEAM WB5 =  $2-2" \times 12"$  SPRUCE BEAM

#### **STEEL LINTELS:**

 $L1 = 3 \, 1 \setminus 2 \times 3 \, 1 \setminus 2 \times 1 \setminus 4^{\text{"}} \, (90 \times 90 \times 6)$ L4 = 6" x 3 1\2" x 3\8" (150 x 90 x 10) L2 = 4" x 3 1\2" x 5\16" (100 x 90 x 8) L5 = 6" x 4" x 3\8" (150 x 100 x 10) L3 = 5" x 3 1\2" x 5\16" (125 x 90 x 8) L6 = 7" x 4" x 3\8" (180 x 100 x 10)

#### LAMINATED VENEER LUMBER (LVL BEAMS)

LVL1A = 1-1 3/4" x 7 1/4" (1-45x184) IVI1 = 2-1 3/4" x 7 1/4" (2-45x184 3-1 3/4" x 7 1/4" (3-45x184) 4-1 3/4" x 7 1/4" (4-45x184  $LVL4A = 1-13/4" \times 91/2" (1-45x240)$ 2-1 3/4" x 9 1/2" (2-45x240 IVI5 =3-1 3/4" x 9 1/2" (3-45x240) 4-1 3/4" x 9 1/2" (4-45x240) I VI 6A= 1-1 3/4" x 11 7/8" (1-45x300 2-1 3/4" x 11 7/8" (2-45x300) LVL6 3-1 3/4" x 11 7/8" (3-45x300) LVL7A= 4-1 3/4" x 11 7/8" (4-45x300) LVL8 = 2-1 3/4" x 14" (2-45x356)

#### DOOR SHEDULE

1 = 2'-10" x 6'-8" INSULATED ENTRANCE DOOR 1A = 2'-8" x 6'-8" INSULATED ENTRANCE DOOR  $2 = 2'-8" \times 6'-8"$  EXTERIOR GLAZED DOOR  $3 = 2'-8'' \times 6'-8'' \text{ SI AB DOOR } (1.3/4'' \text{ EXTERIOR})$ 4 = 2'-8" x 6'-8" SLAB DOOR (1 3/8" INTERIOR)

 $5 = 2'-6" \times 6'-8"$  SLAB DOOR (1 3/8" INTERIOR

 $6 = 2'-2" \times 6'-8"$  SLAB DOOR (1 3/8" INTERIOR = 1'-6" x 6'-8" SLAB DOOR (1 3/8" INTERIOR

 $8 = 2'-6'' \times 6'-8'' BI-FOLD (1.3/8'' INTERIOR)$ = 3'-0" x 6'-8" BI-FOLD (1 3/8" INTERIOR)

10= 2- 2'-0" x 6'-8" BI-FOLD (1 3/8" INTERIOR) 11 = 2-2'-6" x 6'-8" BI-FOLD (1.3/8" INTERIOR)

12 = 2'-6" x 6'-8" FRENCH DOOR (1 3/8" INTERIOR)

#### STRIP FOOTINGS FOR SINGLES AND SEMIS UP TO 2 STOREY

8" OR 10" FOUNDATION WALLS WITH 2"x8" / 2"x10" FLOOR JOISTS

20"x6" CONCRETE STRIP FOOTINGS BELOW FOUNDATION WALLS. 24"x8" CONCRETE STRIP FOOTINGS BELOW PARTY WALLS

ASSUME THE LARGER FOOTINGS SIZE WHEN TWO CONDITIONS APPLY

ASSUMED 120 KPa (18 p.s.i.) SOIL BEARING CAPACITY OR 90 KPa

FOR ENGINEERED FILL IS USED, TO BE VERIFIED ON SITE.

FOUNDATION WALLS WITH ENGINEERING JOISTS OVER 16'-0" SPAN 24"x8" CONCRETE STRIP FOOTINGS BELOW FOUNDATION WALLS

#### **ENGINEERED FILL FOOTINGS**

24"x8" CONCRETE STRIP FOOTINGS WITH REINFORCING

BELOW EXTERIOR WALLS.

30"x8" CONCRETE STRIP FOOTINGS WITH REINFORCING BELOW PARTY WALLS. (REFER TO ENG. FILL FOOTING DETAIL

#### **PAD FOOTING**

F20+KPa NATIVE SOIL 90 KPa ENGINEERED FILL SOIL  $\overline{F2} = 42'' \times 42'' \times 18''$  CONCRETE PAD  $F1 = 48'' \times 48'' \times 20''$  CONCRETE PAD

 $\label{eq:f3} F3 = {}_{36\text{''}x36\text{''}x16\text{''}} \text{CONCRETE PAD} \quad F2 = {}_{40\text{''}x40\text{''}x16\text{''}} \text{CONCRETE PAD}$  $F4 = \frac{30}{30}$  "x30"x12" CONCRETE PAD  $F3 = \frac{34}{30}$  "x14" CONCRETE PAD  $F5 = {}_{24}$ "x24"x12" CONCRETE PAD F4 = 28"x28"x12" CONCRETE PAD

16"x16"x8" CONCRETE PAD F5 = 18"x18"x8" CONCRETE PAD (REFER TO FLOOR PLAN FOR UNUSUAL SIZE PADS NOT ON CHART)

#### NOTE:

WHEN VENEER CUT IS GREATER THAN 26" A 10" POURED CONC. FOUNDATION WALL IS REQUIRED.

#### NOTE:

ALL GARAGE SLABS, PORCH SLABS, STAIRS (EXPOSED CONC. FLAT WORK) TO BE 32 MPa WITH 5-8% AIR ENTRAITMENT.

#### NOTE:

SPACE CONVENTIONAL FLOOR JOISTS @ 12" O.C. BELOW ALL CERAMIC TILE AREAS. PROVIDE 1 ROW BRIDGING FOR SPANS OF 5'-7', 2 ROWS FOR SPANS GREATER THAN 7'

### NOTE:

THESE DRAWINGS ARE TO BE READ IN CONJUNCTION WITH ENGINEER APPROVED ROOF TRUSS DRAWINGS BY MANUFACTURER

#### NOTE:

THESE DRAWINGS ARE TO BE READ IN CONJUNCTION WITH ENGINEER APPROVED FLOOR TRUSS LAYOUT BY MANUFACTURER .


#### NOTE:

PLANS NOT DRAWN TO ACTUAL GRADE. REFER TO FINAL GRADING PLAN.

AUBURN 4 ELEV1		ENERGY EFFICIENCY- SB12	
ELEVATION	WALL FT <sup>2</sup>	OPENING FT <sup>2</sup>	PERCENTAGE
FRONT	857.47	132.05	15.40 %
LEFT SIDE	1127.11	69.96	6.21 %
RIGHT SIDE	1128.07	39.99	3.54 %
REAR	896.43	175.74	19.60 %
TOTAL	4009.08	417.74	10.42 %

AREA CALCUL	OITA	NS EL-1
GROUND FLOOR AREA SECOND FLOOR AREA	=	1398 Sq. Ft. 1599 Sq. Ft.
TOTAL FLOOR AREA	=	2997 Sq. Ft.
ADD OPEN AREAS ADD FIN. BASEMENT AREA	= =	73 Sq. Ft. 58 Sq. Ft.
GROSS FLOOR AREA	=	3128 Sq. Ft.
GROUND FLOOR COVERAGE GARAGE COVERAGE / AREA PORCH COVERAGE / AREA	= = =	1398 Sq. Ft. 391 Sq. Ft. 54 Sq. Ft.
COVERAGE W/ PORCH	=	1843 Sq. Ft.
COVERAGE W/O PORCH	= =	171.22 Sq. m. 1789 Sq. Ft. 16620 Sq. m.


2 - 1 1/2" x 5 1/2" TIMBERSTRAND (LSL) 1 5E STLID WALL GLUED AND NAILED TOGETHER AND SPACED MAX. @10"O.C FULL HT C/W SOLID BLOCKING MAX. 8'-0"O.C. VERTICAL AND 7/16" EXT. OSB SHEATHING.

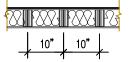

MAXIMUM HEIGHT OF WALL FOR THIS DETAIL IS 201-2" AND MAXIMUM SUPPORTED LENGTH OF TRUSS IS 40'-0'

TWO STORY HEIGHT WALL DETAIL

2 - 1 1/2" x 5 1/2" TIMBERSTRAND (LSL) 1.5E STUD WALL GLUED AND NAILED TOGETHER AND SPACED MAX. @9"O.C FULL HT C/W SOLID BLOCKING MAX. 8'-0"O.C. VERTICAL AND 7/16" EXT\_OSB SHEATHING

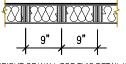

MAXIMUM HEIGHT OF WALL FOR THIS DETAIL IS 21'-5" AND AND MAXIMUM SUPPORTED LENGTH OF TRUSS IS 40'-0"

TWO STORY HEIGHT WALL DETAIL

STRUDET INC.



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#### LEGEND:

BUILDING FACE < THAN 4'-0" (1.2m) (45 MIN. FIRE RATING REQ'D) INDICATES SOLID BEARING REQUIRE

OR POINT LOAD FROM ABOVE

STL. PLATE FOR STEEL COL'N ABOVE 2017 LVL LAMINATED VENEER LUMBER

SINGLE JOIST S.J.

DOUBLE JOIST T.J. TRIPLE JOIST

REPEAT NOTE Ò SHOWER WEEPERS **AUBURN 4 ELEVATION 1** 

3128

O.REG. 332/12

2017-SB-12 COMPLIANCE PACKAGE 'A1'

This is to certify that these plans comply with the applicable Architectural Design Guidelines approved by the City of BRAMPTON.



NSTRUCTED INVERTS MUST BE VERIFIED PRIOR TO POURING

HIS DRAWING IS AN INSTRUMENT OF SERVICE, IS PROVIDED BY AN HE PROPERTY OF JARDIN DESIGN GROUP INC. THIS DRAWING IS N

JULY 18, 2017 REV. AREA: REISSUED FOR PERMIT JUNE 20, 2017 ISSUED FOR BUILDING PERMIT COORDINATED AS PER ENG. ELG 3 JUNE 19, 2017 MAR. 30, 2017 COMPLETED TO PRECOORDINATE STAGE - ISSUED TO CLIENT INTRO. PLAN FROM RIMINI MAR 27 2017 13-11 - AUBURN 4 DATE: WORK DESCRIPTION:

**DESIGN GROUP INC** 

VAUGHAN ONT. L4K 3P3 TEL: 905 660-3377 FAX: 905 660-371 EMAIL: info@jardindesign.ca The undersigned has reviewed and takes responsibilit

64 JARDIN DR. SUITE 3A

for this design and has the qualifications and meets the nts set out in the Ontario Building Code to b a designer OUALIFICATION INFORMATION

Required unle 3.2.5 of the buttings

Walter Botter

NAME

SIGNATURE

NAME REGISTRATION INFORMATION

jardin design group inc. 27763 FIRM NAME


AREA/GENERAL NOTES


**OSTIENSE BRAMPTON** 




3/16"=1'-0"0 17-14

DRAWING NAME: AUBURN 4

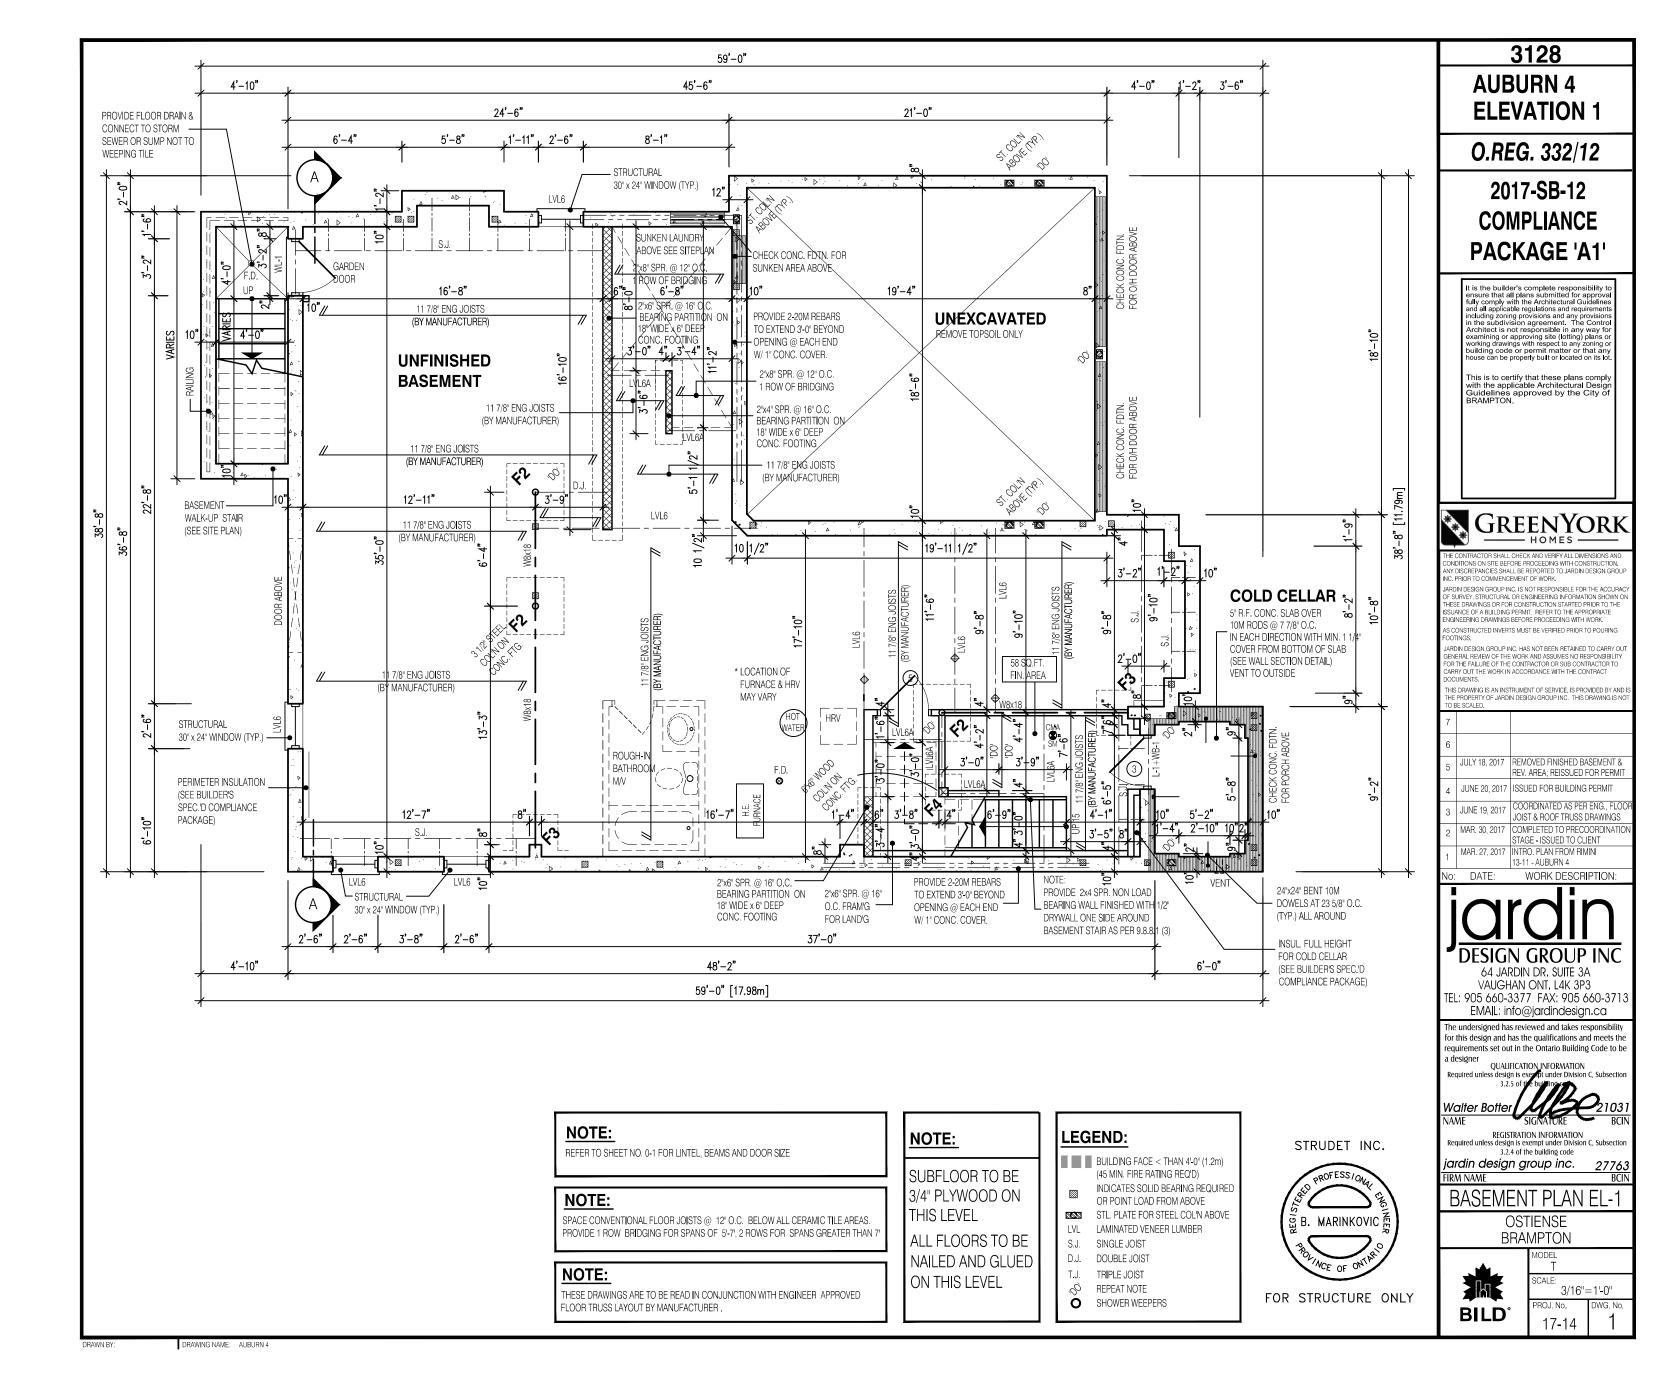

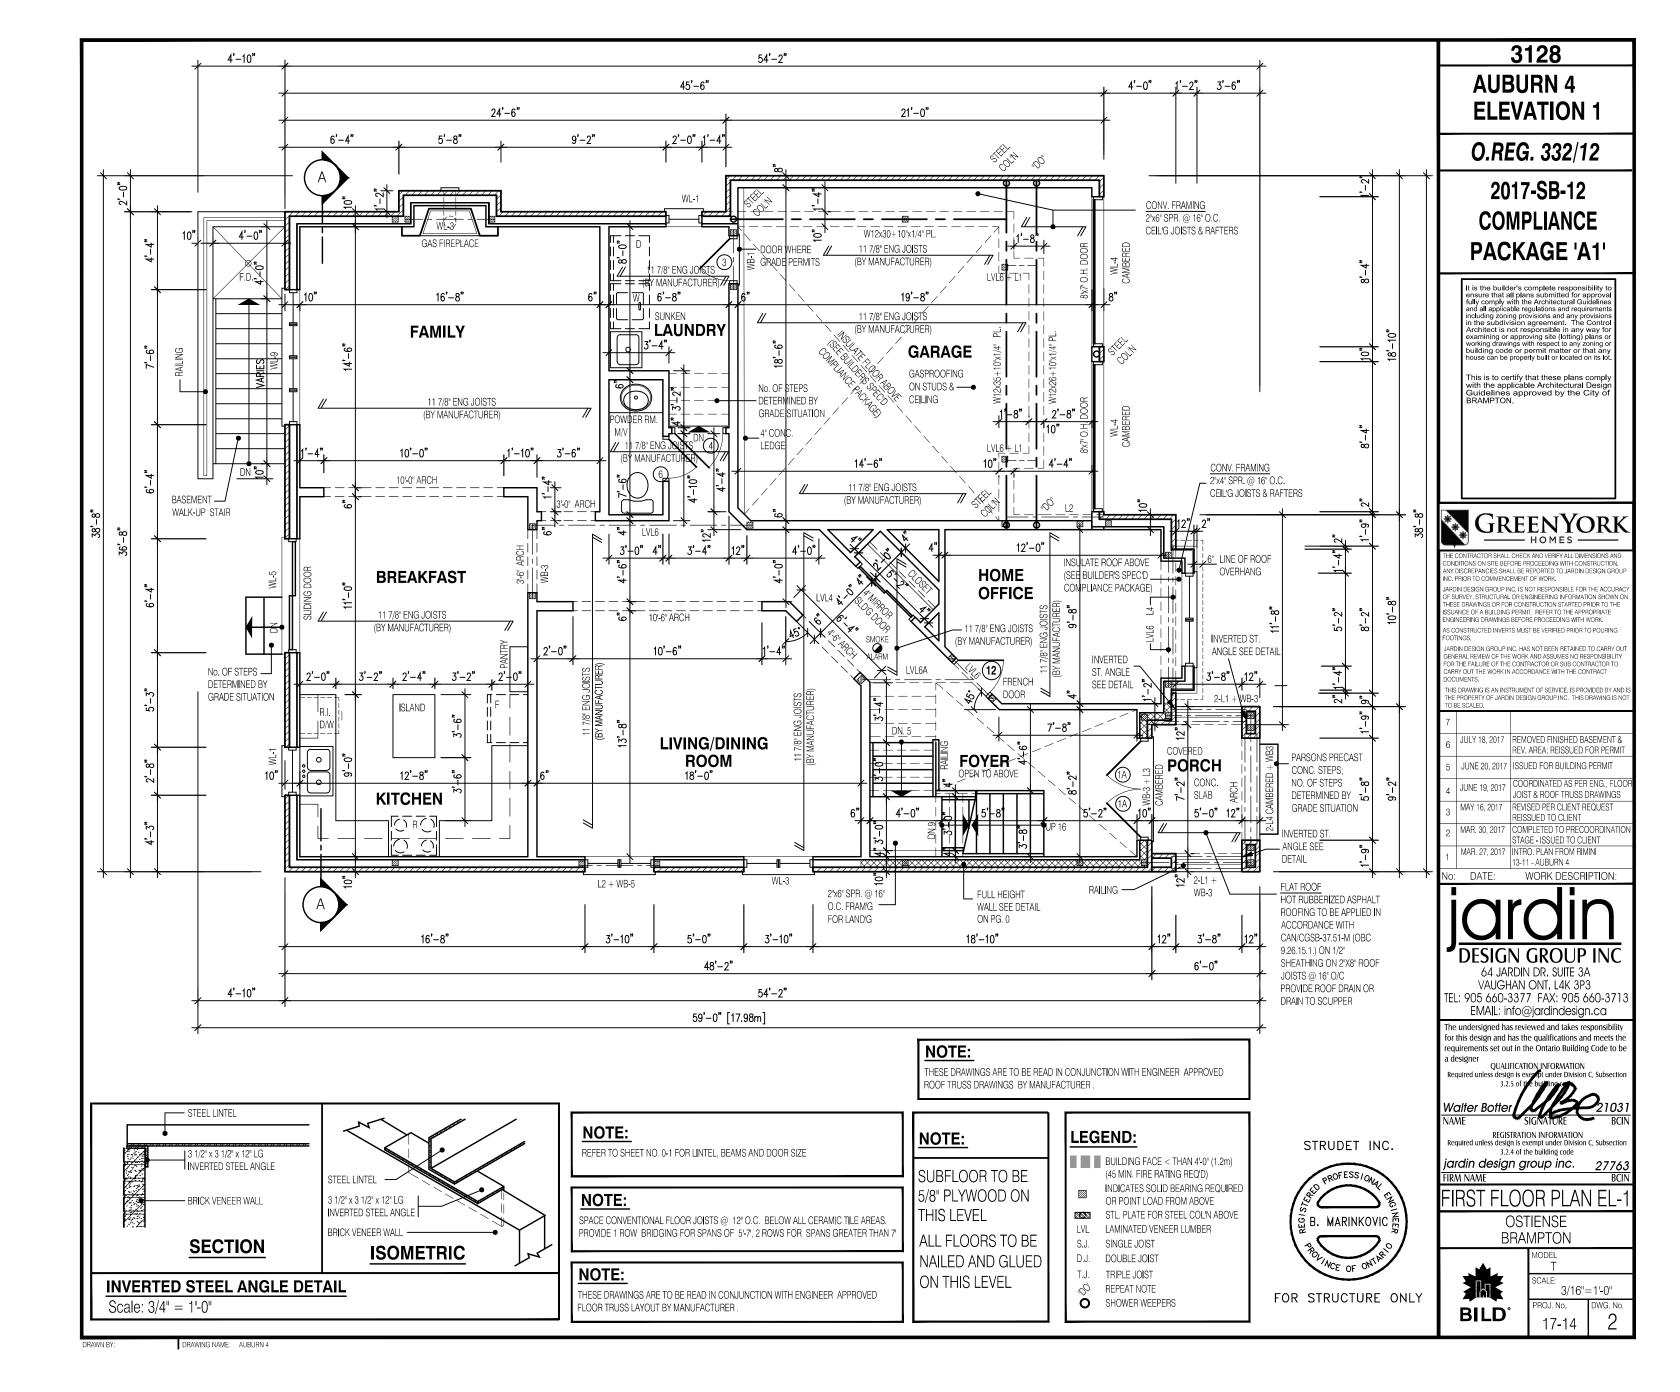

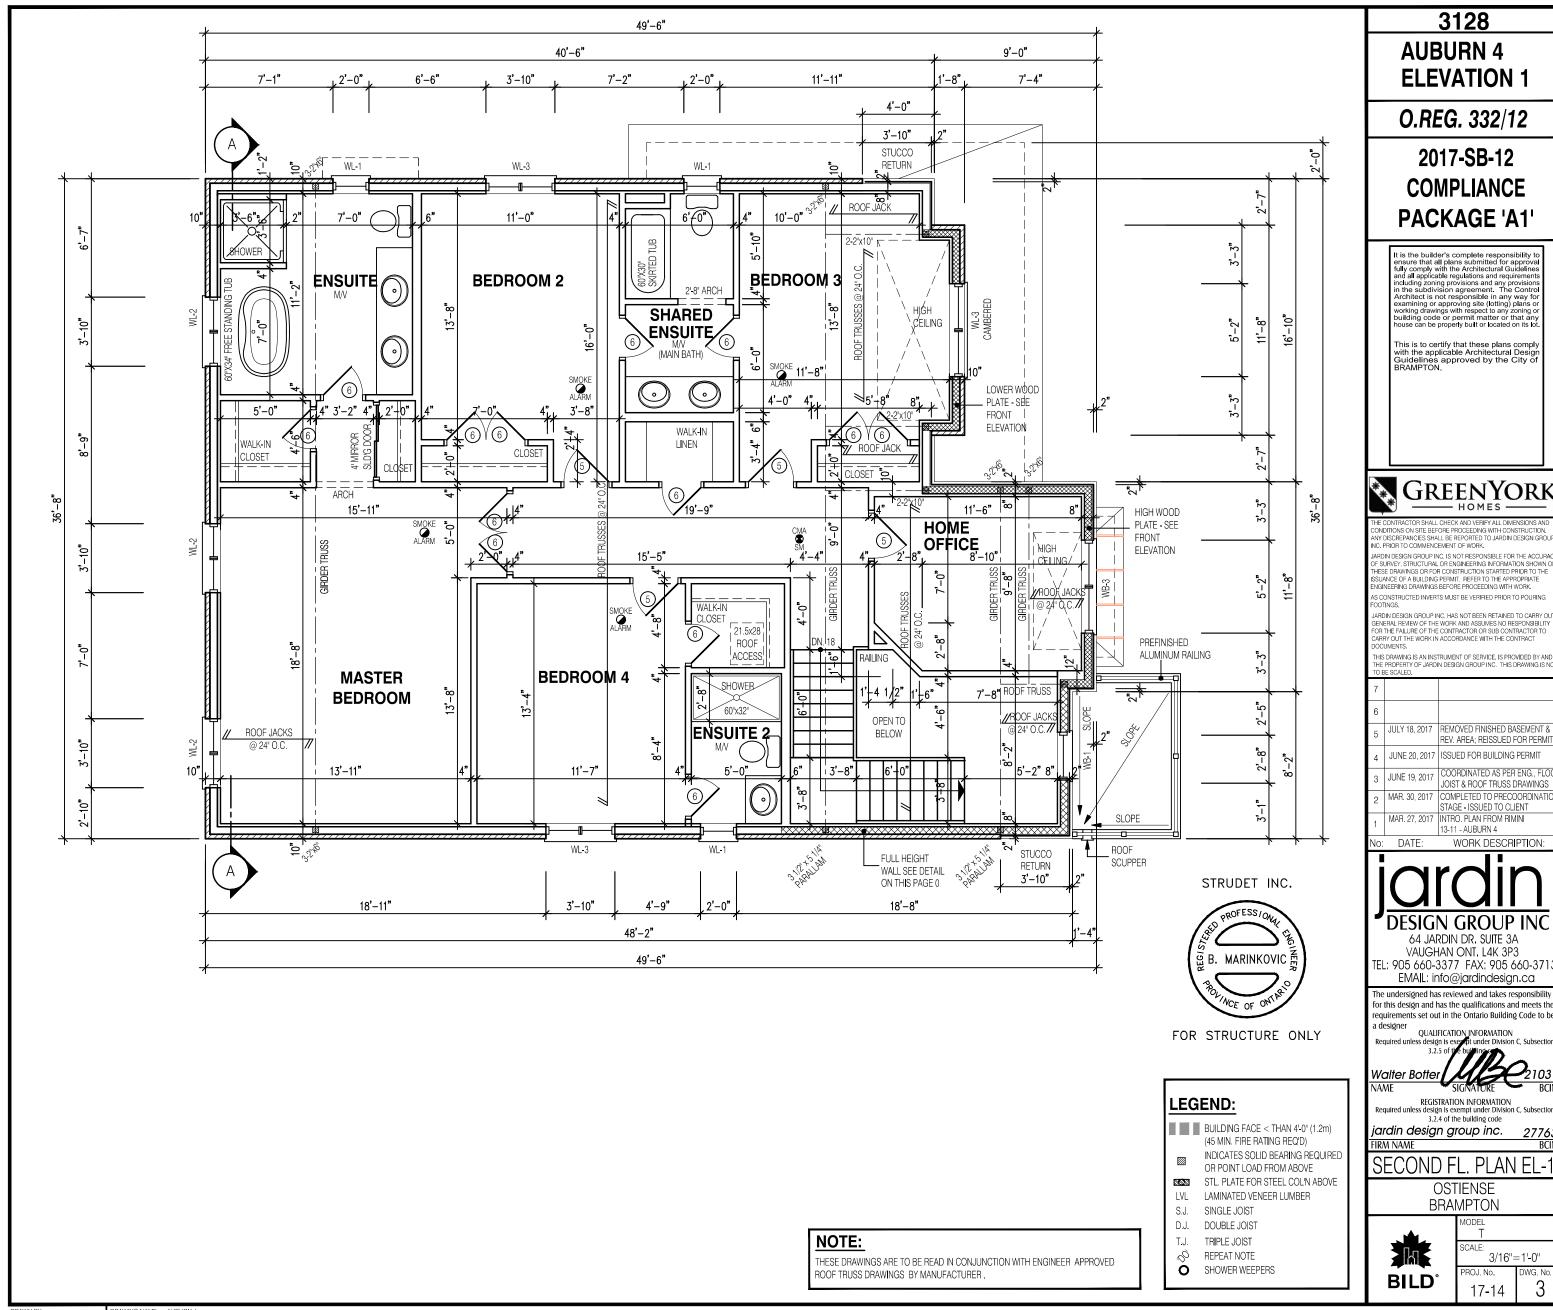


DRAWING NAME: AUBURN 4



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**ROOF PLAN** 

**ELEV-1** 

3128 **AUBURN 4 ELEVATION 1** 
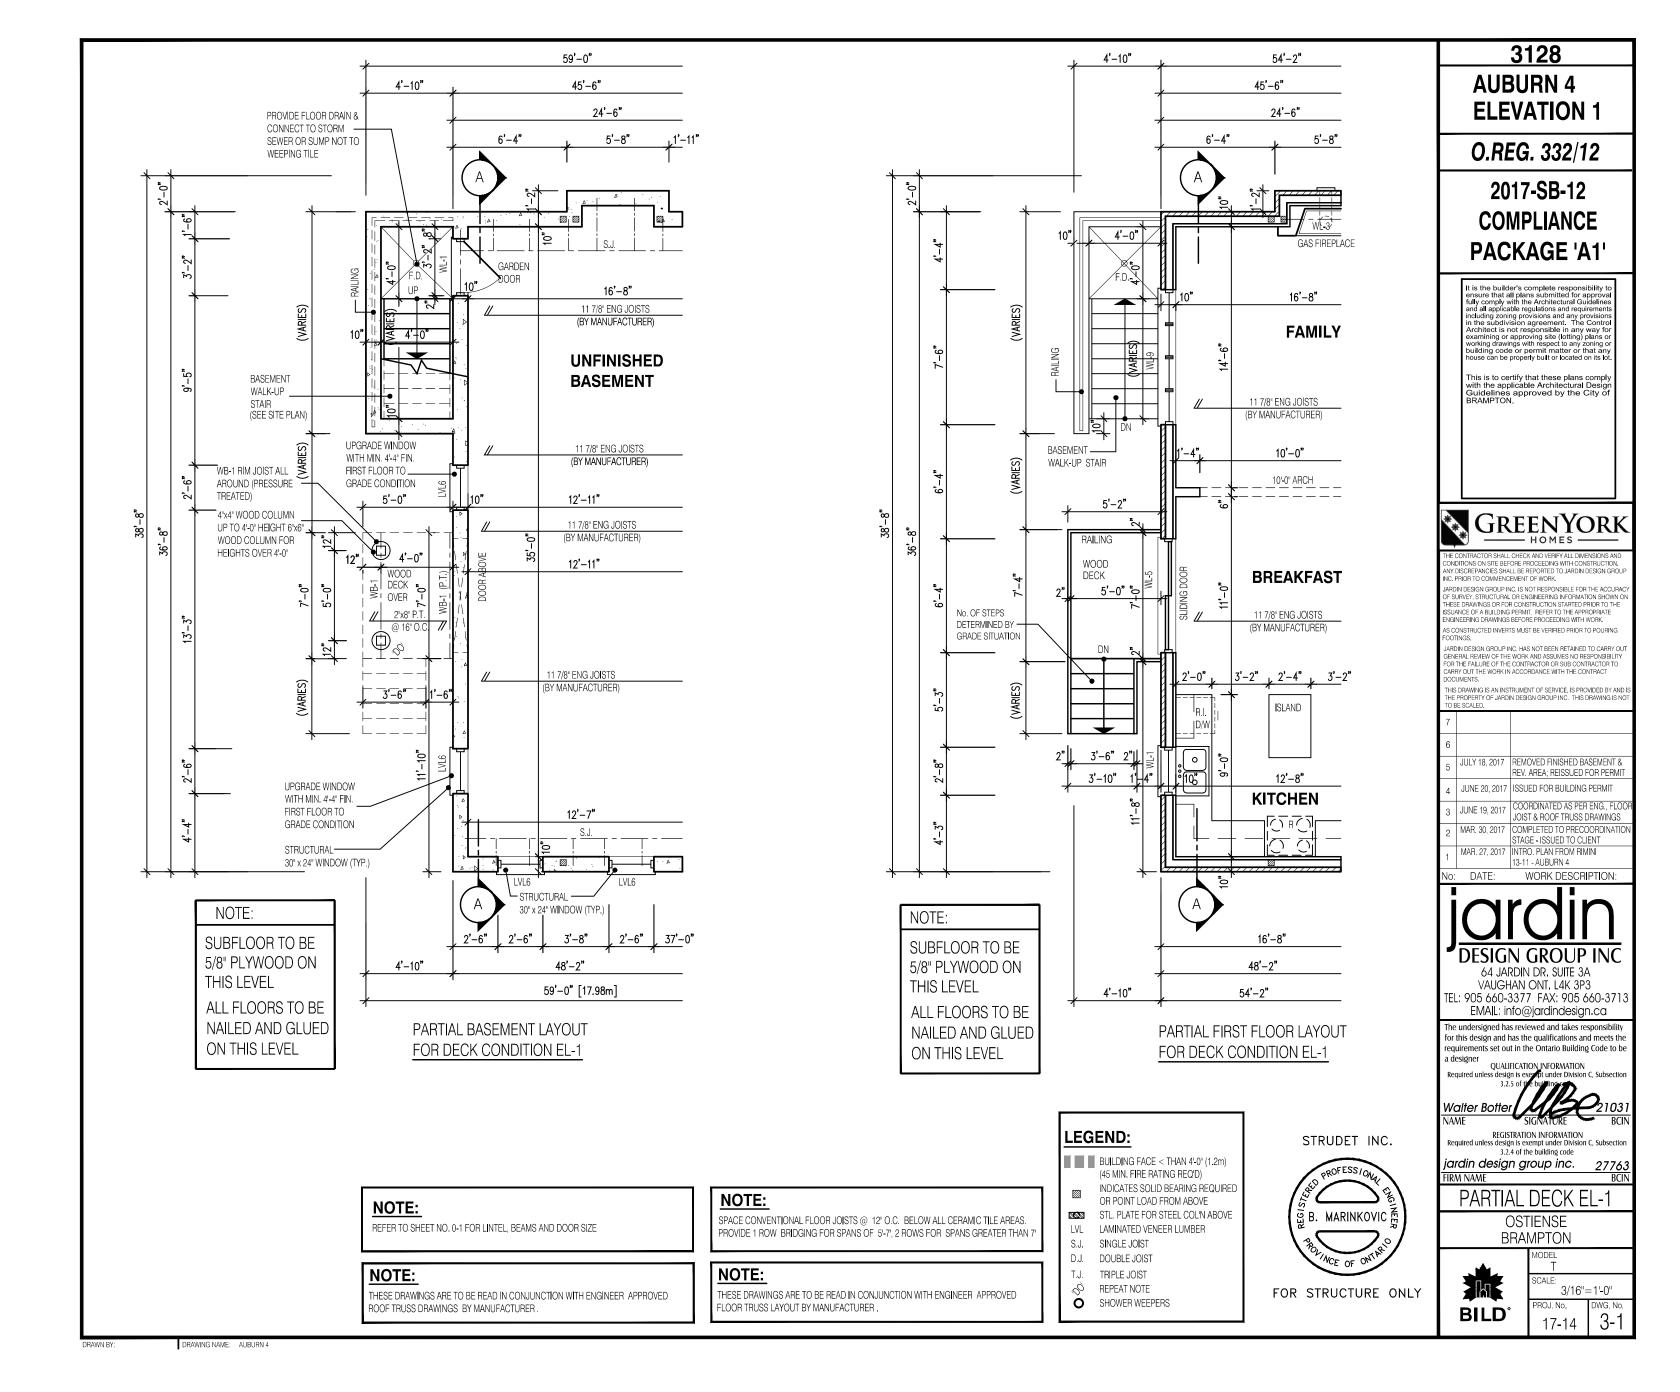
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WORK DESCRIPTION:

# **DESIGN GROUP INC**

64 JARDIN DR. SUITE 3A VAUGHAN ONT. L4K 3P3 TEL: 905 660-3377 FAX: 905 660-371 EMAIL: info@jardindesign.ca

The undersigned has reviewed and takes responsibility for this design and has the qualifications and meets the requirement a designer

OUALIFICATION INFORMATION

Walter Botter SigNature

REGISTRATION INFORMATION Required unless design is exempt under Division C, Subs 3.2.4 of the building code


jardin design group inc. FIRM NAME


FRONT ELEVATION 1

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3/16"=1'-0" 17-14



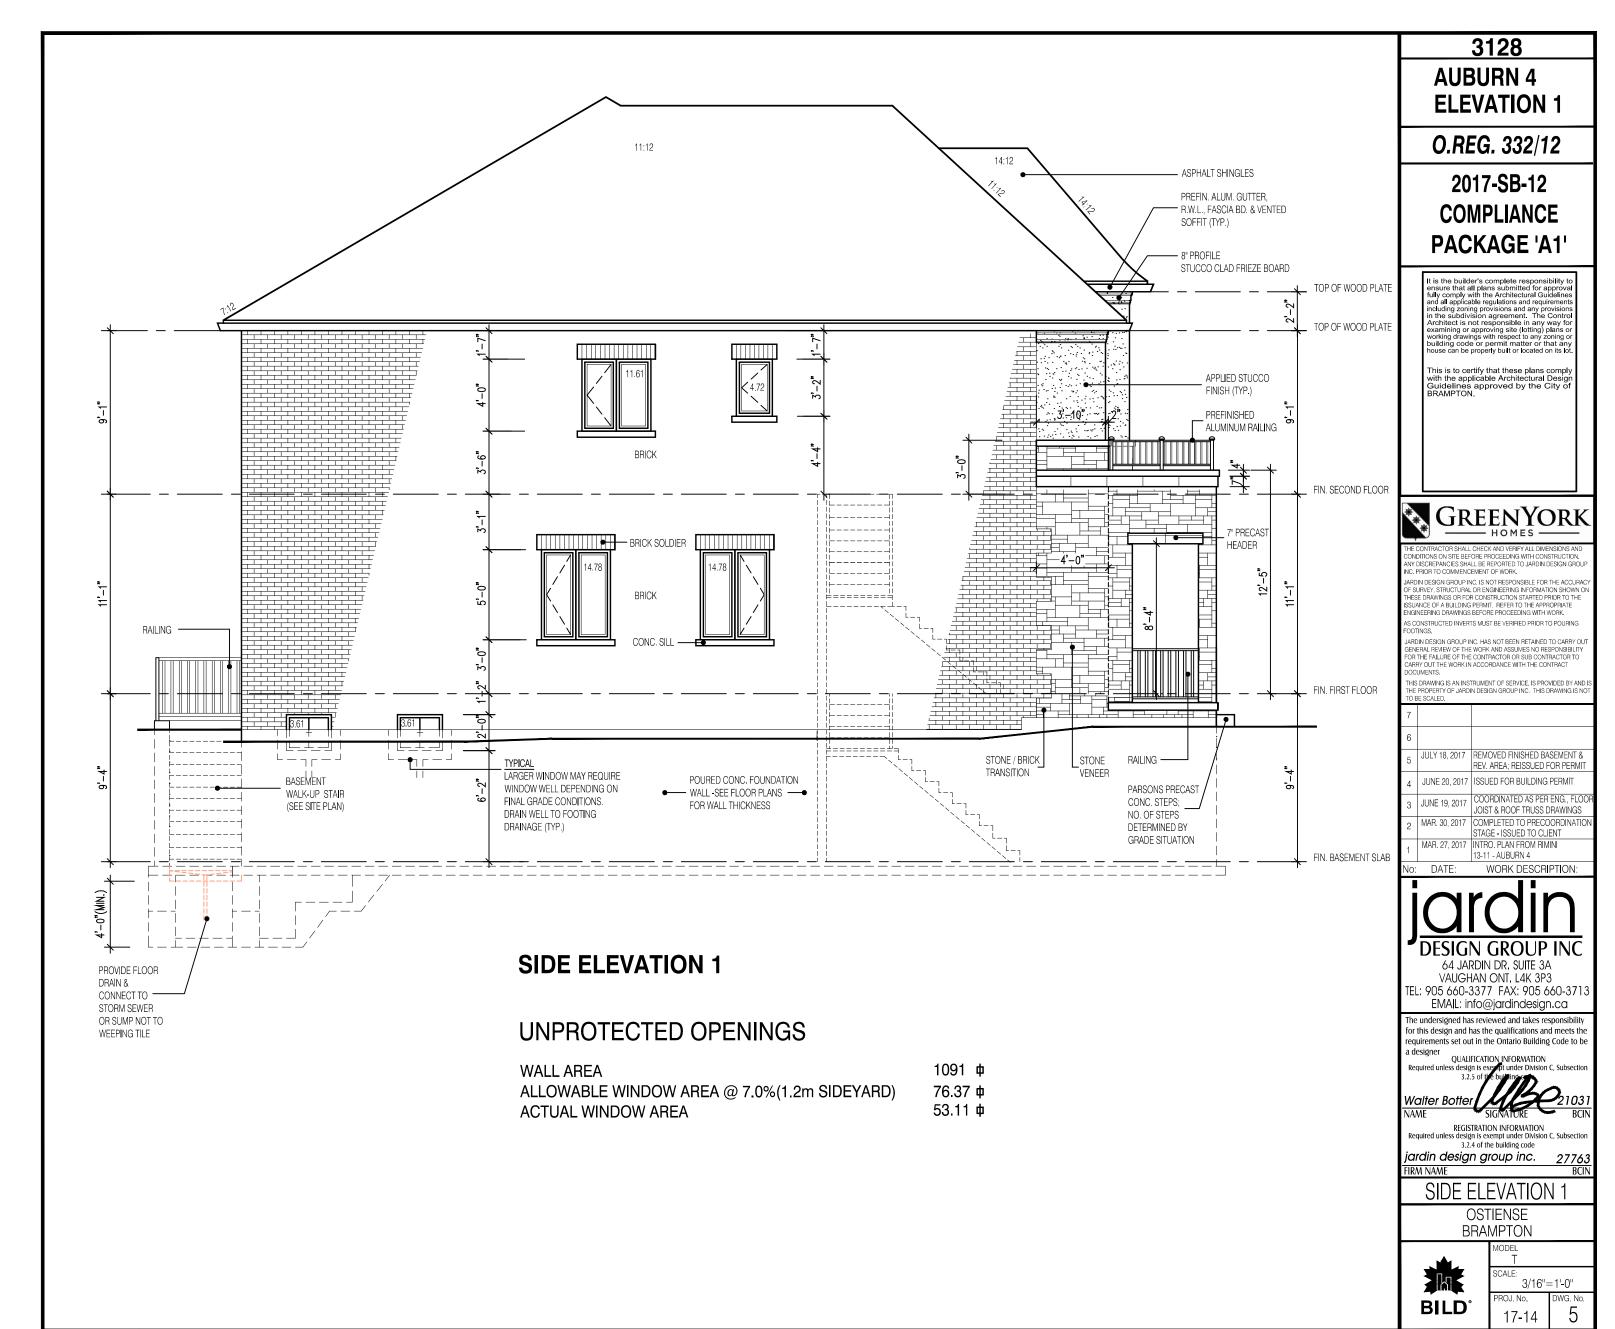

## **REAR ELEVATION 1**

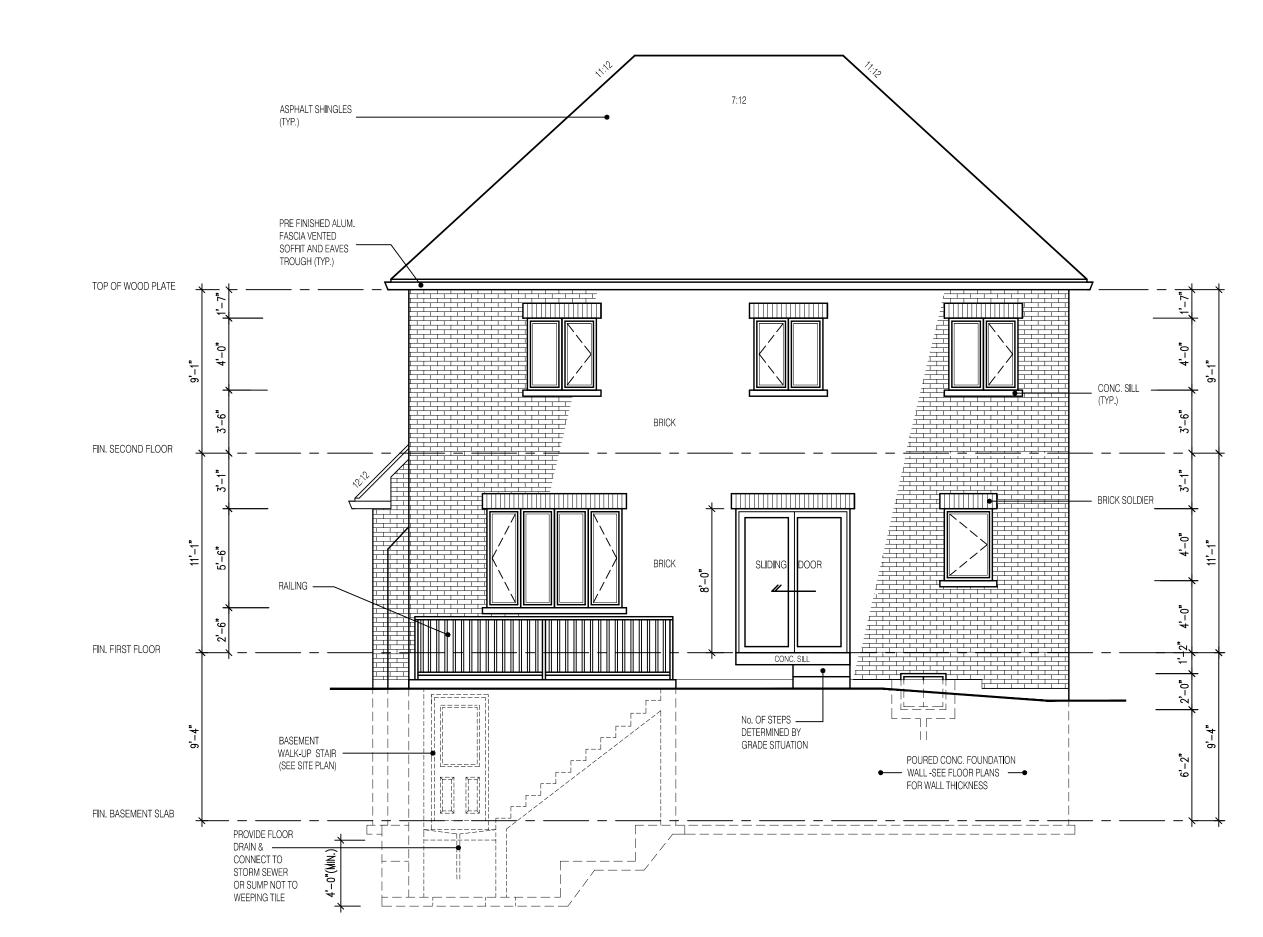3128 AUBURN 4 ELEVATION 1

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2017-SB-12 COMPLIANCE PACKAGE 'A1'

is the builder's complete responsibility to insure that all plans submitted for approva lilly comply with the Architectural Guidelines and all applicable regulations and requirements including zoning provisions and any provisions in the subdivision agreement. The Control Architect is not responsible in any way for xamining or approving site (lotting) plans or vorking drawings with respect to any zoning or uilding code or permit matter or that any ouse can be properly built or located on its lot.

This is to certify that these plans comply with the applicable Architectural Design Guidelines approved by the City of RRAMPTON



CONDITIONS ON SITE BEFORE PROCEEDING WITH CONSTRUCTION, ANY DISCREPANCIES SHALL BE REPORTED TO JARDIN DESIGN GRC INC. PRIOR TO COMMENCEMENT OF WORK.

SURVEY, STRUCTURAL OR ENGINEERING INFORMATION SHOWN O RESE DRAWINGS OR FOR CONSTRUCTION STARTED PRIOR TO THE SUANCE OF A BUILDING PERMIT. REFER TO THE APPROPRIATE IGINEERING DRAWINGS BEFORE PROCEEDING WITH WORK. CONSTRUCTED INVERTS MUST BE VERIFIED PRIOR TO POURING

FOOTINGS,

JARDIN DESIGN GROUP INC. HAS NOT BEEN RETAINED TO CARRY O
GENERAL REVIEW OF THE WORK AND ASSUMES NO RESPONSIBILITY
FOR THE FAILURE OF THE CONTRACTOR OR SUB CONTRACTOR TO

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No: DATE: WORK DESCRIPTION:

# Jarain DESIGN GROUP INC

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The undersigned has reviewed and takes responsibility for this design and has the qualifications and meets the requirements set out in the Ontario Building Code to be a designer

QUALIFICATION\_INFORMATION

QUALIFICATION INFORMATION quired unless design is exempt under Division C, Subsection 3.2.5 of the building C

Walter Botter Signature B

REGISTRATION INFORMATION Required unless design is exempt under Division C, Subsect 3.2.4 of the building code


jardin design group inc.
FIRM NAME

REAR ELEVATION 1

OSTIENSE BRAMPTON



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SCALE:
3/16"=1'-0"
PROJ. No. DWG. No.
17-14

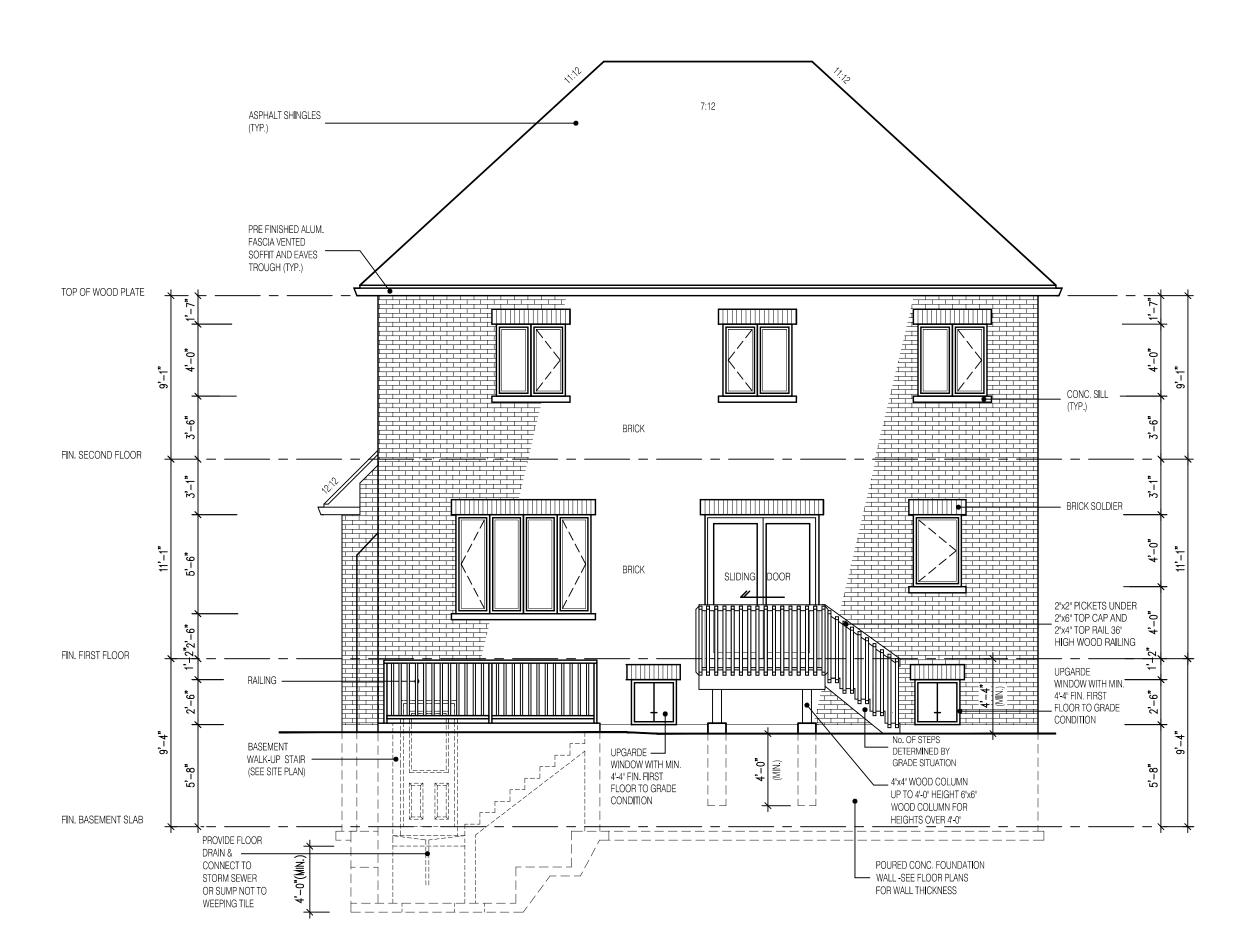

# **REAR ELEVATION 1 DECK CONDITION**

#### NOTE:

WHEN VENEER CUT IS GREATER THAN 26" A 10" POURED CONC. FOUNDATION WALL IS REQUIRED. (FOUNDATION PLAN TO BE REVIEWED IN CONJUNCTION WITH SITE PLAN)

3128 **AUBURN 4 ELEVATION 1** 

O.REG. 332/12

2017-SB-12 **COMPLIANCE** PACKAGE 'A1'



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Walter Botter

NAME REGISTRATION INFORMATION Required unless design is exempt under Division C, Subsect 3.2.4 of the building code

jardin design group inc.

a designer

FIRM NAME


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BRAMPTON

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**BILD** 

3/16"=1'-0" 17-14



**ELEVATION 1** 

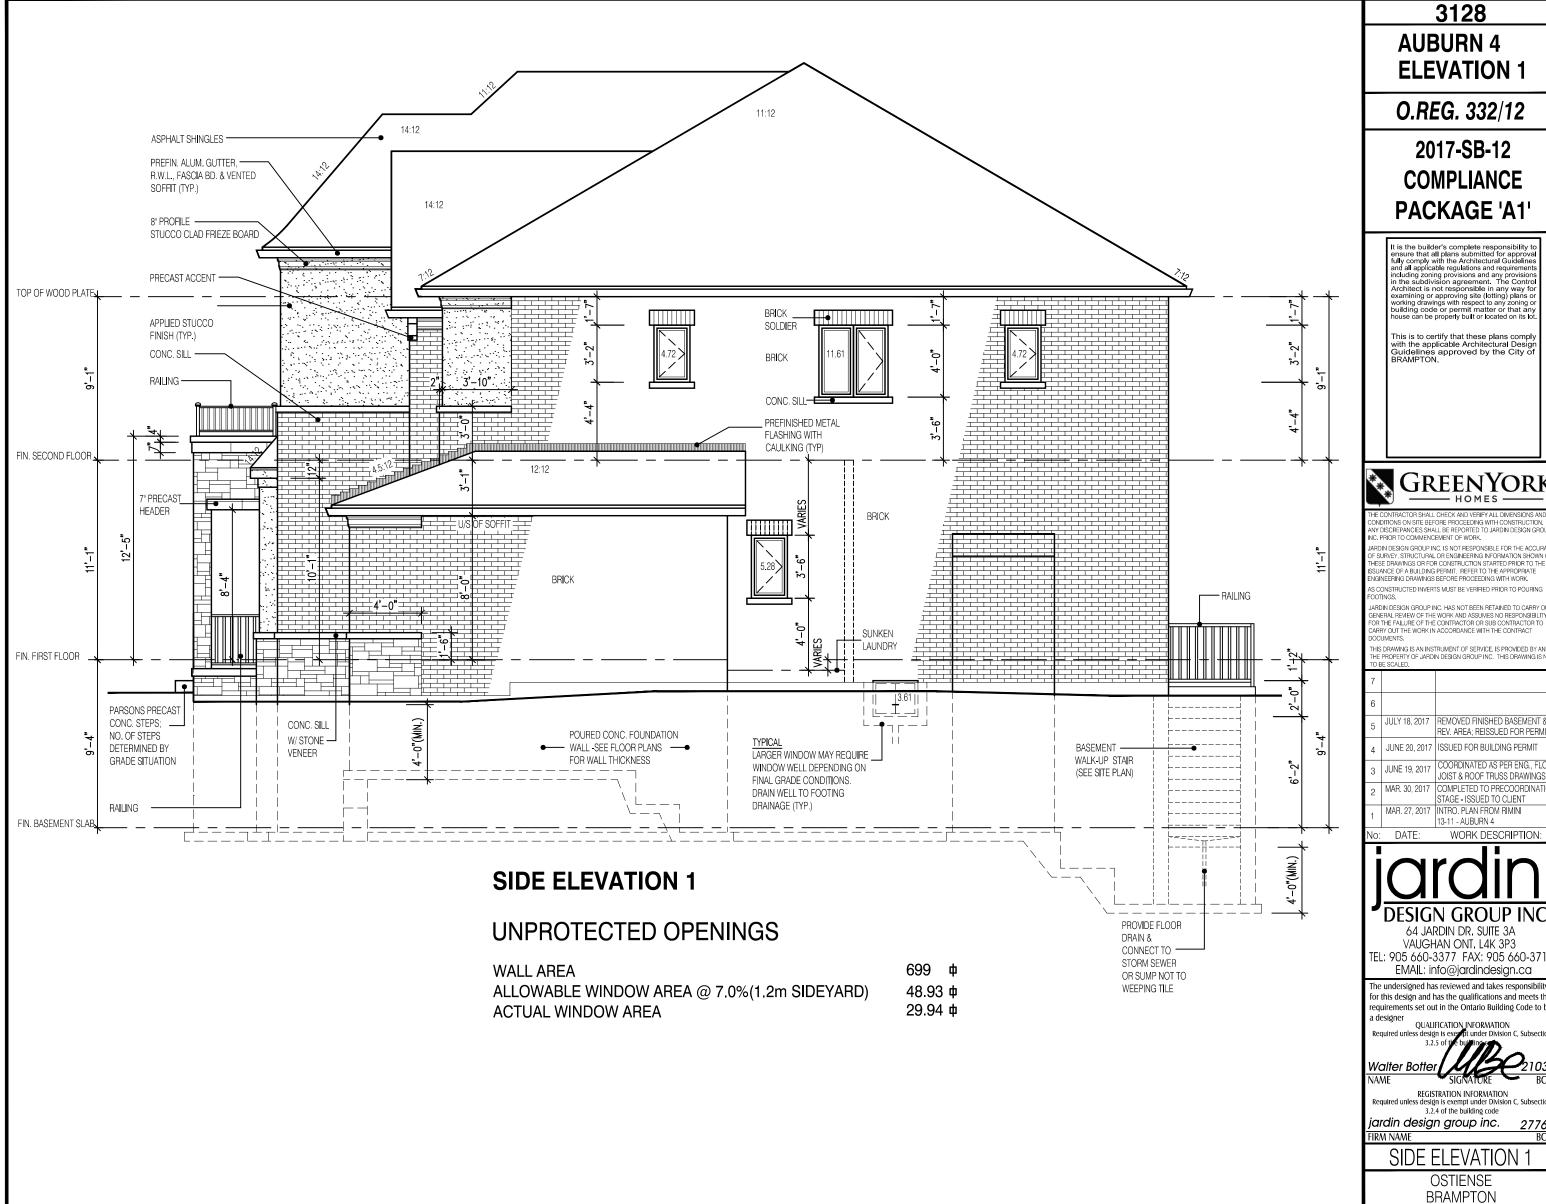**COMPLIANCE** PACKAGE 'A1'



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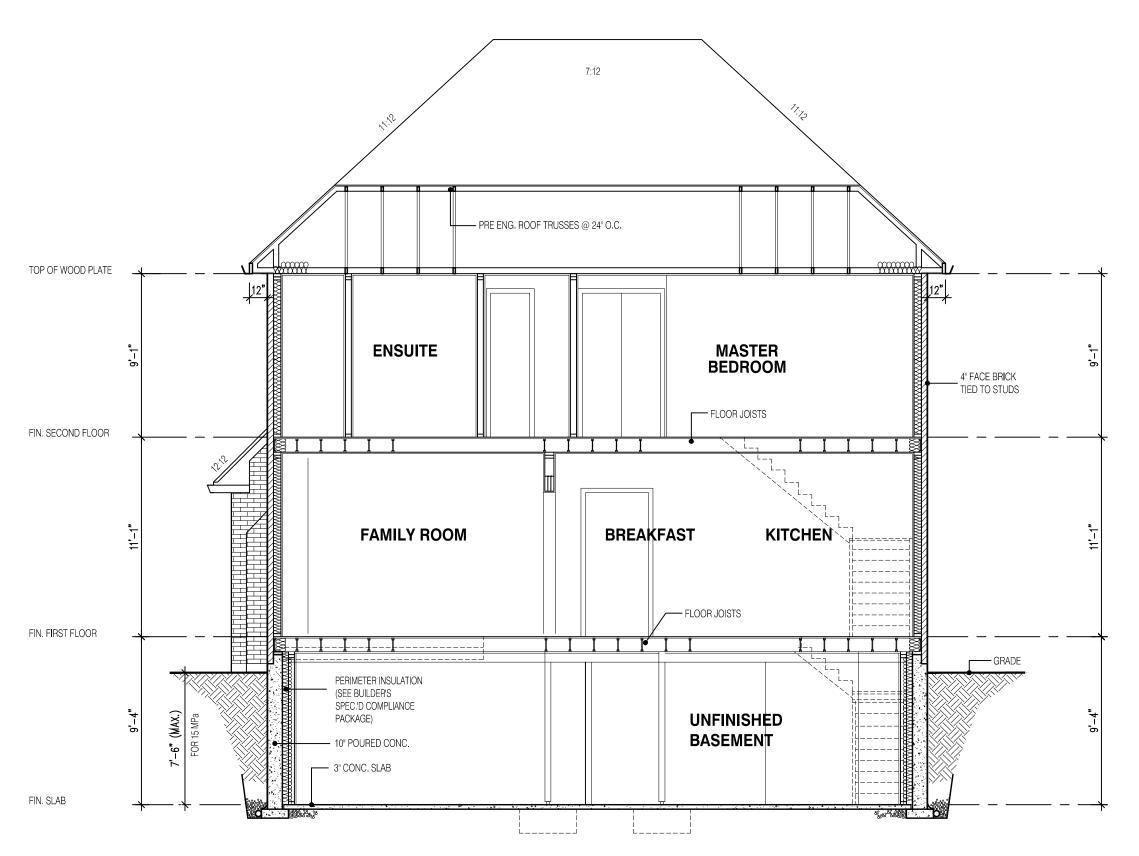
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TEL: 905 660-3377 FAX: 905 660-371



3/16"=1'-0"

17-14



**SECTION A-A ELEVATION 1** 

STRUDET INC.



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# 3128 **AUBURN 4 ELEVATION 1**

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WORK DESCRIPTION:

No: DATE:

**DESIGN GROUP INC** 64 JARDIN DR. SUITE 3A VAUGHAN ONT. L4K 3P3

TEL: 905 660-3377 FAX: 905 660-3713 EMAIL: info@jardindesign.ca

The undersigned has reviewed and takes responsibility for this design and has the qualifications and meets the requirements set out in the Ontario Building Code to be a designer

QUALIFICATION\_INFORMATION

Walter Botter SIGNATURE

REGISTRATION INFORMATION Required unless design is exempt under Division C, Subsecti 3.2.4 of the building code 27763

jardin design group inc. FIRM NAME

SECTION EL-1

OSTIENSE BRAMPTON



3/16"=1'-0" 8 17-14