
AMELIA 3 (MODEL 2970 S.F.)



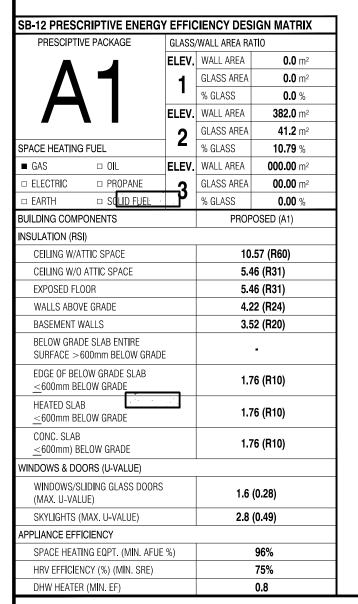

FRONT ELEVATION 2 LOT-14

AREA CALCULATION	ONS	- EL. 2
TOTAL GROUND FLOOR AREA	=	1323 SQ. FT.
TOTAL SECOND FLOOR AREA	=	1677 SQ. FT.
TOTAL GROSS FLOOR AREA	=	3000 SQ. FT.
		278.71 m ²
SUBTRACT OPEN AREAS	=	30 sq. ft.
		2.79 m ²
TOTAL NET FLOOR AREA	=	2970 SQ. FT.
		275.92 m ²

W Architect Inc. **DESIGN CONTROL REVIEW** FEB. 04, 2019

FINAL BY: MMI

This stamp is only for the purposes of design

TYPICAL BASEMENT FLOOR PLAN NOTES

ALL CONCRETE FOOTINGS SHALL REST ON UNDISTURBED SOIL WITH A MIN. ALLOWABLE BEARING CAPACITY OF 75Kpa (1500 PSF), AND BE FOUNDED A MIN. OF 4'-0" BELOW FINISHED GRADE.

CONCRETE STRENGTH FOR WALLS AND FOOTINGS SHALL BE A MINIMUM OF 15Mpa.

CONCRETE STRENGTH FOR GARAGE SLABS, CONC. PORCHES, AND STEPS SHALL BE A MINIMUM OF 32Mpa. WITH 5-8% AIR ENTRAINMENT.

CONCRETE STRIP FOOTING SIZE FOR 8" POURED CONC. WALLS SHALL BE A MINIMUM OF 6"x20" UNREINFORCED.

THE ABOVE FOOTING SIZE WILL BE USED FOR FOUNDATION WALLS WHICH SUPPORT 2 STOREYS OF BRICK VENEER WALL CONSTRUCTION, 2 FLOORS AND A ROOF OF LIGHT WOOD FRAME CONSTRUCTION, WITH THE SPAN OF SUPPORTED JOISTS THAT DO NOT EXCEED 4.9m (16'-1") AT A SPECIFIED LIVE LOAD OF NOT GREATER THAN 2.4 Kpa (50 PSF)

REFER TO BASEMENT PLAN FOR FOOTING SIZES IN AREAS EXCEEDING THE ABOVE

3/4" SUB-FLOOR TO BE GLUED & NAILED (TYP.)

REFER TO APPROVED FLOOR JOIST LAYOUT DRAWINGS, DETAILS AND SPECIFICATIONS FOR ALL FLOOR FRAMING AND DETAILS.

ALL JOISTS UNDER CERAMIC TILES TO BE INSTALLED AS PER JOIST MANUF, SHOP DWG'S

CONC. PAD FOOTING LEGEND (75 KPa)

(UNLESS OTHERWISE SPECIFIED)

F1 = 42"x42"x18" CONCRETE PAD F2 = 36"x36"x16" CONCRETE PAD

F3 = 34"x34"x14" CONCRETE PAD F4 = 30"x30"x12" CONCRETE PAD

F5 = 24"x24"x12" CONCRETE PAD F6 = 18"x18"x10" CONCRETE PAD F7 = 16"x16"x8" CONCRETE PAD

BRICK VENEER LINTELS:

 $WL1 = 3 1\2" \times 3 1\2" \times 1\4" (90x90x6) + 2 - 2" \times 8" SPR. No. 2$ WL2 = 4" x 3 1\2" x 5\16" (100x90x8) + 2- 2" x 8" SPR. No. 2 WL3 = 5" x 3 1\2" x 5\16" (125x90x8) + 2- 2" x 10" SPR. No. 2 $WL4 = 6" \times 3 \ 1\ 2" \times 3\ 8" \ (150 \times 90 \times 10) + 2 - 2" \times 12" \ SPR. \ No. \ 2$ $WL5 = 6" \times 4" \times 3\8" (150\times100\times10) + 2-2" \times 12" SPR. No. 2$ $WL6 = 5" \times 3 \times 12" \times 5 \times 16" \times 125 \times 90 \times 8) + 2 - 2" \times 12" SPR. No. 2$ WL7 = 5" x 3 1\2" x 5\16" (125x90x8) + 3- 2" x 10" SPR. No. 2 WL8 = $5" \times 3 \times 12" \times 5 \times 16" \times 125 \times 90 \times 8) + 3 - 2" \times 12" \text{SPR. No. 2}$ $WL9 = 6" \times 4" \times 3\8" (150\times100\times10) + 3-2" \times 12" SPR. No. 2$

DOOR SHEDULE:

1 = 2'-10" x 6'-8" (865x2033) INSULATED ENTRANCE DOOR 1A = 2'-8" x 6'-8" (815x2033) INSULATED ENTRANCE DOOR $2 = 2'-8" \times 6'-8" (815 \times 2033)$ EXTERIOR WOOD & GLAZED DOOF 3 = 2'-8" x 6'-8" x 1 3/4" (815x2033x45) EXTERIOR SLAB DOOR 4 = 2'-8" x 6'-8" x 1 3/8" (815x2033x35) INTERIOR SLAB DOOR 5 = 2'-6" x 6'-8" x 1 3/8" (760x2033x35) INTERIOR SLAB DOOR 6 = 2'-2" x 6'-8" x 1 3/8" (660x2033x35) INTERIOR SLAB DOOR 7 = 1'-6" x 6'-8" x 1 3/8" (460x2033x35) INTERIOR SLAB DOOR

WOOD LINTELS:

WB1 = $2 - 2^{\circ} \times 8^{\circ}$ (2-38X184) SPR. No. 2 WB2 = 3-2" x 8" (3-38x184) SPR. No. 2 WB3 = $2 - 2^{\circ} \times 10^{\circ} (2 - 38 \times 235)$ SPR. No. 2 WB4 = 3- 2" x 10" (3-38x235) SPR. No. 2 WB5 = 2-2" x 12" (2-38x286) SPR. No. 2 WB6 = 3-2" x 12" (3-38x286) SPR. No. 2 WB7 = 5-2" x 12" (5-38x286) SPR. No. 2 WB10 = 4-2" x 8" (4-38x184) SPR. No. 2 WB11 = 4-2" x 10" (4-38x235) SPR. No. 2 WB12 = 4-2" x 12" (4-38x286) SPR. No. 2 LSL = TIMBERSTRAND BOARD

STEEL LINTELS:

 $L1 = 3.1\2 \times 3.1\2 \times 1\4$ " (90 x 90 x 6) L2 = 4" x 3 1\2" x 5\16" (100 x 90 x 8) L3 = 5" x 3 1\2" x 5\16" (125 x 90 x 8) L4 = 6" x 3 1\2" x 3\8" (150 x 90 x 10) L5 = 6" x 4" x 3\8" (150 x 100 x 10)

L6 = 7" x 4" x 3\8" (180 x 100 x 10)

NOTE: LVL BEAMS

ROOF PLAN

ALL LVL BEAMS SUPPORTING FLOOR LOADS ARE TO BE SPECIFIED BY THE FLOOR TRUSS MANUFACTURER.

LAMINATED VENEER LUMBER

LVL1A = 1-1 3/4" x 7" 1/4" (1-45x184)

LVL1 = 2-1 3/4" x 7" 1/4" (2-45x184)

LVL2 = 3-1 3/4" x 7" 1/4" (3-45x184)

LVL3 = 4-1 3/4" x 7" 1/4" (4-45x184)

LVL4A = 1-1 3/4" x 9" 1/2" (1-45x235)

LVL4 = 2-1 3/4" x 9" 1/2" (2-45x235)

LVL5 = 3-1 3/4" x 9" 1/2" (3-45x235)

LVL5A = 4-1 3/4" x 9" 1/2" (4-45x235)

LVL6A = 1-1 3/4" x 11" 7/8" (1-45x300)

LVL6 = 2-1 3/4" x 11" 7/8" (2-45x300)

(LVL) BEAMS

STRUDET INC.



FOR STRUCTURE ONLY

2970 11.0m LOTS

AMELIA 3-14 ELEVATION 2 (GR)

PACKAGE 'A1'

O.REG. 332/12

ONDITIONS ON SITE BEFORE PROCEEDING WITH CONSTRUCTION NY DISCREPANCIES SHALL BE REPORTED TO JARDIN DESIGN GROU NC. PRIOR TO COMMENCEMENT OF WORK.

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5	DEC. 21, 2018	ISSUED FOR BUILDING PERMI
4	AUG. 15, 2018	COORDINATED AS PER ENGINEER COMMENTS
3	JULY 26, 2018	ISSUED FOR STRUCTURAL REVIEW
2	MAY 22, 2018	ISSUED FOR FLOOR & ROOF TRUSSES
1	APR. 25, 2018	ISSUED TO CONTROL ARCHITECT FOR PRELIMINARY APPROVAL

WORK DESCRIPTION:

VAUGHAN ONT, L4K 3P3 TEL: 905 660-3377 FAX: 905 660-3713 EMAIL: info@jardindesian.ca

64 JARDIN DR. SUITE 3A

The undersigned has reviewed and takes responsibilit for this design and has the qualifications and meets the requirements set out in the Ontario Building Code to b

QUALIFICATION_INFORMATION



REGISTRATION INFORMATION

3.2.4 of the building code jardin design group inc. 27763


FIRM NAME


TITLE SHEET **GRANELLI HOMES BRAMPTON**





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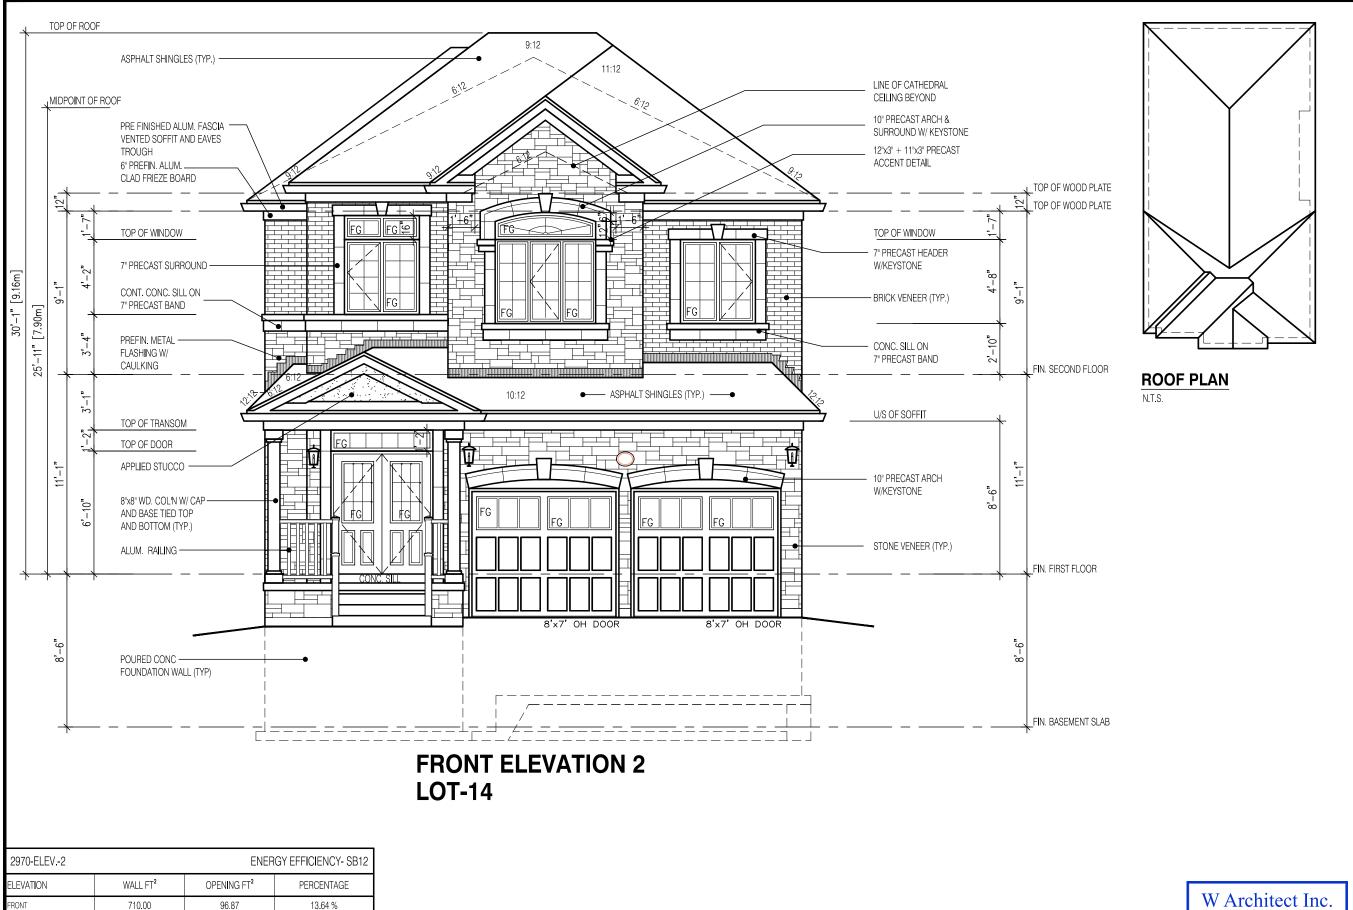
3/16"=1'-0" ROJ. No. 17-55



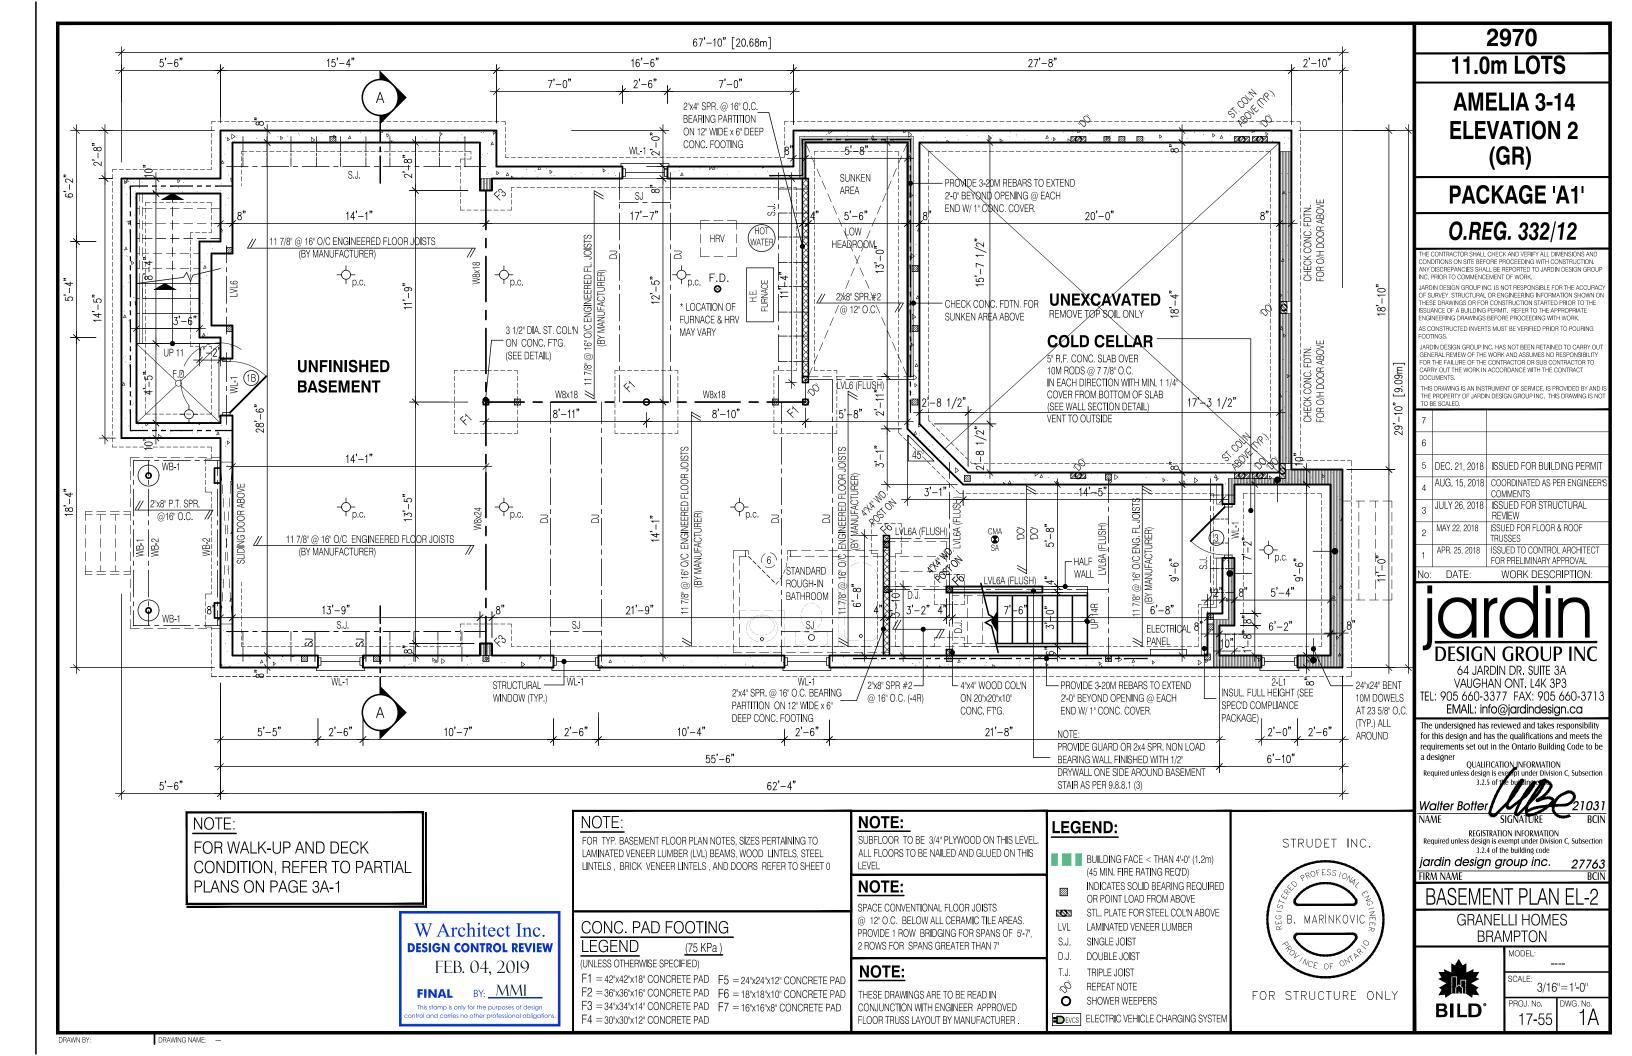

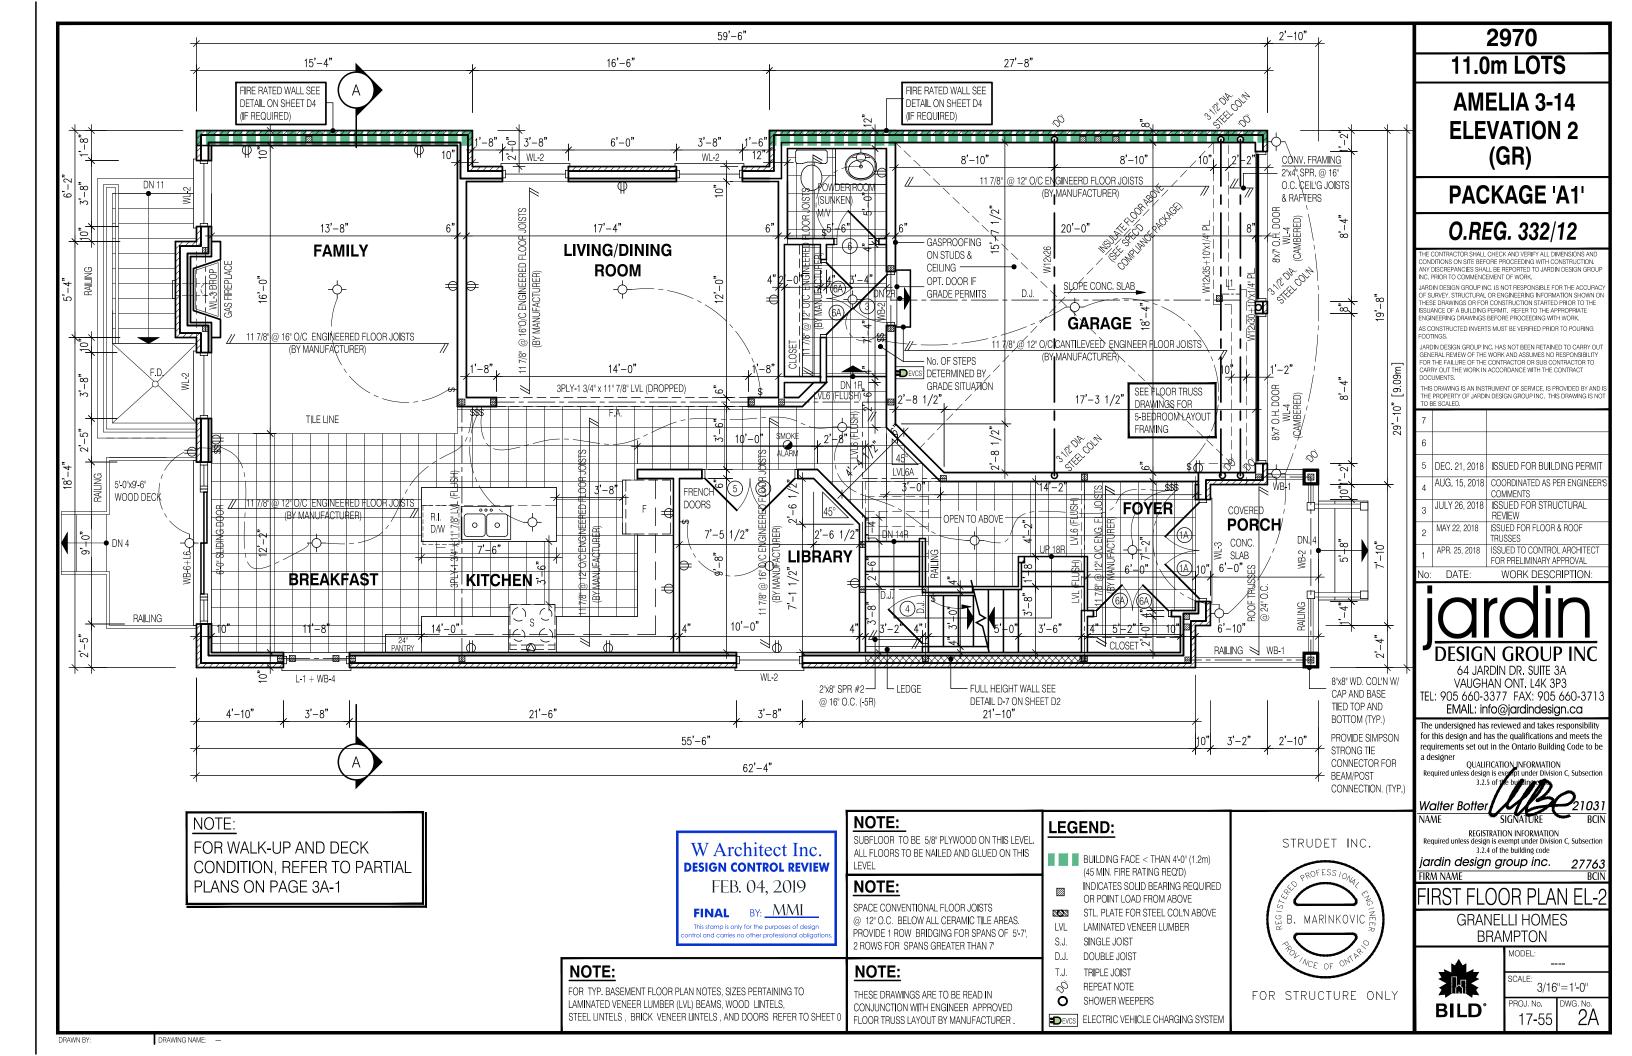

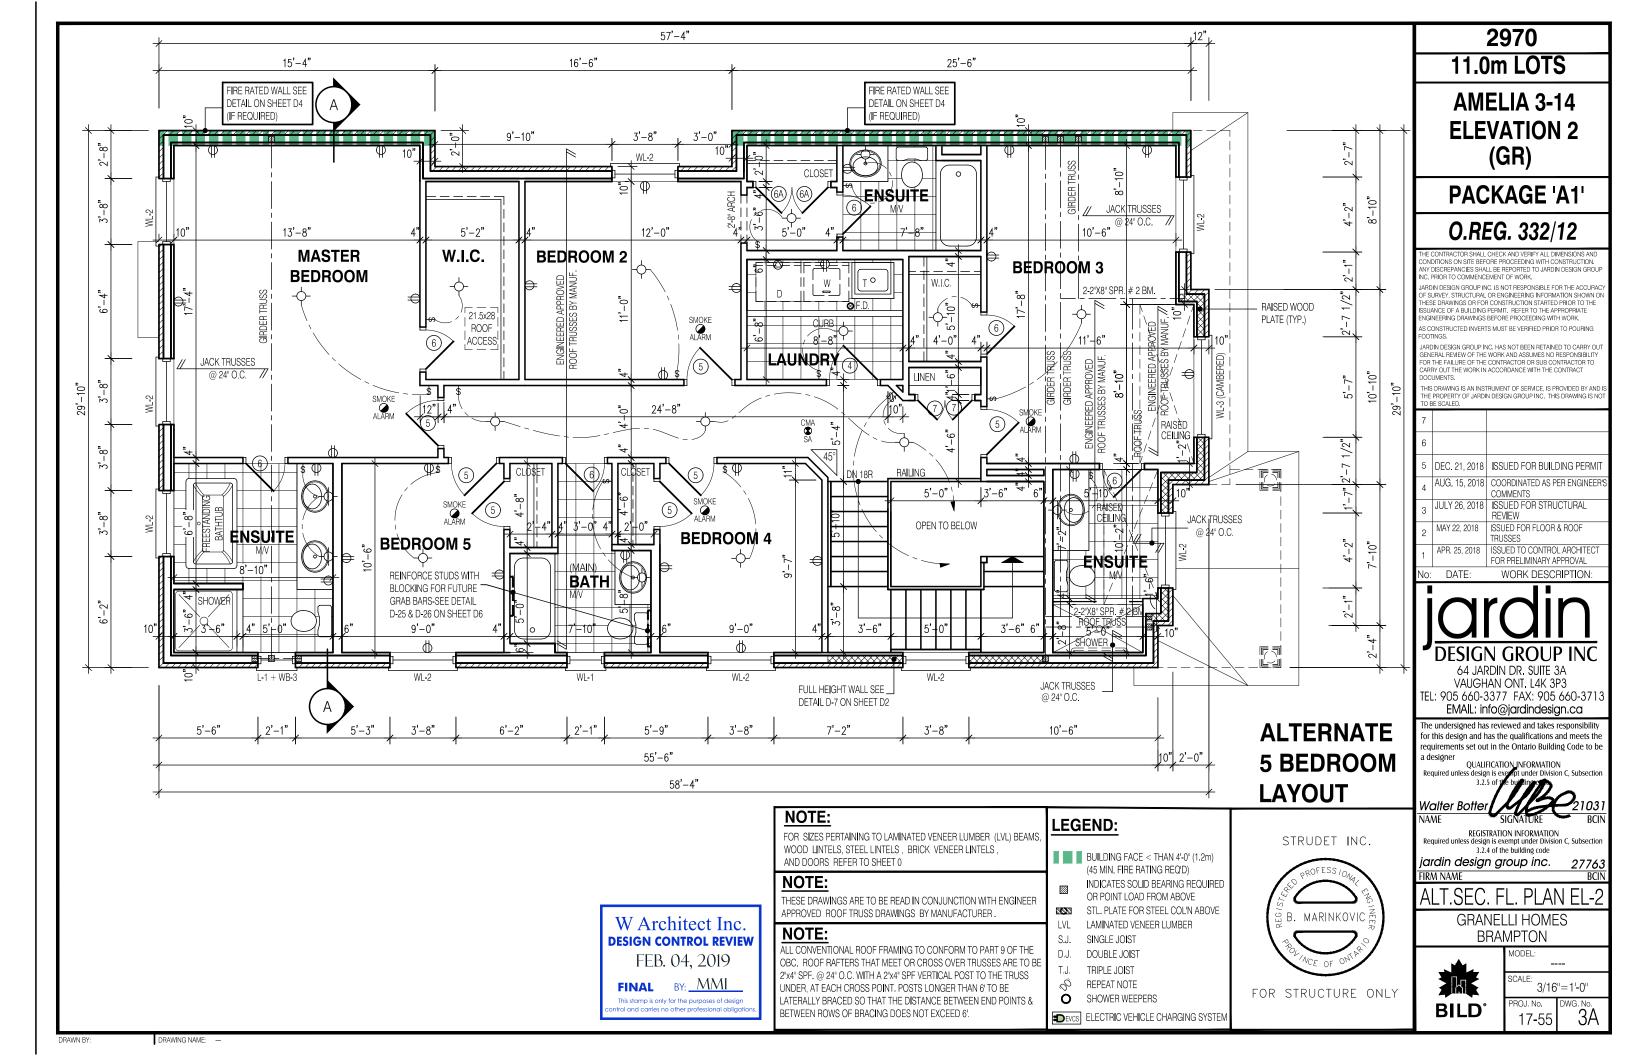

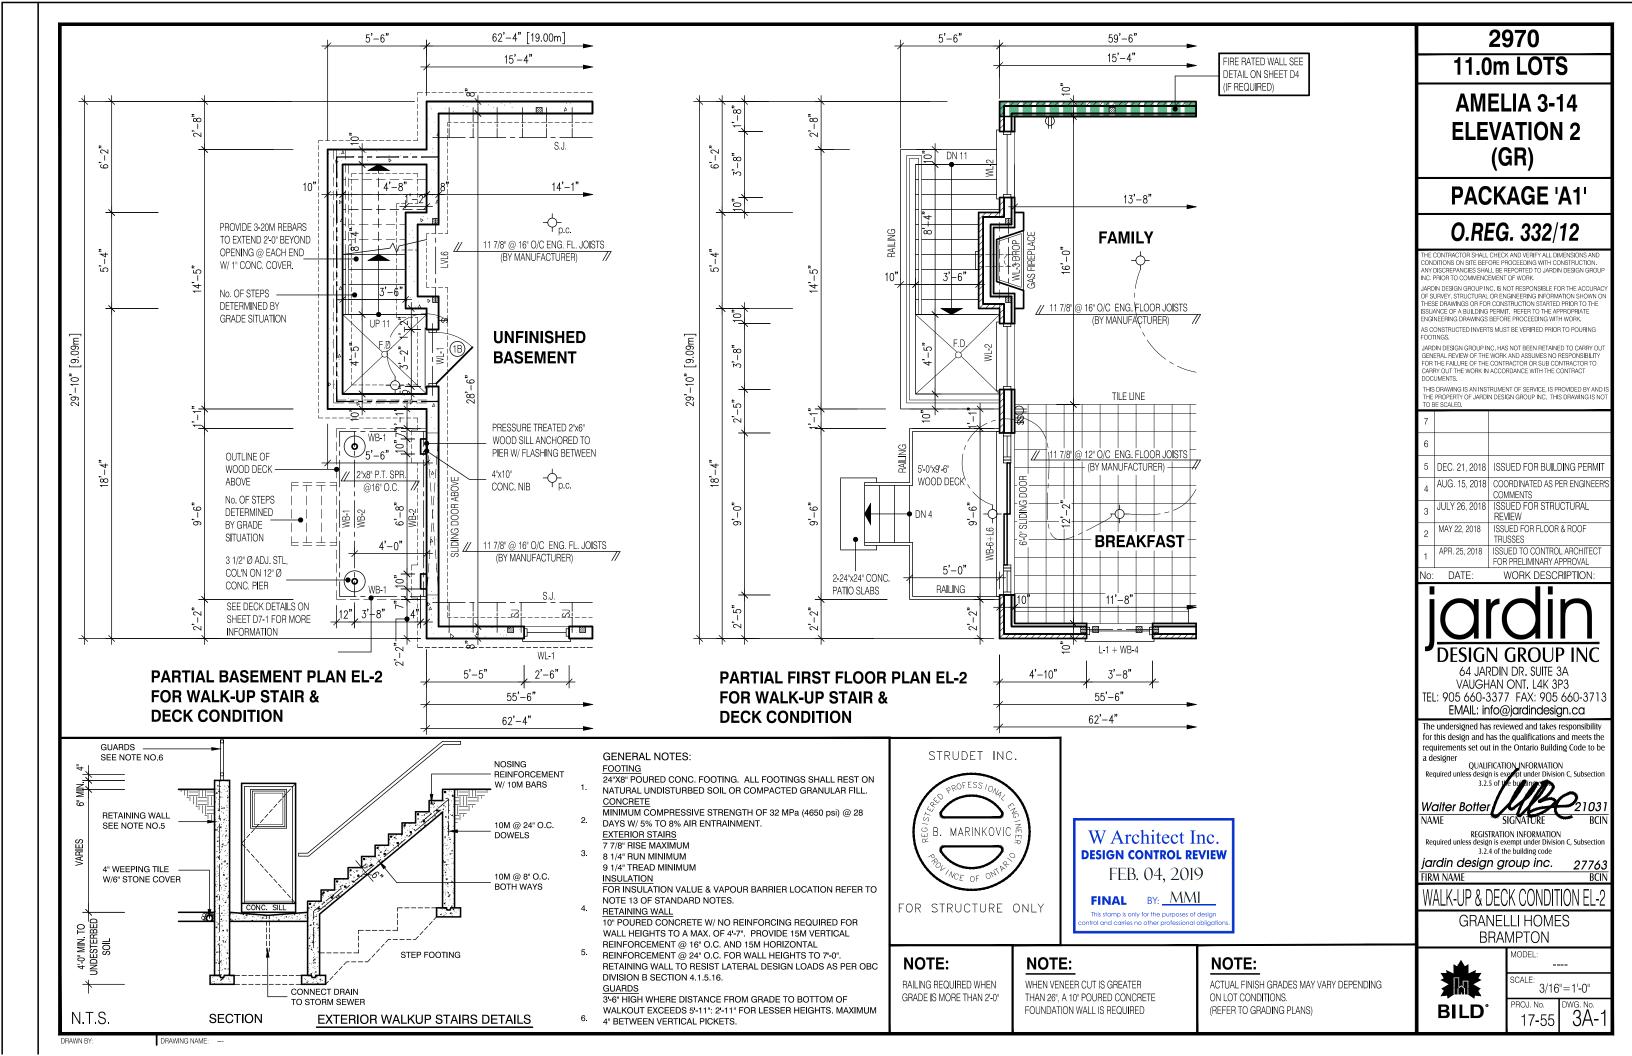

2970 11,0m LOTS

AMELIA 3-14 ELEVATION 2 (GR)

PACKAGE 'A1'

O.REG. 332/12

HE CONTRACTOR SHALL CHECK AND VERIFY ALL DIMENSIONS AND CONDITIONS ON SITE BEFORE PROCEEDING WITH CONSTRUCTION. ANY DISCREPANCIES SHALL BE REPORTED TO JARDIN DESIGN GROUP INC. PRIOR TO COMMENCEMENT OF WORK.

JARDIN DESIGN GROUP INC. IS NOT BESPONSIBLE FOR THE ACCUBA-JAMINI DESIGN GOUDT INC. IS NOT INSPONSIBLE FOR THE ACCOUNT. OF SURVEY, STRUCTURAL OF ENGINEERING INFORMATION SHOWN OF THESE DRAWINGS OR FOR CONSTRUCTION STARTED PRIOR TO THE ISSUANCE OF A BULLDING PERMIT. REFER TO THE APPROPRIATE ENGINEERING DRAWINGS BEFORE PROCEEDING WITH WORK.

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64 JARDIN DR. SUITE 3A VAUGHAN ONT, L4K 3P3 TEL: 905 660-3377 FAX: 905 660-3713 EMAIL: info@jardindesign.ca

The undersigned has reviewed and takes responsibility for this design and has the qualifications and meets the requirements set out in the Ontario Building Code to be

QUALIFICATION_INFORMATION Required unless design is e

Walter Botte NAME

REGISTRATION INFORMATION Required unless design is exempt under Division C, Subsectio 3.2.4 of the building code

jardin design group inc.

FIRM NAME

FRONT ELEVATION 2

GRANELLI HOMES BRAMPTON



MODEL: SCALE: 3/16"=1'-0" ROJ. No. 17-55

trol and carries no other professional obliga

FINAL BY: MMI This stamp is only for the purposes of design

DESIGN CONTROL REVIEW

FEB. 04, 2019

1382.00

1284.35

736.00

DRAWING NAME:

116.00

58.00

173.00

443.87

8.39 %


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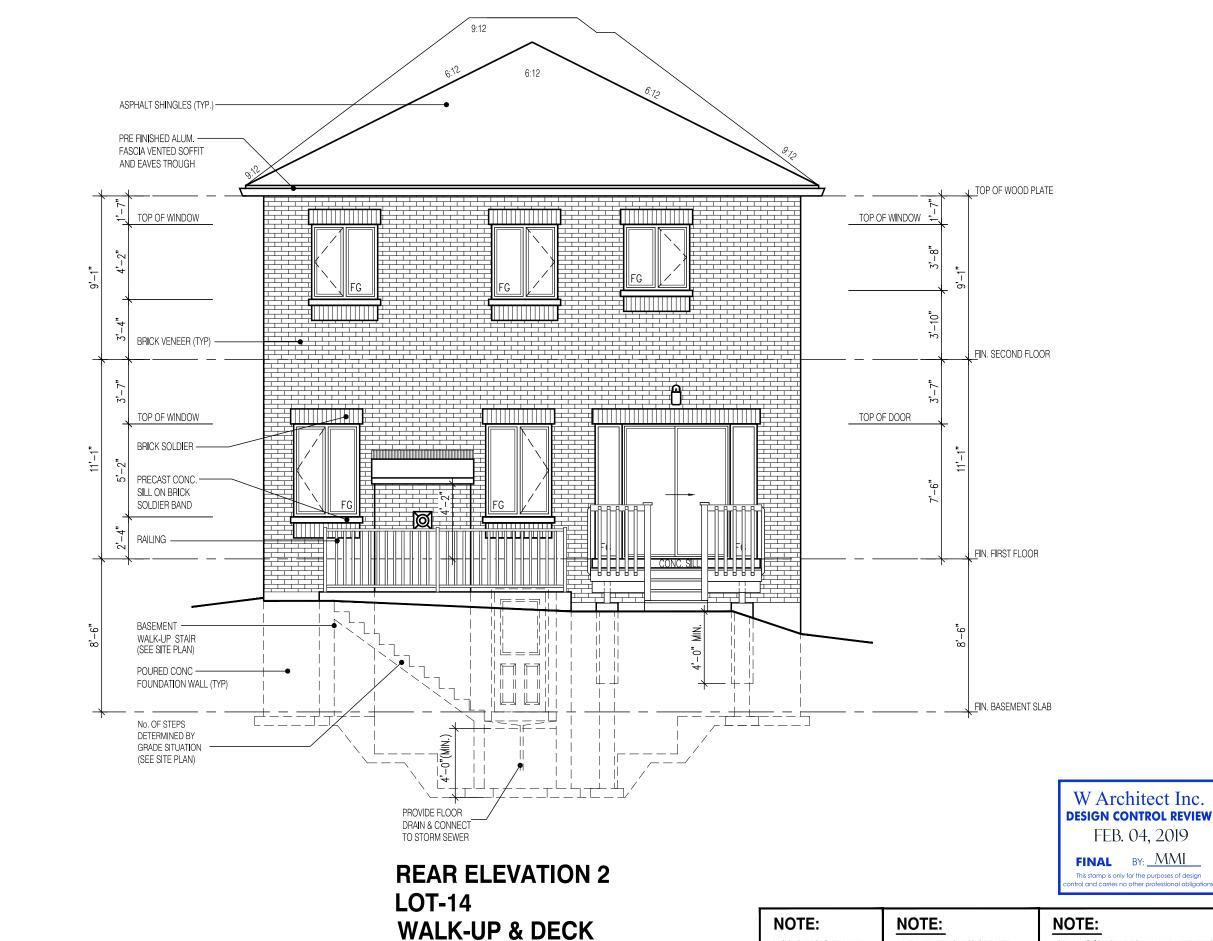
23.51 %

10.79 %

LEFT SIDE

RIGHT SIDE



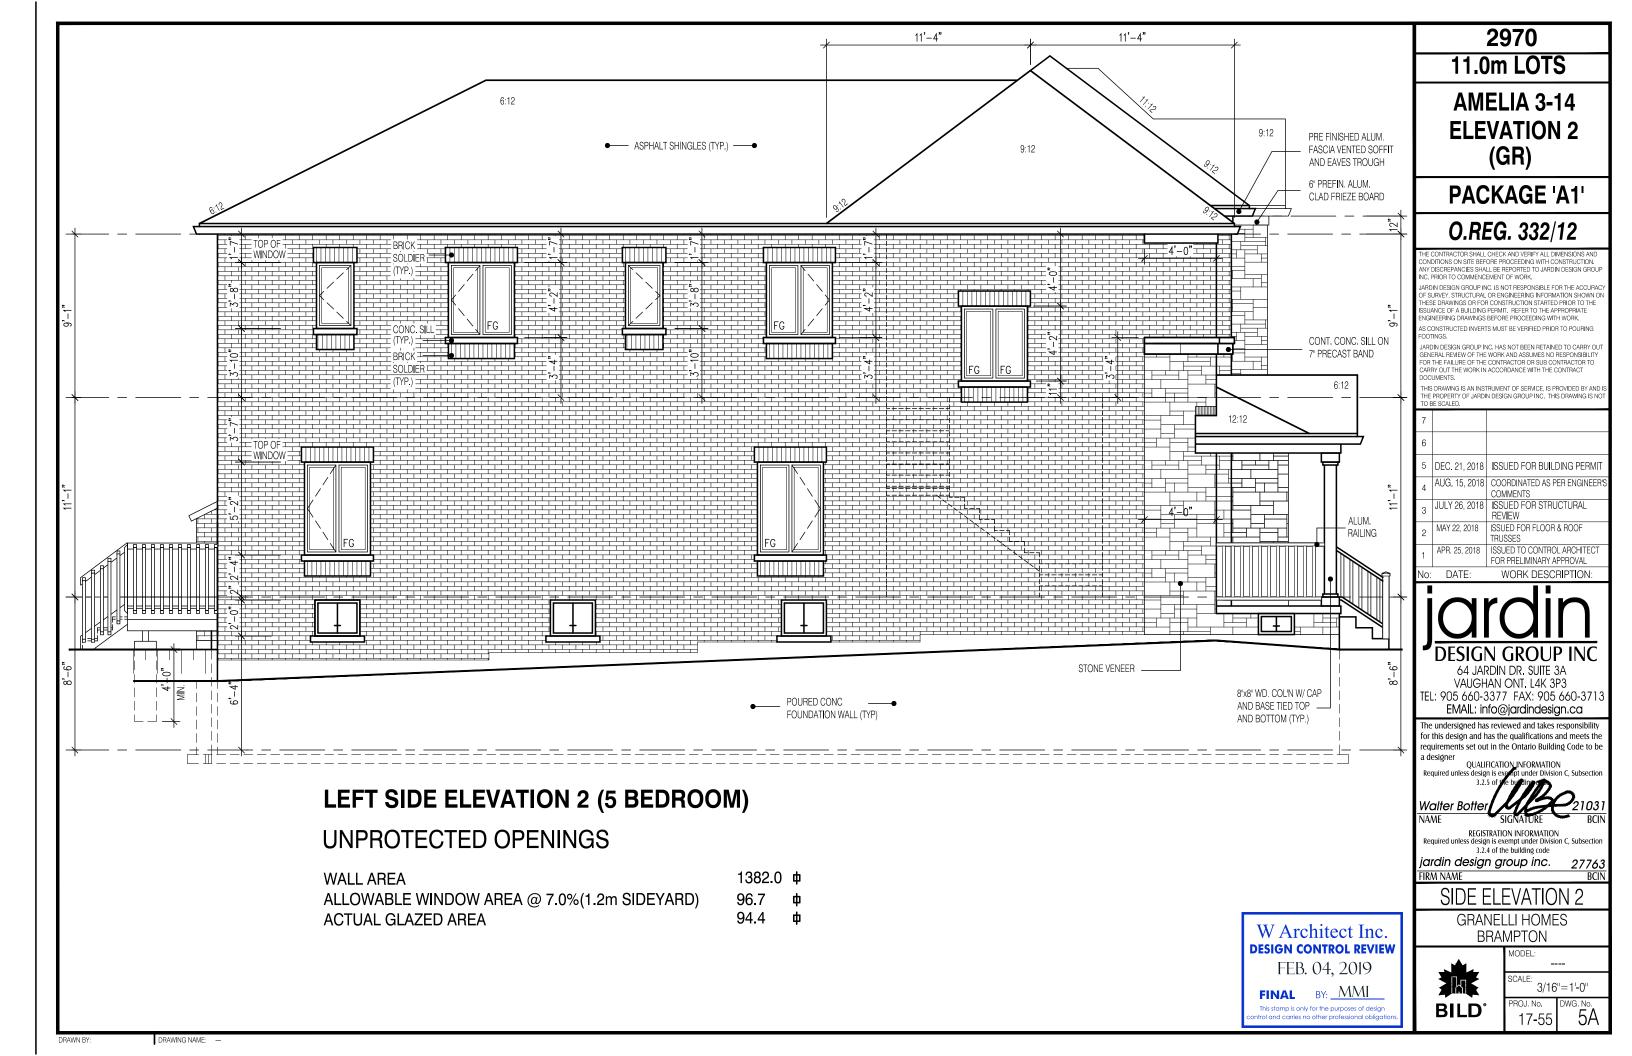

CONDITION

2970

11.0m LOTS

AMELIA 3-14 ELEVATION 2 (GR)

PACKAGE 'A1'

O.REG. 332/12

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REGISTRATION INFORMATION Required unless design is exempt under Division C, Subsection

3.2.4 of the building code

jardin design group inc.

FIRM NAME

REAR ELEVATION-2

GRANELLI HOMES BRAMPTON

MODEL:

17-55

3/16"=1'-0"

WG. №. 6A

BILD

NOTE:

RAILING REQUIRED WHEN

GRADE IS MORE THAN 2'-0"

WHEN VENEER CUT IS GREATER

FOUNDATION WALL IS REQUIRED

THAN 26", A 10" POURED CONCRETE

ACTUAL FINISH GRADES MAY VARY DEPENDING ON LOT CONDITIONS. (REFER TO GRADING PLANS)

