

# LIANA 2 (MODEL 2252 S.F.)

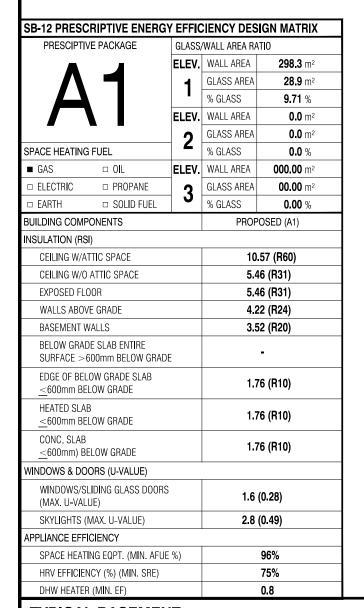



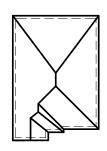

**ROOF PLAN** 

# FRONT ELEVATION 1

| AREA CALCULATI          | ONS | S - EL.1              |
|-------------------------|-----|-----------------------|
| TOTAL GROUND FLOOR AREA | =   | 1015 SQ. FT.          |
| TOTAL SECOND FLOOR AREA | =   | 1245 SQ FT.           |
| TOTAL GROSS FLOOR AREA  | =   | 2260 SQ. FT.          |
|                         |     | 209.96 m <sup>2</sup> |
| SUBTRACT OPEN AREAS     | =   | 8 sq. ft.             |
|                         |     | 0.74 m <sup>2</sup>   |
| TOTAL NET FLOOR AREA    | =   | 2252 SQ. FT.          |
|                         |     | 209.22 m <sup>2</sup> |



### TYPICAL BASEMENT FLOOR PLAN NOTES

ALL CONCRETE FOOTINGS SHALL REST ON UNDISTURBED SOIL WITH A MIN. ALLOWABLE BEARING CAPACITY OF 75Kpa (1500 PSF), AND BE FOUNDED A MIN. OF 4'-0" BELOW FINISHED GRADE.

CONCRETE STRENGTH FOR WALLS AND FOOTINGS SHALL BE A MINIMUM OF 15Mpa.

CONCRETE STRENGTH FOR GARAGE SLABS, CONC. PORCHES, AND STEPS SHALL BE A MINIMUM OF 32Mpa, WITH 5-8% AIR ENTRAINMENT.

CONCRETE STRIP FOOTING SIZE FOR 8" POURED CONC. WALLS SHALL BE A MINIMUM OF 6"x20" UNREINFORCED.

THE ABOVE FOOTING SIZE WILL BE USED FOR FOUNDATION WALLS WHICH SUPPORT 2 STOREYS OF BRICK VENEER WALL CONSTRUCTION, 2 FLOORS AND A ROOF OF LIGHT WOOD FRAME CONSTRUCTION, WITH THE SPAN OF SUPPORTED JOISTS THAT DO NOT EXCEED 4.9m (16'-1") AT A SPECIFIED LIVE LOAD OF NOT GREATER THAN 2.4 Kpa (50 PSF)

REFER TO BASEMENT PLAN FOR FOOTING SIZES IN AREAS EXCEEDING THE ABOVE CONDITIONS

3/4" SUB-FLOOR TO BE GLUED & NAILED (TYP.)

REFER TO APPROVED FLOOR JOIST LAYOUT DRAWINGS, DETAILS AND SPECIFICATIONS FOR ALL FLOOR FRAMING AND DETAILS.

ALL JOISTS UNDER CERAMIC TILES TO BE INSTALLED AS PER JOIST MANUF. SHOP DWG'S

#### CONC. PAD FOOTING LEGEND (75 KPa)

(UNLESS OTHERWISE SPECIFIED)

F1 = 42"x42"x18" CONCRETE PAD F2 = 36"x36"x16" CONCRETE PAD

F3 = 34"x34"x14" CONCRETE PAD F4 = 30"x30"x12" CONCRETE PAD

F5 = 24"x24"x12" CONCRETE PAD F6 = 18"x18"x10" CONCRETE PADF7 = 16"x16"x8" CONCRETE PAD

#### DOOR SHEDULE:

BRICK VENEER LINTELS:

 $WL1 = 3 \frac{1}{2} \times 3 \frac{1}{2} \times 1 \frac{4}{90} \times 90 \times 6 + 2 \cdot 2 \times 8 \times SPR. \text{ No. 2}$ 

WL2 = 4" x 3 1\2" x 5\16" (100x90x8) + 2-2" x 8" SPR. No. 2

 $WL3 = 5" \times 3 \times 1/2" \times 5/16" (125x90x8) + 2-2" \times 10" SPR. No. 2$ 

WL4 = 6" x 3 1\2" x 3\8" (150x90x10) + 2-2" x 12" SPR. No. 2

WL5 = 6" x 4" x 3\8" (150x100x10) + 2-2" x 12" SPR. No. 2

WL6 = 5" x 3 1\2" x 5\16" (125x90x8) + 2-2" x 12" SPR. No. 2

WL7 = 5" x 3 1\2" x 5\16" (125x90x8) + 3-2" x 10" SPR. No. 2

WL8 = 5" x 3 1\2" x 5\16" (125x90x8) + 3- 2" x12" SPR. No. 2

 $WL9 = 6" \times 4" \times 3\8" (150\times100\times10) + 3-2" \times 12" SPR. No. 2$ 

1 = 2'-10" x 6'-8" (865x2033) INSULATED ENTRANCE DOOR 1A = 2'-8" x 6'-8" (815x2033) INSULATED ENTRANCE DOOR 2 = 2'-8" x 6'-8" (815x2033) EXTERIOR WOOD & GLAZED DOOF  $3 = 2'-8" \times 6'-8" \times 1 3/4" (815 \times 2033 \times 45)$  EXTERIOR SLAB DOOR  $4 = 2'-8" \times 6'-8" \times 1 3/8" (815 \times 2033 \times 35)$  INTERIOR SLAB DOOR 5 = 2'-6" x 6'-8" x 1 3/8" (760x2033x35) INTERIOR SLAB DOOR  $6 = 2'-2'' \times 6'-8'' \times 1 3/8'' (660 \times 2033 \times 35)$  INTERIOR SLAB DOOR  $7 = 1'-6" \times 6'-8" \times 1 3/8" (460 \times 2033 \times 35)$  INTERIOR SLAB DOOR

#### WOOD LINTELS:

WB1 = 2-2" x 8" (2-38X184) SPR. No. 2 WB2 =  $3-2" \times 8"$  (3-38x184) SPR. No. 2 WB3 =  $2 - 2'' \times 10'' (2 - 38 \times 235)$  SPR No. 2 WB4 = 3-2" x 10" (3-38x235) SPR. No. 2 WB5 = 2-2" x 12" (2-38x286) SPR. No. 2 WB6 = 3-2" x 12" (3-38x286) SPR. No. 2 WB7 = 5-2" x 12" (5-38x286) SPR. No. 2 WB10 = 4-2" x 8" (4-38x184) SPR. No. 2 WB11 = 4- 2" x 10" (4-38x235) SPR. No. 2 WB12 = 4-2" x 12" (4-38x286) SPR. No. 2 LSL = TIMBERSTRAND BOARD

#### STEEL LINTELS:

 $L1 = 3 \, 1 \setminus 2 \, x \, 3 \, 1 \setminus 2 \, x \, 1 \setminus 4^{-1} \, (90 \, x \, 90 \, x \, 6)$ L2 = 4" x 3 1\2" x 5\16" (100 x 90 x 8) L3 = 5" x 3 1\2" x 5\16" (125 x 90 x 8) L4 = 6" x 3 1\2" x 3\8" (150 x 90 x 10) L5 = 6" x 4" x 3\8" (150 x 100 x 10) L6 = 7" x 4" x 3\8" (180 x 100 x 10)

# LAMINATED VENEER LUMBER

(LVL) BEAMS LVL1A = 1-1 3/4" x 7" 1/4" (1-45x184) LVL1 = 2-1 3/4" x 7" 1/4" (2-45x184) LVL2 = 3-1 3/4" x 7" 1/4" (3-45x184) LVL3 =  $4-1 \ 3/4$ " x 7" 1/4" (4-45x184) LVL4A = 1-1 3/4" x 9" 1/2" (1-45x235) LVL4 = 2-1 3/4" x 9" 1/2" (2-45x235) LVL5 = 3-1 3/4" x 9" 1/2" (3-45x235) LVL5A = 4-1 3/4" x 9" 1/2" (4-45x235) LVL6A = 1-1 3/4" x 11" 7/8" (1-45x300) LVL6 = 2-1 3/4" x 11" 7/8" (2-45x300)

#### NOTE: LVL BEAMS

ALL LVL BEAMS SUPPORTING FLOOR LOADS ARE TO BE SPECIFIED BY THE FLOOR TRUSS MANUFACTURER.

# STRUDET INC.



FOR STRUCTURE ONLY

2252

11.0m LOTS **LIANA 2-17 ELEVATION 1** 

**PACKAGE 'A1'** 

(GR)

O.REG. 332/12

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CARRY OUT THE WORK IN ACCORDANCE WITH THE CONTRACT

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| 5 |               |  |
| 4 | DEC. 21, 2018 | ISSUED FOR BUILDING PERM               |
| 3 | AUG. 15, 2018 | COORDINATED AS PER ENGINEI<br>COMMENTS |
| 2 | JULY 26, 2018 | ISSUED FOR STRUCTURAL<br>REVIEW        |
| 1 | MAY 22, 2018  | ISSUED FOR FLOOR & ROOF                |

WORK DESCRIPTION:

64 JARDIN DR. SUITE 3A VAUGHAN ONT, L4K 3P3 TEL: 905 660-3377 FAX: 905 660-3713 EMAIL: info@jardindesian.ca

he undersigned has reviewed and takes responsibilit for this design and has the qualifications and meets the equirements set out in the Ontario Building Code to b

QUALIFICATION\_INFORMATION

NAME

REGISTRATION INFORMATION

3.2.4 of the building code 27763

jardin design group inc. FIRM NAME


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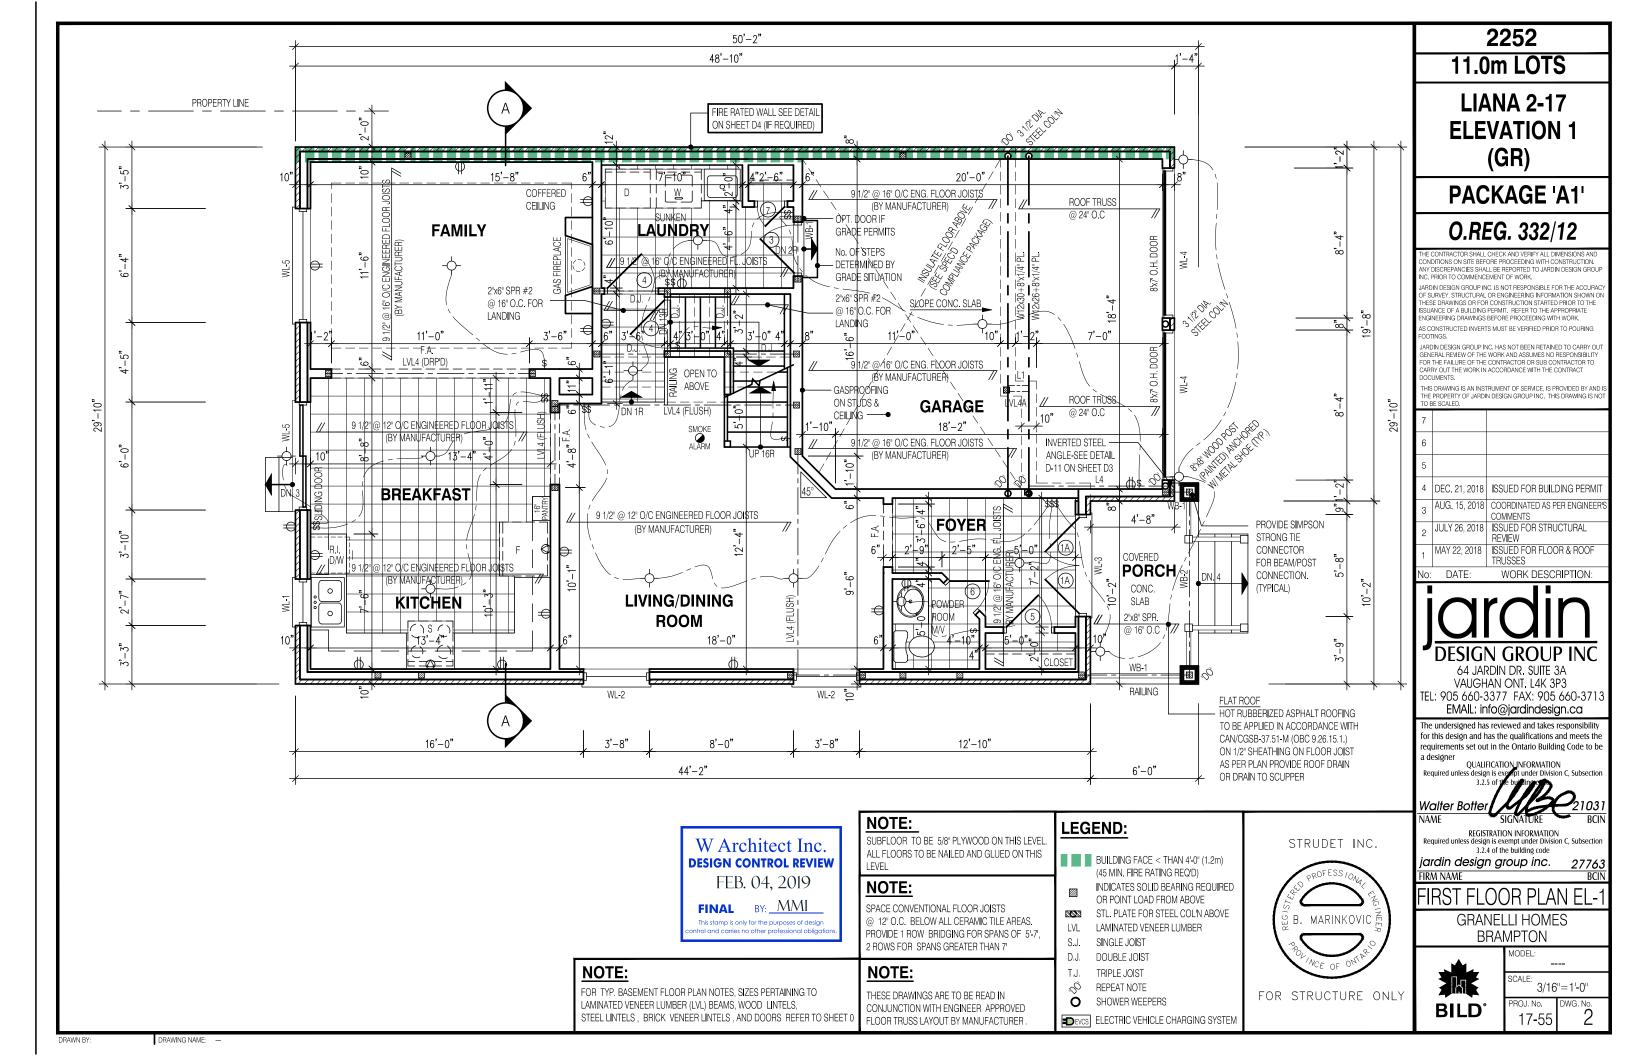
**GRANELLI HOMES** BRAMPTON




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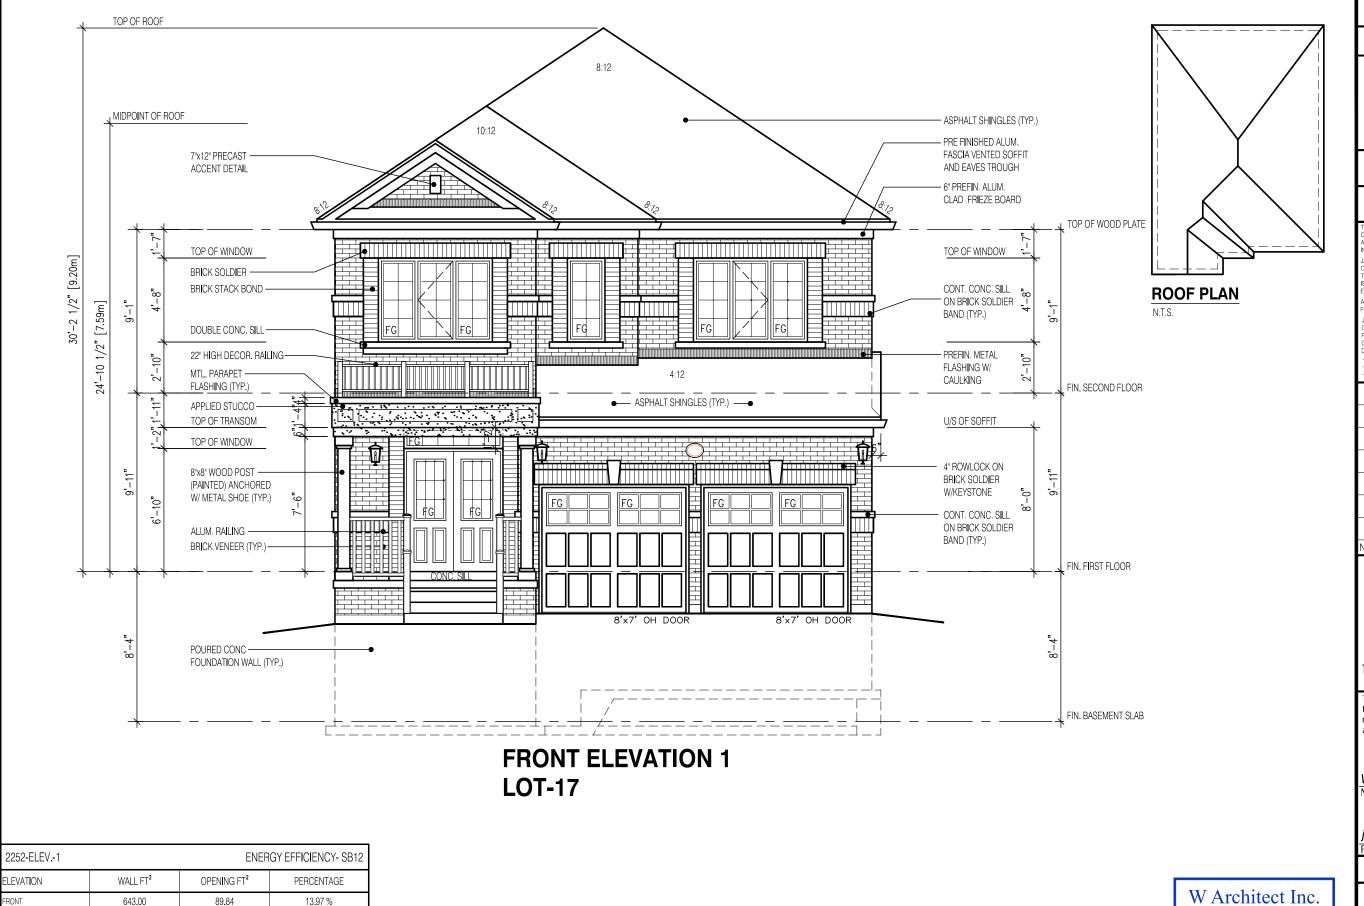
3/16"=1'-0" ROJ. No. 17-55





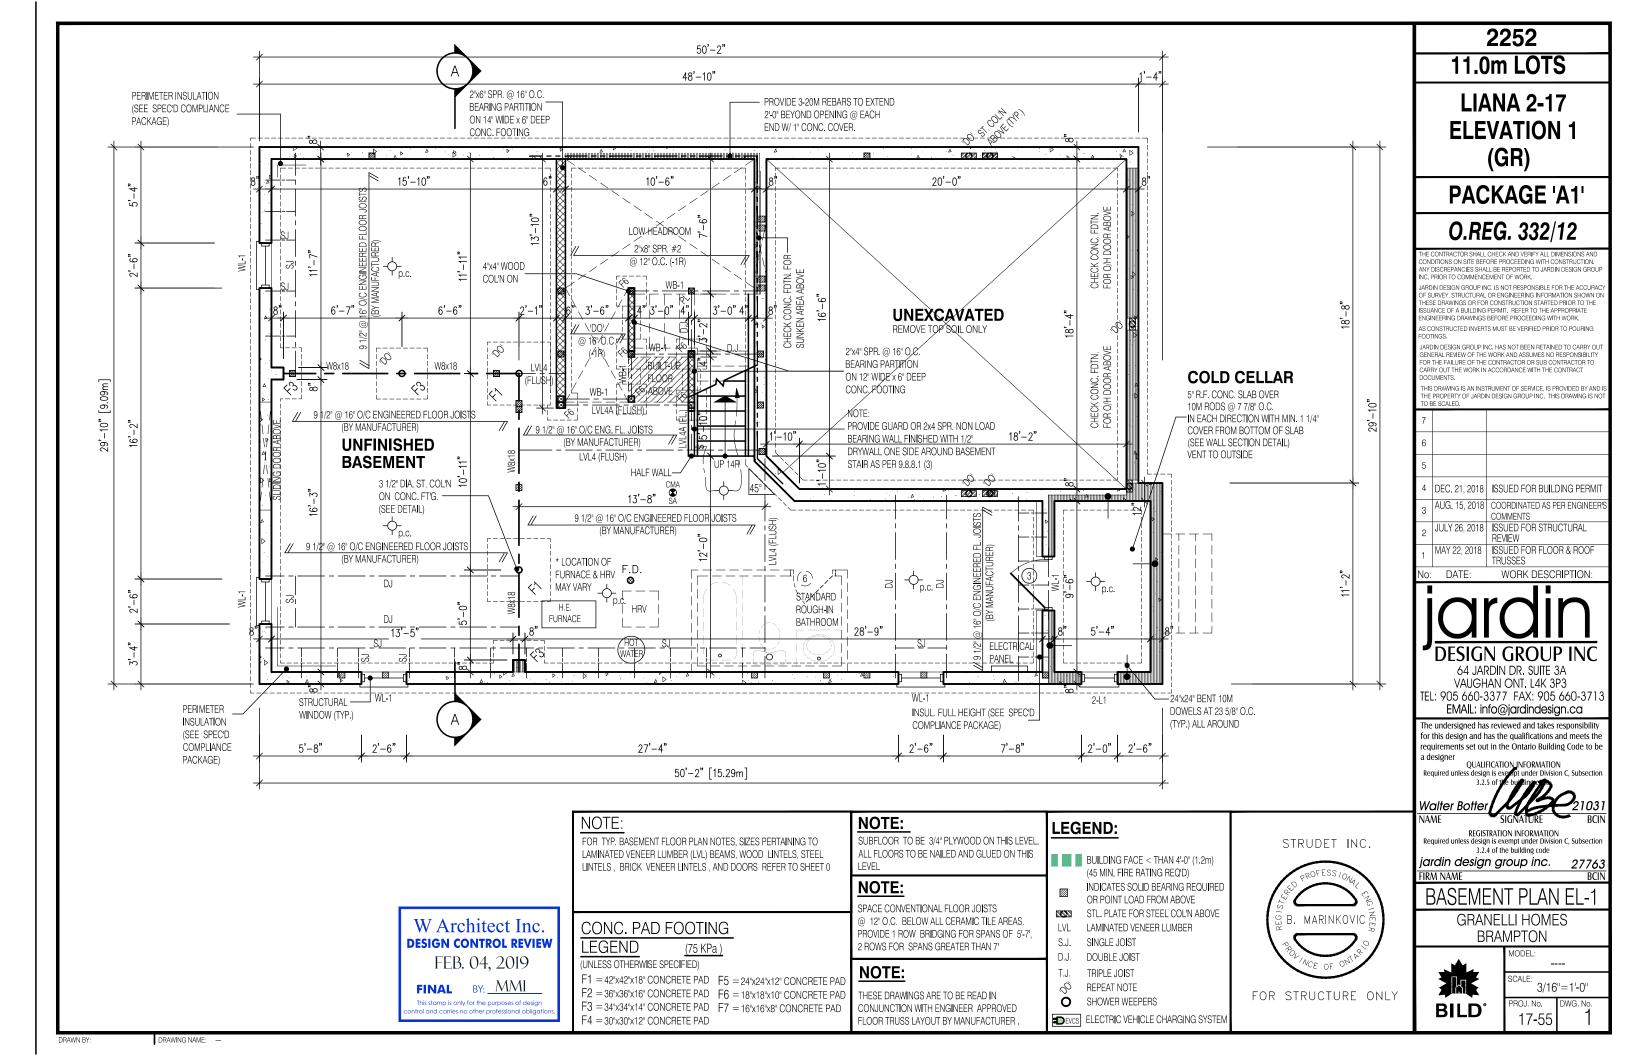

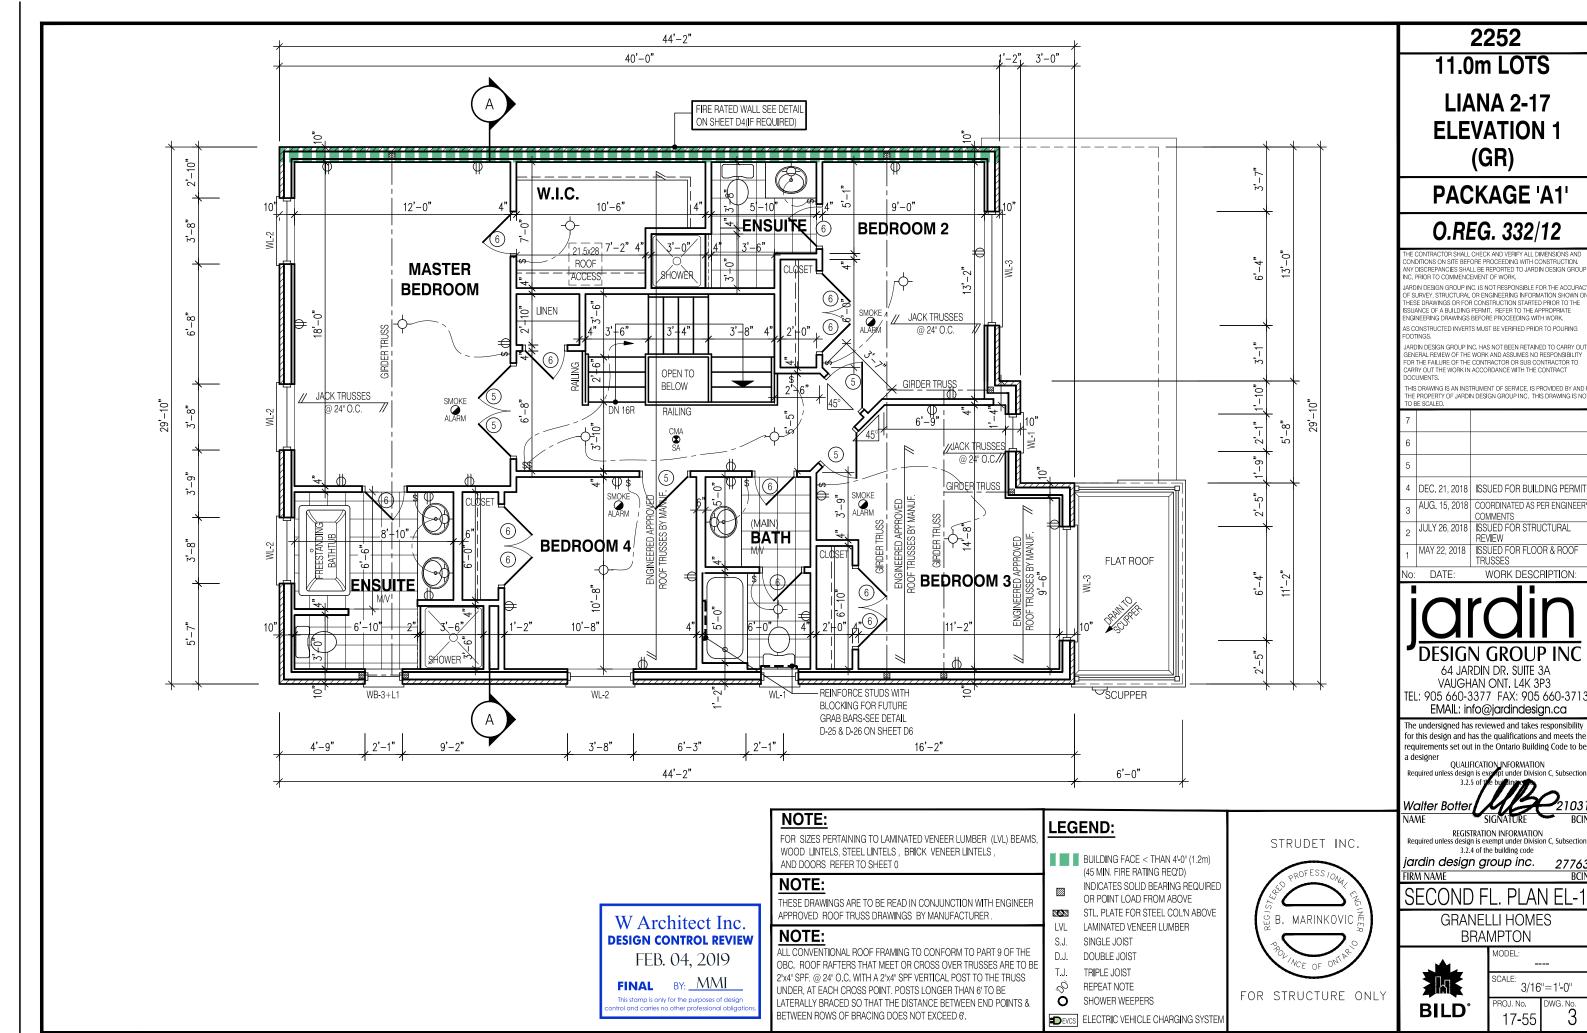DRAWING NAME:



W Architect Inc. **DESIGN CONTROL REVIEW** FEB. 04, 2019

FINAL BY: MMI

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2252 11.0m LOTS

**LIANA 2-17 ELEVATION 1** (GR)

**PACKAGE 'A1'** 

O.REG. 332/12

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|---|---------------|------------------------------------|
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| 4 | DEC. 21, 2018 | ISSUED FOR BUILDING PERI           |
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| 1 | MAY 22, 2018  | ISSUED FOR FLOOR & ROOI<br>TRUSSES |

WORK DESCRIPTION:



64 JARDIN DR. SUITE 3A VAUGHAN ONT, L4K 3P3 TEL: 905 660-3377 FAX: 905 660-3713 EMAIL: info@jardindesign.ca

The undersigned has reviewed and takes responsibility for this design and has the qualifications and meets the requirements set out in the Ontario Building Code to be a designer

QUALIFICATION\_INFORMATION Required unless design is e

Walter Botte NAME

REGISTRATION INFORMATION Required unless design is exempt under Division C, Subsectio 3.2.4 of the building code

jardin design group inc. FIRM NAME

FRONT ELEVATION 1

**GRANELLI HOMES BRAMPTON** 



MODEL: SCALE:

3/16"=1'-0" ROJ. No. 17-55

DRAWING NAME:

991.00

953.00

624.00

3211.00

80.70

0.00

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311.74

8.14 %


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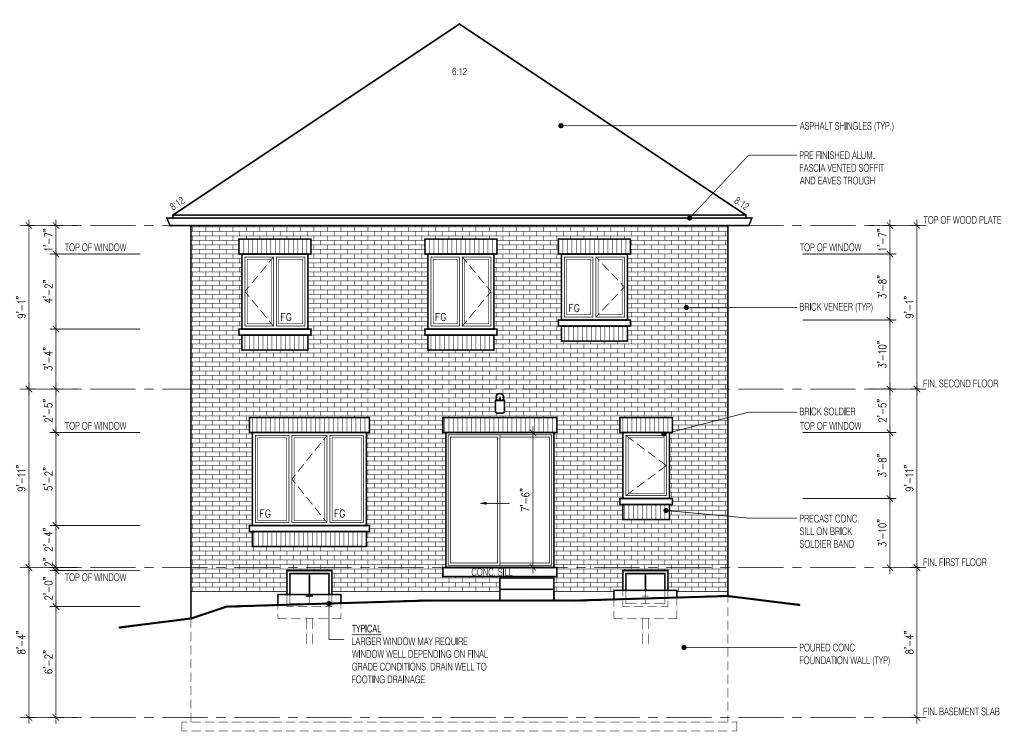
22.63 %

9.71 %

LEFT SIDE

RIGHT SIDE



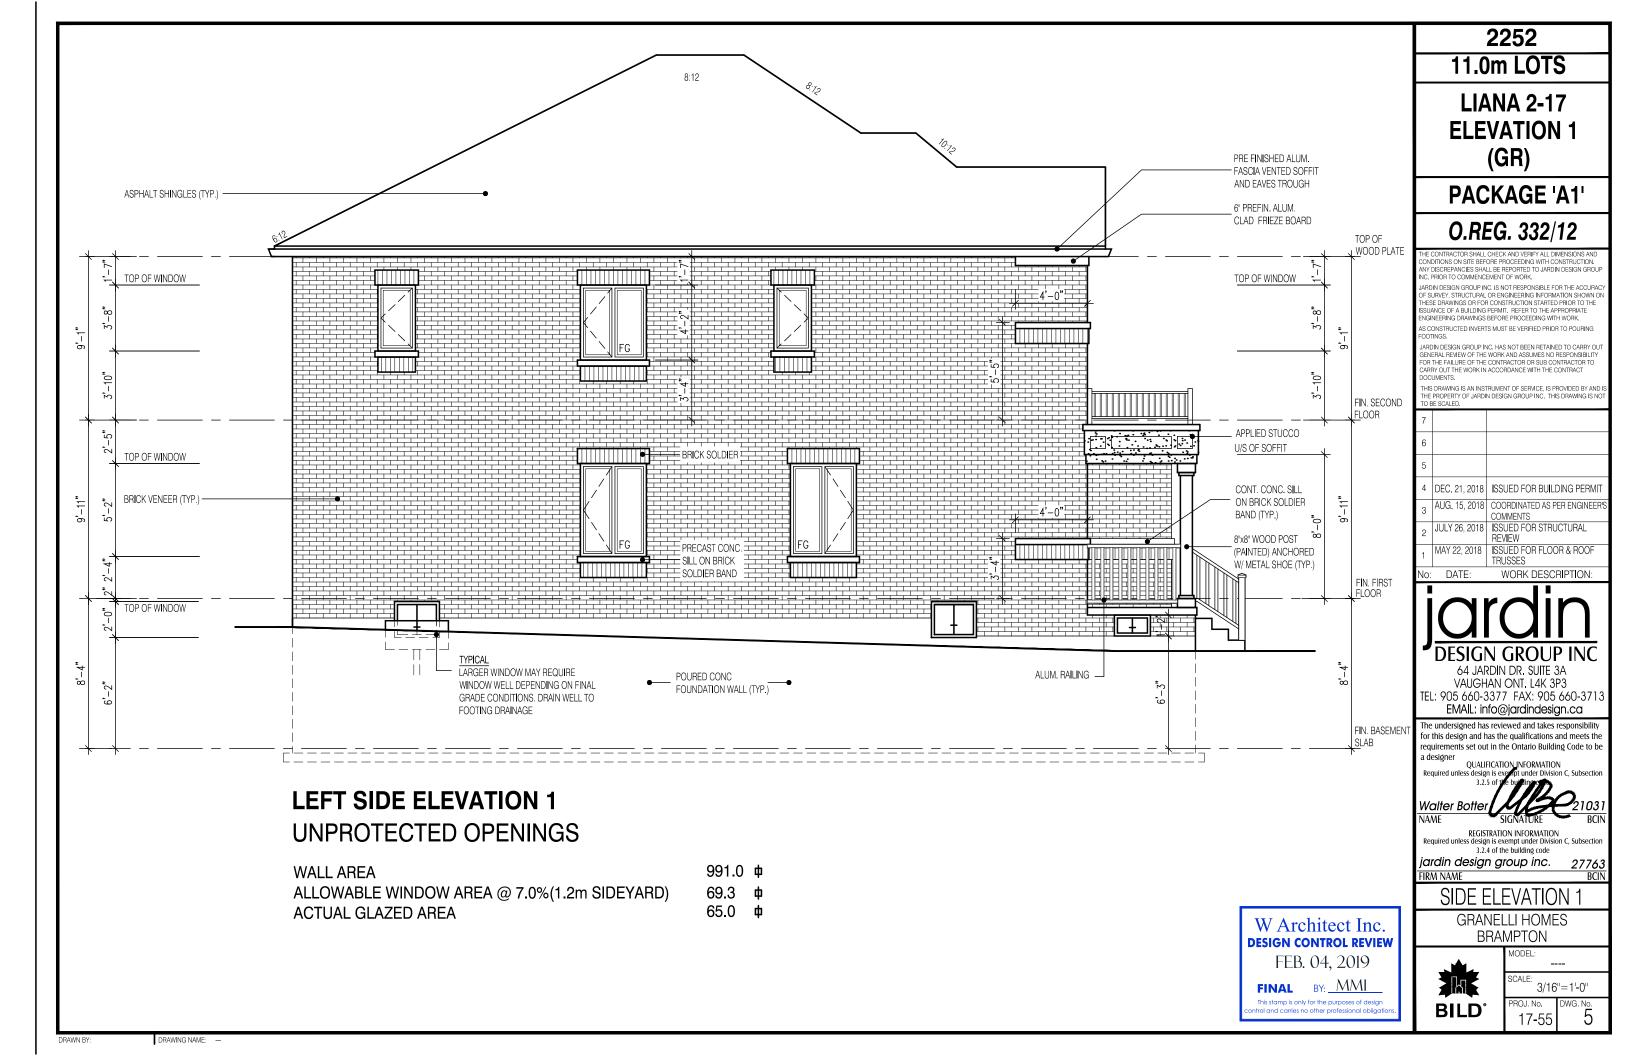

**REAR ELEVATION 1** 

W Architect Inc.

DESIGN CONTROL REVIEW
FEB. 04, 2019

FINAL BY: MMI

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2252 11.0m LOTS

LIANA 2-17 ELEVATION 1 (GR)

PACKAGE 'A1'

O.REG. 332/12

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6 5 4 DEC. 21, 2018 ISSUED FOR BUILDING PERMIT 3 AUG. 15, 2018 COORDINATED AS PER ENGINEER COMMENTS 2 JULY 26, 2018 ISSUED FOR STRUCTURAL REVIEW 1 MAY 22, 2018 ISSUED FOR FLOOR & ROOF TRUSSES

o: DATE: WORK DESCRIPTION:



64 JARDIN DR. SUITE 3A VAUGHAN ONT. L4K 3P3 TEL: 905 660-3377 FAX: 905 660-3713 EMAIL: info@jardindesign.ca

The undersigned has reviewed and takes responsibility for this design and has the qualifications and meets the requirements set out in the Ontario Building Code to be a designer

QUALIFICATION INFORMATION Required unless design is exempt under Division 3.2.5 of the building con-

NAME SIGNATURE

REGISTRATION INFORMA-

REGISTRATION INFORMATION Required unless design is exempt under Division C, Subsection 3.2.4 of the building code

jardin design group inc.

REAR ELEVATION 1


GRANELLI HOMES BRAMPTON




MODEL:

SCALE:
3/PROJ. No.

3/16"=1'-0"
ROJ. No. DWG. No. 6

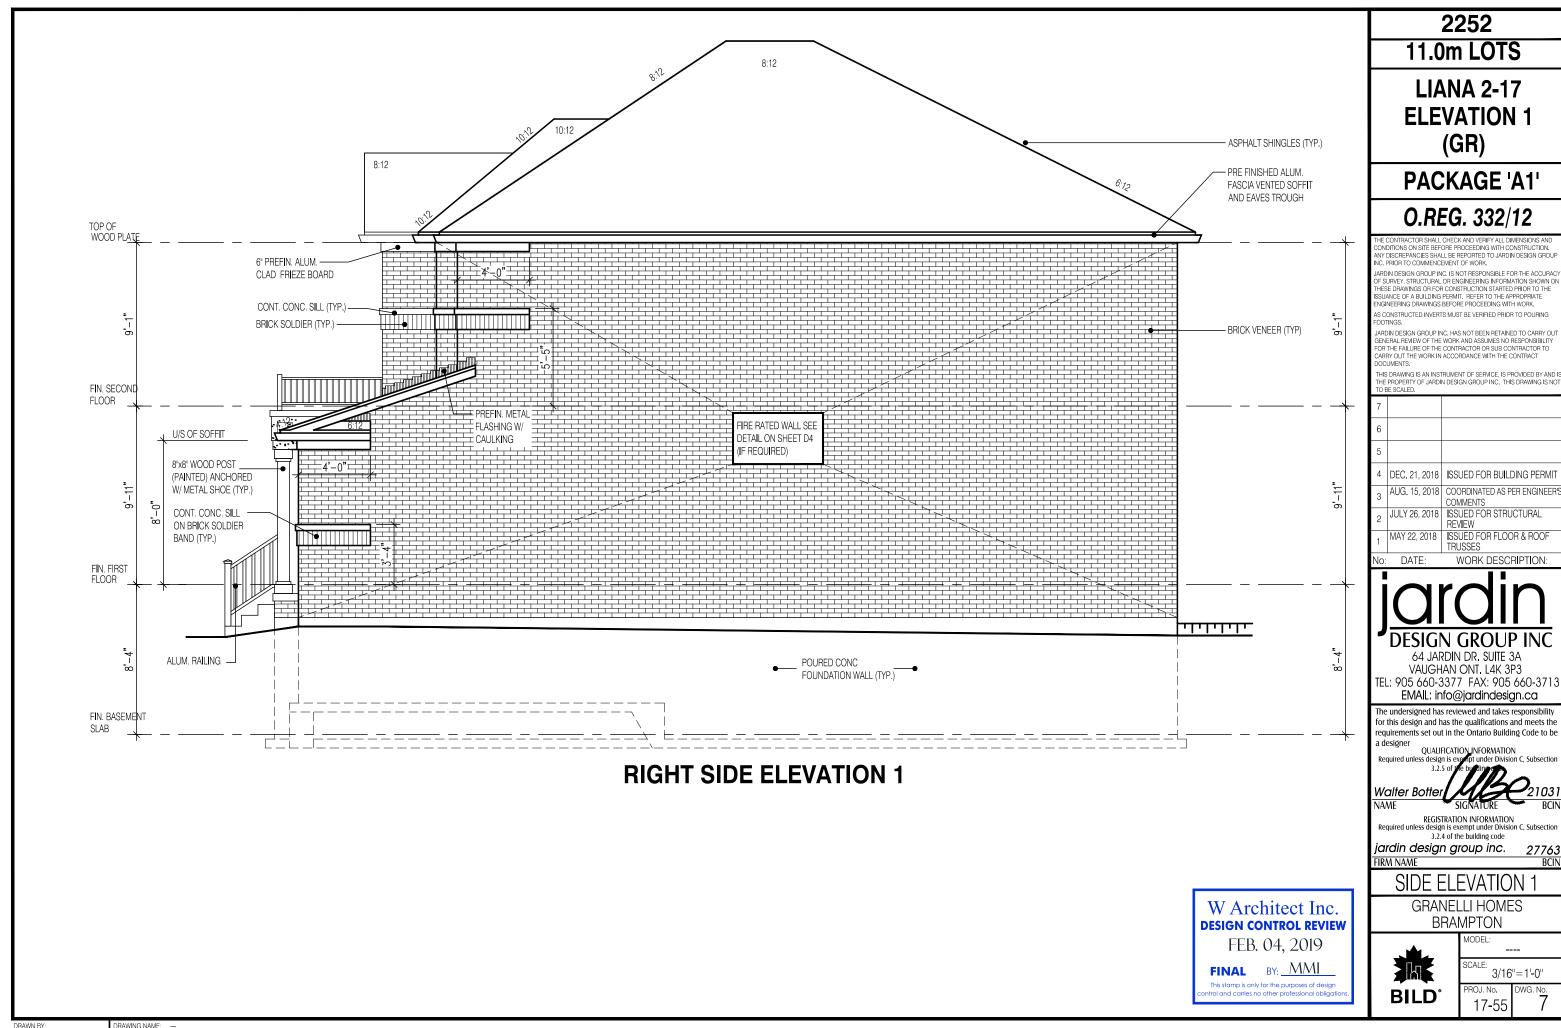

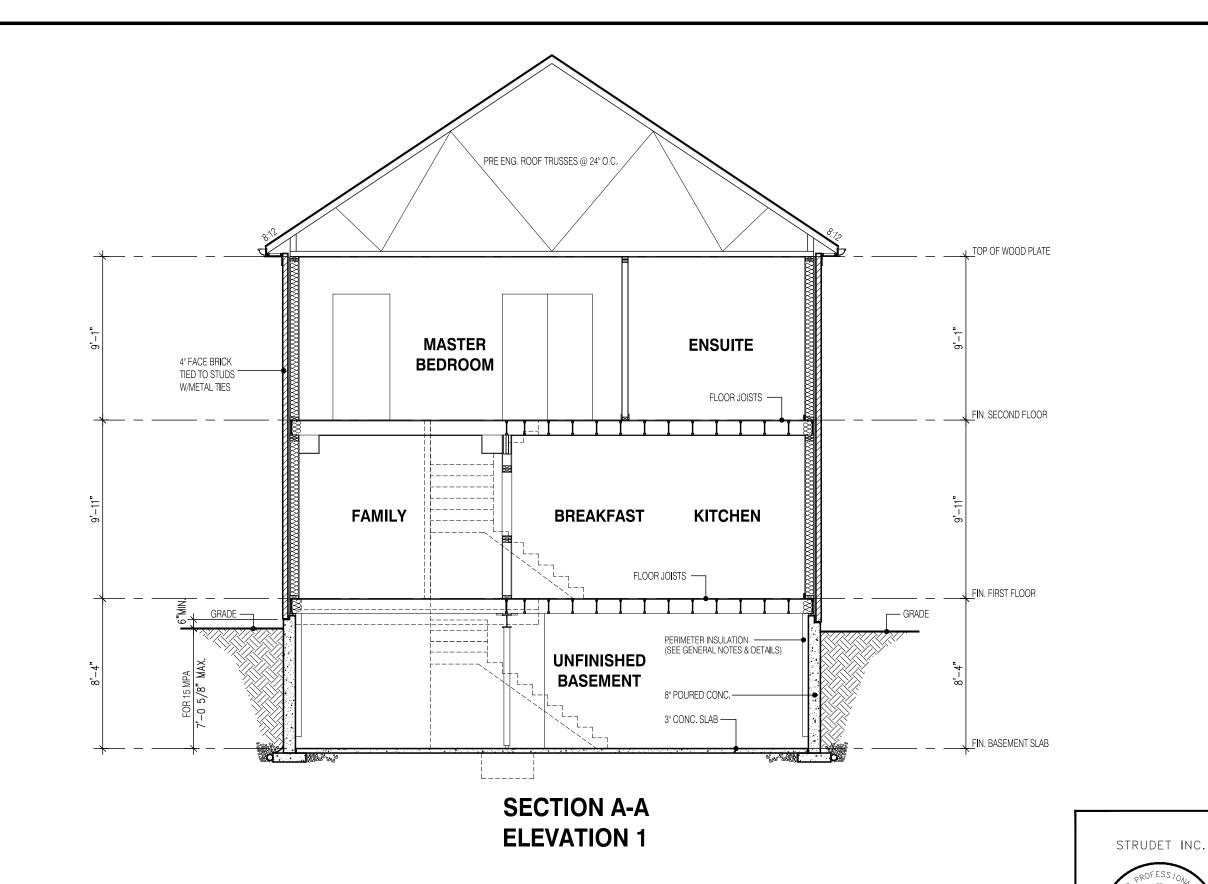

W Architect Inc. **DESIGN CONTROL REVIEW** FEB. 04, 2019

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2252

11.0m LOTS

**LIANA 2-17 ELEVATION 1** (GR)

PACKAGE 'A1'

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QUALIFICATION\_INFORMATION Required unless design is e

NAME

REGISTRATION INFORMATION
Required unless design is exempt under Division C, Subsection

3.2.4 of the building code 27763

jardin design group inc. FIRM NAME

**SECTION EL-1** 

MODEL:

17-55

3/16"=1'-0"

**GRANELLI HOMES BRAMPTON** 



B. MARINKOVIC

SCALE: PROJ. No.