

M. David Blakely
Architect Inc.

2200 Prince of Wales Dr. Suite 101 Ottawa, Ontario
Phone (613) 226-8811 Fax (613) 226-7422 K2E 6Z9

GENERAL NOTES:

- THE CONTRACTOR IS RESPONSIBLE FOR CHECKING AND VERIFYING ALL DIMENSIONS. ANY DISCREPANCY MUST BE REPORTED TO M. DAVID BLAKELY ARCHITECT INC.
- ALL WORK AND MATERIALS TO BE IN COMPLIANCE WITH ALL CODES, REGULATIONS, & STANDARDS.
- ADDITIONAL DRAWINGS MAY BE ISSUED FOR CLARIFICATION TO ASSIST THE PROPER EXECUTION OF WORK. SUCH DRAWINGS WILL HAVE THE SAME MEANING AND INTENT AS IF THEY WERE INCLUDED WITH THE PLANS IN ARCHITECT DOCUMENTS.
- DO NOT SCALE DRAWINGS.
- THE DRAWING SHALL NOT BE USED OR COPIED WITHOUT THE AUTHORIZATION OF THE ARCHITECT.
- THIS DRAWING SHALL NOT BE USED FOR PERMIT OR CONSTRUCTION UNLESS THE DRAWING BEARS THE ARCHITECT'S SEAL AND SIGNATURE.

POST SCHEDULE

P1 - 3" DIA. ADJUSTABLE STEEL TELEPOST
P2 - 2" DIA. 6 OR 8" (AS APPLICABLE)
P3 - 3" DIA. 6 OR 8" (AS APPLICABLE)
P4 - 4" DIA. 6 OR 8" (AS APPLICABLE)
P5 - 5" DIA. 6 OR 8" (AS APPLICABLE)
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STRUCTURAL ENGINEER:
Cleland Jardine Engineering Ltd
580 Terry Fox Dr. Kanata, ON
K0L 4B9 (613) 591-1533

SEAL

ONTARIO ASSOCIATION OF ARCHITECTS
M. DAVID BLAKELY
LICENCE 34558

NO.	DATE	DESCRIPTION	INT.	NO.	DATE	DESCRIPTION	INT.
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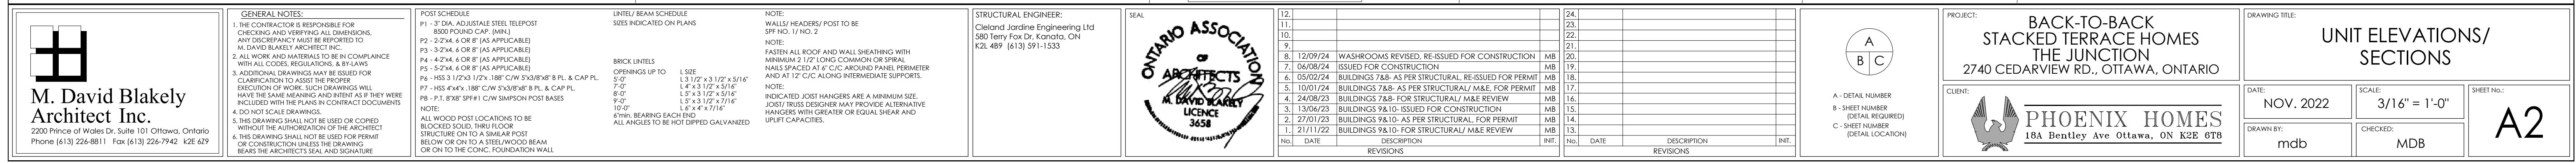
REVISIONS


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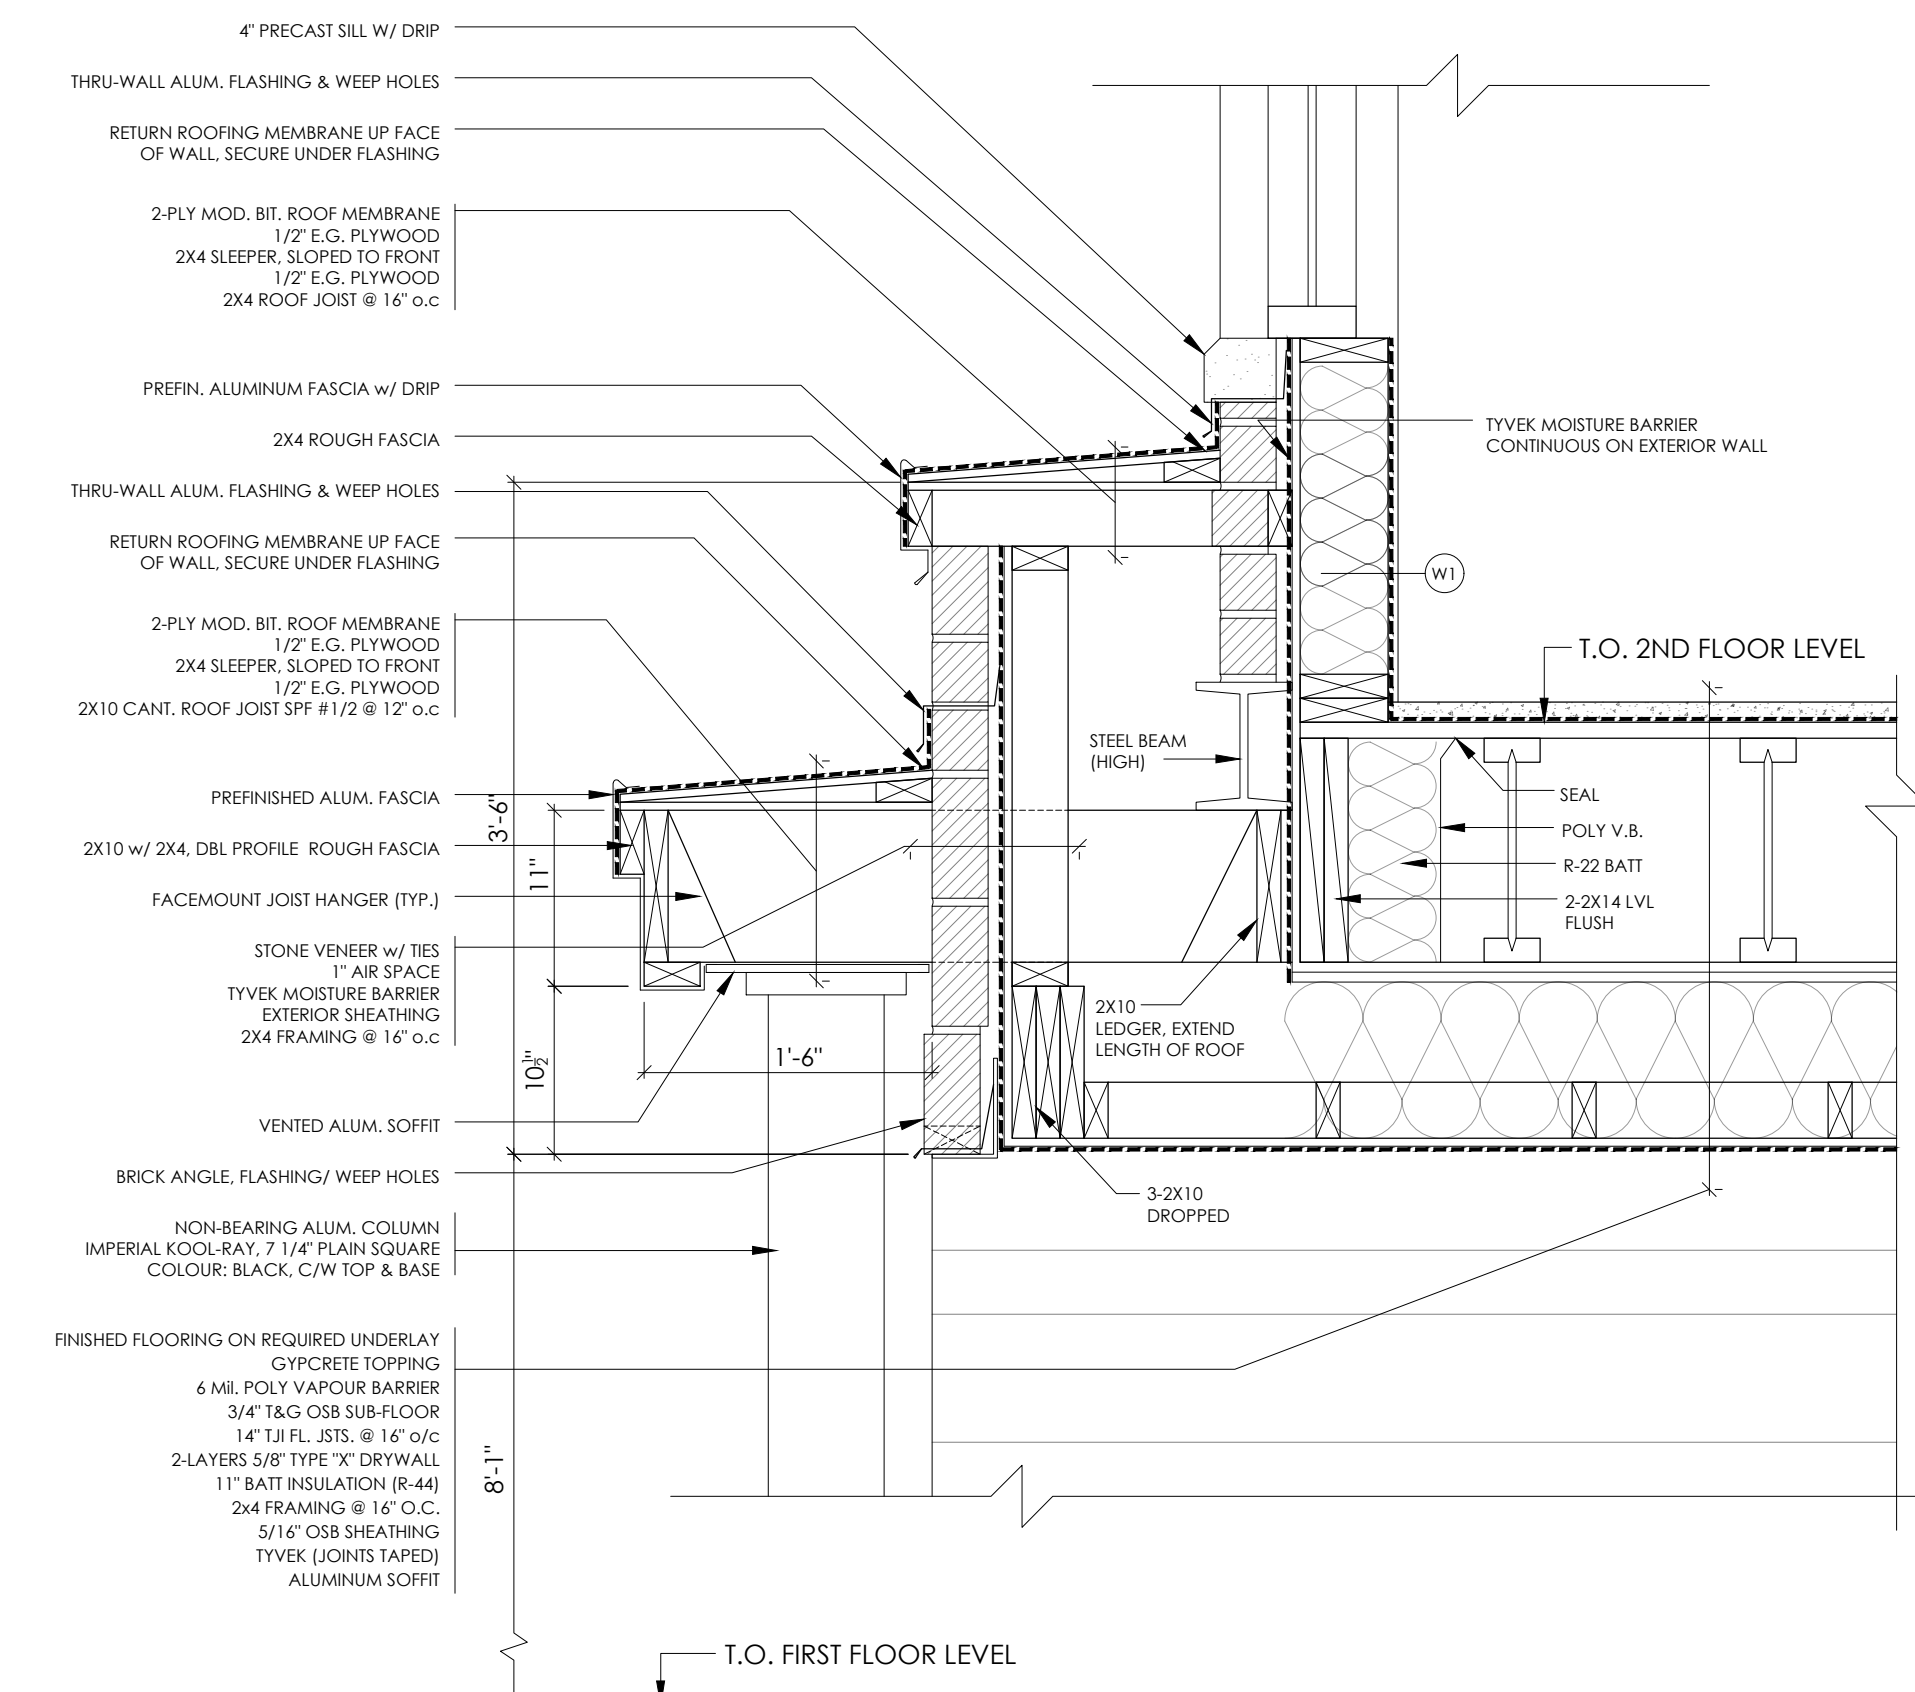
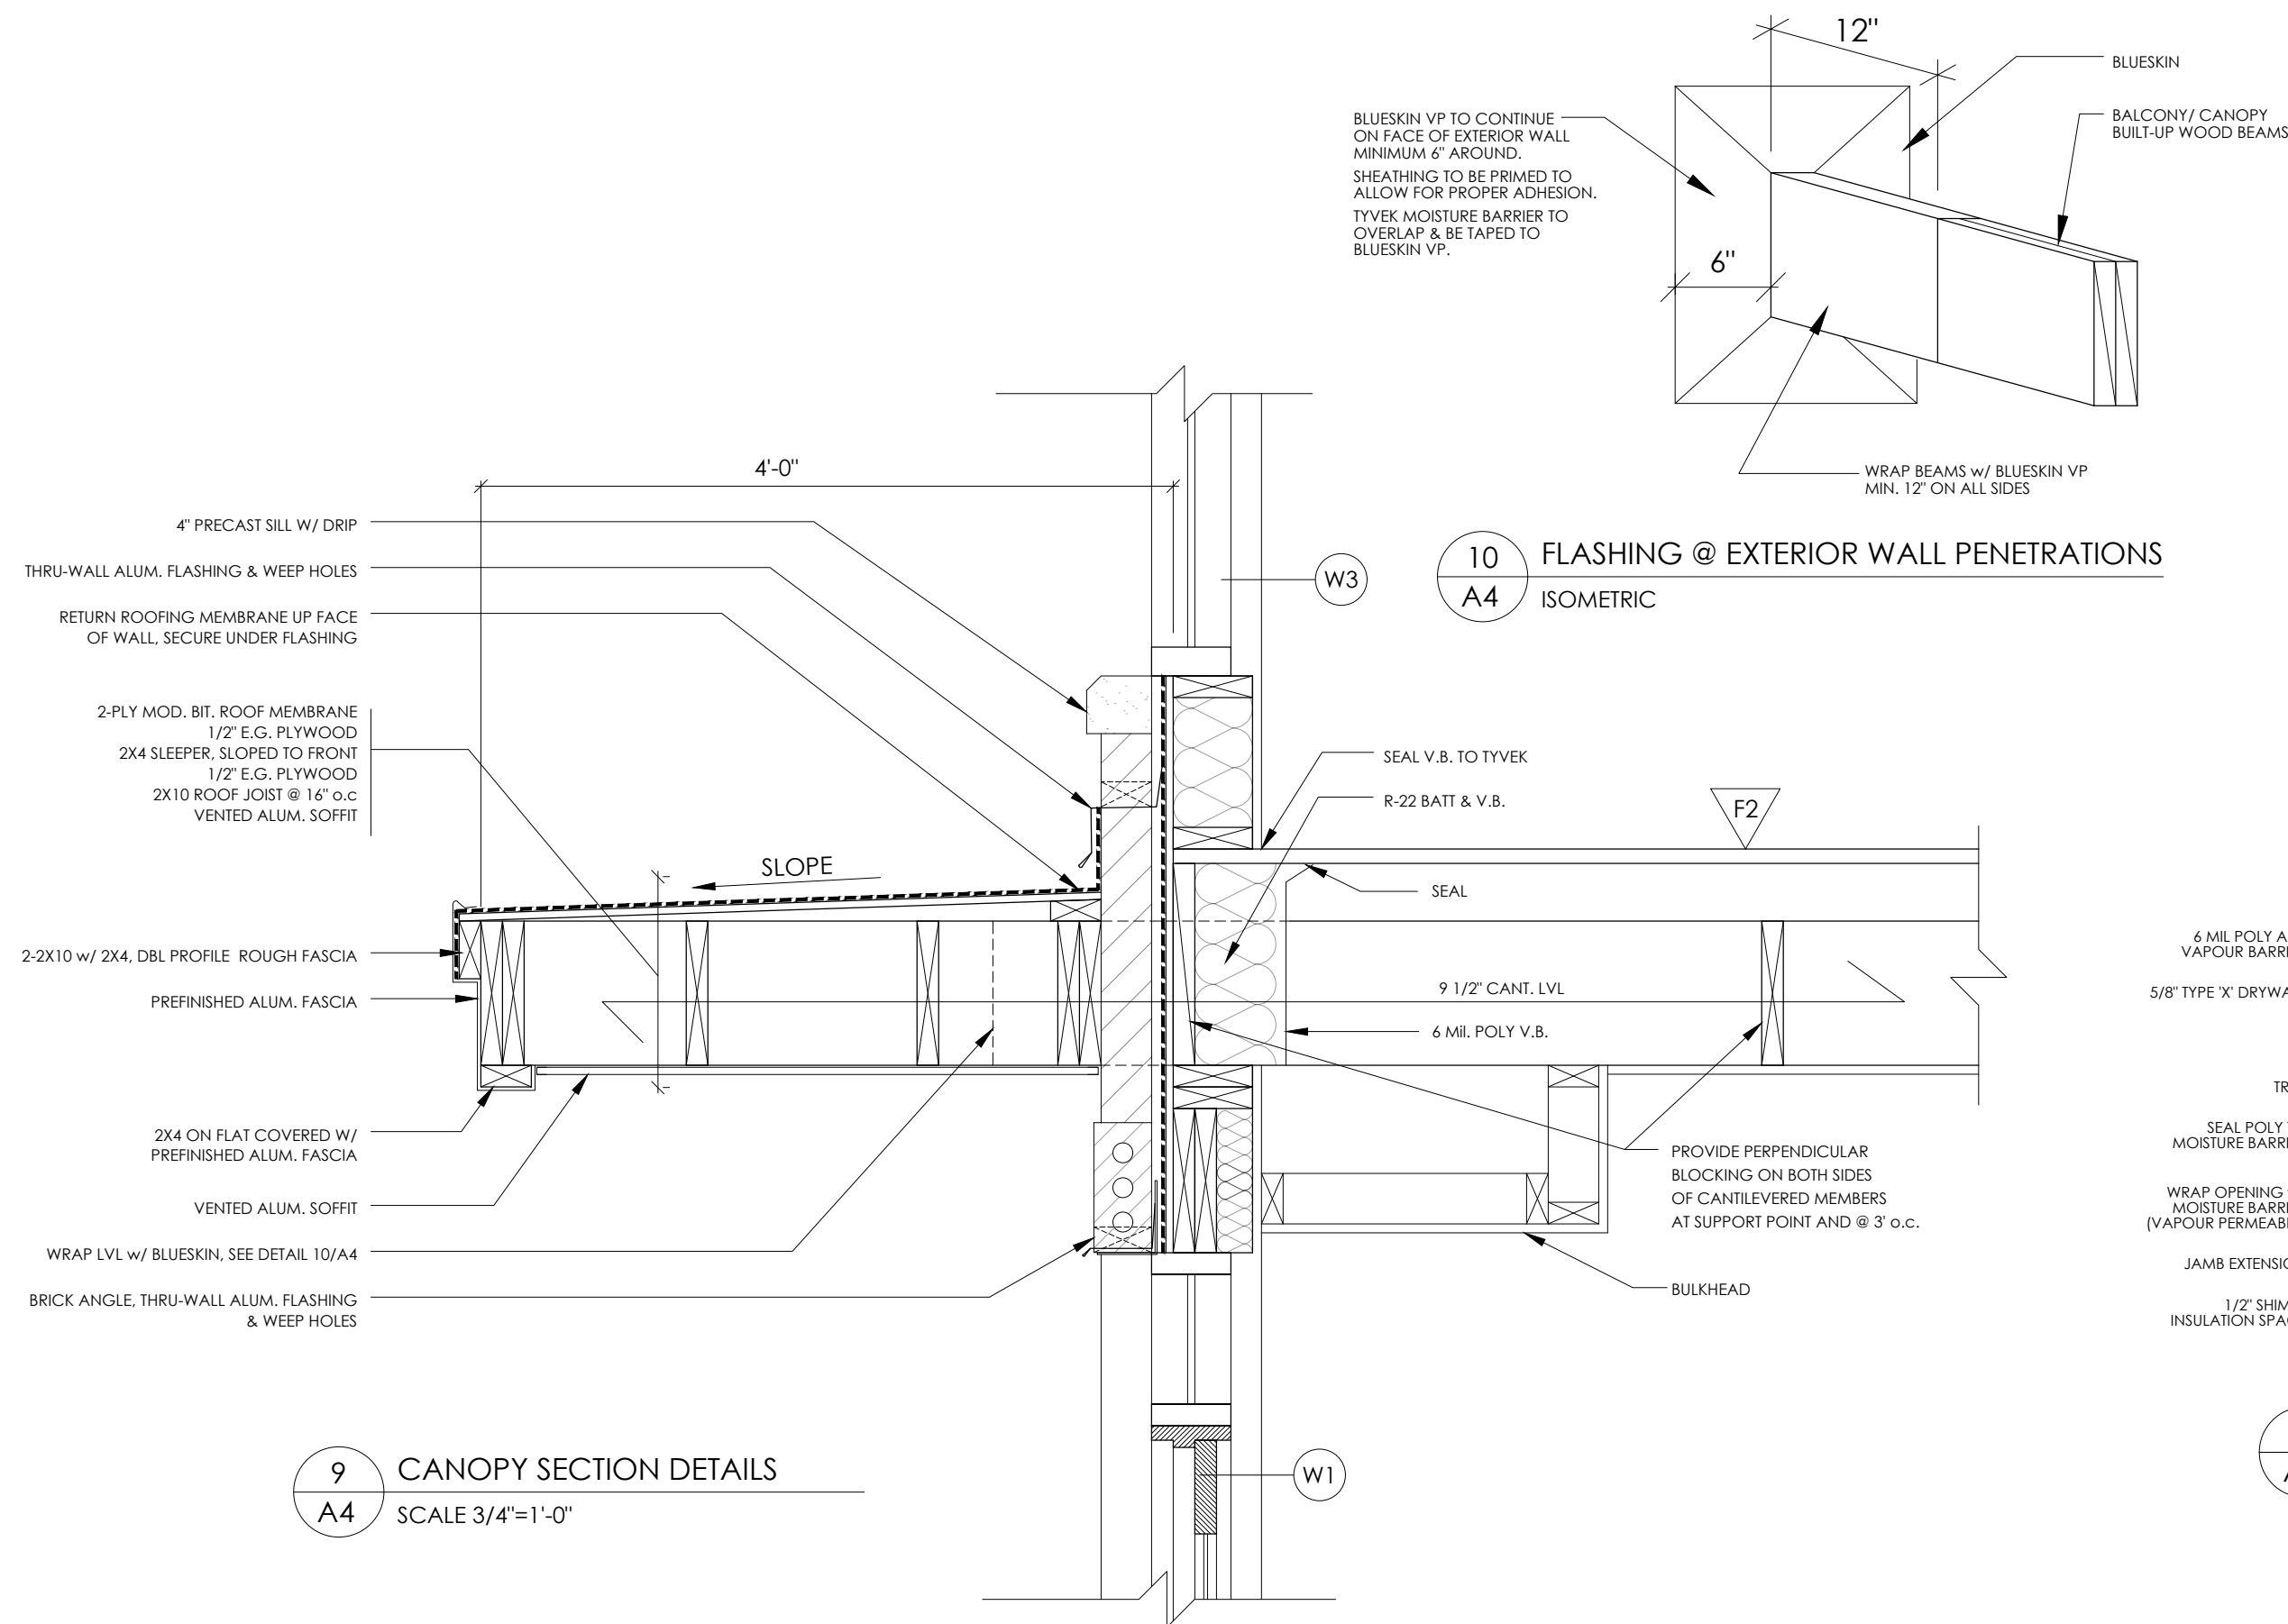
PHOENIX HOMES
18A Bentley Ave Ottawa, ON K2E 6T8

UNIT FLOOR PLANS SCHEDULES




DATE: NOV. 2022
SCALE: 3/16" = 1'-0"
SHEET NO.: A1






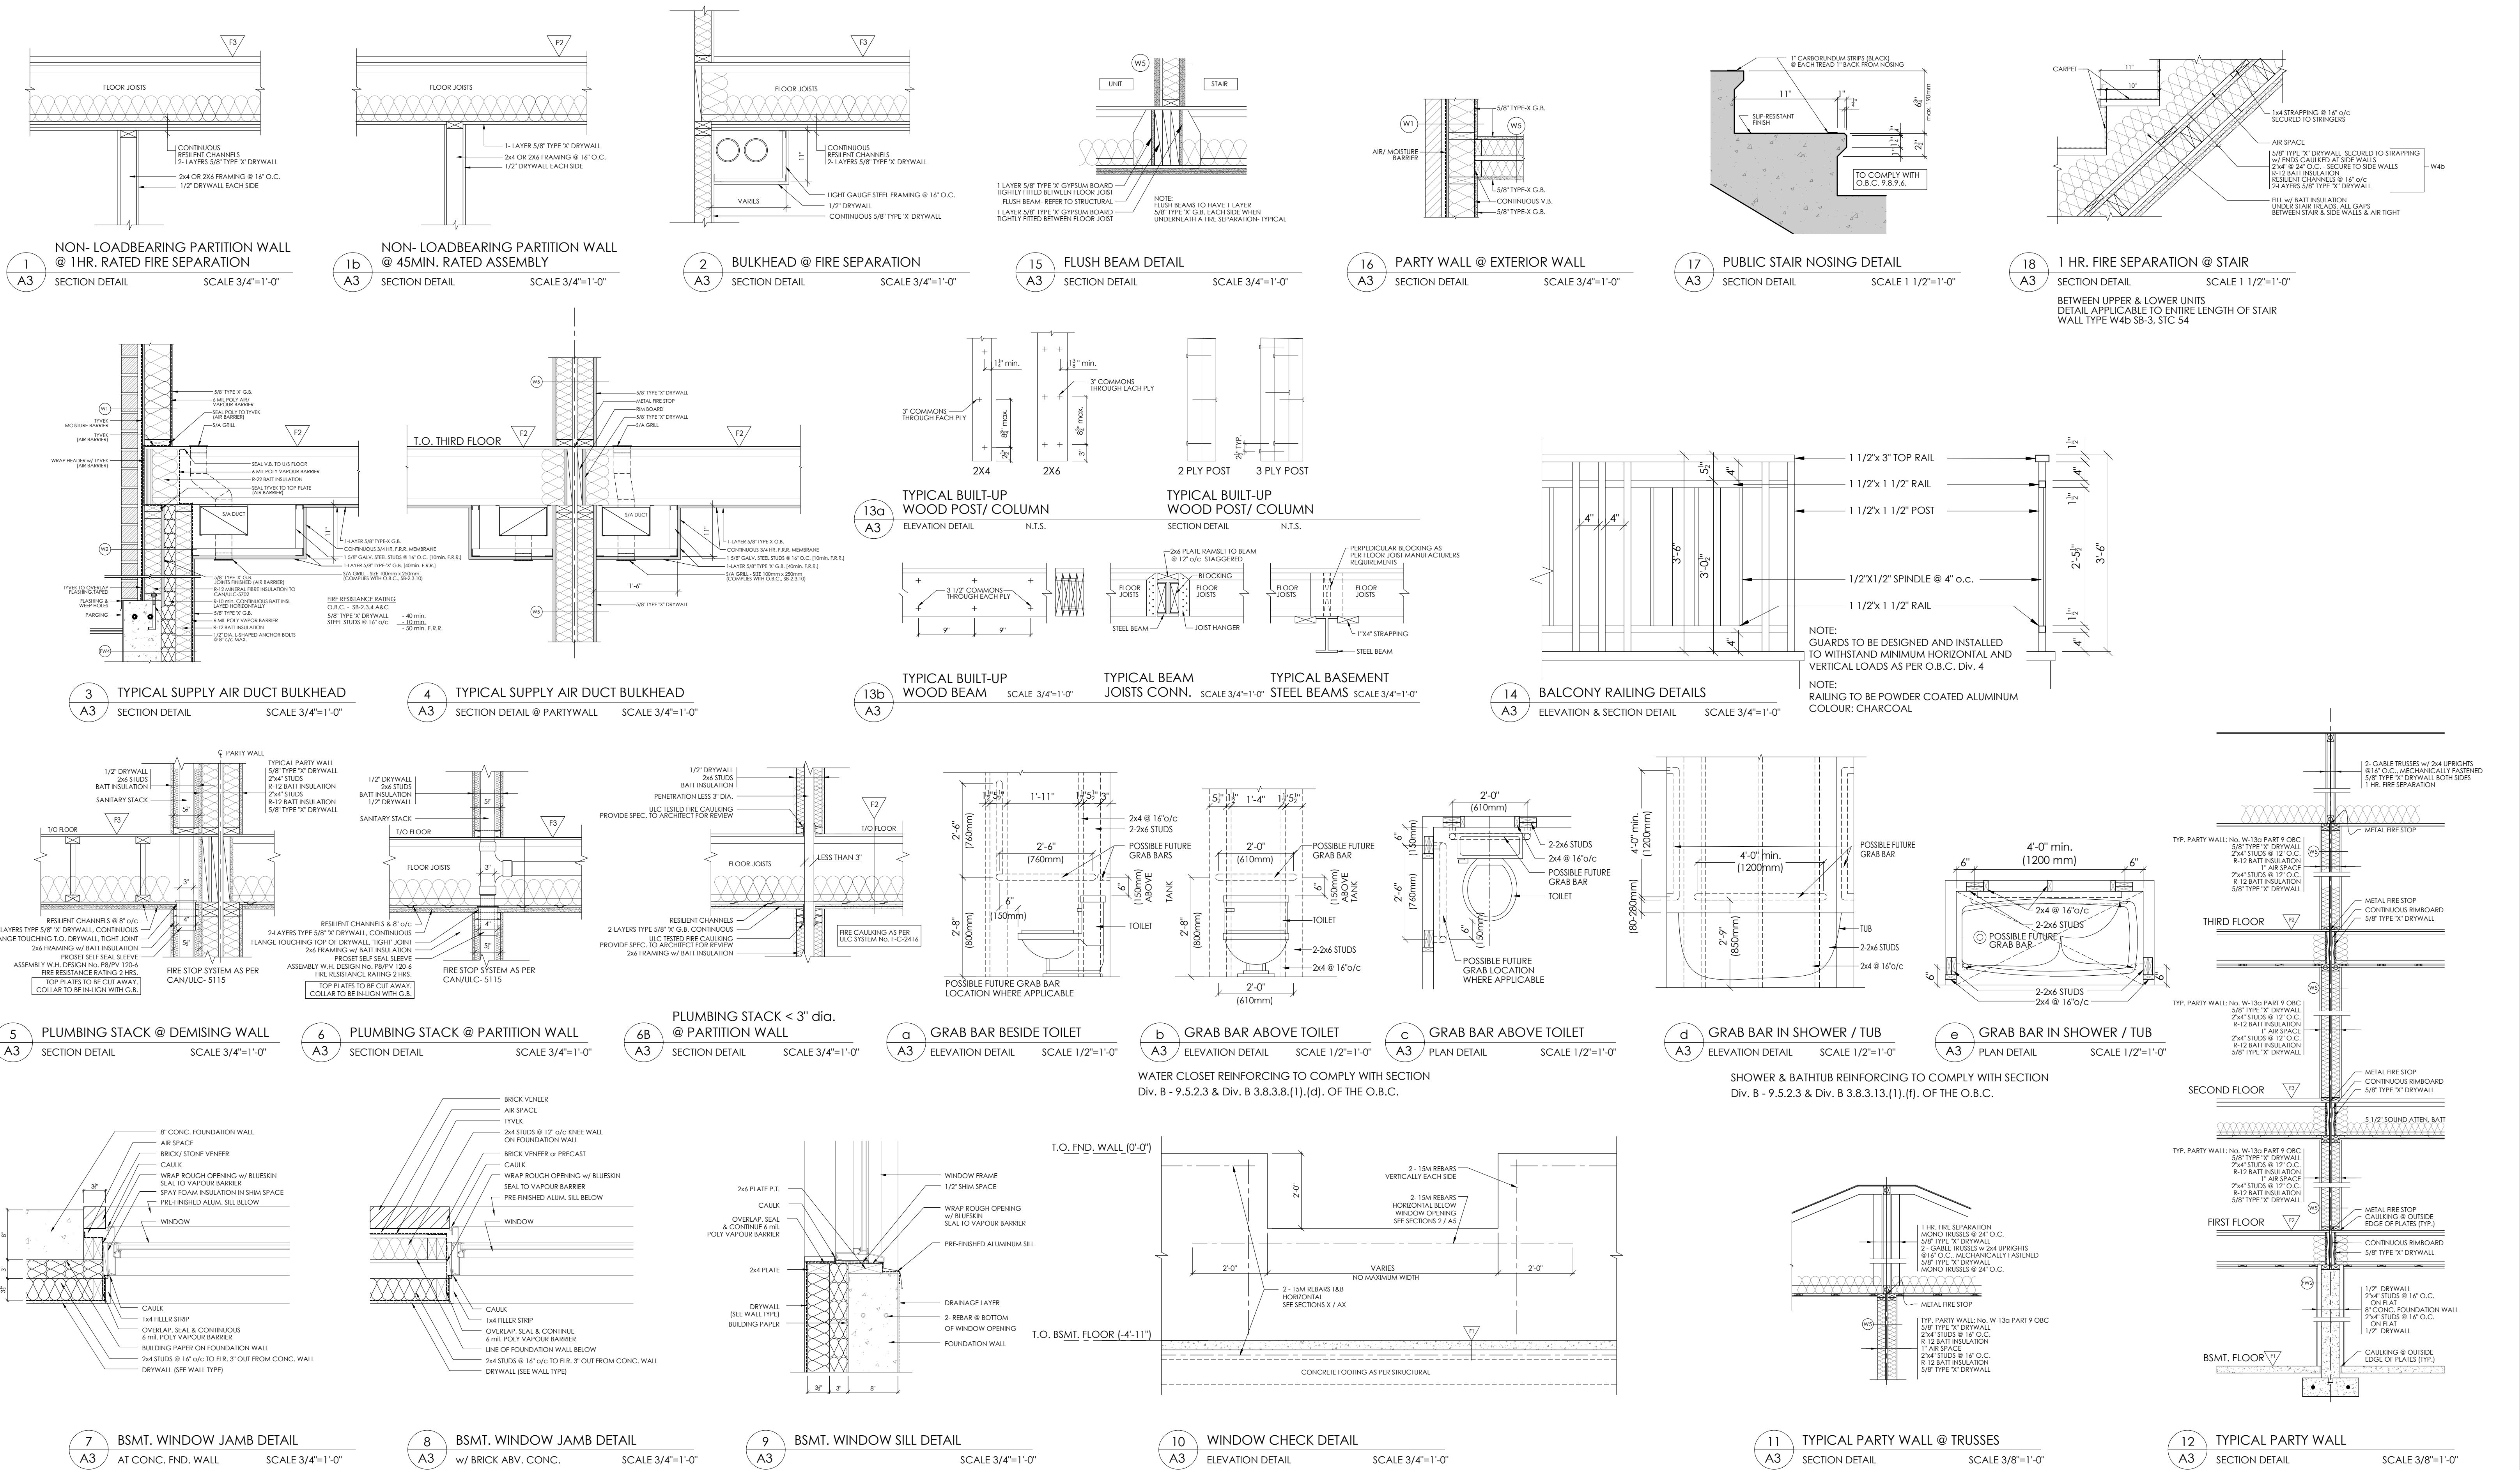


8 PORCH ROOF SECTION DETAIL
SCALE 3/8"=1'-0"

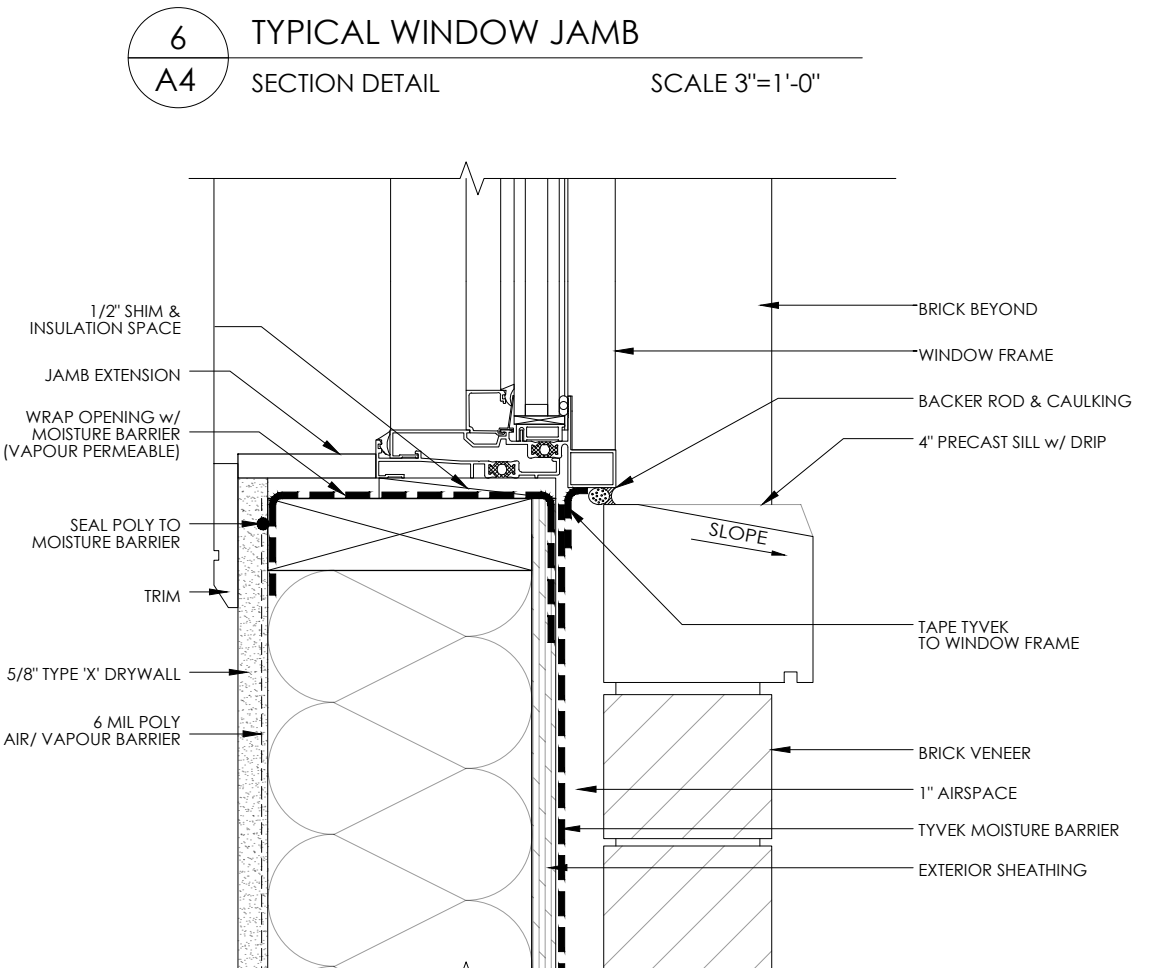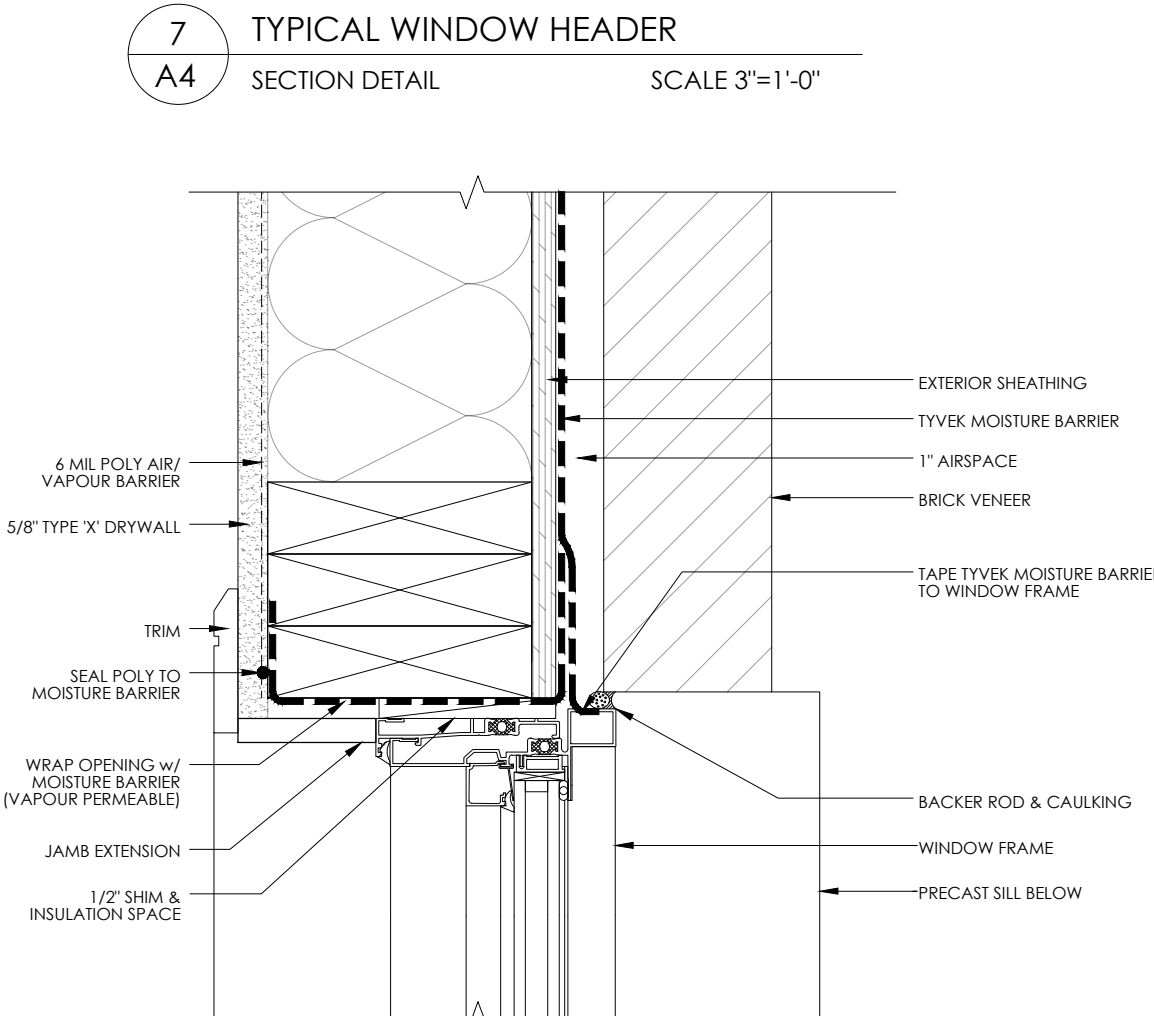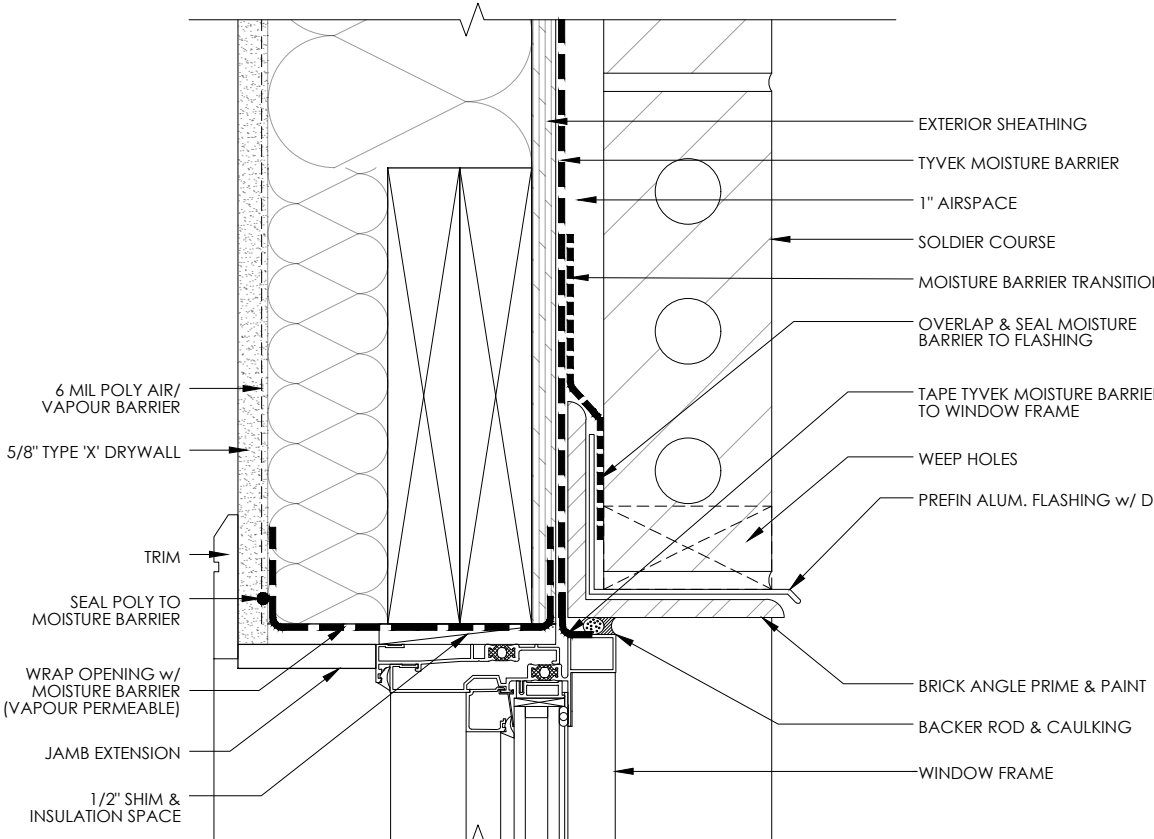


5 TYPICAL WINDOW SILL
SECTION DETAIL SCALE 3"=1'-0"

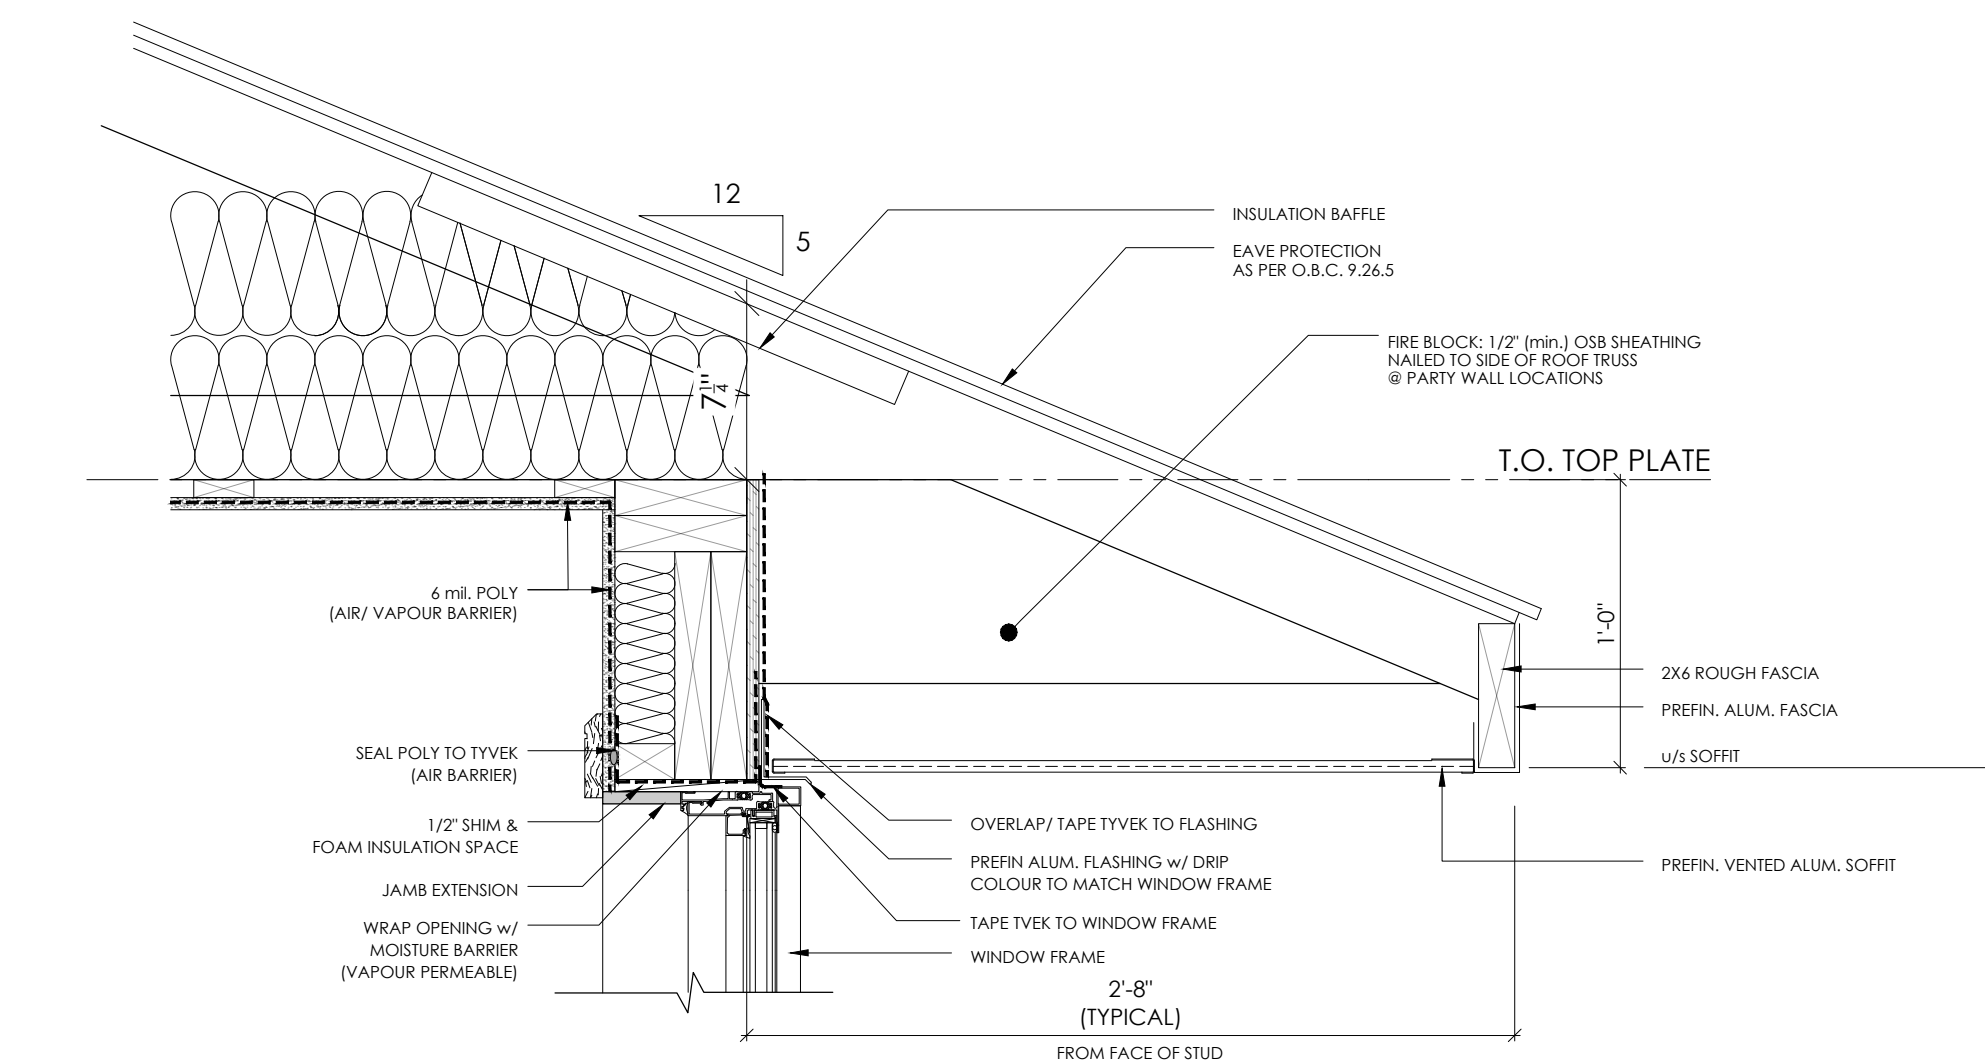


3 TYPICAL TRUSS HEAL
SECTION DETAIL SCALE 1 1/2"=1'-0"

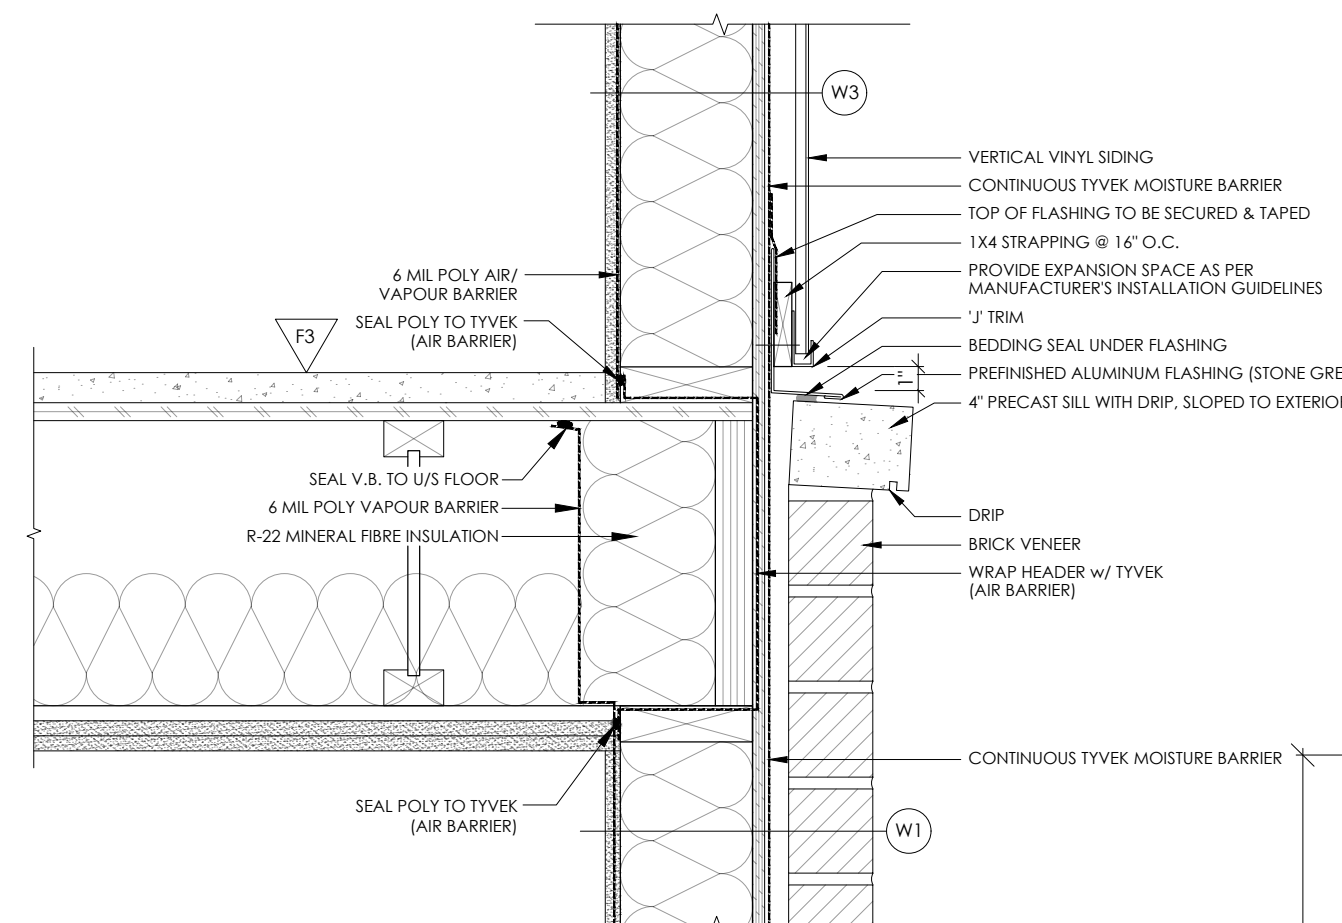


2 TYPICAL FLOOR HEADER
SECTION DETAIL SCALE 1 1/2"=1'-0"

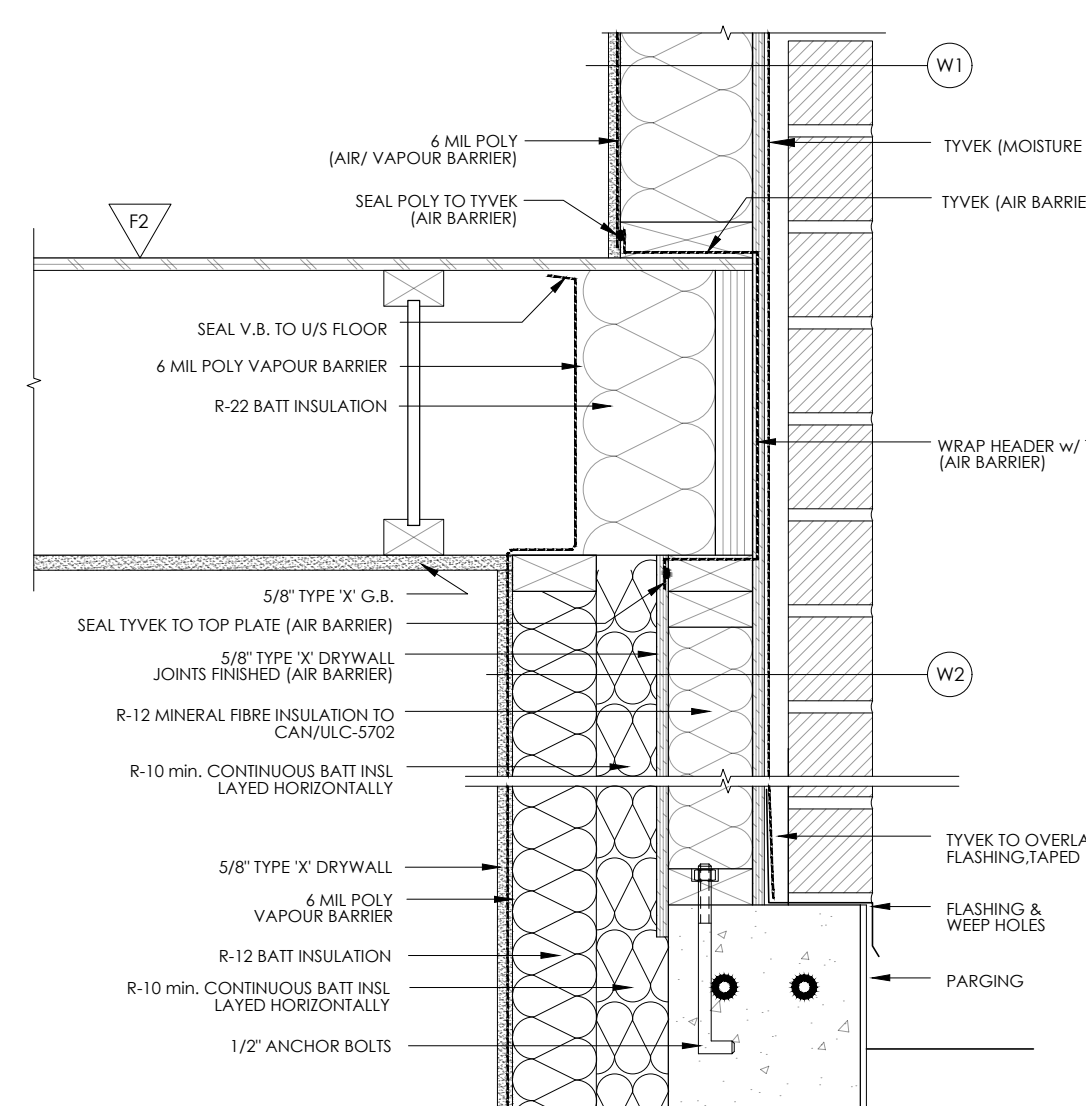

1 TYPICAL FLOOR HEADER w/ BRICK
SECTION DETAIL SCALE 1 1/2"=1'-0"

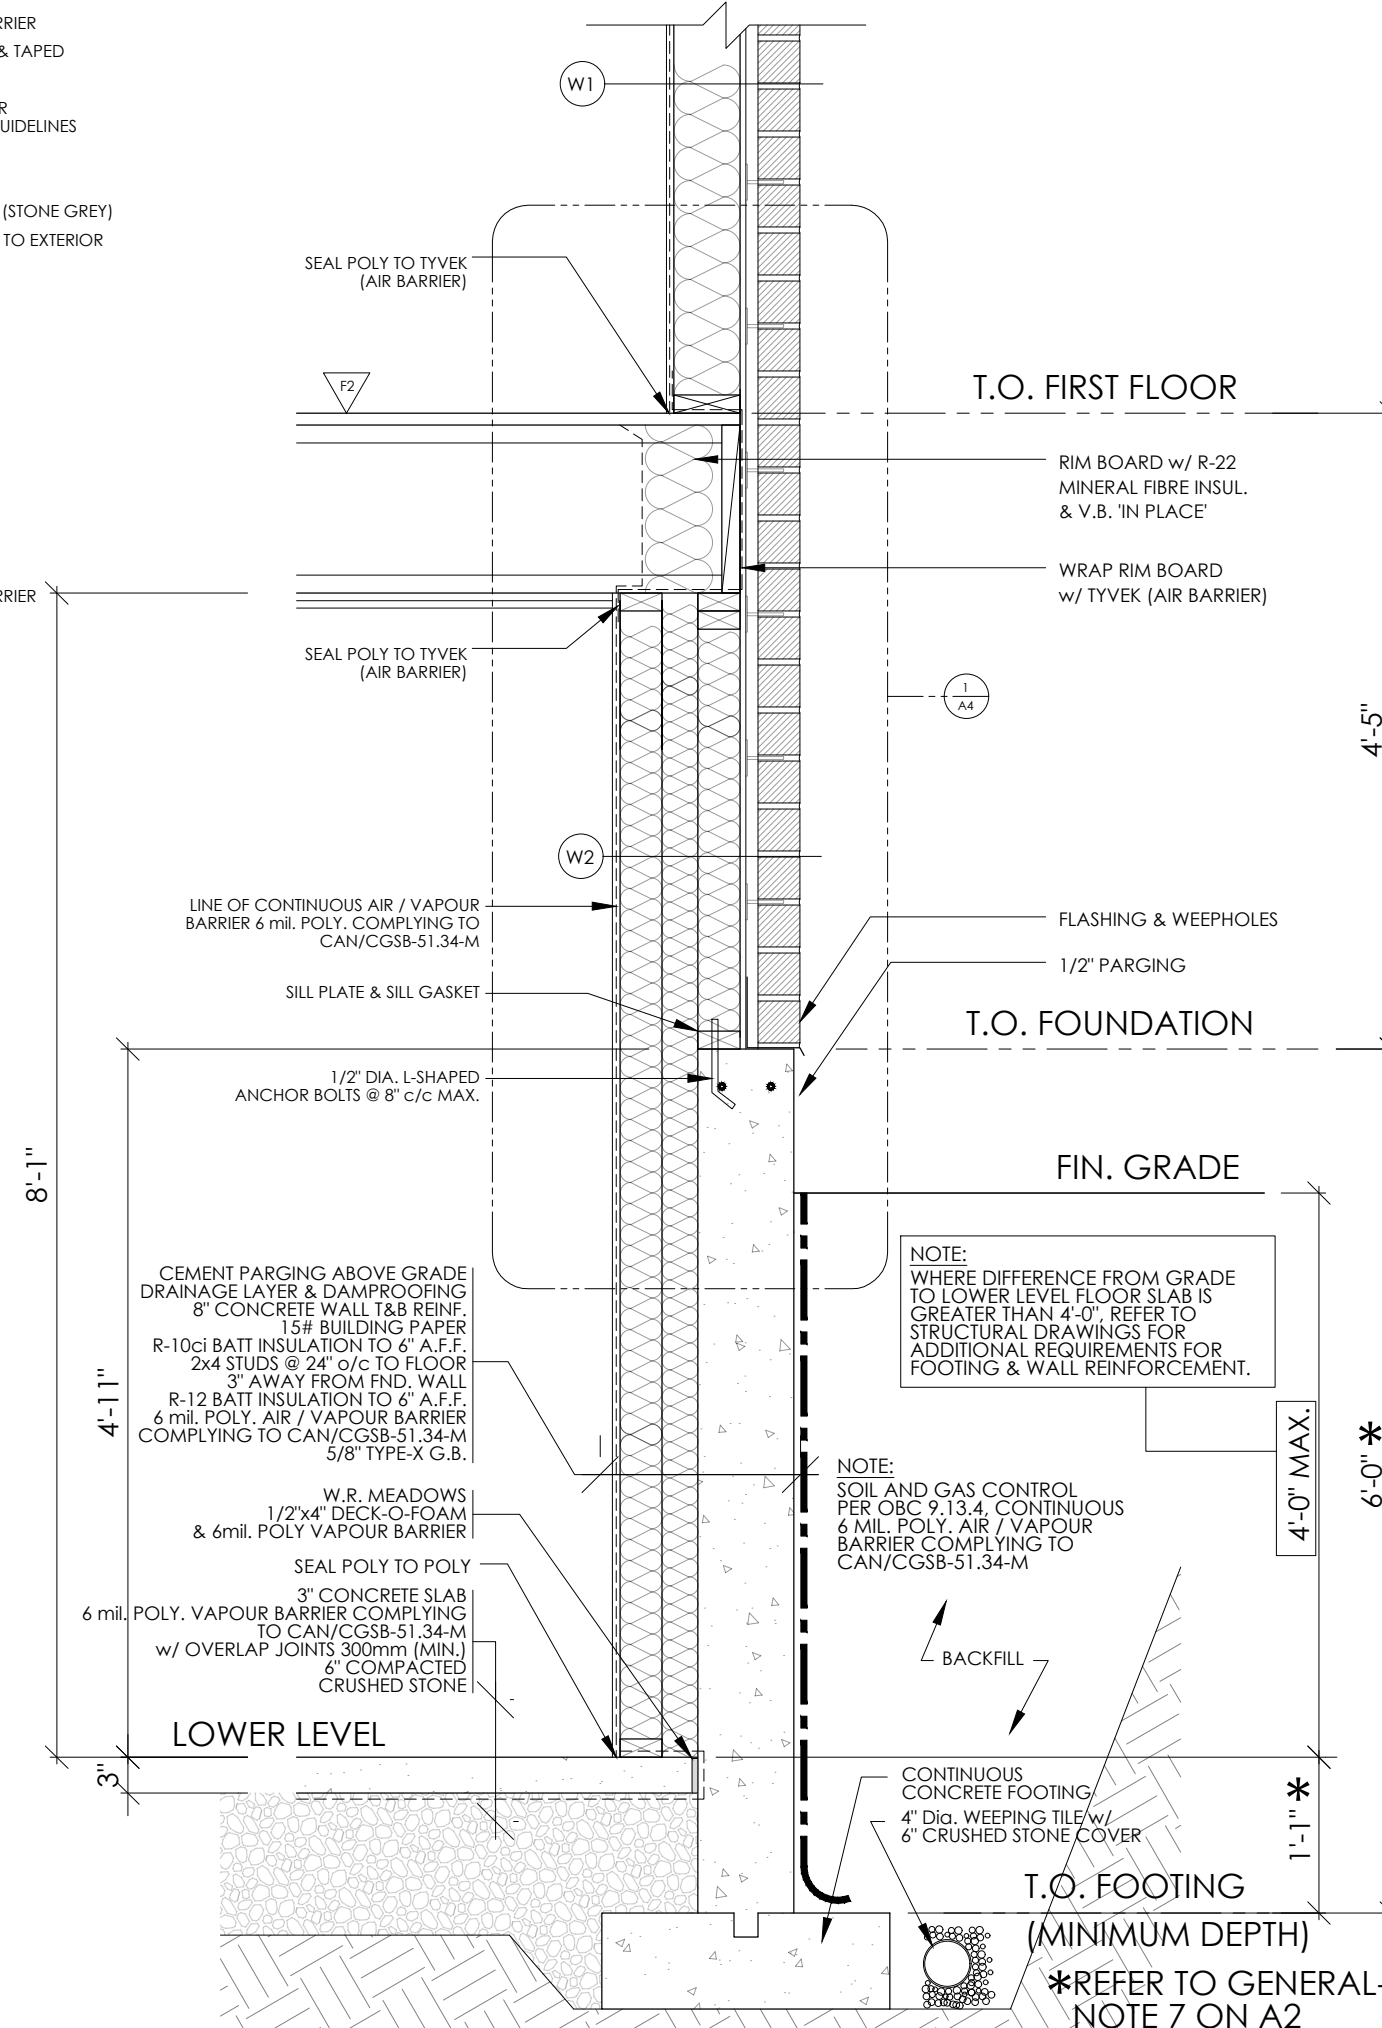

4 TYPICAL END WALL w/ BRICK
SECTION DETAIL SCALE 3/8"=1'-0"

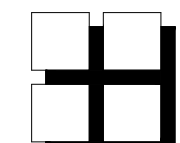

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Architect Inc.

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POST SCHEDULE

- P1 - 3" DIA. ADJUSTABLE STEEL TELEPOST
8500 POUND CAP. (MIN.)
P2 - 2"X4, 6 OR 8" (AS APPLICABLE)
P4 - 4"X4, 6 OR 8" (AS APPLICABLE)
P5 - 5"X4, 6 OR 8" (AS APPLICABLE)
P7 - HSS 4"x4"x .188" C/W 5/16"x8" PL. & CAP PL.
P8 - P1, 8"x8" SPP#1, C/W SIMPSON POST BASES
- NOTE:
ALL WOOD POST LOCATIONS TO BE BLOCKED SOLID THRU FLOOR STRUCTURE ON TO A STEEL WOOD BEAM OR ON TO THE CONC. FOUNDATION WALL

LINTEL / BEAM SCHEDULE

- SIZES INDICATED ON PLANS
- BRICK LINTELS
OPENINGS UP TO
5'-0"
5'-0"
6'-0"
10'-0"
6" MIN. BEARING EACH END
ALL ANGLES TO BE HOT DIPPED GALVANIZED
- L SIZE
L 3 1/2" x 3 1/2" x 5/16"
L 4" x 3 1/2" x 5/16"
L 5" x 3 1/2" x 5/16"
L 5" x 3 1/2" x 7/16"
L 6" x 4" x 7/16"

NOTE:

- WALLS / HEADERS / POST TO BE SPP NO. 1 (IND. 2)
- NOTE:
FASTER ALL ROOF AND WALL SHEATHING WITH MINIMUM 2 1/2" LONG COMMON OR SPIRAL NAILS SPACED AT 6" C/C AROUND PANEL PERIMETER AND AT 12" C/C ALONG INTERMEDIATE SUPPORTS.
- NOTE:
INDICATED JOIST HANGERS ARE A MINIMUM SIZE. JOIST TRUSS DESIGNER MAY PROVIDE ALTERNATIVE HANGERS WITH GREATER OR EQUAL SHEAR AND UPLIFT CAPACITIES.


STRUCTURAL ENGINEER:
Cleland Jarline Engineering Ltd
580 Terry Fox Dr. Kanata, ON
K0L 4B7 (613) 591-1533

SEAL



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NO.	DATE	DESCRIPTION	REVISIONS
1.	12/09/24	WASHROOMS REVISED. RE-ISSUED FOR CONSTRUCTION	MB
2.	06/08/24	ISSUED FOR CONSTRUCTION	MB
3.	03/02/24	BUILDINGS 7&8- AS PER STRUCTURAL REISSUED FOR PERMIT	MB
4.	10/01/24	BUILDINGS 7&8- AS PER STRUCTURAL/ M&E, FOR PERMIT	MB
5.	24/08/23	BUILDINGS 7&8- FOR STRUCTURAL/ M&E REVIEW	MB
6.	13/06/23	BUILDINGS 9&10- ISSUED FOR CONSTRUCTION	MB
7.	27/01/23	BUILDINGS 9&10- AS PER STRUCTURAL, FOR PERMIT	MB
8.	21/11/22	BUILDINGS 9&10- FOR STRUCTURAL/ M&E REVIEW	MB
9.			

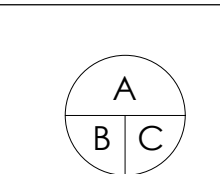

- A - DETAIL NUMBER
B - SHEET NUMBER (DETAIL REQUIRED)
C - SHEET NUMBER (DETAIL LOCATION)

PROJECT:
BACK-TO-BACK STACKED TERRACE HOMES THE JUNCTION
2740 CEDARVIEW RD., OTTAWA, ONTARIO

CLIENT:
PHOENIX HOMES
18A Bentley Ave Ottawa, ON K2E 6T8

DRAWING TITLE:

NOV. 2022

DRAWN BY:
mdb



SCALE:
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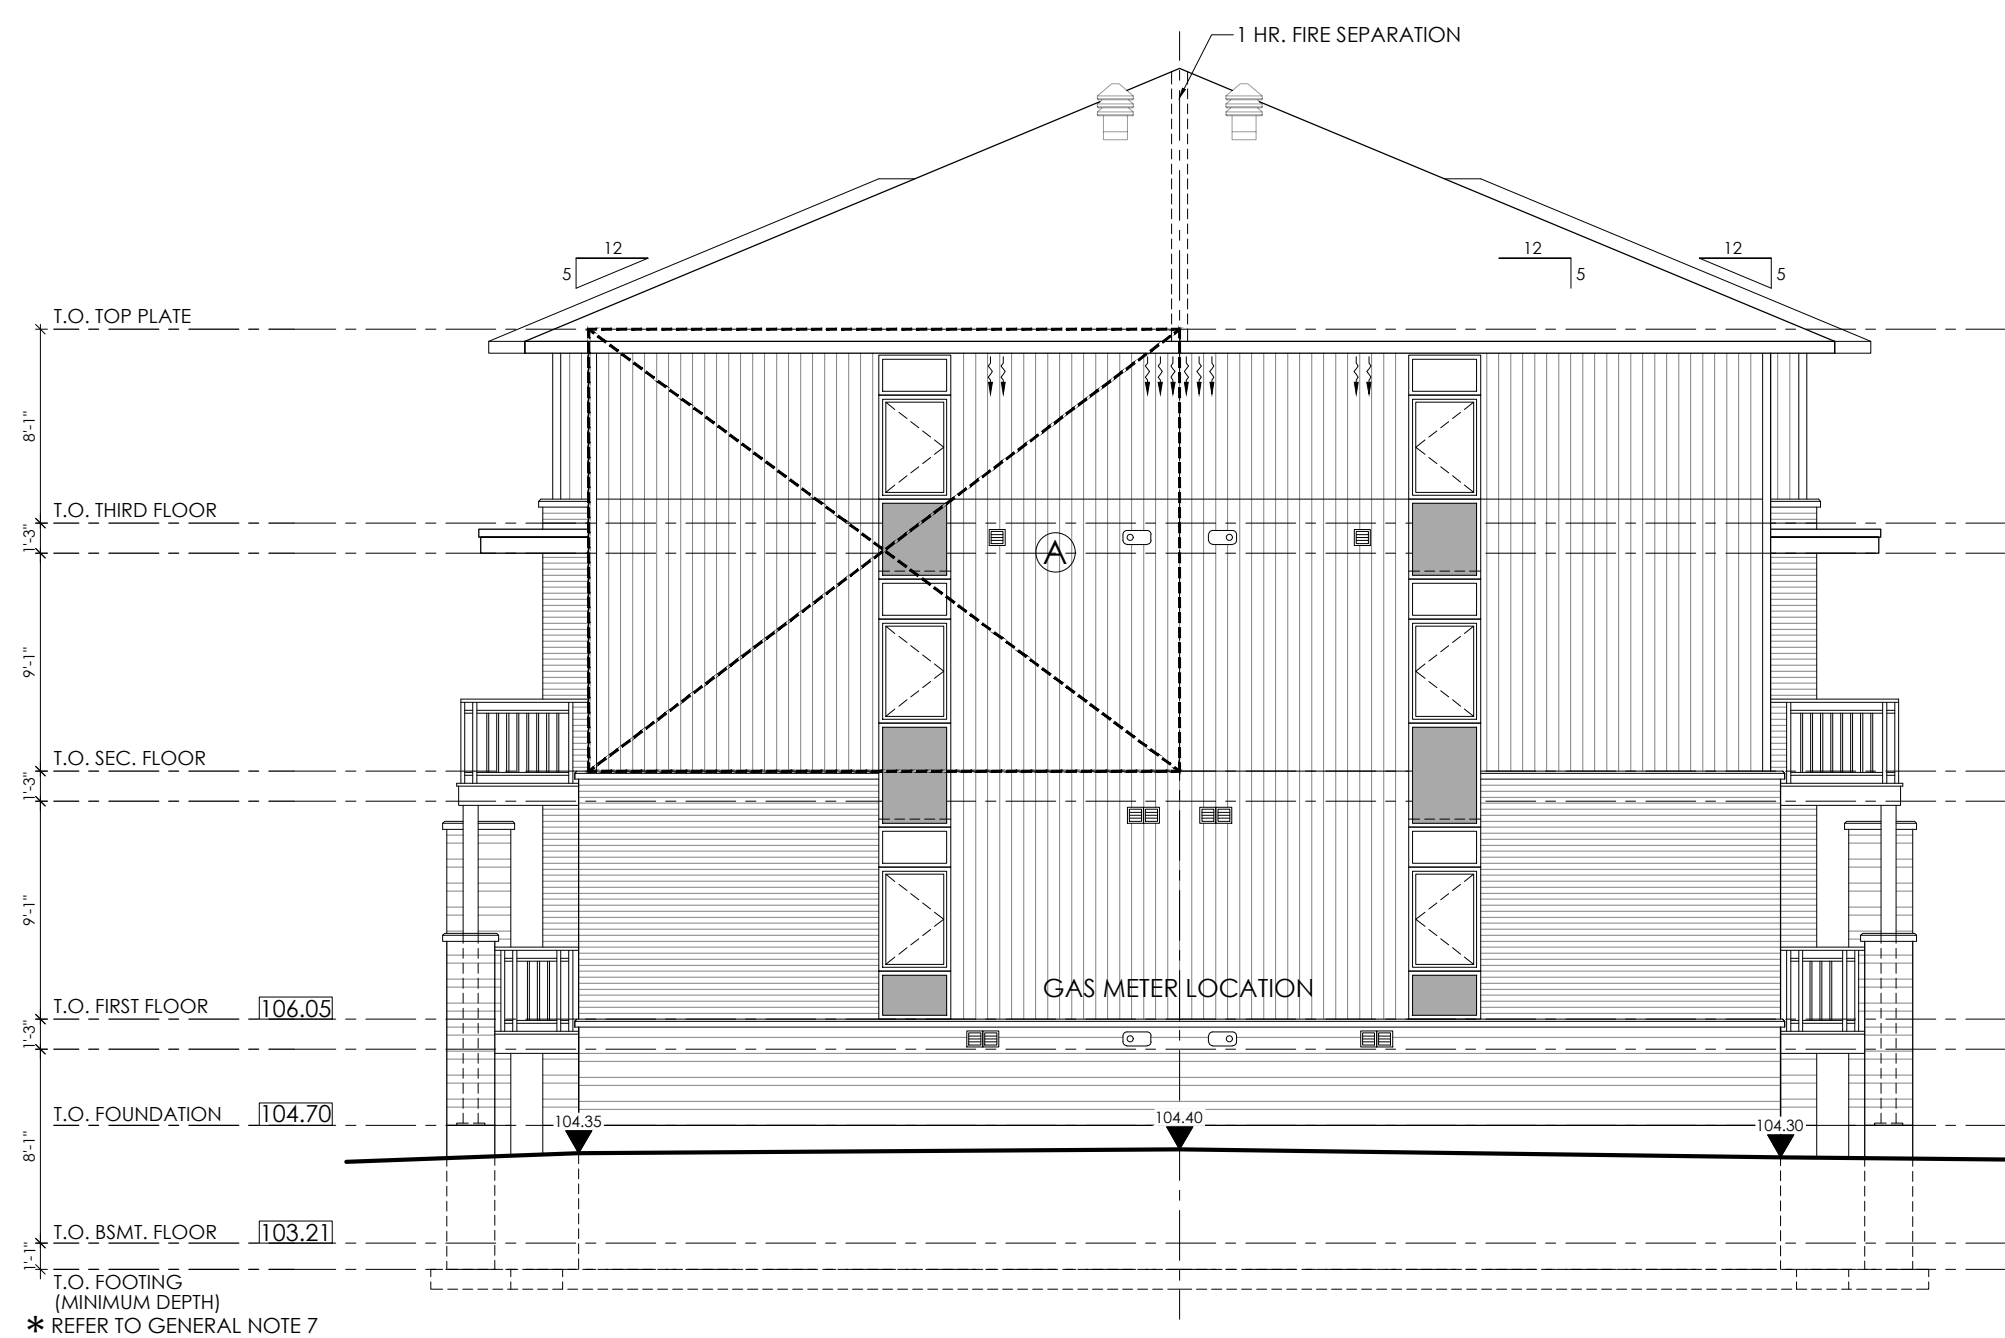
DETAILS/ SECTIONS

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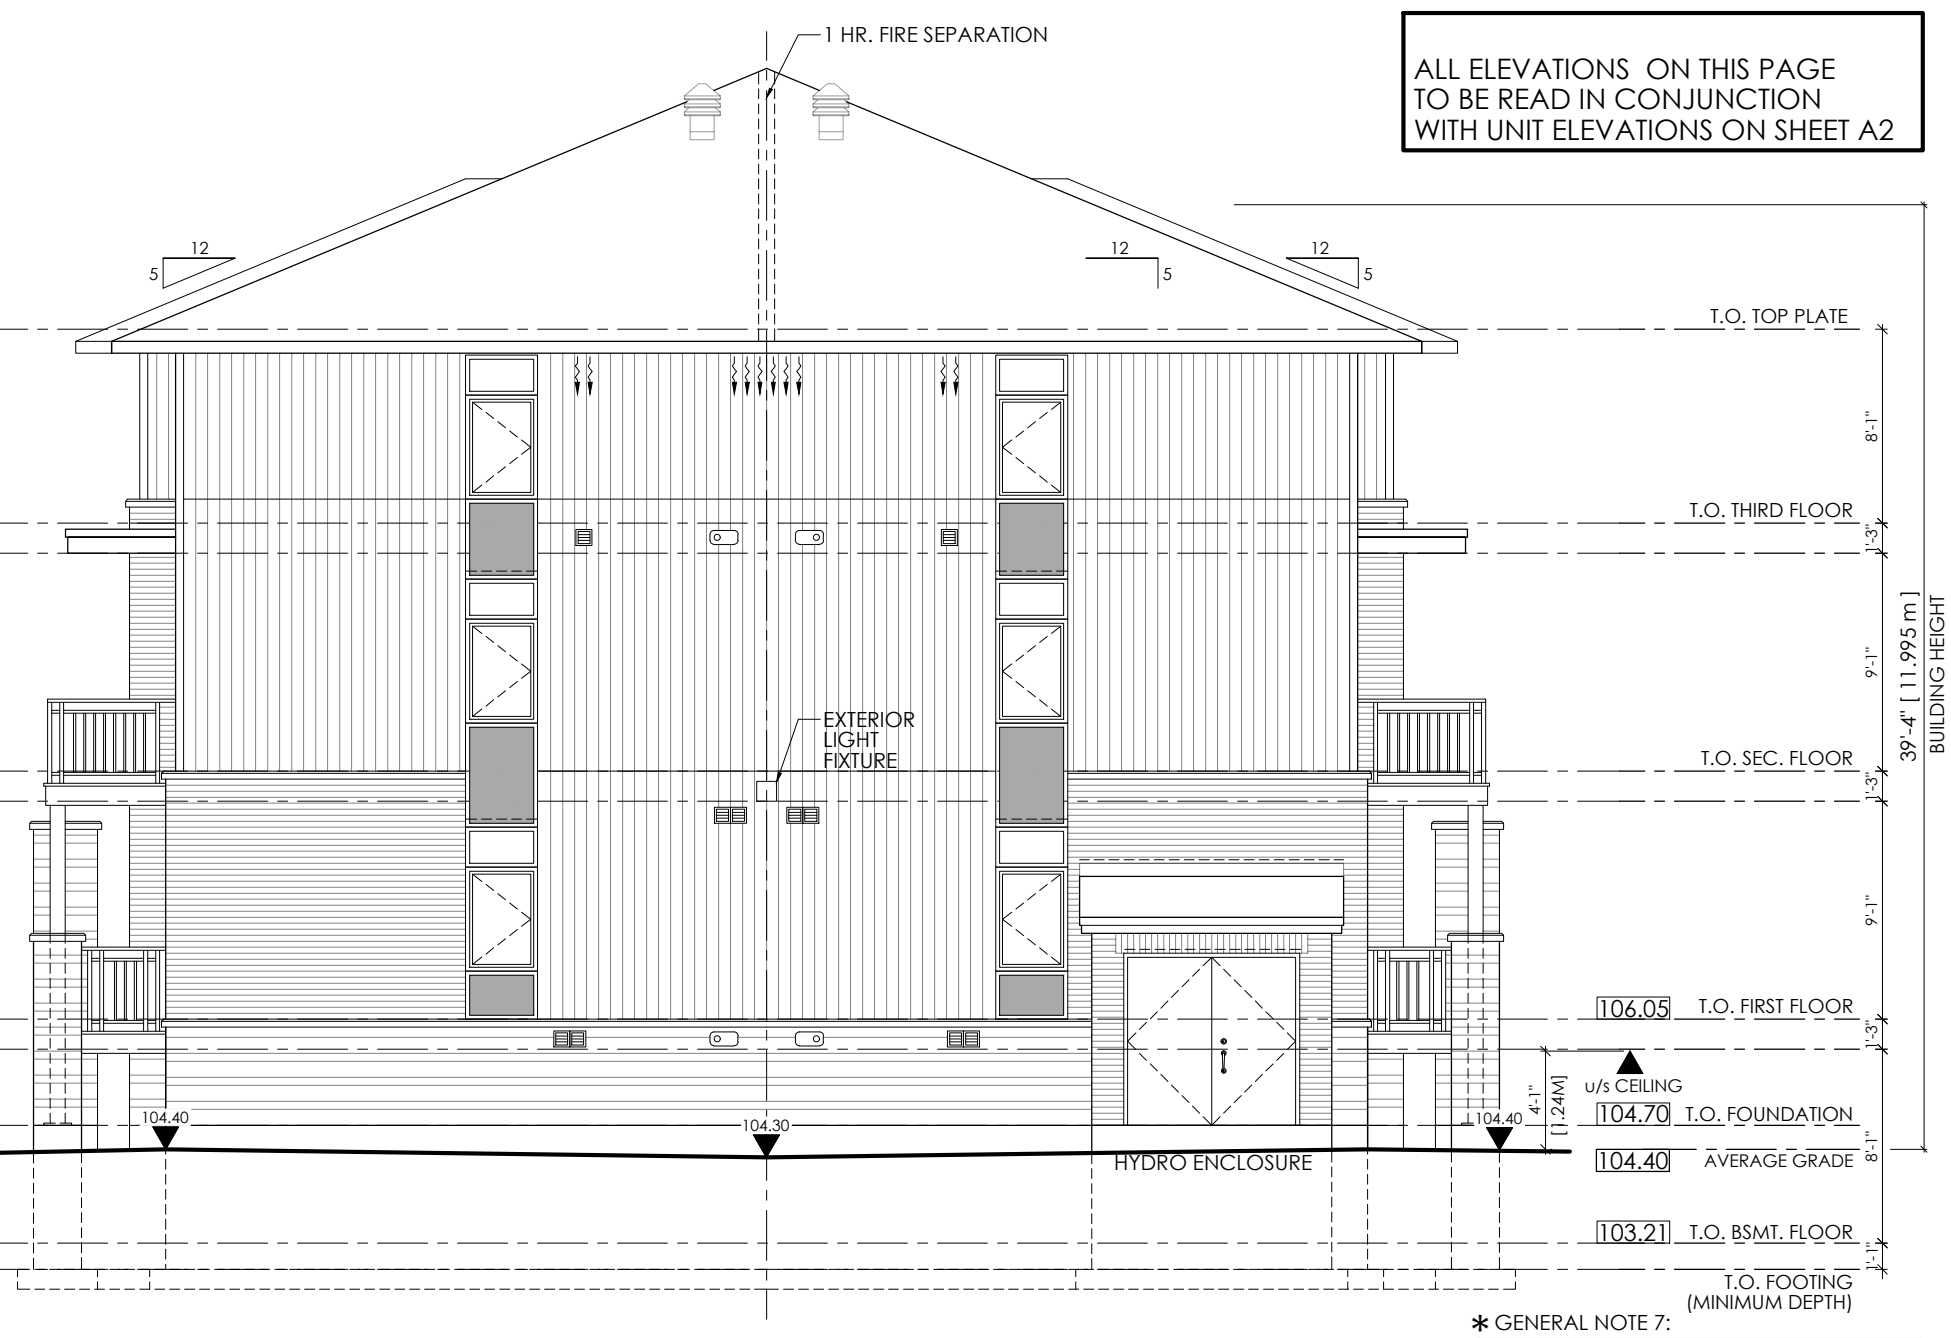


* GENERAL NOTE 7:
NOTE:
ALL FOOTINGS ARE TO BE PLACED ON SOLS APPROVED BY GEOTECHNICAL ENGINEER, CIVIL ENGINEER, AND STRUCTURAL ENGINEER.
NOTE:
SITE TO COORDINATE DEPTH OF FOOTINGS AS PER CIVIL, GEOTECHNICAL, AND STRUCTURAL ENGINEERS' REQUIREMENTS.
NOTE:
INSULATION @ FOOTINGS AS PER GEOTECHNICAL ENGINEERS SPECIFICATION
NOTE:
REFER TO SOILS REPORT FOR UNDER-SLAB DRAINAGE REQUIREMENTS


ALL ELEVATIONS ON THIS PAGE TO BE READ IN CONJUNCTION WITH UNIT ELEVATIONS ON SHEET A2

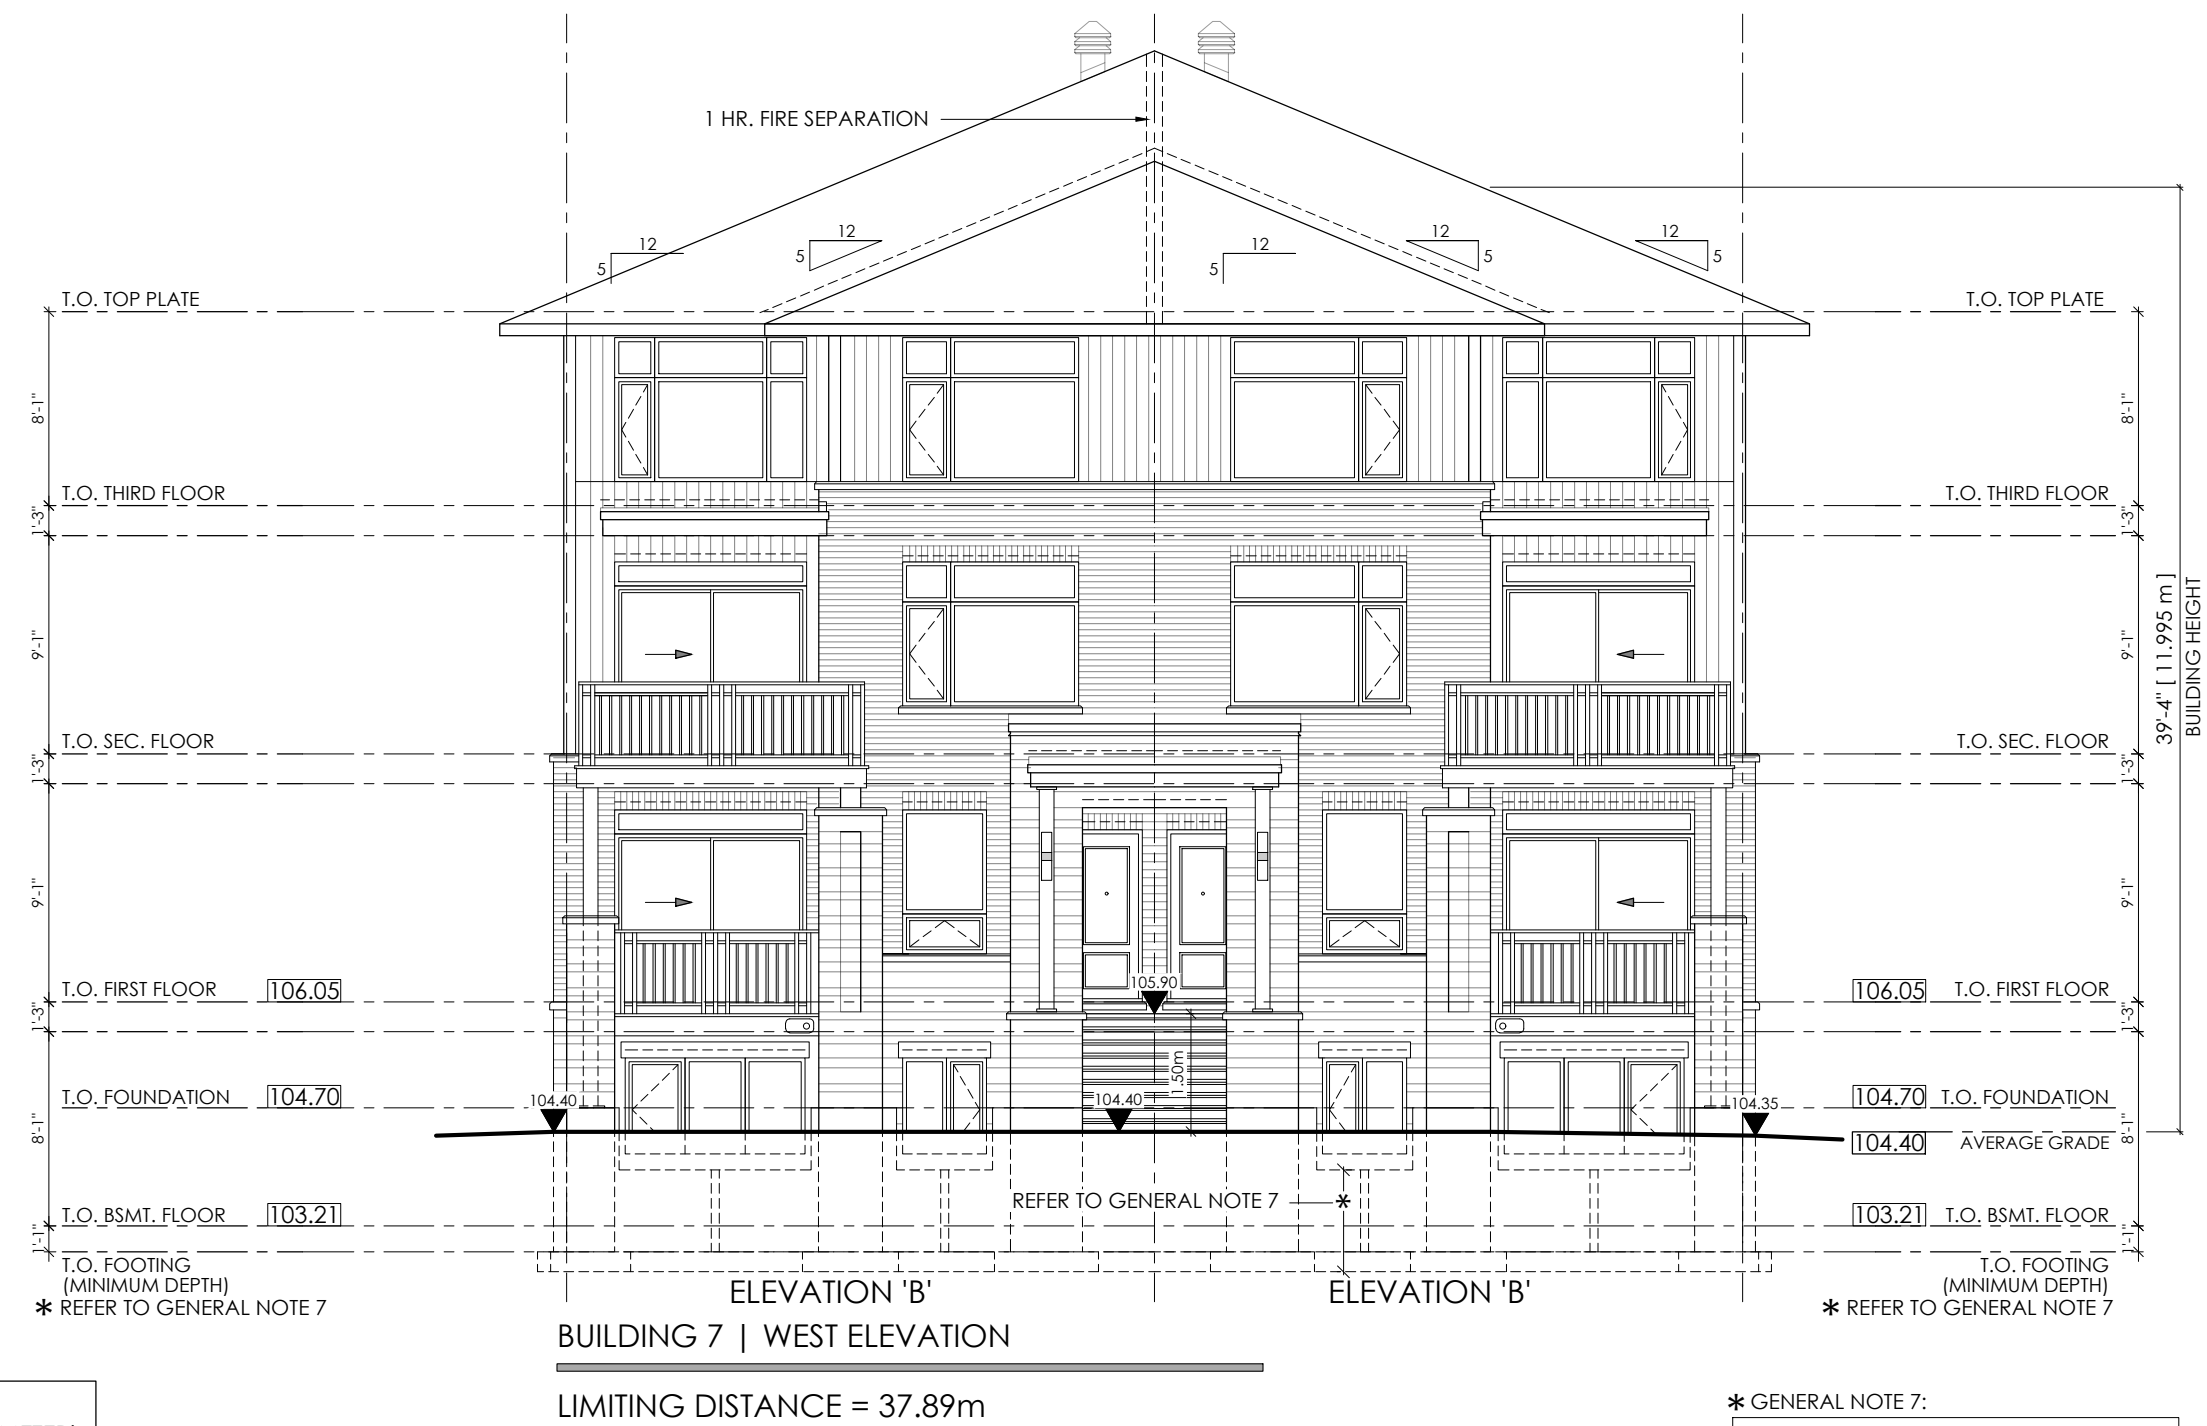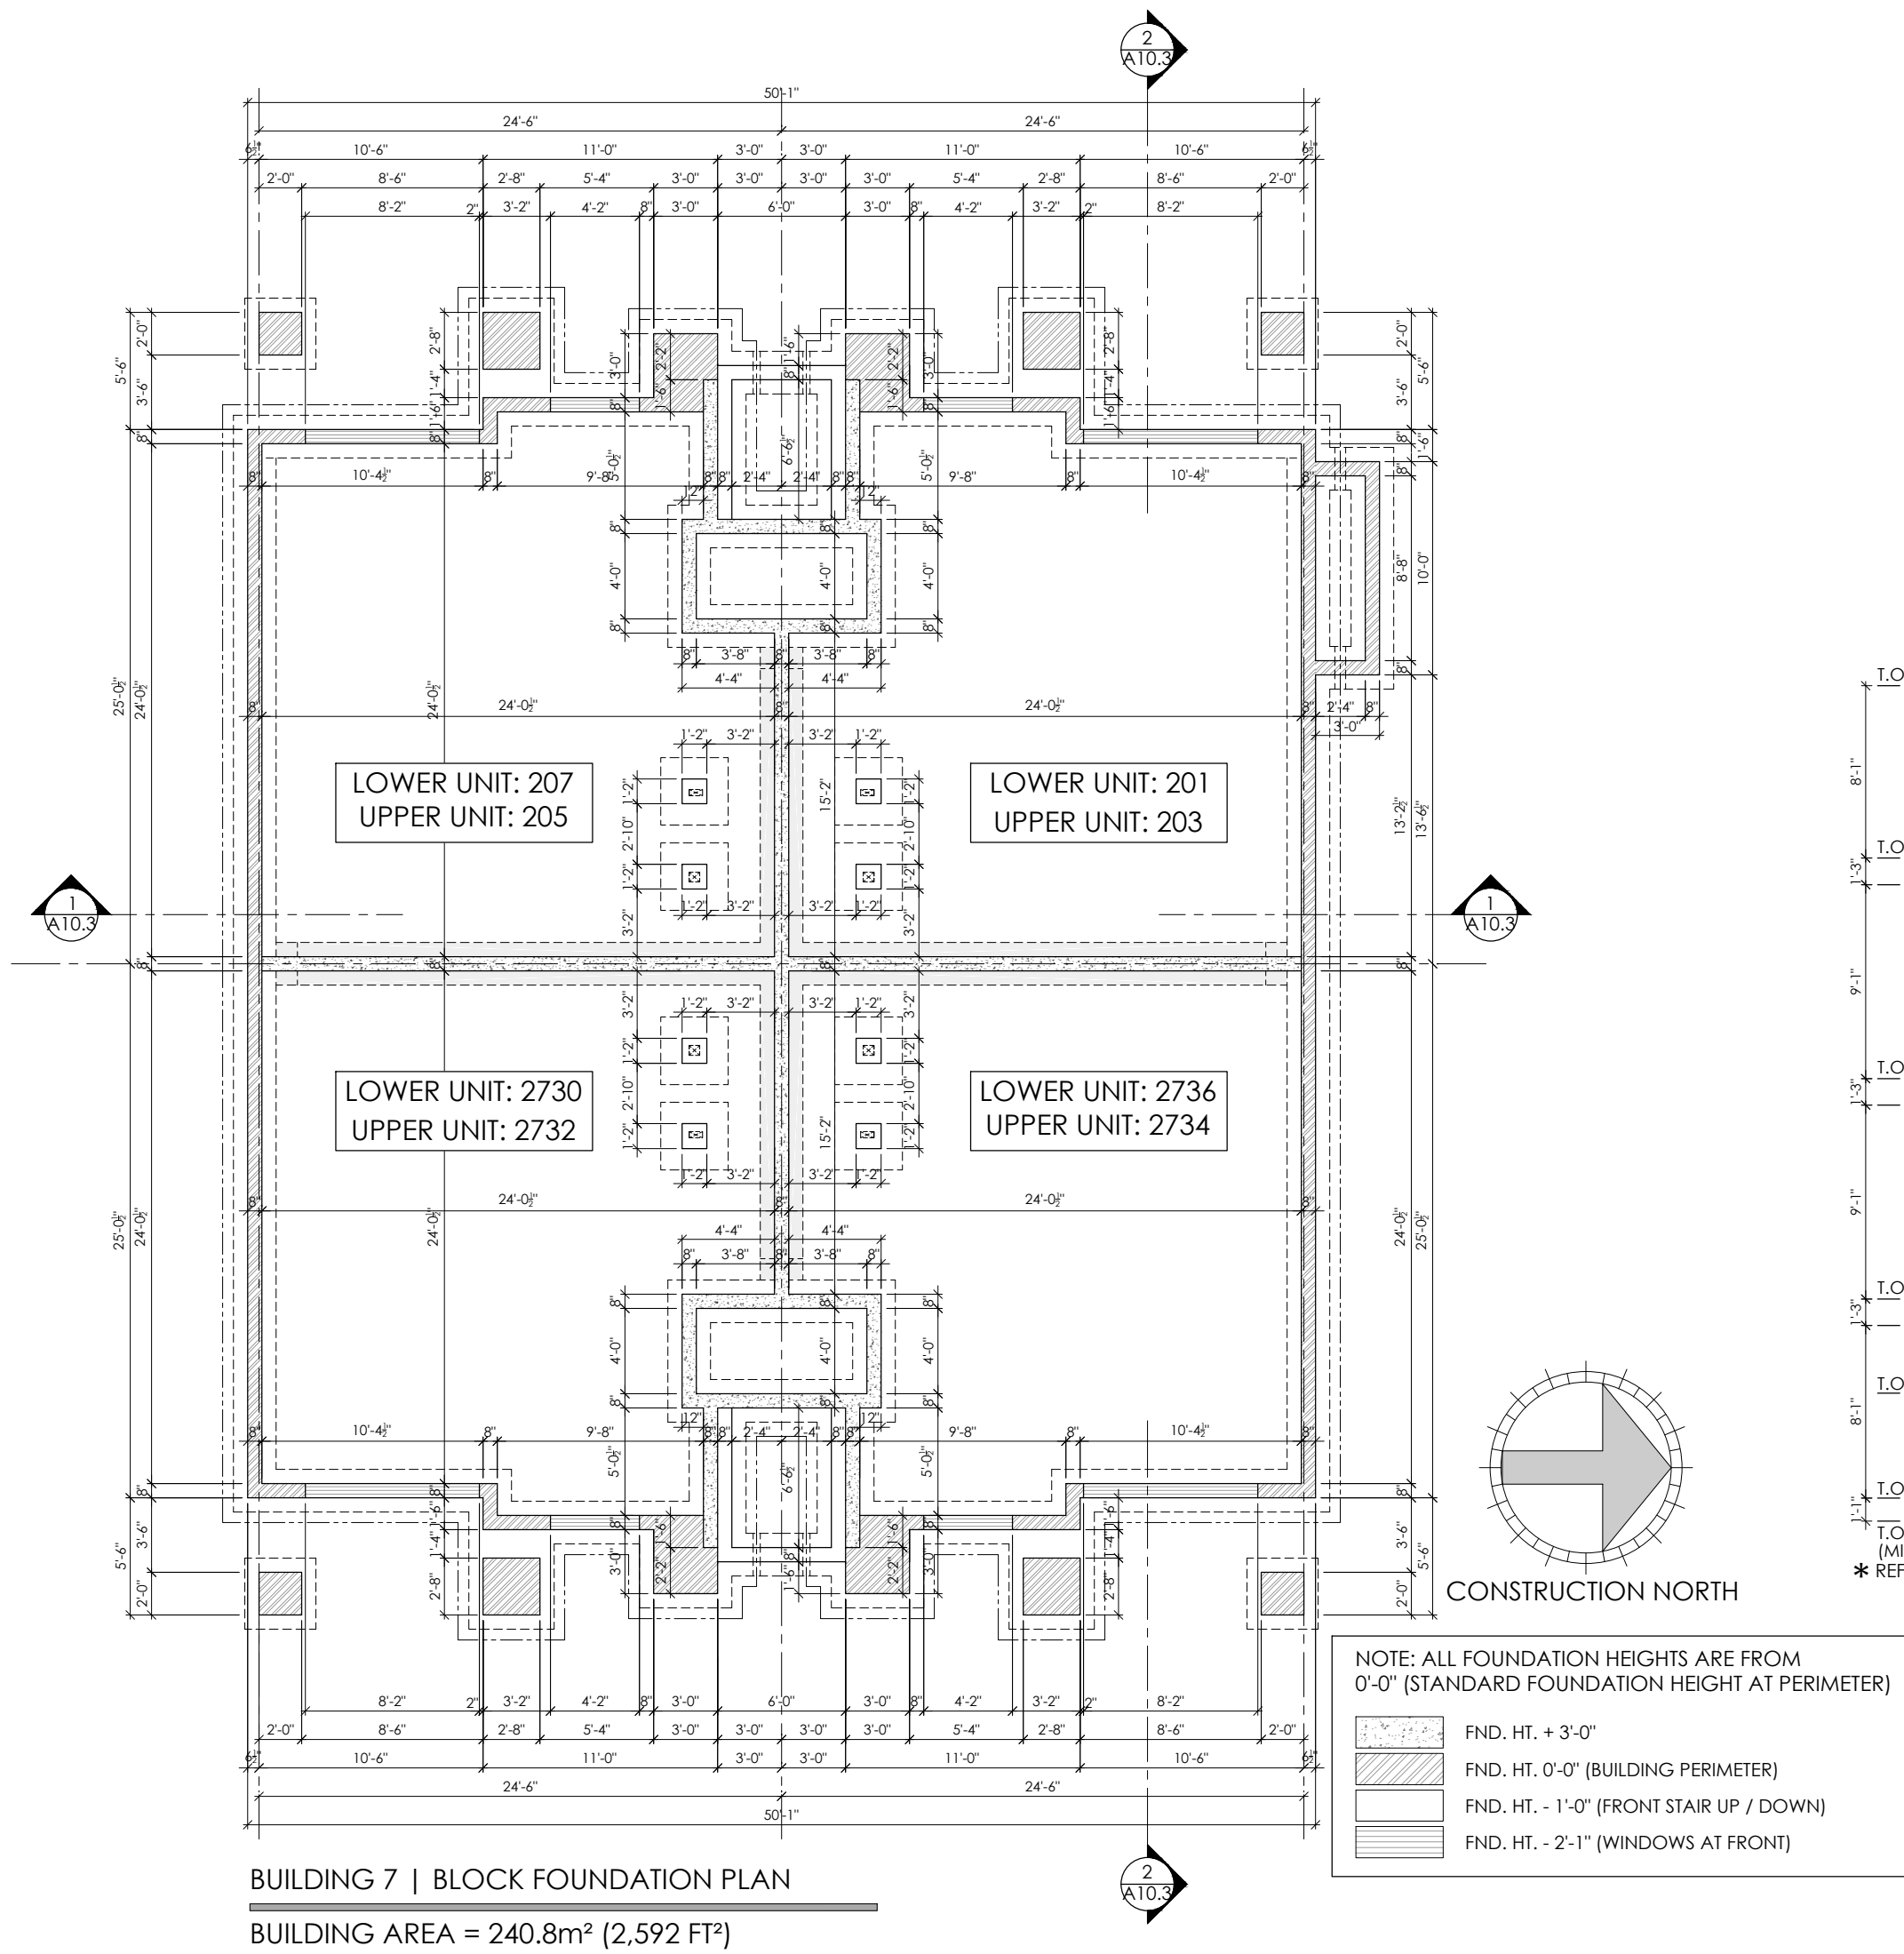

REQUIRED WALL CONSTRUCTION [9.10.14.5]
- 1 HOUR FIRE RESISTANCE RATING
- COMBUSTIBLE CONSTRUCTION
- COMBUSTIBLE CLADDING
AREA OF U.P.O. = 36.0 sq.ft. (3.3m²)
PERCENT OF U.P.O. = 7.9%



* GENERAL NOTE 7:
NOTE:
ALL FOOTINGS ARE TO BE PLACED ON SOLS APPROVED BY GEOTECHNICAL ENGINEER, CIVIL ENGINEER, AND STRUCTURAL ENGINEER.
NOTE:
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NOTE:
INSULATION @ FOOTINGS AS PER GEOTECHNICAL ENGINEERS SPECIFICATION
NOTE:
REFER TO SOILS REPORT FOR UNDER-SLAB DRAINAGE REQUIREMENTS

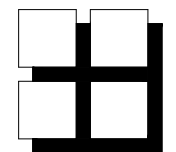

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8500 POUND CAP. (MIN.)
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P3 - 3"x4" 6 OR 8" (AS APPLICABLE)
P4 - 4"x4" 6 OR 8" (AS APPLICABLE)
P5 - 5"x4" 6 OR 8" (AS APPLICABLE)
P6 - HSS 3 1/2"x3 1/2" x 1/4" 180" C/W 5"x3/8"x8" B PL. & CAP PL.
P7 - HSS 4"x4" 180" C/W 5"x3/8"x8" B PL. & CAP PL.
P8 - P.T. 6"x6"
NOTE:
ALL WOOD POST LOCATIONS TO BE BLOCKED SOLID, THRU FLOOR STRUCTURE ON TO A SIMILAR POST BELOW OR ON TO A STEEL/WOOD BEAM OR ON TO THE CONC. FOUNDATION WALL.

LINTEL BEAM SCHEDULE
SIZES INDICATED ON PLANS
BRICK LINTELS
OPENINGS UP TO 5'-0"
7'-0"
8'-0"
9'-0"
10'-0"
6" MIN. BEARING EACH END
ALL ANGLES TO BE HOT DIPPED GALVANIZED

NOTE:
WALLS/ HEADERS/ POST TO BE SPF NO. 1/ NO. 2
NOTE:
FASTEN ALL ROOF AND WALL SHEATHING WITH MINIMUM 3 1/2" LONG COMMON OR SPIRAL NAILS SPACED AT 6" C/C AROUND PANEL PERIMETER AND AT 12" C/C ALONG INTERMEDIATE SUPPORTS.
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K2L 4B9 (613) 591-1533



NO.	DATE	DESCRIPTION	INT.
1.	12/09/24	WASHROOMS REVISED, RE-ISSUED FOR CONSTRUCTION	MB
2.	06/08/24	ISSUED FOR CONSTRUCTION	MB
3.	05/02/24	AS PER STRUCTURAL RE-ISSUED FOR PERMIT	MB
4.	10/01/24	AS PER STRUCTURAL M&E FOR BUILDING PERMIT	MB
5.	24/08/23	FOR STRUCTURAL M&E REVIEW	MB

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1.	12/09/24	WASHROOMS REVISED, RE-ISSUED FOR CONSTRUCTION	MB
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4.	10/01/24	AS PER STRUCTURAL M&E FOR BUILDING PERMIT	MB
5.	24/08/23	FOR STRUCTURAL M&E REVIEW	MB

PROJECT:
B2B STACKED TERRACE HOMES
THE JUNCTION | BUILDING #7
201-207 SILHOUETTE PVT., OTTAWA, ONTARIO
2730-2736 CEDARVIEW RD., OTTAWA, ONTARIO


CLIENT:
PHOENIX HOMES
18A Bentley Ave Ottawa, ON K2E 6T8

DRAWING TITLE:
BUILDING 7
BLOCK FOUNDATION PLAN
BLOCK ELEVATIONS

DATE:
AUG., 2023

SCALE:
1/8" = 1'-0"

SHEET NO.:
B7.1

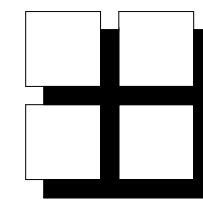

**M. David Blakely
Architect Inc.**

2200 Prince of Wales Dr. Suite 101 Ottawa, Ontario
Phone (613) 226-8811 Fax (613) 226-7942 K2E 6Z9

GENERAL NOTES:

1. THE CONTRACTOR IS RESPONSIBLE FOR CHECKING AND VERIFYING ALL DIMENSIONS. ANY DISCREPANCY MUST BE REPORTED TO M. DAVID BLAKELY ARCHITECT INC.
2. ALL WORK AND MATERIALS TO BE IN COMPLIANCE WITH ALL CODES, REGULATIONS, AND BY-LAWS.
3. ADDITIONAL DRAWINGS MAY BE ISSUED FOR CLARIFICATION OF WORK. SUCH DRAWINGS WILL HAVE THE SAME MEANING AND INTENT AS IF THEY WERE INCLUDED WITH THE PLANS IN CONTRACT DOCUMENTS.
4. DO NOT SCALE DRAWINGS.
5. THIS DRAWING SHALL NOT BE USED OR COPIED, WITHOUT THE AUTHORIZATION OF THE ARCHITECT.
6. THIS DRAWING SHALL NOT BE USED FOR PERMIT OR CONSTRUCTION UNLESS THE DRAWING BEARS THE ARCHITECT'S SEAL AND SIGNATURE.
7. THIS REPRODUCTION SHALL NOT BE ALTERED.

POST SCHEDULE

- P1- 3" DIA. ADJUSTABLE STEEL TELEPOST
8500 POUND CAP. (MIN.)
P2- 2"x4, 6 OR 8" (AS APPLICABLE)
P3- 3"x4, 6 OR 8" (AS APPLICABLE)
P4- 4"x4, 6 OR 8" (AS APPLICABLE)
P5- 5"x4, 6 OR 8" (AS APPLICABLE)
P6- HSS 3 1/2"x3 1/2"x .188" C/W 5"x3/8"x8" B PL. & CAP PL.
P7- HSS 4"x4"x .188" C/W 5"x3/8"x8" B PL. & CAP PL.
P8- P.T. 6"x6"

BRICK LINTELS	OPENINGS UP TO	L SIZE
	5'-0"	L 3 1/2" x 3 1/2" x 5/16"
	7'-0"	L 4" x 3 1/2" x 5/16"
	8'-0"	L 5" x 3 1/2" x 5/16"
	9'-0"	L 5" x 3 1/2" x 7/16"
	10'-0"	L 6" x 4" x 7/16"

6min. BEARING EACH END
ALL ANGLES TO BE HOT DIPPED GALVANIZED


NOTE:
ALL WOOD POST LOCATIONS TO BE BLOCKED SOLID THRU FLOOR STRUCTURE ON TO A SIMILAR POST BELOW OR ON TO A STEEL/WOOD BEAM OR ON TO THE CONC. FOUNDATION WALL

NOTE:
WALLS/ HEADERS/ POST TO BE SPF NO. 11/ NO. 2

NOTE:
FASTEN ALL ROOF AND WALL SHEATHING WITH MINIMUM 2 1/2" LONG COMMON OR SPIRAL NAILS SPACED AT 6" C/C AROUND PANEL PERIMETER AND AT 12" C/C ALONG INTERMEDIATE SUPPORTS.

NOTE:
INDICATED JOIST HANGERS ARE A MINIMUM SIZE. JOIST/ TRUSS DESIGNER MAY PROVIDE ALTERNATIVE HANGERS WITH GREATER OR EQUAL SHEAR AND UPLIFT CAPACITIES.

NO.	DATE	DESCRIPTION	REVISED BY
10.			
9.			
8.			
7.			
6.			
5.	12/09/24	WASHROOMS REVISED. RE-ISSUED FOR CONSTRUCTION	MB
4.	04/08/24	ISSUED FOR CONSTRUCTION	MB
3.	05/02/24	AS PER STRUCTURAL. RE-ISSUED FOR PERMIT	MB
2.	10/01/24	AS PER STRUCTURAL/ M&E. FOR BUILDING PERMIT	MB
1.	24/08/23	FOR STRUCTURAL/ M&E REVIEW	MB
NO.	DATE	DESCRIPTION	REVISED BY

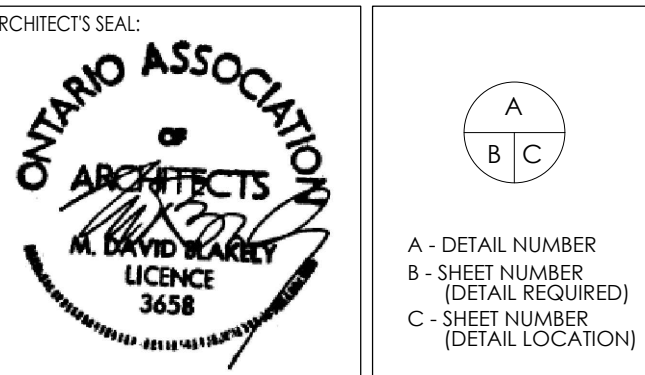


PROJECT
B2B STACKED TERRACE HOMES
THE JUNCTION | BUILDING #7
201-207 SILHOUETTE PVT., OTTAWA, ONTARIO
2730-2736 CEDARVIEW RD., OTTAWA, ONTARIO

CLIENT:

PHOENIX HOMES
18A Bentley Ave Ottawa, ON K2E 6T8


DRAWING TITLE:
BUILDING 7
LOWER UNIT FLOOR PLANS
UPPER UNIT FLOOR PLANS

DATE: AUG. 2023
SCALE: 1/8" = 1'-0"
SHEET NO.: B7.2
DRAWN BY: mdb
CHECKED: MDB

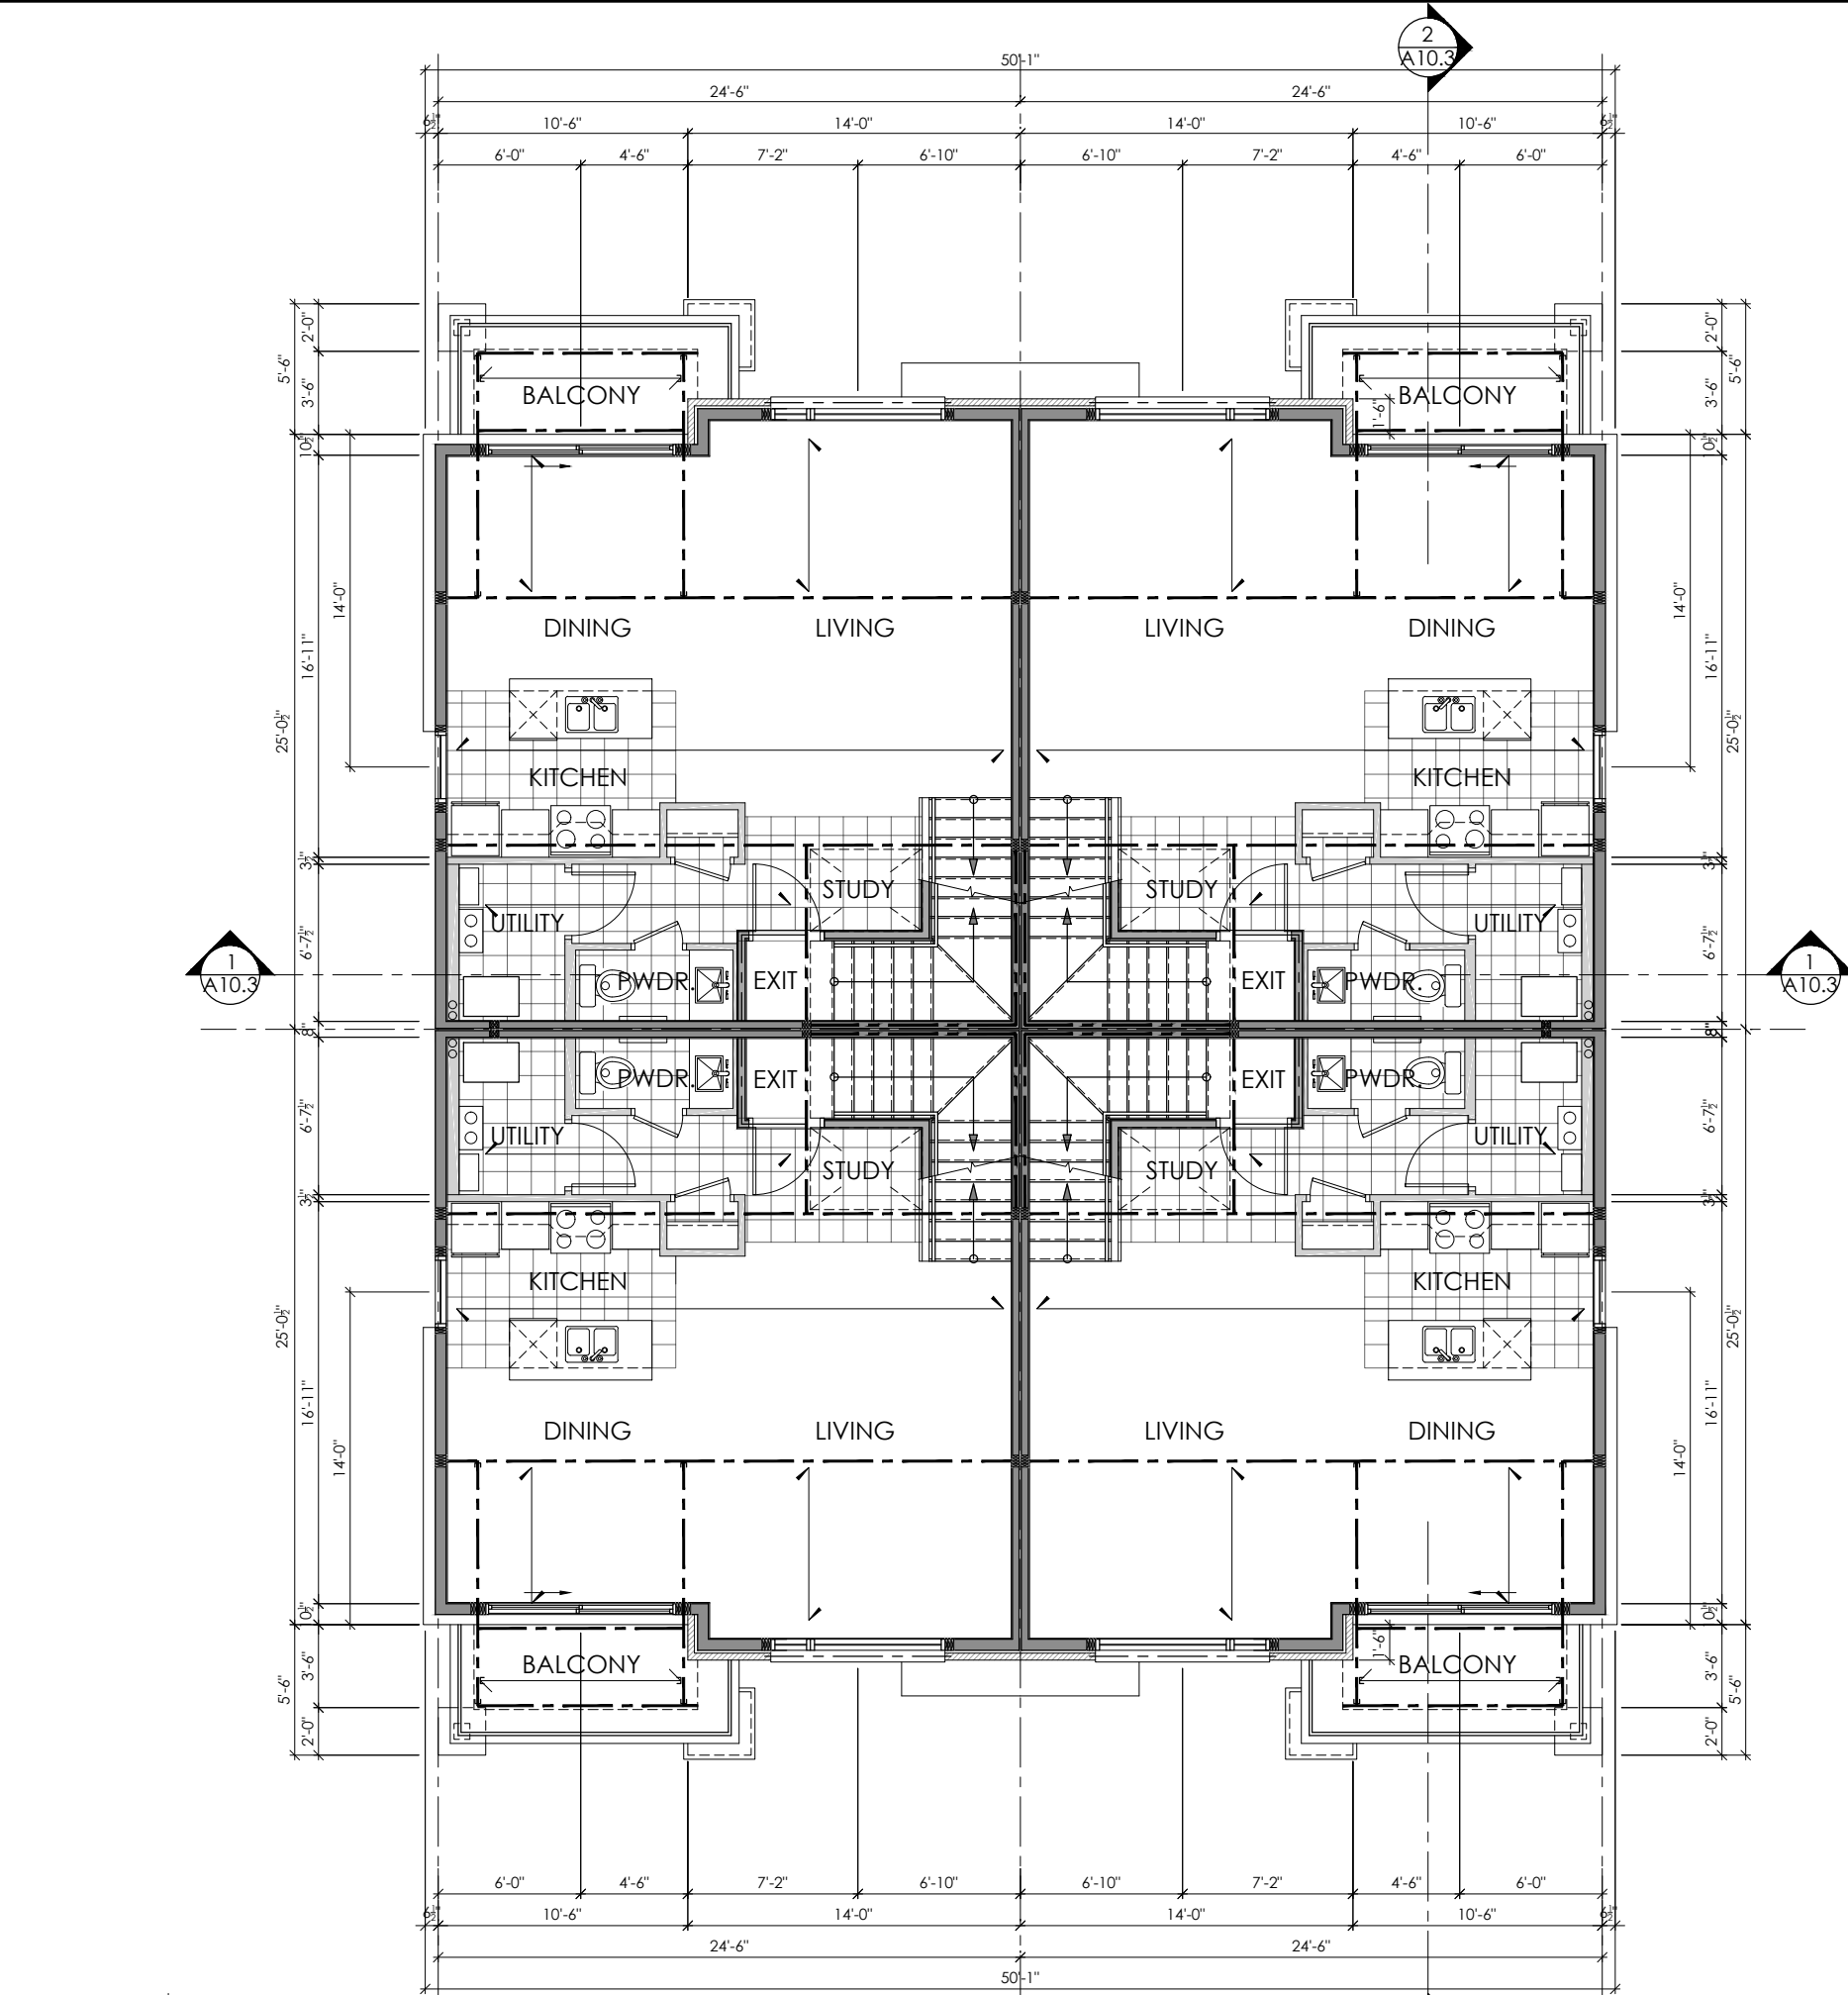


UPPER UNIT | MAIN LEVEL FLOOR PLAN

CONSTRUCTION NORTH

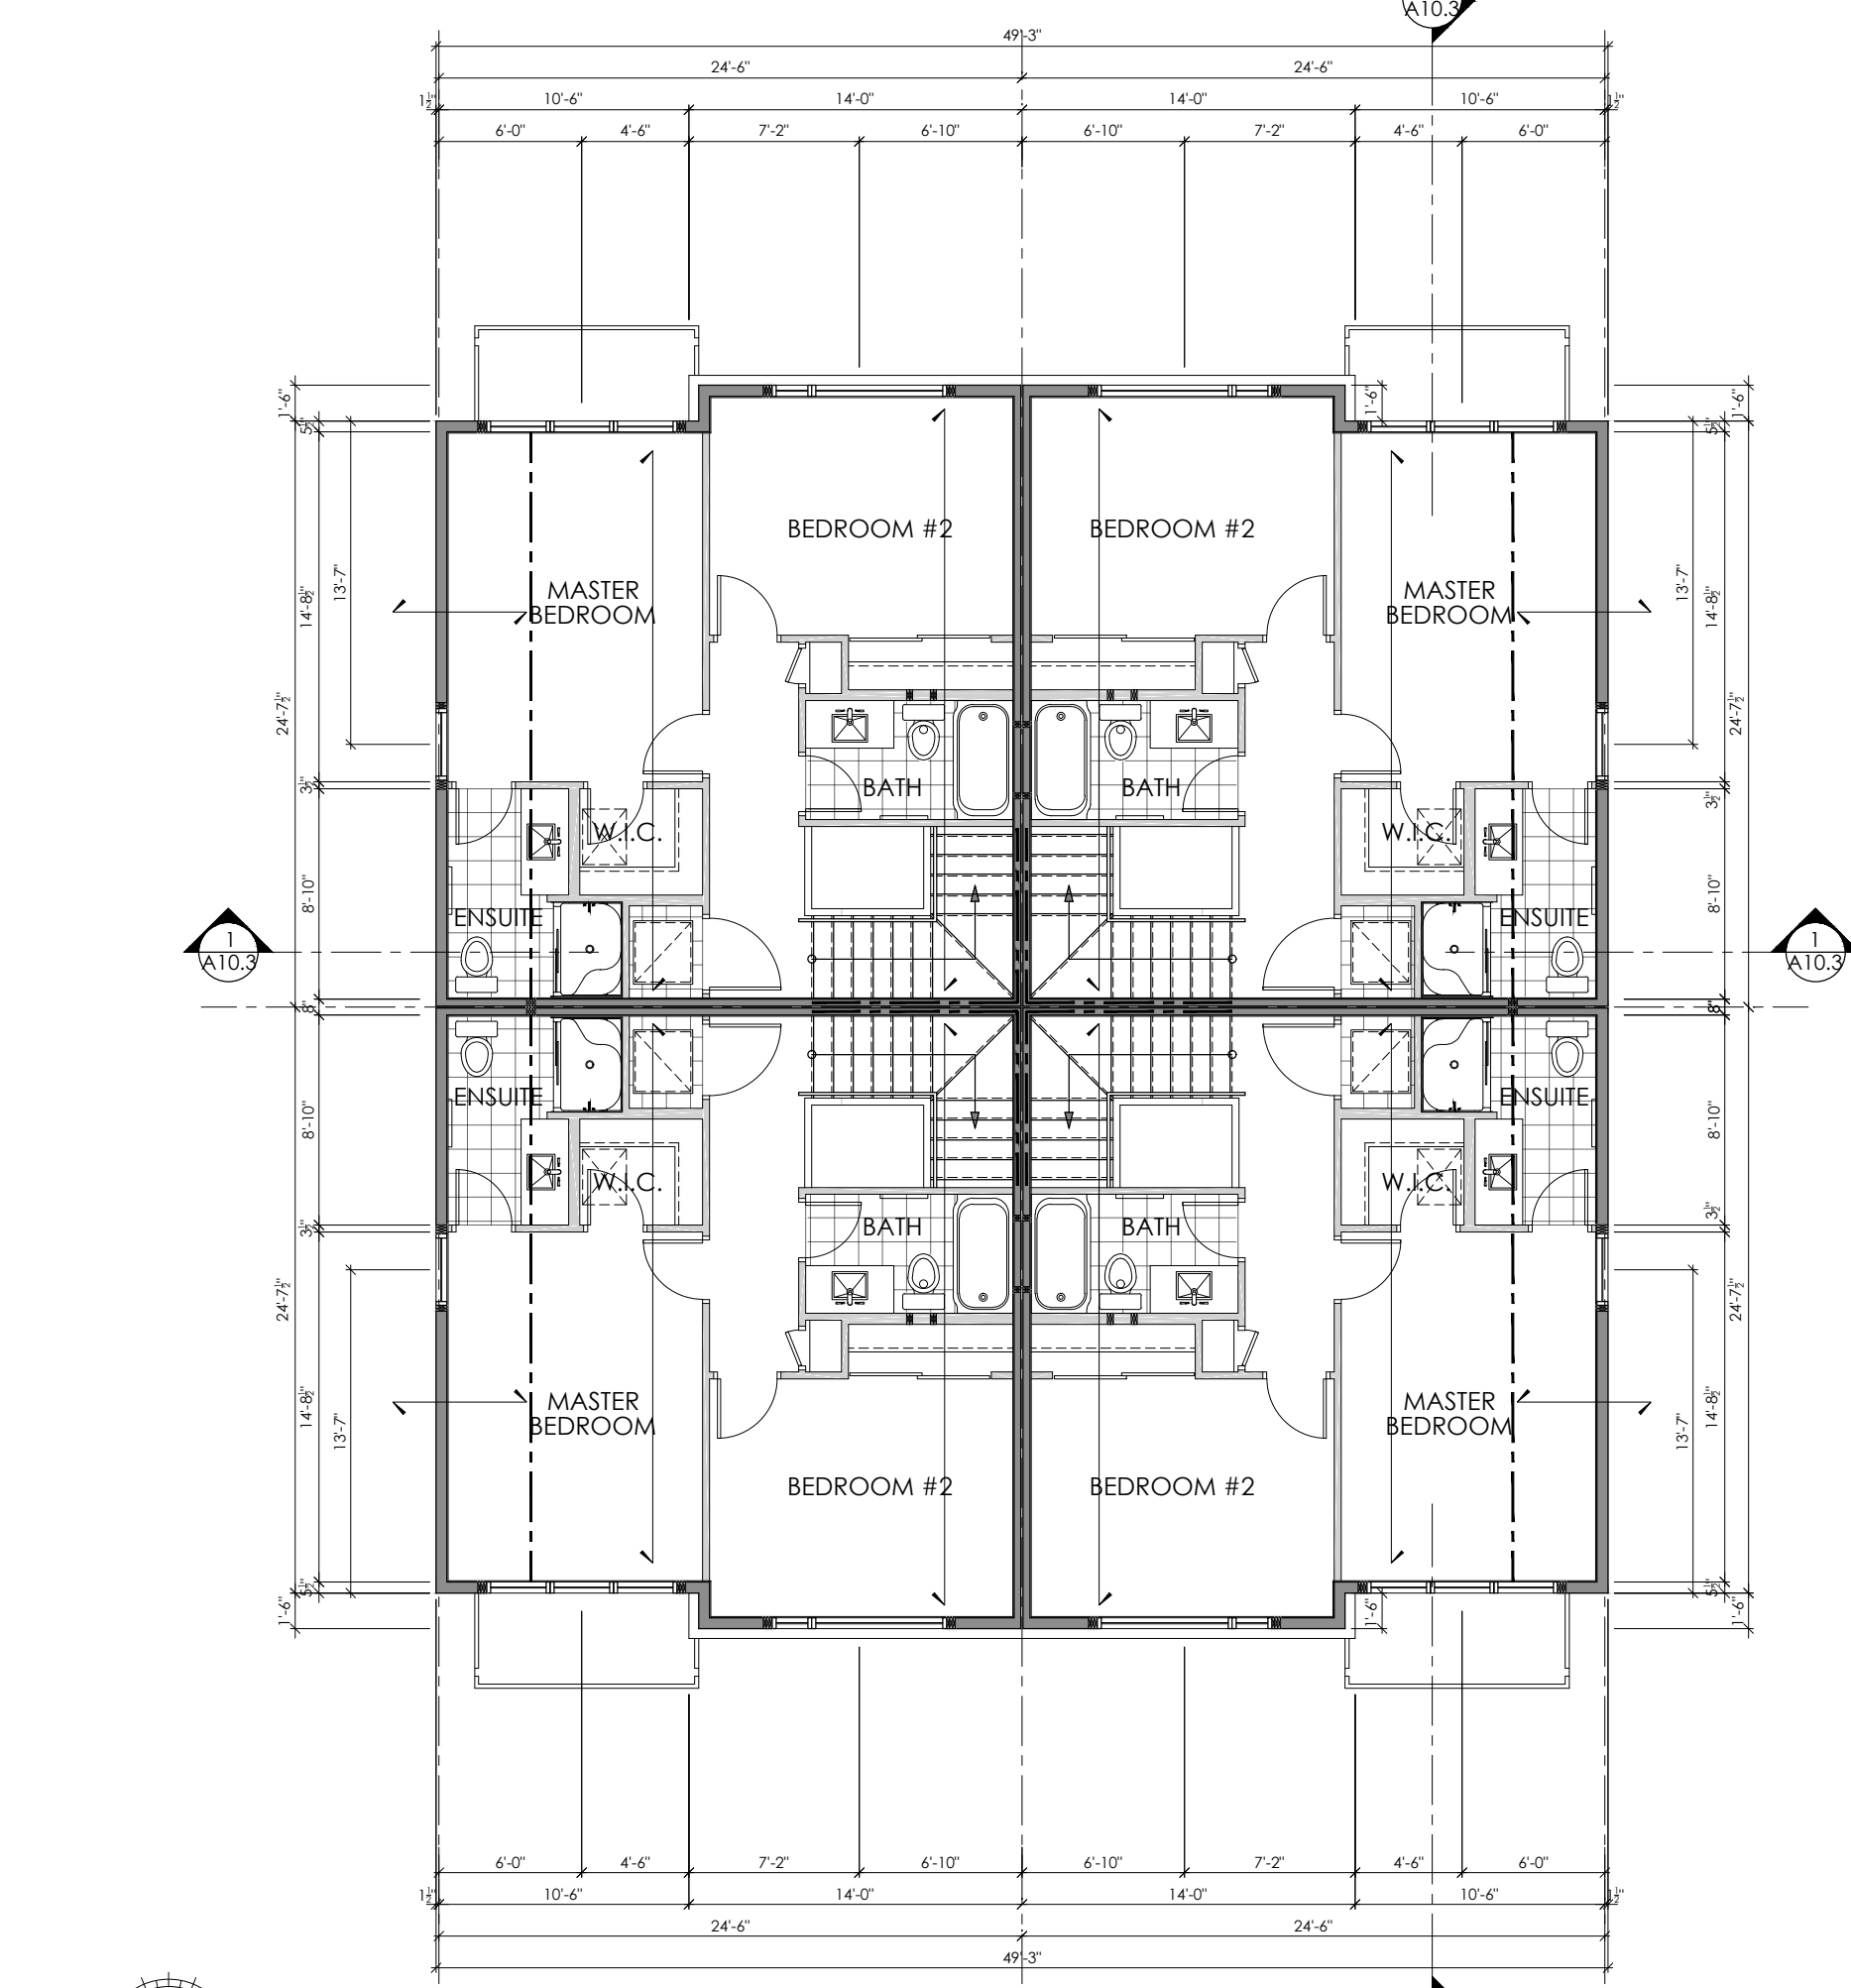


UPPER UNIT | UPPER LEVEL FLOOR PLAN

CONSTRUCTION NORTH

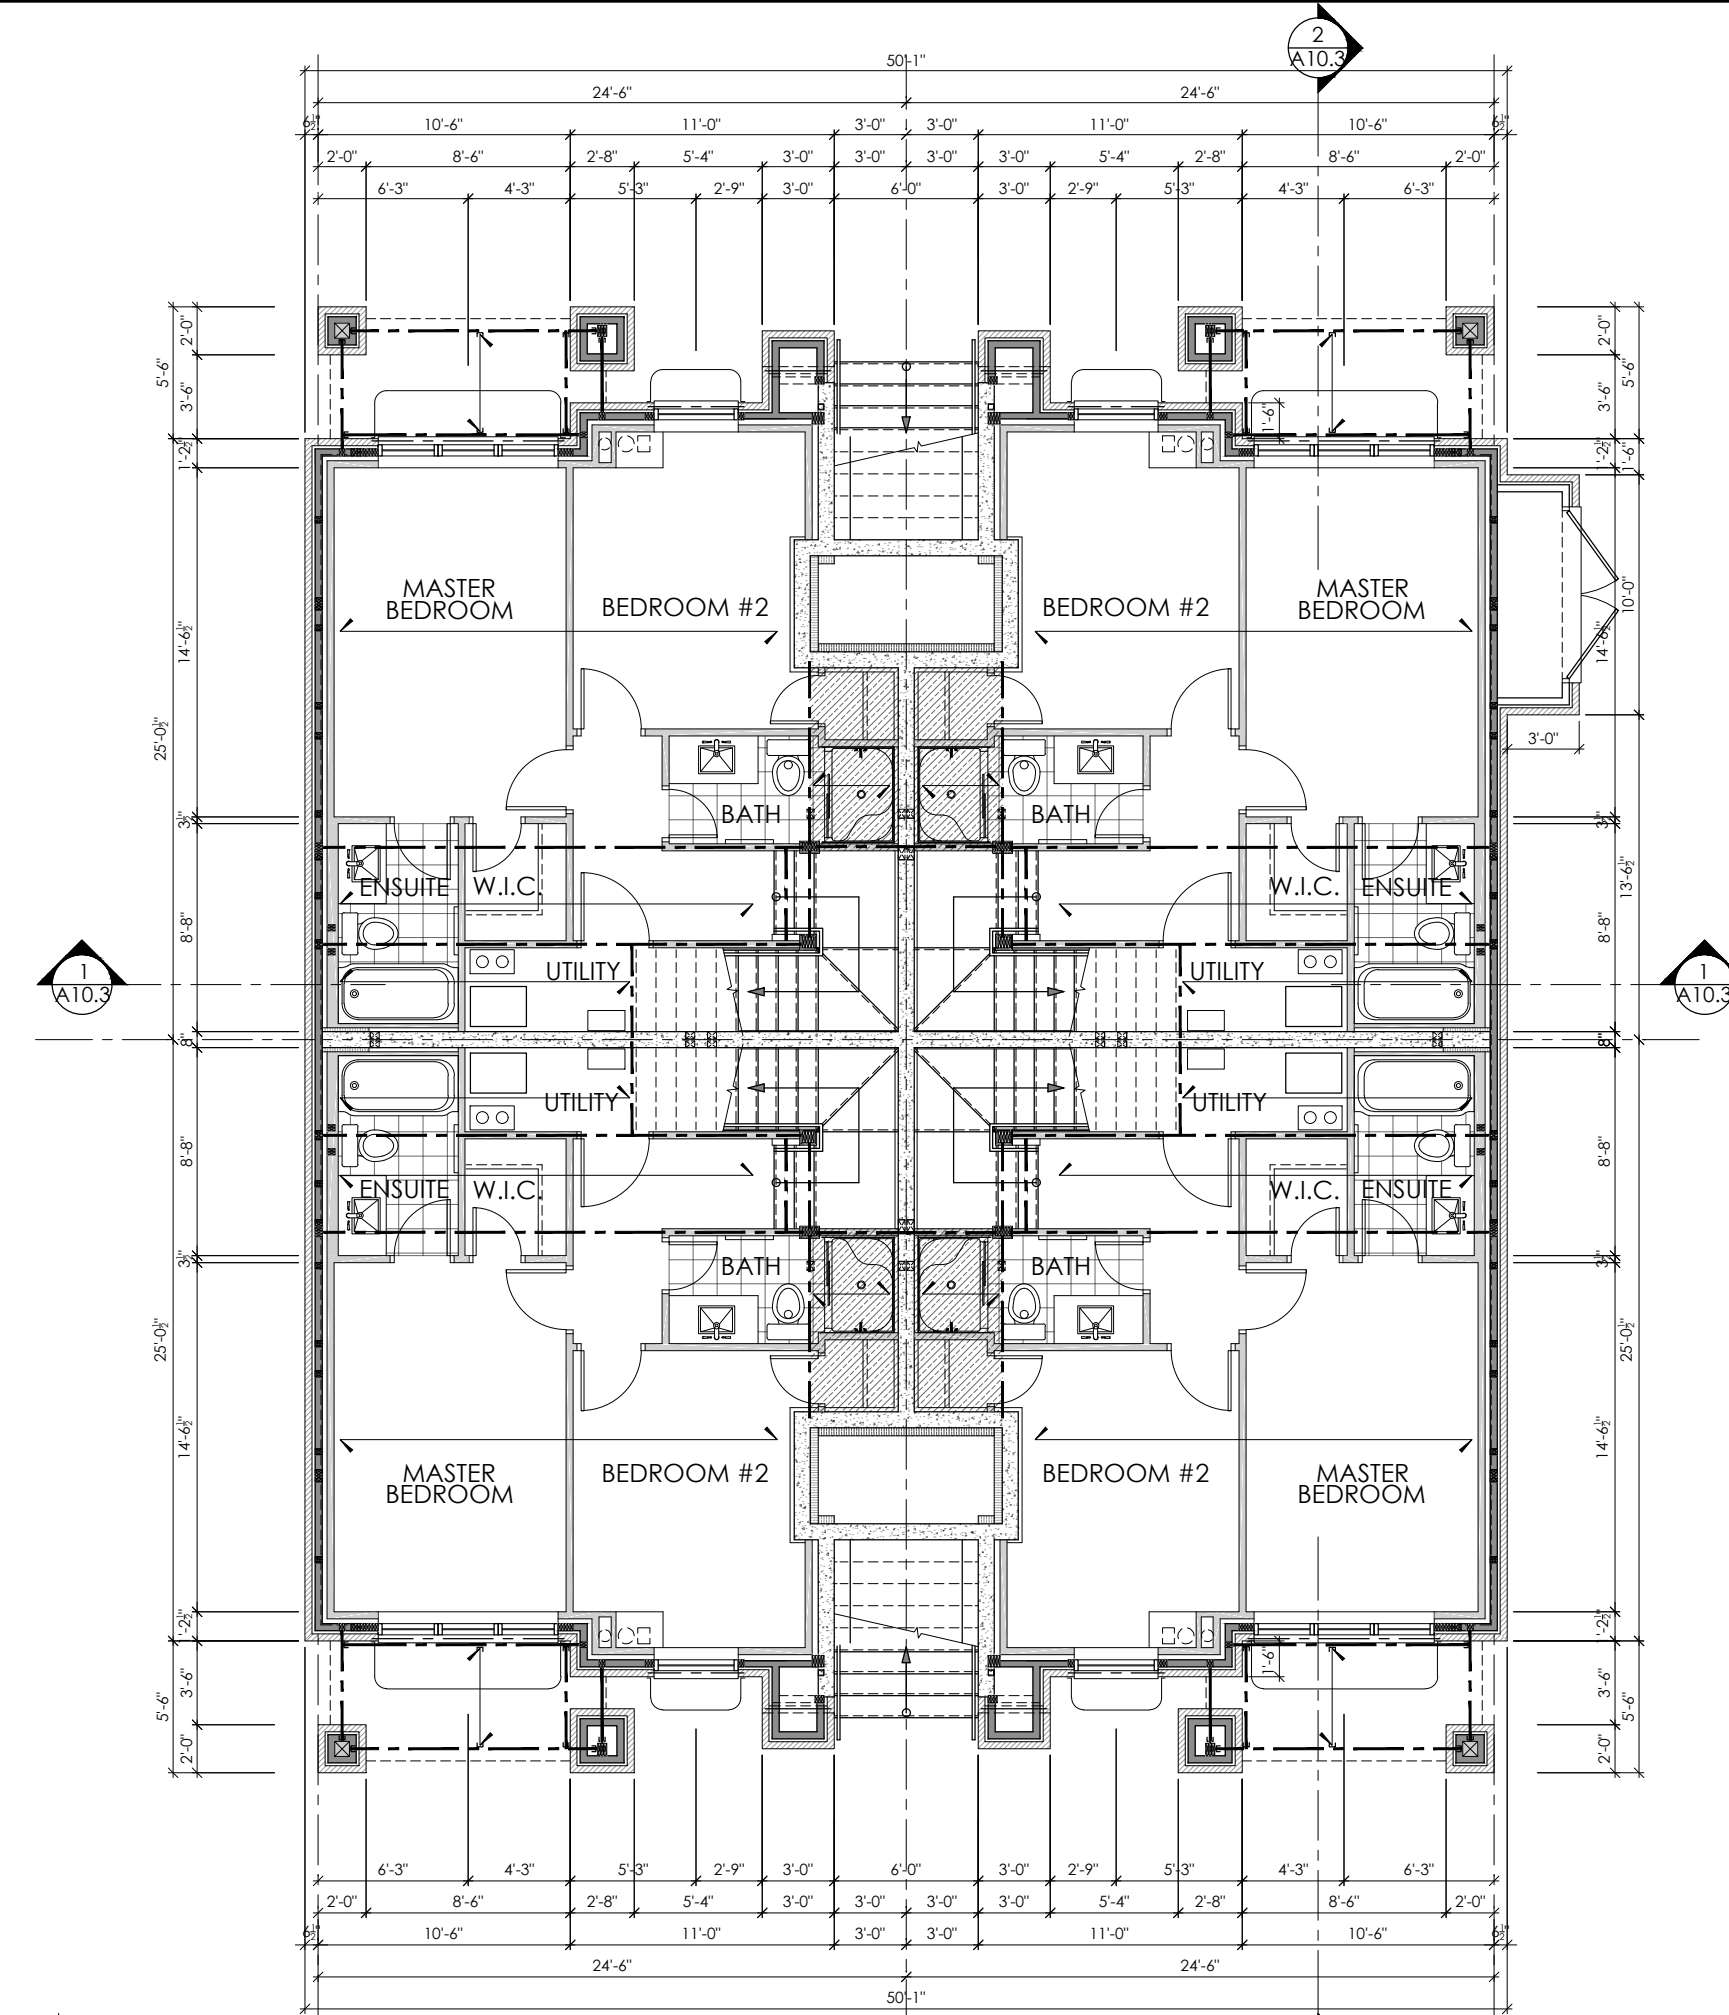

LOWER UNIT | LOWER LEVEL FLOOR PLAN


CONSTRUCTION NORTH

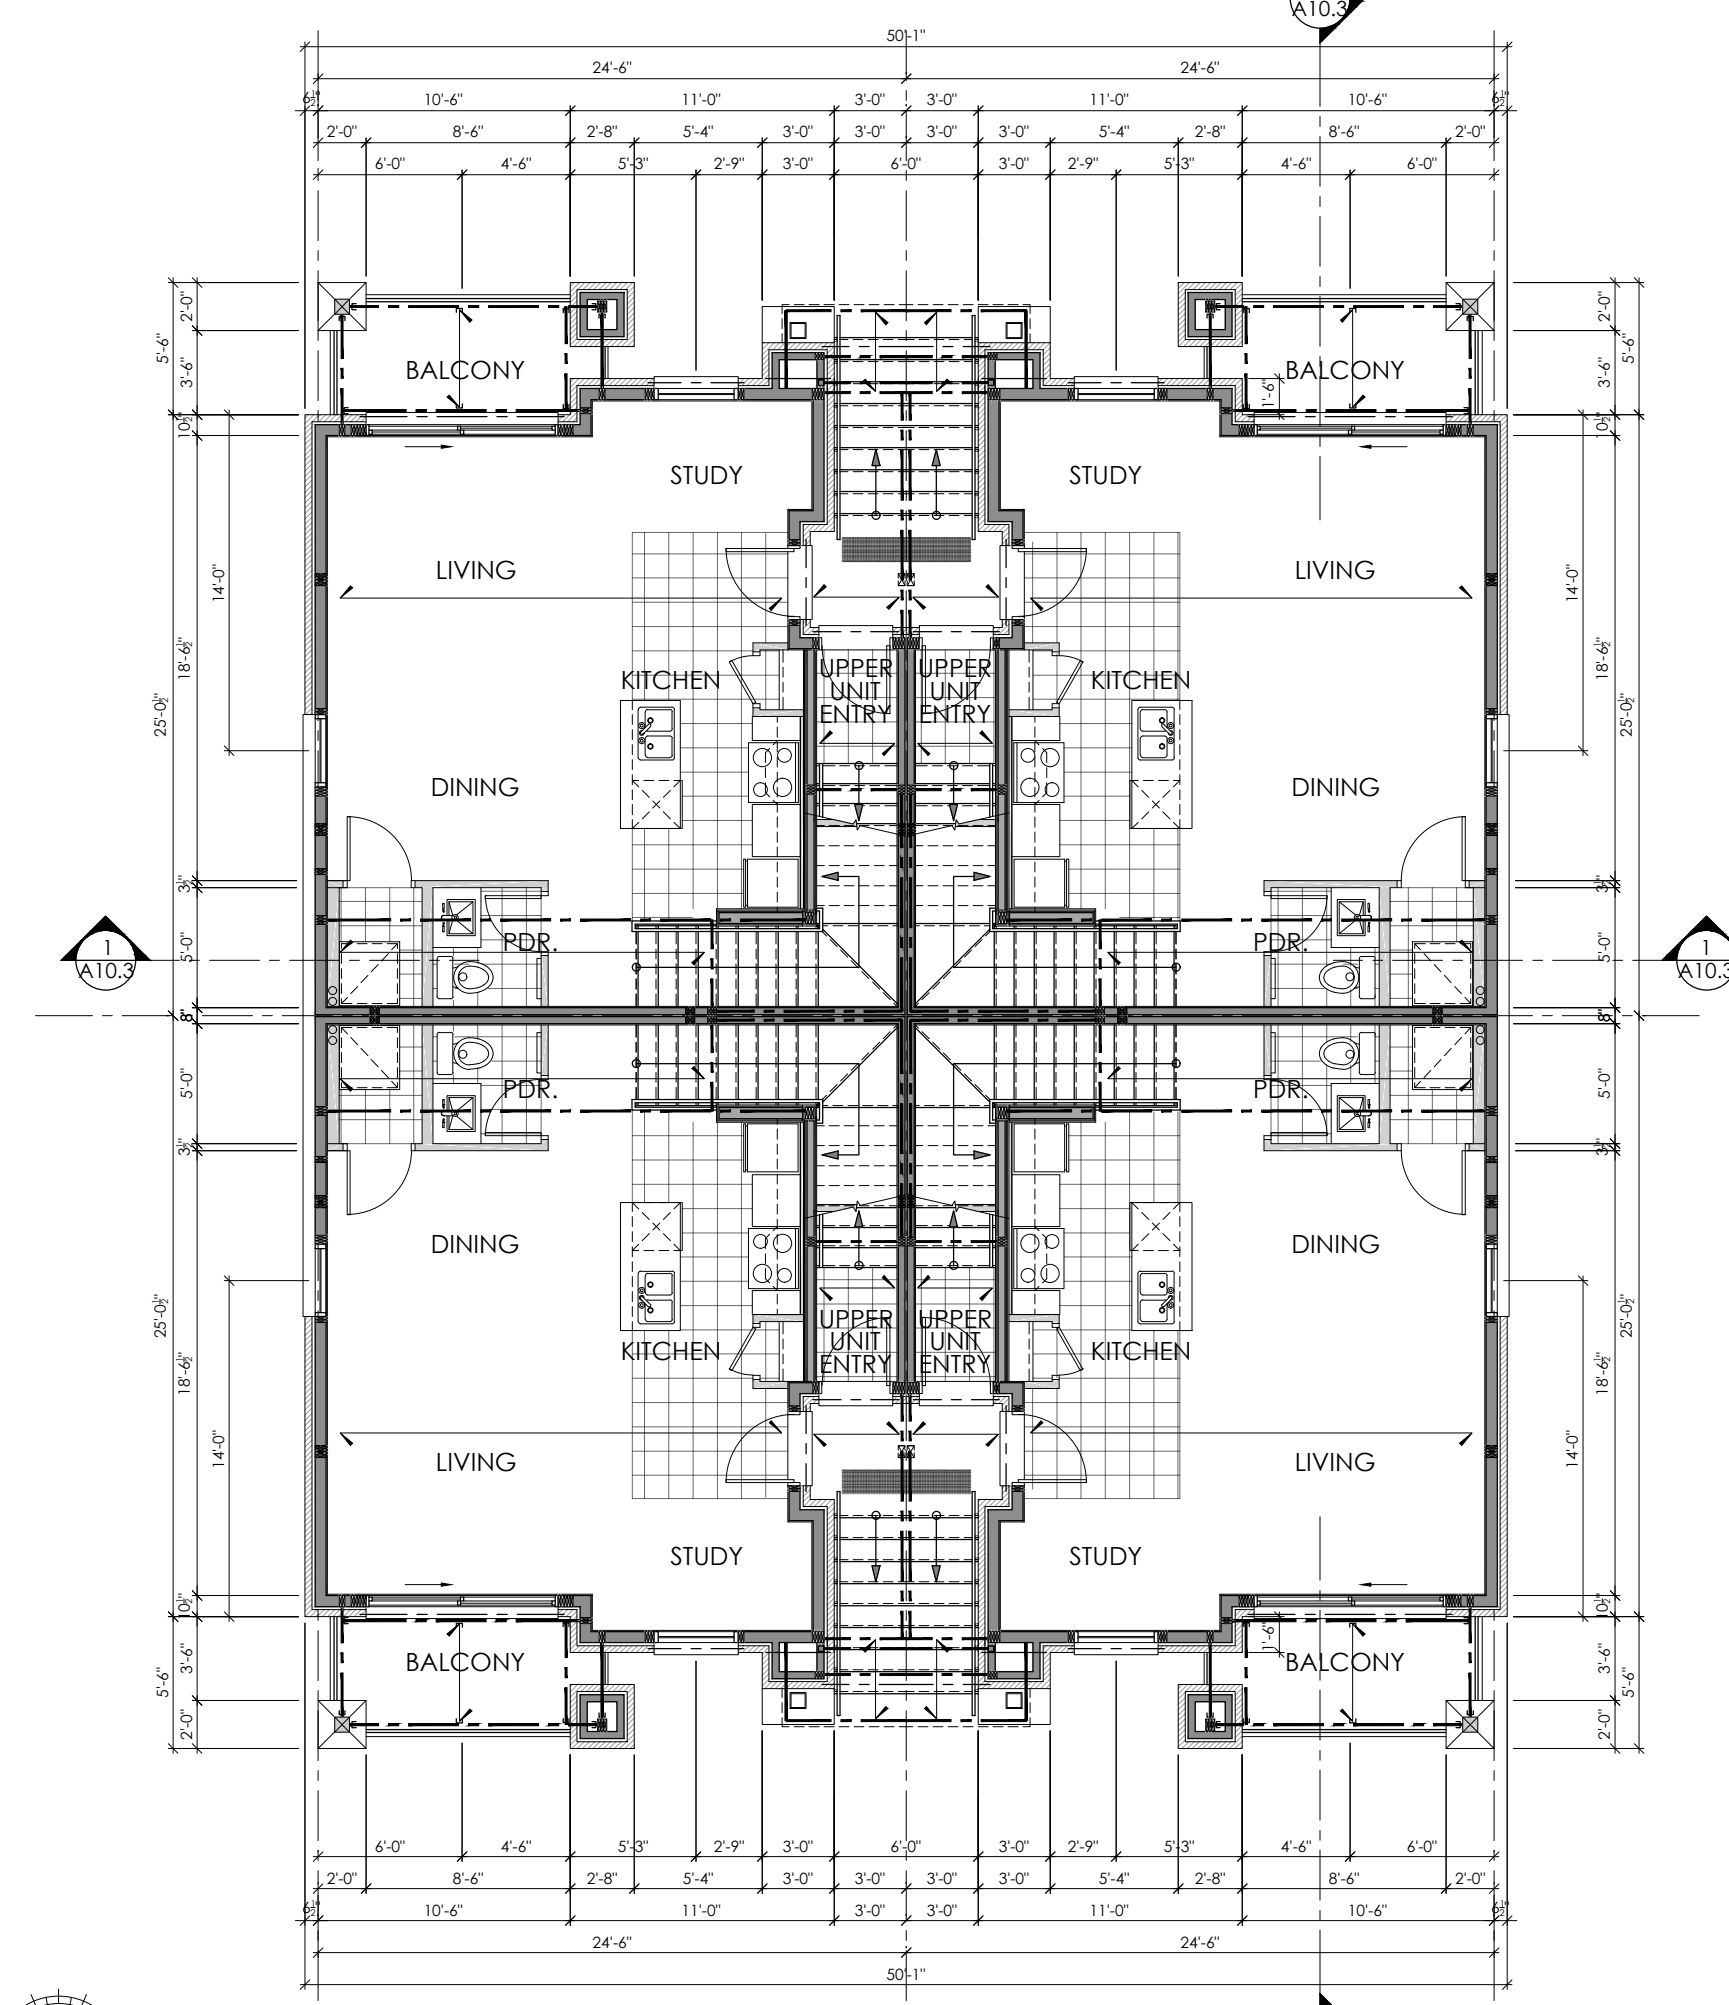

LOWER UNIT | MAIN LEVEL FLOOR PLAN

CONSTRUCTION NORTH


NOTE:
ALL FLOOR PLANS ON THIS PAGE TO BE READ IN CONJUNCTION WITH UNIT FLOOR PLANS ON SHEET A1

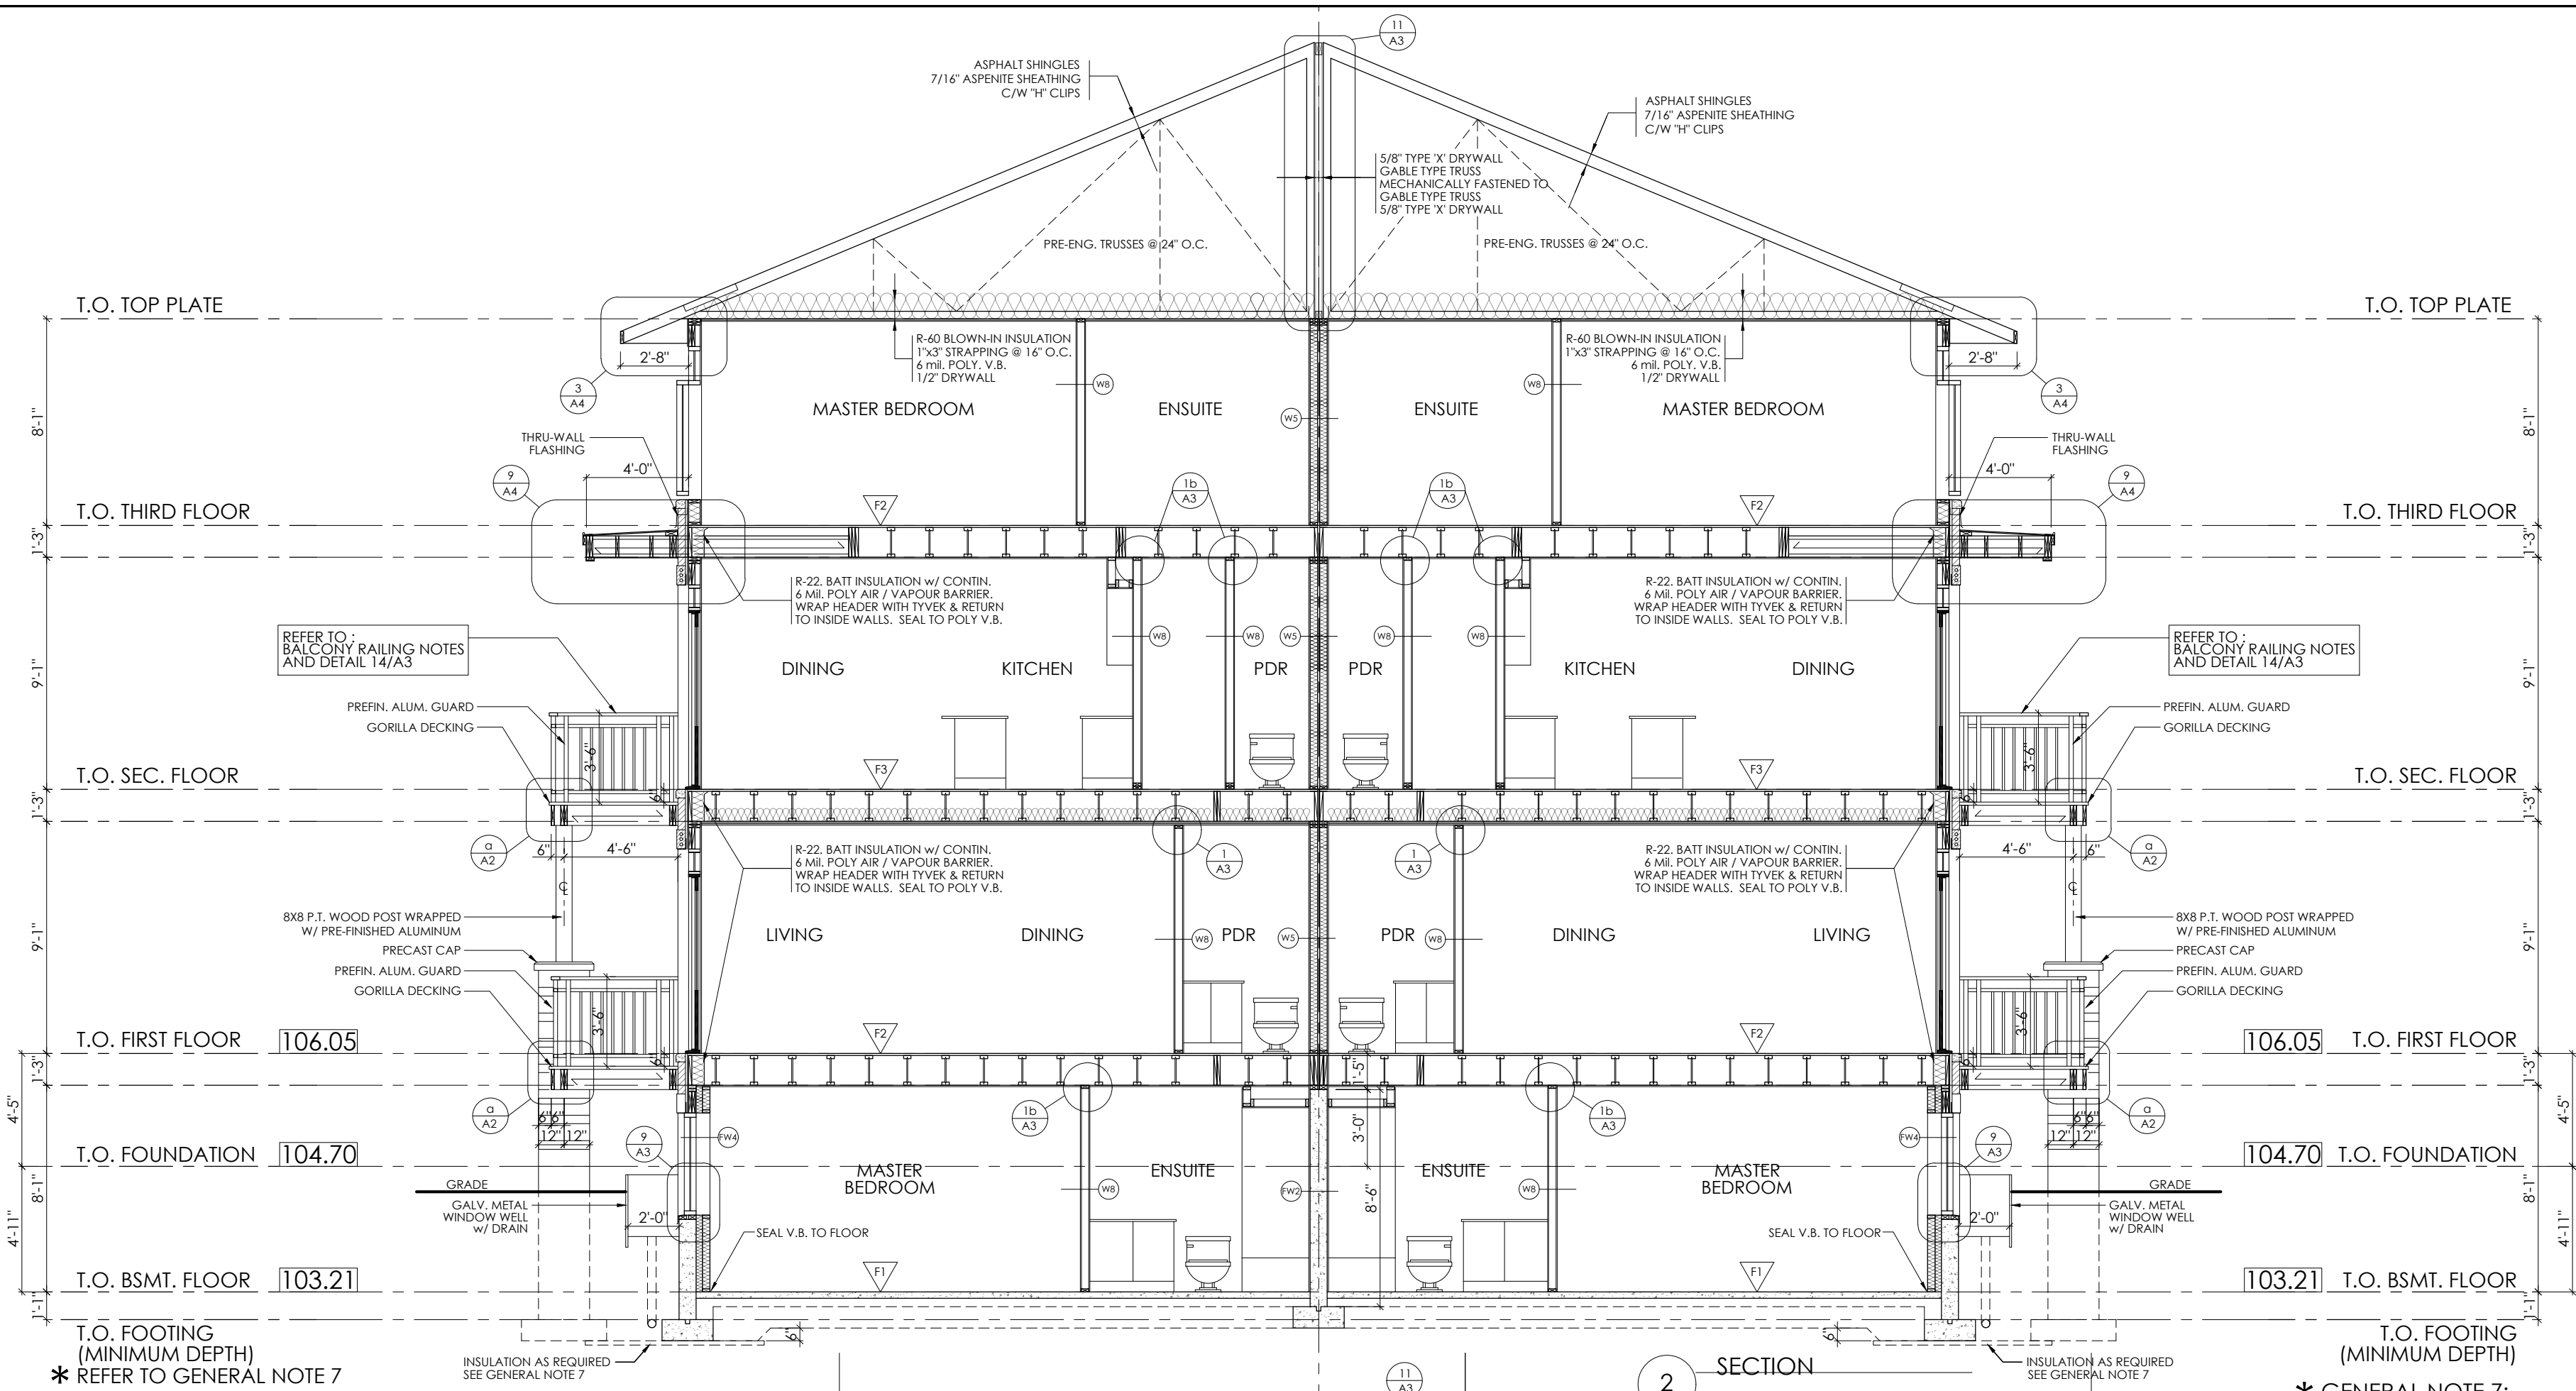

T.O. FOOTING (MINIMUM DEPTH)
* REFER TO GENERAL NOTE 7

T.O. FOOTING (MINIMUM DEPTH)
* GENERAL NOTE 7:

NOTE:
ALL FOOTINGS ARE TO BE PLACED ON SOLS APPROVED BY GEOTECHNICAL ENGINEER, CIVIL ENGINEER, AND STRUCTURAL ENGINEER'S REQUIREMENTS.
NOTE:
SITE TO COORDINATE DEPTH OF FOOTINGS AS PER CIVIL, GEOTECHNICAL, AND STRUCTURAL ENGINEERS' REQUIREMENTS.
NOTE:
INSULATION @ FOOTINGS AS PER GEOTECHNICAL ENGINEERS SPECIFICATION
NOTE:
REFER TO SOLS REPORT FOR UNDER SLAB DRAINAGE REQUIREMENTS

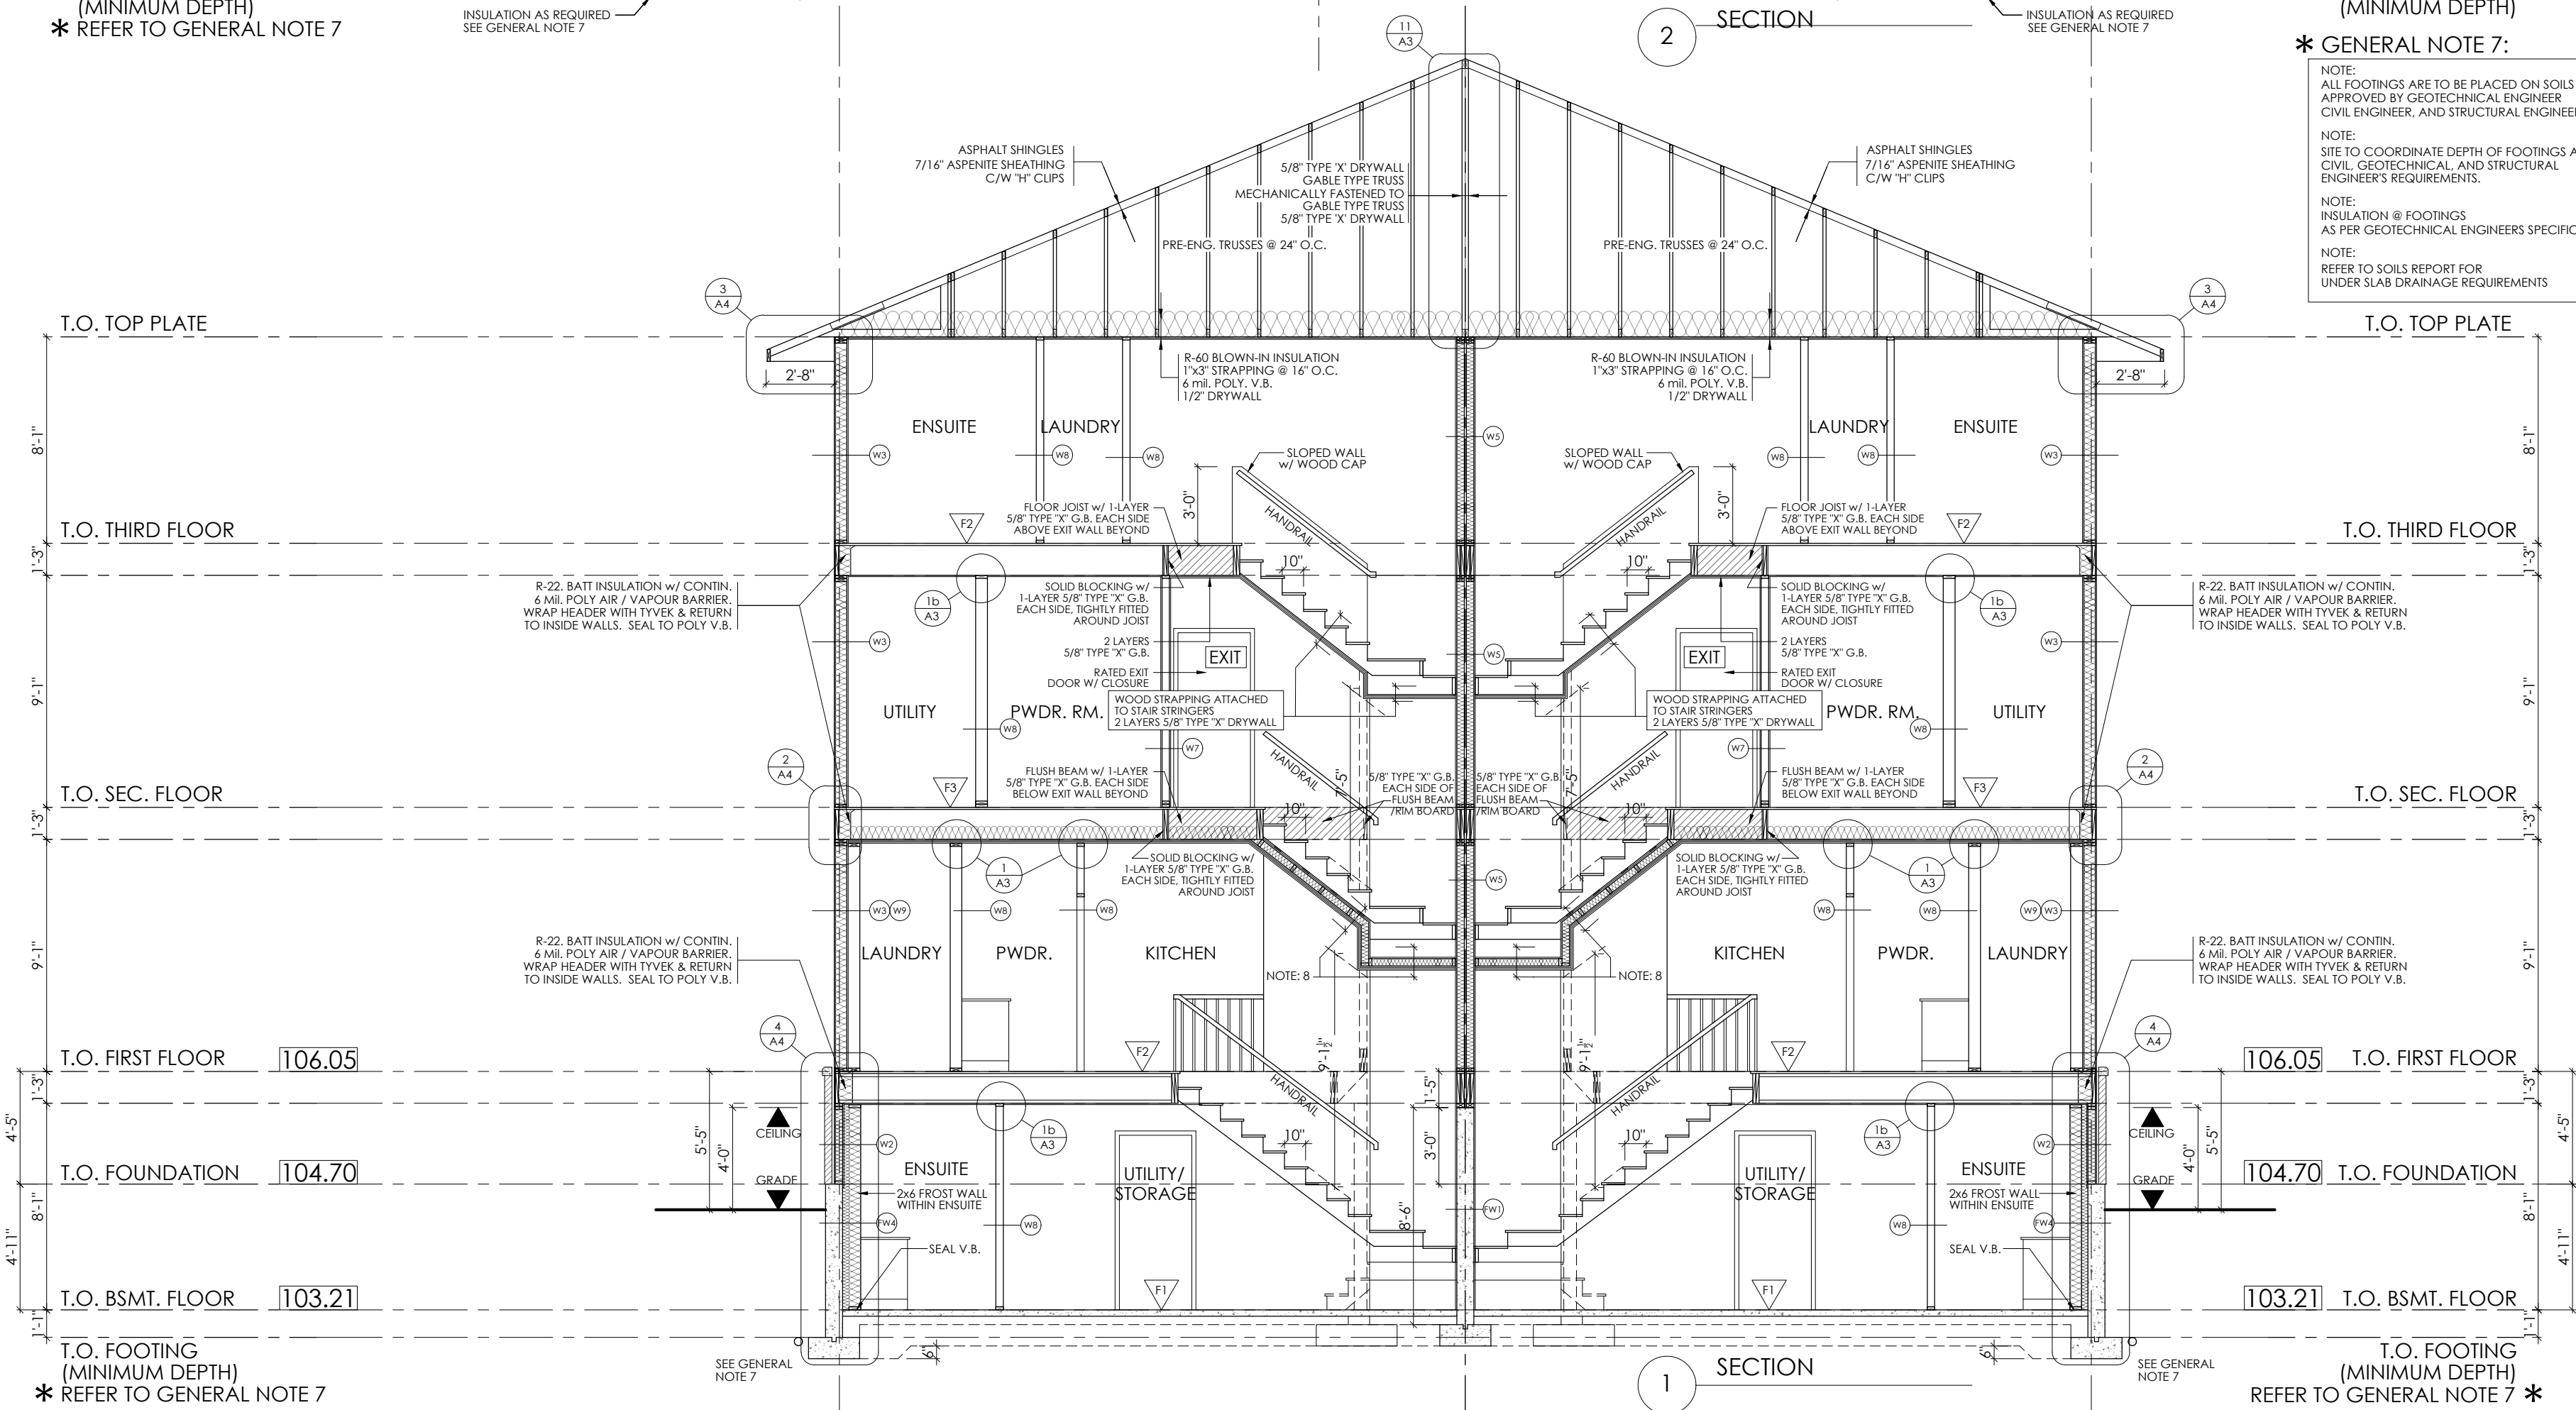

T.O. FOOTING (MINIMUM DEPTH)
* REFER TO GENERAL NOTE 7

T.O. FOOTING (MINIMUM DEPTH)
* REFER TO GENERAL NOTE 7

EXIT WALL FIRE SEPARATIONS
SERVICES SUCH AS: DUCTWORK, PLUMBING, & ELECTRICAL ARE NOT TO PENETRATE, OR BE LOCATED WITHIN, ANY EXIT WALL UNLESS THESE SERVICES SERVE THE EXIT AND ONLY THE EXIT.


NOTE 8:
18-3 WEL-100 R.F.R.R. - STC = 54
2 LAYERS 5/8" TYPE 'X' DRYWALL
RESISTENT METAL CHAIRS @ 16" o/c
ON 2"x4" WOOD STUDS @ 24" o/c
SECURED TO SIDE WALLS
5/8" DRYWALL SECURED TO STRAPPING
WOOD STRAPPING ATTACHED TO STAIR STRINGERS
FILL UNDER STAIR HEADS W/ BATT INSULATION
ALL GAPS BETWEEN STAIR & SIDE WALLS, AIR TIGHT.

STAIRS & RAILING NOTES:
(INTERIOR ONLY)
CONSTRUCTION OF GUARDS SHALL CONFORM TO O.B.C. 9.8.8 & 9.5.7, SUPPLEMENT TO THE O.B.C.
HEIGHT OF GUARD AT LANDING MIN. 2'-11" HANDRAILS TO BE 86mm (2'-10")
MAX RISE: 200mm (7'-8")
MIN. RUN: 255mm (10")
MIN. HEADROOM CLEARANCE TO BE 1950mm (6'-3/4")

* GENERAL NOTE 7:

NOTE:
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NOTE:
SITE TO COORDINATE DEPTH OF FOOTINGS AS PER CIVIL, GEOTECHNICAL, AND STRUCTURAL ENGINEERS' REQUIREMENTS.
NOTE:
INSULATION @ FOOTINGS AS PER GEOTECHNICAL ENGINEERS SPECIFICATION
NOTE:
REFER TO SOLS REPORT FOR UNDER SLAB DRAINAGE REQUIREMENTS

NOTE:
ALL SECTIONS ON THIS PAGE TO BE READ IN CONJUNCTION WITH UNIT SECTIONS ON SHEET A2

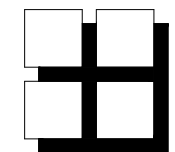

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POST SCHEDULE
P1 - 3" DIA. ADJUSTABLE STEEL TELEPOST
8500 ROUND CAP. (MIN.)
P2 - 2"x24, 6 OR 8" (AS APPLICABLE)
P3 - 3"x24, 6 OR 8" (AS APPLICABLE)
P4 - 4"x24, 6 OR 8" (AS APPLICABLE)
P5 - 5"x24, 6 OR 8" (AS APPLICABLE)
P6 - HSS 3 1/2"x3 1/2", 180 C/W 5/8"x8" B PL. & CAP PL.
P7 - HSS 4"x4", 180 C/W 5/8"x8" B PL. & CAP PL.
P8 - P.T. 6'x6'
NOTE:
ALL WOOD POST LOCATIONS TO BE BLOCKED SOLID, THRU FLOOR STRUCTURE OR TO A STEEL/WOOD BEAM OR ON TO THE CONC. FOUNDATION WALL

LINTEL/ BEAM SCHEDULE
SEE INDICATED ON PLANS
BRICK LINTELS
OPENINGS UP TO 5'-0"
5'-0" TO 7'-0"
7'-0" TO 8'-0"
8'-0" TO 9'-0"
9'-0" TO 10'-0"
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