

Planning and Development Services

Building Division

8850 McLaughlin Road, Unit 1 Brampton, ON L6Y 5T1

WATER PIPE SIZING AND PLUMBING DATA SHEET **CERTIFIED MODEL WITH ONE DWELLING UNIT**


THIS TABLE IS APPLICABLE FOR A HOUSE AFTER DECEMBER 31, 2017

ROYAL PINE HOMES Builder Name: Certified Model Name: 2203.T3 (#78693)

minimum size of water service will automatically be calculated.

Optional Floor Layout:

Application No.:

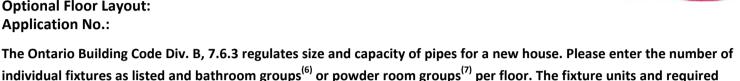

Description	Basement Floor	First Floor	Second Floor	Third Floor
	Qty.	Qty.	Qty.	Qty.
Bathroom group ⁽⁶⁾	1		2	
Bidet				
Extra Shower			1	
Lav				
Bar Sink				
Powder room ⁽⁷⁾		1		
Kitchen Sink		1		
Dishwasher		1		
Laundry Tub		1		
Washing Machine		1		
Hose Bib		2		

Total Fixture Units 25.7


Minimum Diametre of Water Service Pipe


Required from the Property Line to the 3/4

House (Inch)

Notes:

- (1) A potable water system shall be designed, constructed and installed to conform to good engineering practice appropriate to the circumstances, such as that described in the ASHRAE Handbooks and ASPE
- (2) No water system between the point of connection with the water service pipe or the water meter and the first branch that supplies a water heater that serves more than one fixture shall be less than ¾ in.
- (3) The minimum water pressure at the entry to the building is 200 kPa, and the total maximum length of the water system is 90 m.
- (4) In a hot water distribution system of a developed length of more than 30 m from the HWT to the farthest fixture or supplying more than 4 storeys, the water temperature shall be maintained by, (a) recirculation, or (b) a self-regulating heat tracing system.
- (5) Where piping may be exposed to freezing conditions, it shall be protected from the effects of freezing.
- (6) A bathroom group consists of 1 water closet, 1 lavatory, and 1 bathtub (with or without showerhead)
- (7) A powder room group consists of 1 water closet and 1 lavatory.

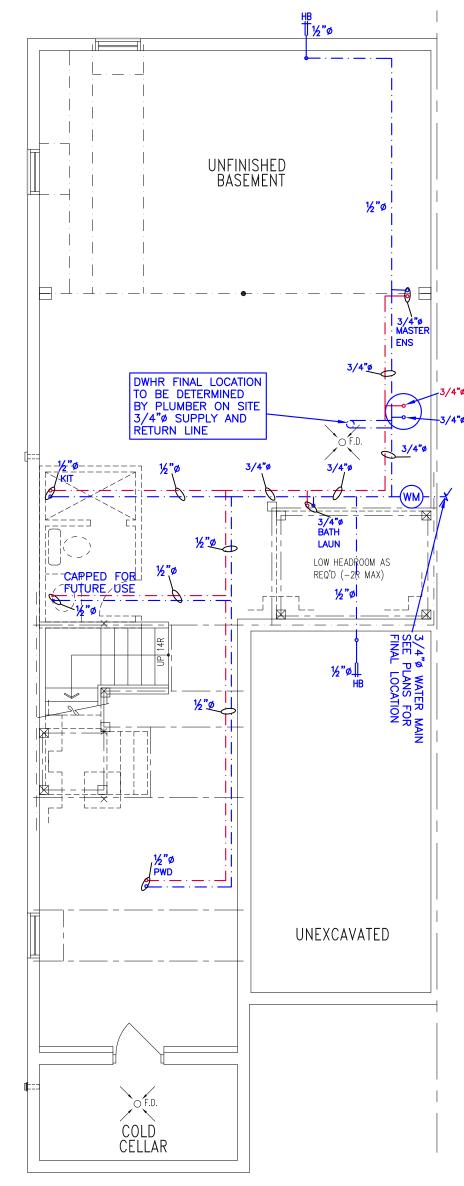

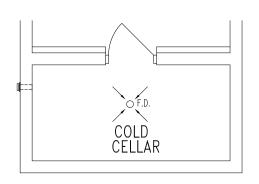

BASEMENT PLAN, EL. 'B'

NOTES

- DRAWINGS ARE TO BE PRINTED IN COLOUR
 WHERE A 3/4"ø TUB SPOUT/ SPIGOT CONNECTION IS USED ON THE BATHTUB FAUCET THE WATER SUPPLY PIPE SHALL BE 3/4"ø TO THE BRANCH FOR THE BATHTUB
 BASEMENT BATHROOM ROUGH-IN SHALL BE USED IN SIZING
- OF WATER PIPE
 EXACT LOCATION OF ALL PLUMBING PIPING TO BE
 DETERMINED ON SITE

LEGEND

BASEMENT PLAN, EL. 'A'

SYMBOL	DESCRIPTION (SEE PLAN FOR PIPE SIZING)
- · - WM- · -	WATER METER, PROVIDE SUPPLY PIPE SIZE/ Ø
нв₩	HOSE BIB
 · •	PROPOSED COLD WATER LINE & RISER
 · •	PROPOSED HOT WATER LINE & RISER
⊕ FD	FLOOR DRAIN



ROYAL PINE HOMES

Project Name

FORESTSIDE BRAMPTON, ONTARIO

375 Finley Ave. Suite 202 - Ajax, Ontario L1S 2E2 Tel. 905.619.2300 - 905.420.5300 Fax 905.619.2375 Email: info@hvacdesigns.ca Web: www.hvacdesigns.ca Specializing in Residential Mechanical Design Services

BASEMENT
PLUMBING


Sheet Title


LO#

MAY/2019 3/16" = 1'-0" BCIN# 19669

78693

2203.T3 2308 sqft

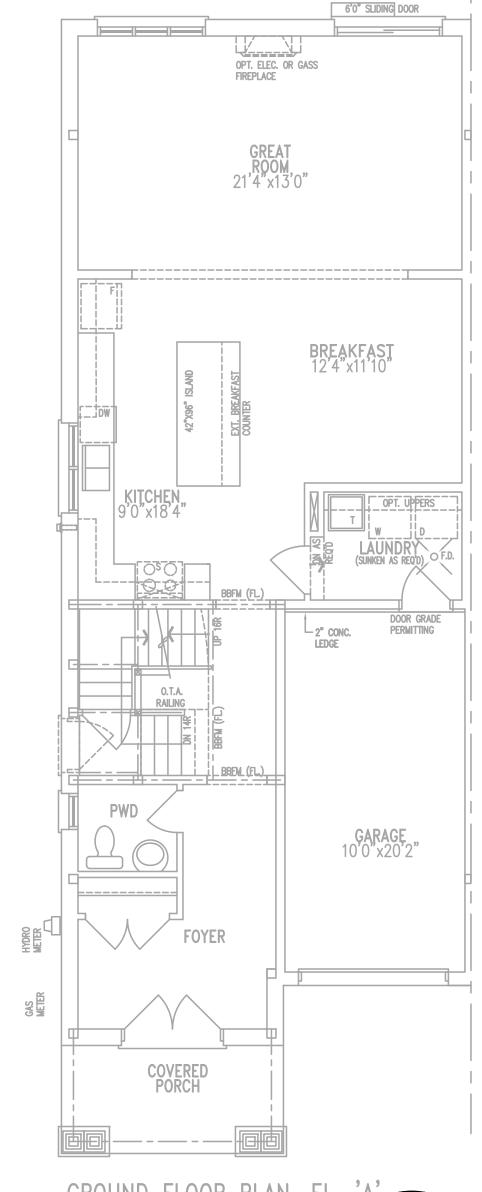

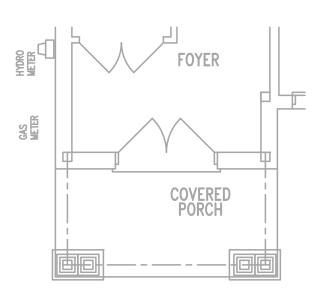

GROUND FLOOR PLAN, EL. 'B'



Cllent

ROYAL PINE HOMES

Project Name

2203.T3

FORESTSIDE BRAMPTON, ONTARIO

2308 sqft

HVA DESIGNS LTD.

375 Finley Ave. Suite 202 - Ajax, Ontario
L1S 2E2 Tel. 905.619.2300 - 905.420.5300 Fax 905.619.2375
Email: info@hvacdesigns.ca
Web: www.hvacdesigns.ca
Specializing in Residential Mechanical Design Services


FIRST FLOOR


PLUMBING


mate MAY/2019
cale 3/16" = 1'-0"

BCIN# 19669

LO# 78693

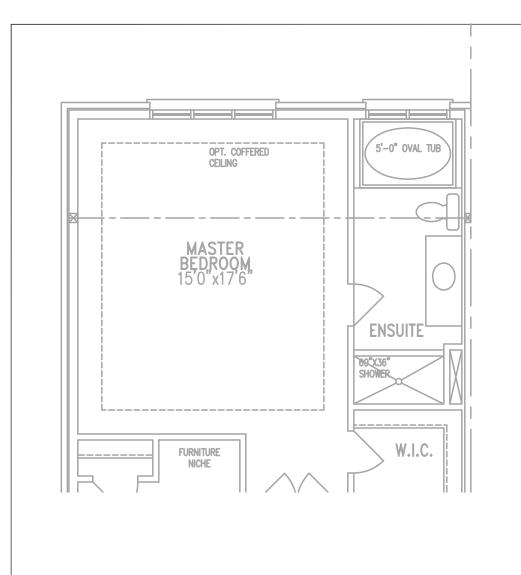

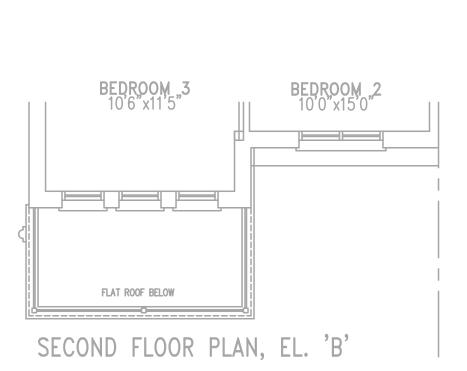

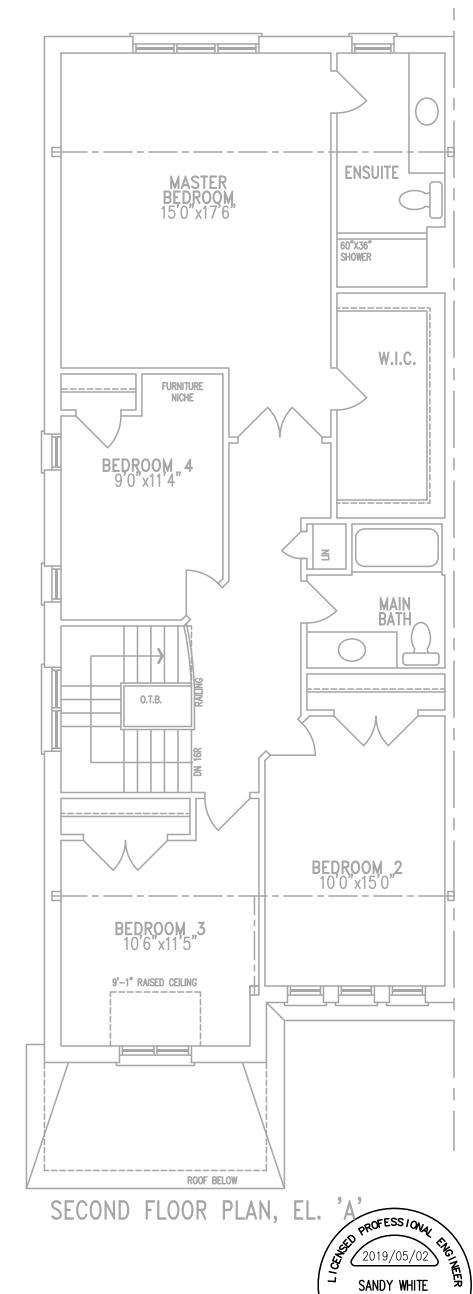



FORESTSIDE BRAMPTON, ONTARIO

375 Finley Ave. Suite 202 - Ajax, Ontario L1S 2E2 Tel. 905.619.2300 - 905.420.5300 Fax 905.619.2375 Email: info@hvacdesigns.ca Web: www.hvacdesigns.ca Specializing in Residential Mechanical Design Services

SECOND FLOOR **PLUMBING**

SANDY WHITE

POVINCE OF

MAY/2019 3/16" = 1'-0"

BCIN# 19669 78693 LO#

2203.T3 2308 sqft