ELEVATION A (4 BEDROOM)

DOOR & WINDOWS GLASS AREA TO PERIPHERAL INSULATED WALLS RATIO--O.B.C. SB-12 ART. 3.1.1.2(1) ELEVATION A

ROOM	QUANTITY	WIDTH(IN.)	HEIGHT(IN.)	ARCH AREA	WINDOW / DOOR R.S.O. (SQ.FT.)	WINDOW / DOOR R.S.O. (SQ.M.)
BASEMENT	6	30	16	0	20.00	1.86
FOYER	2	23	55	0	17.57	1.63
FOTER	1	0	0	4.59	4.59	0.43
DINING/LIVING ROOM	2	48	62	0	41.33	3.84
BREAKFAST	1	36	62	0	15.50	1.44
DREAKI AST	1	108	96	0	72.00	6.69
FAMILY ROOM	2	36	68	0	34.00	3.16
MUDROOM (SUNKEN)	1	24	40	0	6.67	0.62
MASTER BEDROOM	2	48	52	0	34.67	3.22
 MASTER ENSUITE	1	48	52	0	17.33	1.61
WASTER ENSOTTE	1	36	56	0	14.00	1.30
BEDROOM NO.2	1	48	52	0	17.33	1.61
SHARED BATH	1	24	40	0	6.67	0.62
BEDROOM NO.3	2	30	56	0	23.33	2.17
ENSUITE NO.2	1	24	62	0	10.33	0.96
LINSUITE NO.2	1	0	0	2.69	2.69	0.25
BEDROOM NO.4	1	72	56	0	28.00	2.60
BEDITOON NO.4	1	0	0	8.01	8.01	0.74
LAUNDRY	1	24	40	0	6.67	0.62
STAIRS (UPPER HALL)	1	42	68	1	20.83	1.94
DRESSING ROOM	1	36	52	0	13.00	1.21
TOTAL	31	-	-	-	414.53	38.51
WALL AREA	-	-	-	-	4156.30	386.13
RATIO	-	-	-	-	9.97	9.97

ELEVATION A (5 BEDROOM)

DOOR & WINDOWS GLASS AREA TO PERIPHERAL INSULATED WALLS RATIOO.B.C. SB-12 ART. 3.1.1.2(1) ELEVATION A								
ROOM	QUANTITY	WIDTH(IN.)	HEIGHT(IN.)	ARCH AREA	WINDOW / DOOR R.S.O. (SQ.FT.)	WINDOW / DOOR R.S.O. (SQ.M.)		
BASEMENT	6	30	16	0	20.00	1.86		
FOYER	2	23	55	0	17.57	1.63		
FOTER	1	0	0	4.59	4.59	0.43		
DINING/LIVING ROOM	2	48	62	0	41.33	3.84		
BREAKFAST	1	36	62	0	15.50	1.44		
DREARFAST	1	108	96	0	72.00	6.69		
FAMILY ROOM	2	36	68	0	34.00	3.16		
MUDROOM (SUNKEN)	1	24	40	0	6.67	0.62		
MASTER BEDROOM	2	48	52	0	34.67	3.22		
DRESSING ROOM	1	24	52	0	8.67	0.81		
BEDROOM NO.2	2	24	52	0	17.33	1.61		
SHARED BATH	1	24	40	0	6.67	0.62		
BEDROOM NO.3	1	48	52	0	17.33	1.61		
BEDROOM NO.4	2	30	56	0	23.33	2.17		
SHARED BATH	1	24	62	0	10.33	0.96		
SHARLD BATTI	1	0	0	2.69	2.69	0.25		
BEDROOM NO.5	1	72	56	0	28.00	2.60		
DEDITOON NO.3	1	0	0	8.01	8.01	0.74		
LAUNDRY	1	24	40	0	6.67	0.62		
STAIRS (UPPER HALL)	1	42	62	0	18.08	1.68		
MASTER ENSUITE	1	48	52	0	17.33	1.61		
TOTAL	32	-	-	-	410.78	38.16		
WALL AREA	-				4156.30	386.13		
RATIO	-	-	-	-	9.88	9.88		

W Architect Inc.

DESIGN CONTROL REVIEW
JANUARY 21, 2022

FINAL
RECERT BY: GGE

This stamp is only for the purposes of design control and carries no other professional obligations.

MODEL 40-3 SOPHIA

	DEC. <i>08/2</i> 1 NOV. <i>05/2</i> 1	RE-186UED FOR BUILDING PERMIT 186UED FOR BUILDING PERMIT	MS MS
I.	SEPT. 21/21	166UED TO STRUCT, ENG. /HVAC FOR REVIEW AND COMMENTS	MS
No:	DATE:	REVISION/ISSUED:	BY:





SURIANO.

ARCHITECTURAL DESIGN

SURIANO DESIGN CONSULTANTS INC. 51 Roysun Road, Unit 1 Vaughan, Ontario L4L 8P9 T. 905-264-0924

SHEET NAME: INSULATED WALL & WINDOWS OPENING AREA CALCULATION (A)							
DATE PLOTTED:	DRAWN BY:	AREA:					
DEC. Ø8/21	M.H./J.LAM	3223 SQ.FT.					
DATE:	TYPE:	PAGE No:	PR				
OCT. 23/2Ø							
SCALE:	PROJECT No:	Ø 1	мо				
3/16"=1'-0"	20-103		~				

ROYAL PINE HOMES

PROJECT NAME:

MODEL NAME:

ELEVATION A (4 BEDROOM) WITH WOOD DECK CONDITION

DOOR & WINDOWS GLASS AREA TO PERIPHERAL INSULATED WALLS RATIO--O.B.C. SB-12 ART. 3.1.1.2(1) **ELEVATION A** | WINDOW / DOOR | WINDOW / DOOR QUANTITY | WIDTH(IN.) | HEIGHT(IN.) | ARCH AREA ROOM R.S.O. (SQ.FT.) R.S.O. (SQ.M.) 16.67 1.55 5 30 16 0 BASEMENT 0.46 30 24 0 5.00 2 23 55 17.57 1.63 0 FOYER 4.59 4.59 0.43 0 0 DINING/LIVING ROOM 48 62 41.33 3.84 2 0 36 62 0 15.50 1.44 BREAKFAST 108 96 72.00 6.69 0 FAMILY ROOM 2 36 68 0 34.00 3.16 MUDROOM (SUNKEN) 24 40 0 6.67 0.62 MASTER BEDROOM 52 2 48 0 34.67 3.22 52 48 0 17.33 1.61 MASTER ENSUITE 56 36 0 14.00 1.30 BEDROOM NO.2 48 52 0 17.33 1.61 SHARED BATH 24 40 0 6.67 0.62 BEDROOM NO.3 2 30 56 0 23.33 2.17

62

0

56

0

40

68

52

0

2.69

0

8.01

0

0

10.33

2.69

28.00

8.01

6.67

20.83

13.00

416.19

4323.81

0.96

0.25

2.60

0.74

0.62

1.94

1.21

38.67

401.69

9.63

24

0

72

0

24

42

36

31

ENSUITE NO.2

BEDROOM NO.4

DRESSING ROOM

STAIRS (UPPER HALL)

LAUNDRY

TOTAL

RATIO

WALL AREA


ELEVATION A (5 BEDROOM) WITH WOOD DECK CONDITION

DOOR & WINDOWS GLASS AREA TO PERIPHERAL INSULATED WALLS RATIOO.B.C. SB-12 ART. 3.1.1.2(1) ELEVATION A							
ROOM	QUANTITY	WIDTH(IN.)	HEIGHT(IN.)	ARCH AREA	WINDOW / DOOR R.S.O. (SQ.FT.)	WINDOW / DOOR R.S.O. (SQ.M.)	
BASEMENT	5	30	16	0	16.67	1.55	
DASEMENT	1	30	24	0	0.00	0.00	
FOYER	2	23	55	0	17.57	1.63	
FUTER	1	0	0	4.59	4.59	0.43	
DINING/LIVING ROOM	2	48	62	0	41.33	3.84	
BREAKFAST	1	36	62	0	15.50	1.44	
DREARFAST	1	108	96	0	72.00	6.69	
FAMILY ROOM	2	36	68	0	34.00	3.16	
MUDROOM (SUNKEN)	1	24	40	0	6.67	0.62	
MASTER BEDROOM	2	48	52	0	34.67	3.22	
DRESSING ROOM	1	24	52	0	8.67	0.81	
BEDROOM NO.2	2	24	52	0	17.33	1.61	
SHARED BATH	1	24	40	0	6.67	0.62	
BEDROOM NO.3	1	48	52	0	17.33	1.61	
BEDROOM NO.4	2	30	56	0	23.33	2.17	
SHARED BATH	1	24	62	0	10.33	0.96	
SHANLD DATTI	1	0	0	2.69	2.69	0.25	
BEDROOM NO.5	1	72	56	0	28.00	2.60	
DEDITOON NO.3	1	0	0	8.01	8.01	0.74	
LAUNDRY	1	24	40	0	6.67	0.62	
STAIRS (UPPER HALL)	1	42	62	0	18.08	1.68	
MASTER ENSUITE	1	48	52	0	17.33	1.61	
TOTAL	32	-	_	-	407.44	37.85	
WALL AREA	-	-	-	-	4323.81	401.69	
RATIO	-	-	-	-	9.42	9.42	



MODEL 40-3 SOPHIA

3.	DEC. 08/21	RE-ISSUED FOR BUILDING PERMIT	MS
2.	NOV. Ø5/21	ISSUED FOR BUILDING PERMIT	MS
i.	SEPT. 21/21	ISSUED TO STRUCT, ENG. /HVAC FOR REVIEW AND COMMENTS	JLAM
No:	DATE:	REVISION/ISSUED:	BY:

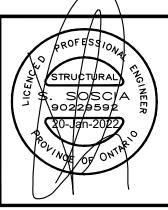

ONTARIO
ASSOCIATION
OF ARCHITECTS

LICENSED TECHNOLOGIST
OAA

MICHELE SURIANO
LICENCE
6253

SURIANO.

ARCHITECTURAL DESIGN

SURIANO DESIGN CONSULTANTS INC. 51 Roysun Road, Unit 1 Vaughan, Ontario L4L 8P9 T. 905-264-0924

SHEET NAME: INSULATED WALL & WINDOWS OPENING AREA CALCULATION (A)							
DATE PLOTTED:	DRAWN BY:	AREA:					
DEC. Ø8/21	M.H./J.L.AM	3223 SQ.FT.					
DATE:	TYPE:	PAGE No:					
OCT. 23/20							
		Ø2					
SCALE:	PROJECT No:						
3/16"=1'-0"	20-103						

ROYAL PINE HOMES

PROJECT NAME:

DDEL NAME:

ELEVATION A (4 BEDROOM) WITH WALK-UP BASEMENT CONDITION

DOOR & WINDOWS GLASS AREA TO PERIPHERAL INSULATED WALLS RATIO--O.B.C. SB-12 ART. 3.1.1.2(1) **ELEVATION A**

ROOM	QUANTITY	WIDTH(IN.)	HEIGHT(IN.)	ARCH AREA	WINDOW / DOOR R.S.O. (SQ.FT.)	WINDOW / DOOR R.S.O. (SQ.M.)
BASEMENT	5	30	16	0	16.67	1.55
DASEMENT	1	20	32	0	4.44	0.41
FOYER	2	23	55	0	17.57	1.63
TOTEK	1	0	0	4.59	4.59	0.43
DINING/LIVING ROOM	2	48	62	0	41.33	3.84
 BREAKFAST	1	36	62	0	15.50	1.44
DILANI AST	1	108	96	0	72.00	6.69
FAMILY ROOM	2	36	68	0	34.00	3.16
MUDROOM (SUNKEN)	1	24	40	0	6.67	0.62
MASTER BEDROOM	2	48	52	0	34.67	3.22
MASTER ENSUITE	1	48	52	0	17.33	1.61
WASTER ENSUITE	1	36	56	0	14.00	1.30
BEDROOM NO.2	1	48	52	0	17.33	1.61
SHARED BATH	1	24	40	0	6.67	0.62
BEDROOM NO.3	2	30	56	0	23.33	2.17
ENSUITE NO.2	1	24	62	0	10.33	0.96
ENSUITE NO.2	1	0	0	2.69	2.69	0.25
BEDROOM NO.4	1	72	56	0	28.00	2.60
BLDROOM NO.4	1	0	0	8.01	8.01	0.74
LAUNDRY	1	24	40	0	6.67	0.62
STAIRS (UPPER HALL)	1	42	68	1	20.83	1.94
DRESSING ROOM	1	36	52	0	13.00	1.21
TOTAL	31	-	-	-	415.64	38.61
WALL AREA	-	-	-	-	3987.37	370.44
RATIO	_	-	-	-	10.42	10.42

W Architect Inc. DESIGN CONTROL REVIEW JANUARY 21, 2022 FINAL RECERT BY: GGE


WITH WALK-UP BASEMENT CONDITION

ELEVATION A (5 BEDROOM)

DOOR & WINDOWS GLASS AREA TO PERIPHERAL INSULATED WALLS RATIOO.B.C. SB-12 ART. 3.1.1.2(1) ELEVATION A							
ROOM	QUANTITY	WIDTH(IN.)	HEIGHT(IN.)	ARCH AREA	WINDOW / DOOR R.S.O. (SQ.FT.)	WINDOW / DOOR R.S.O. (SQ.M.)	
DACEMENT	5	30	16	0	16.67	1.55	
BASEMENT	1	20	32	0	4.44	0.41	
FOYER	2	23	55	0	17.57	1.63	
FUTER	1	0	0	4.59	4.59	0.43	
DINING/LIVING ROOM	2	48	62	0	41.33	3.84	
BREAKFAST	1	36	62	0	15.50	1.44	
BREAKFAST	1	108	96	0	72.00	6.69	
FAMILY ROOM	2	36	68	0	34.00	3.16	
MUDROOM (SUNKEN)	1	24	40	0	6.67	0.62	
MASTER BEDROOM	2	48	52	0	34.67	3.22	
DRESSING ROOM	1	24	52	0	8.67	0.81	
BEDROOM NO.2	2	24	52	0	17.33	1.61	
SHARED BATH	1	24	40	0	6.67	0.62	
BEDROOM NO.3	1	48	52	0	17.33	1.61	
BEDROOM NO.4	2	30	56	0	23.33	2.17	
CHADED DATH	1	24	62	0	10.33	0.96	
SHARED BATH	1	0	0	2.69	2.69	0.25	
DEDDOOM NO E	1	72	56	0	28.00	2.60	
BEDROOM NO.5	1	0	0	8.01	8.01	0.74	
LAUNDRY	1	24	40	0	6.67	0.62	
STAIRS (UPPER HALL)	1	42	62	0	18.08	1.68	
MASTER ENSUITE	1	48	52	0	17.33	1.61	
TOTAL	32	-	-	-	411.89	38.27	
WALL AREA	-	-	-	-	3987.37	370.44	
RATIO	-	-	-	-	10.33	10.33	

MODEL 40-3 SOPHIA

3.	DEC. Ø8/21	RE-166UED FOR BUILDING PERMIT	MS	
2.	NOV. Ø5/21	ISSUED FOR BUILDING PERMIT	MS	
l.	SEPT. 21/21	198UED TO STRUCT, ENG. /HVAC FOR REVIEW AND COMMENTS	JLAM	
No:	DATE:	REVISION/ISSUED:	BY:	

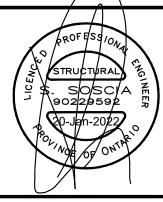

ONTARIO ASSOCIATION OF ARCHITECTS LICENSED TECHNOLOGIST MICHELE SURIANO LICENCE 6253

SURIANO. ARCHITECTURAL DESIGN

SURIANO DESIGN CONSULTANTS INC. 51 Roysun Road, Unit 1 Vaughan, Ontario L4L 8P9 T. 905-264-0924

	D WALL & REA CALCU		ROYAL PINE
DATE PLOTTED:	DRAWN BY:	AREA:	
DEC. Ø8/21	M.H./J.LAM	3223 SQ.FT.	
DATE:	TYPE:	PAGE No:	PROJECT NAME:
OCT. 23/2Ø		<i>(</i> 2)	
SCALE:	PROJECT No:	<i>Ø</i> 3	MODEL NAME:
3/16"=1'-0"	20-103		MODEL 40-3 SOPHIA

ELEVATION B (4 BEDROOM)

DOOR & WINDOWS GLASS AREA TO PERIPHERAL INSULATED WALLS RATIO--O.B.C. SB-12 ART. 3.1.1.2(1) ELEVATION B

ROOM	QUANTITY	WIDTH(IN.)	HEIGHT(IN.)	ARCH AREA	WINDOW / DOOR R.S.O. (SQ.FT.)	WINDOW / DOOR R.S.O. (SQ.M.)
BASEMENT	6	30	16	0	20.00	1.86
FOVED	2	11	80	0	12.22	1.14
FOYER	1	12	66	0	5.50	0.51
DINING / LIVING ROOM	2	48	62	0	41.33	3.84
BREAKFAST	1	36	62	0	15.50	1.44
DREARFAST	1	108	96	0	72.00	6.69
FAMILY ROOM	2	36	68	0	34.00	3.16
MUDROOM (SUNKEN)	1	24	40	0	6.67	0.62
MASTER BEDROOM	2	48	52	0	34.67	3.22
MASTER ENSUITE	1	48	52	0	17.33	1.61
WASTER ENSUITE	1	36	56	0	14.00	1.30
BEDROOM NO.2	1	48	52	0	17.33	1.61
SHARED BATH	1	24	40	0	6.67	0.62
BEDROOM NO.3	1	24	74	0	12.33	1.15
BEDROOM NO.3	1	60	74	0	30.83	2.86
ENSUITE NO.2	1	24	92	0	15.33	1.42
	1	24	74	0	12.33	1.15
BEDROOM NO.4	1	8	32	0	1.78	0.17
	1	24	72	0	12.00	1.11
LAUNDRY	1	24	40	0	6.67	0.62
STAIR (UPPER HALL)	1	42	62	0	18.08	1.68
DRESSING ROOM	1	36	52	0	13.00	1.21
TOTAL	31	-	-	-	419.58	38.98
WALL AREA	-	-	-	-	4148.30	385.39
RATIO	-	-	-	-	10.11	10.11

ELEVATION B (5 BEDROOM)

DOOR & WINDOWS GLASS AREA TO PERIPHERAL INSULATED WALLS RATIOO.B.C. SB-12 ART. 3.1.1.2(1) ELEVATION B						
ROOM	QUANTITY	WIDTH(IN.)	HEIGHT(IN.)	ARCH AREA	WINDOW / DOOR R.S.O. (SQ.FT.)	WINDOW / DOOR R.S.O. (SQ.M.)
BASEMENT	6	30	16	0	20.00	1.86
FOYER	2	11	80	0	12.22	1.14
FUTER	1	12	66	0	5.50	0.51
DINING / LIVING ROOM	2	48	62	0	41.33	3.84
BREAKFAST	1	36	62	0	15.50	1.44
DKEAKFAST	1	108	96	0	72.00	6.69
FAMILY ROOM	2	36	68	0	34.00	3.16
MUDROOM (SUNKEN)	1	24	40	0	6.67	0.62
MASTER BEDROOM	2	48	52	0	34.67	3.22
MASTER BEDROOM	2	48	52	0	34.67	3.22
DRESSING ROOM	1	24	52	0	8.67	0.81
BEDROOM NO.2	2	24	52	0	17.33	1.61
SHARED BATH	1	24	40	0	6.67	0.62
BEDROOM NO.3	1	48	52	0	17.33	1.61
BEDROOM NO.4	1	24	74	0	12.33	1.15
DEDROUM NO.4	1	60	74	0	30.83	2.86
SHARED BATH	1	24	92	0	15.33	1.42
	1	24	74	0	12.33	1.15
BEDROOM NO.5	1	8	32	0	1.78	0.17
	1	24	72	0	12.00	1.11
LAUNDRY	1	24	40	0	6.67	0.62
STAIRS (UPPER HALL)	1	42	62	0	18.08	1.68
MASTER ENSUITE	1	48	52	0	17.33	1.61
TOTAL	34	-	-	-	453.25	42.11
WALL AREA	-	-	-	-	4148.30	385.39
RATIO	-	-	-	-	10.93	10.93



MODEL 40-3 SOPHIA

3.	DEC. Ø8/21	RE-199UED FOR BUILDING PERMIT	MS
2.	NOV. Ø5/21	ISSUED FOR BUILDING PERMIT	MS
l.	SEPT. 21/21	ISSUED TO STRUCT, ENG. /HVAC FOR REVIEW AND COMMENTS	JLAM
No:	DATE:	REVISION/ISSUED:	BY:





SURIANO.

ARCHITECTURAL DESIGN

SURIANO DESIGN CONSULTANTS INC.
51 Roysun Road, Unit 1
Vaughan, Ontario L4L 8P9
T. 905-264-0924

SHEET NAME: INSULATED WALL & WINDOWS OPENING AREA CALCULATION (B)					
DATE PLOTTED:	DRAWN BY:	AREA:			
DEC. Ø8/21	M.H./J.L.AM	3223 SQ.FT.			
DATE:	TYPE:	PAGE No:			
OCT. 23/2Ø					
		l ax l			
SCALE:	PROJECT No:	Ø4			
3/16"=1'-0"	20-103				

ROYAL PINE HOMES

ELEVATION B (4 BEDROOM) WITH WOOD DECK CONDITION

DOOR & WINDOWS GLASS AREA TO PERIPHERAL INSULATED WALLS RATIO--O.B.C. SB-12 ART. 3.1.1.2(1) **ELEVATION B**

ROOM	QUANTITY	WIDTH(IN.)	HEIGHT(IN.)	ARCH AREA	WINDOW / DOOR R.S.O. (SQ.FT.)	WINDOW / DOOR R.S.O. (SQ.M.)
BASEMENT	5	30	16	0	16.67	1.55
DAGLIVILINI	1	30	24	0	5.00	0.46
FOYER	2	11	80	0	12.22	1.14
TOTER	1	12	66	0	5.50	0.51
DINING / LIVING ROOM	2	48	62	0	41.33	3.84
BREAKFAST	1	36	62	0	15.50	1.44
DIVEARITAGE	1	108	96	0	72.00	6.69
FAMILY ROOM	2	36	68	0	34.00	3.16
MUDROOM (SUNKEN)	1	24	40	0	6.67	0.62
MASTER BEDROOM	2	48	52	0	34.67	3.22
MASTER ENSUITE	1	48	52	0	17.33	1.61
WASTER ENSOTTE	1	36	56	0	14.00	1.30
BEDROOM NO.2	1	48	52	0	17.33	1.61
SHARED BATH	1	24	40	0	6.67	0.62
BEDROOM NO.3	1	24	74	0	12.33	1.15
BEDITOOM NO.3	1	60	74	0	30.83	2.86
ENSUITE NO.2	1	24	92	0	15.33	1.42
	1	24	74	0	12.33	1.15
BEDROOM NO.4	1	8	32	0	1.78	0.17
	1	24	72	0	12.00	1.11
LAUNDRY	1	24	40	0	6.67	0.62
STAIR (UPPER HALL)	1	42	62	0	18.08	1.68
DRESSING ROOM	1	36	52	0	13.00	1.21
TOTAL	31	-	-	-	421.25	39.14
WALL AREA	-	-	-	-	4315.81	400.95
RATIO	-	-	-	-	9.76	9.76

ELEVATION B (5 BEDROOM) WITH WOOD DECK CONDITION

DOOR & WINDOWS GLASS AREA TO PERIPHERAL INSULATED
WALLS RATIOO.B.C. SB-12 ART. 3.1.1.2(1)
ELEVATION B

ROOM	QUANTITY	WIDTH(IN.)	HEIGHT(IN.)	ARCH AREA	WINDOW / DOOR R.S.O. (SQ.FT.)	WINDOW / DOOR R.S.O. (SQ.M.)
BASEMENT	5	30	16	0	16.67	1.55
DASEIVIEIVI	1	30	24	0	5.00	0.46
FOYER	2	11	80	0	12.22	1.14
FUTER	1	12	66	0	5.50	0.51
DINING / LIVING ROOM	2	48	62	0	41.33	3.84
BREAKFAST	1	36	62	0	15.50	1.44
DREARFAST	1	108	96	0	72.00	6.69
FAMILY ROOM	2	36	68	0	34.00	3.16
MUDROOM (SUNKEN)	1	24	40	0	6.67	0.62
MASTER BEDROOM	2	48	52	0	34.67	3.22
MASTER BEDROOM	2	48	52	0	34.67	3.22
DRESSING ROOM	1	24	52	0	8.67	0.81
BEDROOM NO.2	2	24	52	0	17.33	1.61
SHARED BATH	1	24	40	0	6.67	0.62
BEDROOM NO.3	1	48	52	0	17.33	1.61
BEDROOM NO.4	1	24	74	0	12.33	1.15
DEDROOM NO.4	1	60	74	0	30.83	2.86
SHARED BATH	1	24	92	0	15.33	1.42
	1	24	74	0	12.33	1.15
BEDROOM NO.5	1	8	32	0	1.78	0.17
	1	24	72	0	12.00	1.11
LAUNDRY	1	24	40	0	6.67	0.62
STAIRS (UPPER HALL)	1	42	62	0	18.08	1.68
MASTER ENSUITE	1	48	52	0	17.33	1.61
TOTAL	34	•	-	-	454.92	42.26
WALL AREA	-	-	-	-	4315.81	400.95
RATIO	-	-	-	-	10.54	10.54

W Architect Inc. DESIGN CONTROL REVIEW JANUARY 21, 2022 RECERT BY: GGE

MODEL 40-3 SOPHIA

3.	DEC. Ø8/21	RE-199UED FOR BUILDING PERMIT	MS
2.	NOV. Ø5/21	ISSUED FOR BUILDING PERMIT	MS
1.	SEPT. 21/21	ISSUED TO STRUCT, ENG. /HVAC FOR REVIEW AND COMMENTS	JLAM
No:	DATE:	REVISION/ISSUED:	BY:





SURIANO. ARCHITECTURAL DESIGN

SURIANO DESIGN CONSULTANTS INC. 51 Roysun Road, Unit 1 Vaughan, Ontario L4L 8P9 T. 905-264-0924

SHEET NAME:			
INSULATE	D WALL \$	WINDOWS	5
OPENING A	REA CALCU	LATION (B)	
DATE PLOTTED:	DRAWN BY:	AREA:	
DEC. Ø8/21	M.H./J.L.AM	3223 SQ.FT.	
DATE:	TYPE:	PAGE No:	PROJECT NAME:
OCT. 23/20			
		ØE	
SCALE:	PROJECT No:	Ø5	MODEL NAME:
3/16"=1'-0"	20-103		MOD

ROYAL PINE HOMES

ELEVATION B (4 BEDROOM) WITH WALK-UP BASEMENT CONDITION

DOOR & WINDOWS GLASS AREA TO PERIPHERAL INSULATED WALLS RATIO-O.B.C. SB-12 ART. 3.1.1.2(1) **ELEVATION B** | WINDOW / DOOR | WINDOW / DOOR QUANTITY | WIDTH(IN.) | HEIGHT(IN.) | ARCH AREA ROOM R.S.O. (SQ.FT.) R.S.O. (SQ.M.) 16.67 1.55 5 30 16 BASEMENT 20 32 0 4.44 0.41 2 11 80 0 12.22 1.14 **FOYER** 12 66 0 5.50 0.51 DINING / LIVING ROOM 2 48 62 0 41.33 3.84 36 62 0 15.50 1.44 **BREAKFAST** 108 96 0 72.00 6.69 FAMILY ROOM 2 36 68 0 34.00 3.16 MUDROOM (SUNKEN) 24 40 0 6.67 0.62 MASTER BEDROOM 2 48 52 0 34.67 3.22 48 52 17.33 1.61 0 MASTER ENSUITE 36 56 0 14.00 1.30 BEDROOM NO.2 48 52 17.33 1.61 0 SHARED BATH 24 40 0 6.67 0.62 12.33 24 74 0 1.15 BEDROOM NO.3 60 74 0 30.83 2.86 ENSUITE NO.2 24 92 15.33 1.42 0 12.33 1.15 24 74 0 BEDROOM NO.4 32 0 1.78 0.17 8 24 72 0 12.00 1.11 LAUNDRY 24 40 6.67 0.62 0 STAIR (UPPER HALL) 42 62 0 18.08 1.68 DRESSING ROOM 52 13.00 1.21 36 0

ELEVATION B (5 BEDROOM) WITH WALK-UP BASEMENT CONDITION

		ALLS RATIO-		ERIPHERAL II ART. 3.1.1.2(1		
ROOM	QUANTITY	WIDTH(IN.)	HEIGHT(IN.)	ARCH AREA	WINDOW / DOOR R.S.O. (SQ.FT.)	WINDOW / DOOR R.S.O. (SQ.M.)
BASEMENT	5	30	16	0	16.67	1.55
DASCIVICINI	1	20	32	0	4.44	0.41
FOYER	2	11	80	0	12.22	1.14
FOILK	1	12	66	0	5.50	0.51
DINING / LIVING ROOM	2	48	62	0	41.33	3.84
BREAKFAST	1	36	62	0	15.50	1.44
DICARI AST	1	108	96	0	72.00	6.69
FAMILY ROOM	2	36	68	0	34.00	3.16
MUDROOM (SUNKEN)	1	24	40	0	6.67	0.62
MASTER BEDROOM	2	48	52	0	34.67	3.22
MASTER BEDROOM	2	48	52	0	34.67	3.22
DRESSING ROOM	1	24	52	0	8.67	0.81
BEDROOM NO.2	2	24	52	0	17.33	1.61
SHARED BATH	1	24	40	0	6.67	0.62
BEDROOM NO.3	1	48	52	0	17.33	1.61
BEDROOM NO.4	1	24	74	0	12.33	1.15
DEDROOM NO.4	1	60	74	0	30.83	2.86
SHARED BATH	1	24	92	0	15.33	1.42
	1	24	74	0	12.33	1.15
BEDROOM NO.5	1	8	32	0	1.78	0.17
	1	24	72	0	12.00	1.11
LAUNDRY	1	24	40	0	6.67	0.62
STAIRS (UPPER HALL)	1	42	62	0	18.08	1.68
MASTER ENSUITE	1	48	52	0	17.33	1.61
TOTAL	34	-	-	-	454.36	42.21
WALL AREA	-	-	-	-	4241.69	394.07
RATIO	-	-	-	-	10.71	10.71

W Architect Inc. **DESIGN CONTROL REVIEW** JANUARY 21, 2022 RECERT BY: GGE

MODEL 40-3 SOPHIA

3.	DEC. Ø8/21	RE-ISSUED FOR BUILDING PERMIT	MS
2.	NOV. Ø5/21	ISSUED FOR BUILDING PERMIT	MS
i.	SEPT. 21/21	ISSUED TO STRUCT, ENG. /HVAC FOR REVIEW AND COMMENTS	JLAM
No:	DATE:	REVISION/ISSUED:	BY:

31

TOTAL

RATIO

WALL AREA



420.69

4241.69

9.92

39.08

394.07

9.92




SURIANO. ARCHITECTURAL DESIGN


SURIANO DESIGN CONSULTANTS INC. 51 Roysun Road, Unit 1 Vaughan, Ontarlo L4L 8P9 T. 905-264-0924


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DEC. Ø8/21	M.H./J.L.AM	3223 SQ.FT.			
DATE:	TYPE:	PAGE No:			
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SCALE:	PROJECT No:	06			
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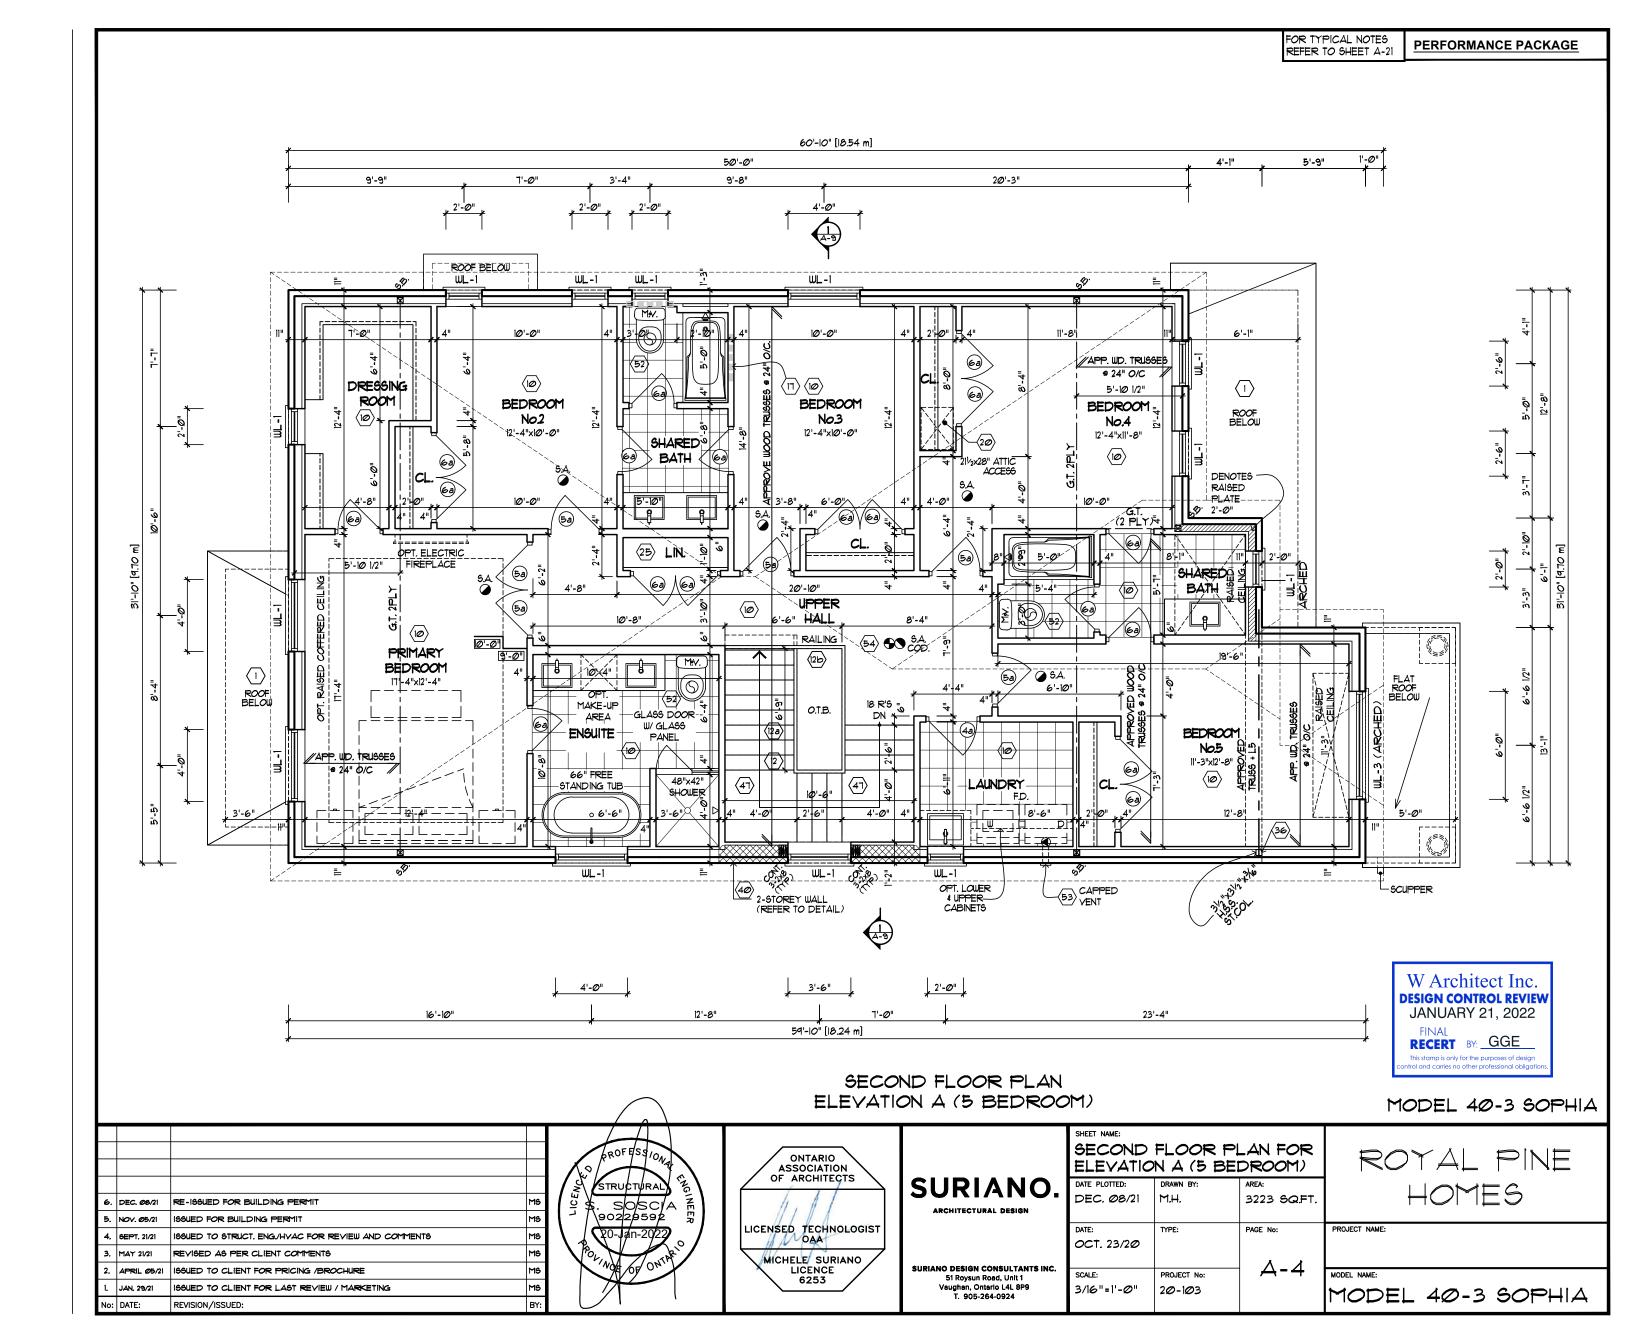
ROYAL PINE HOMES


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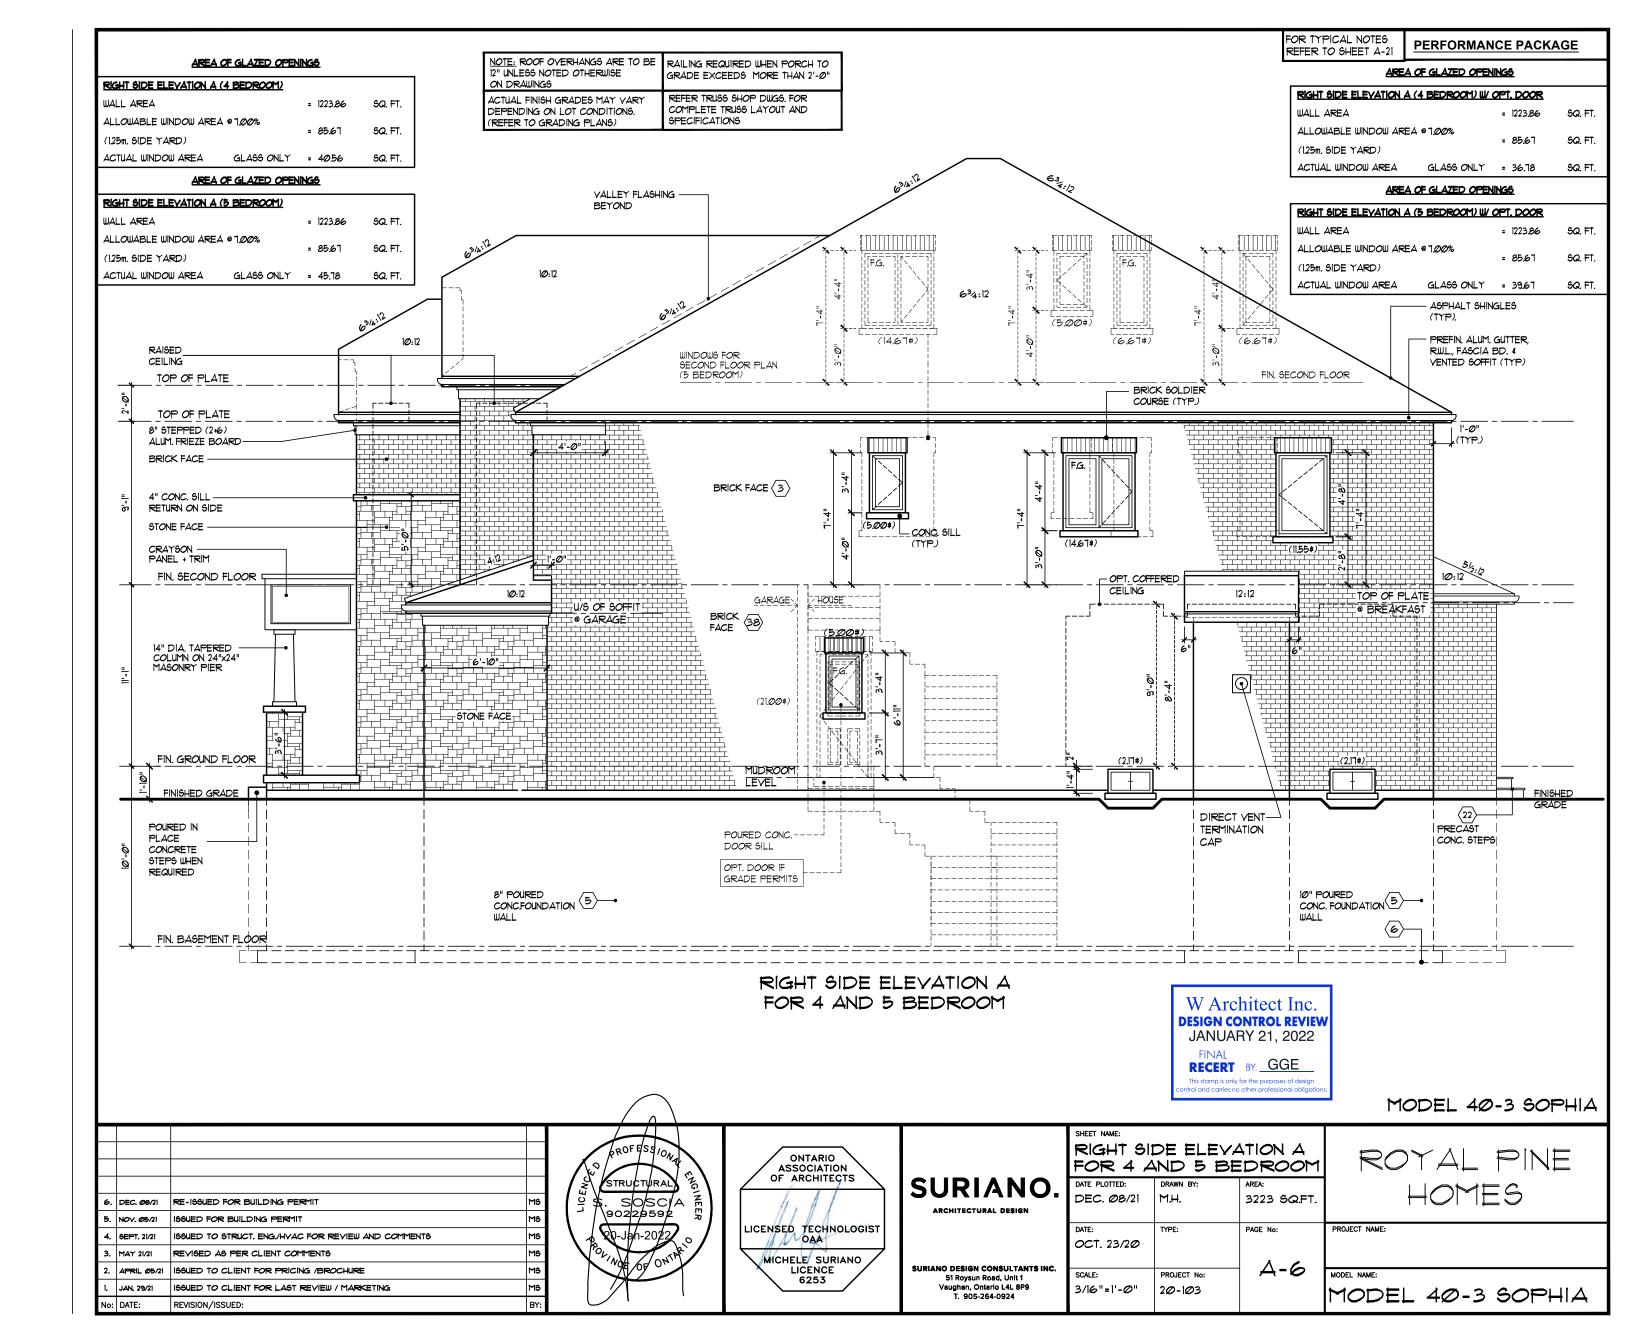





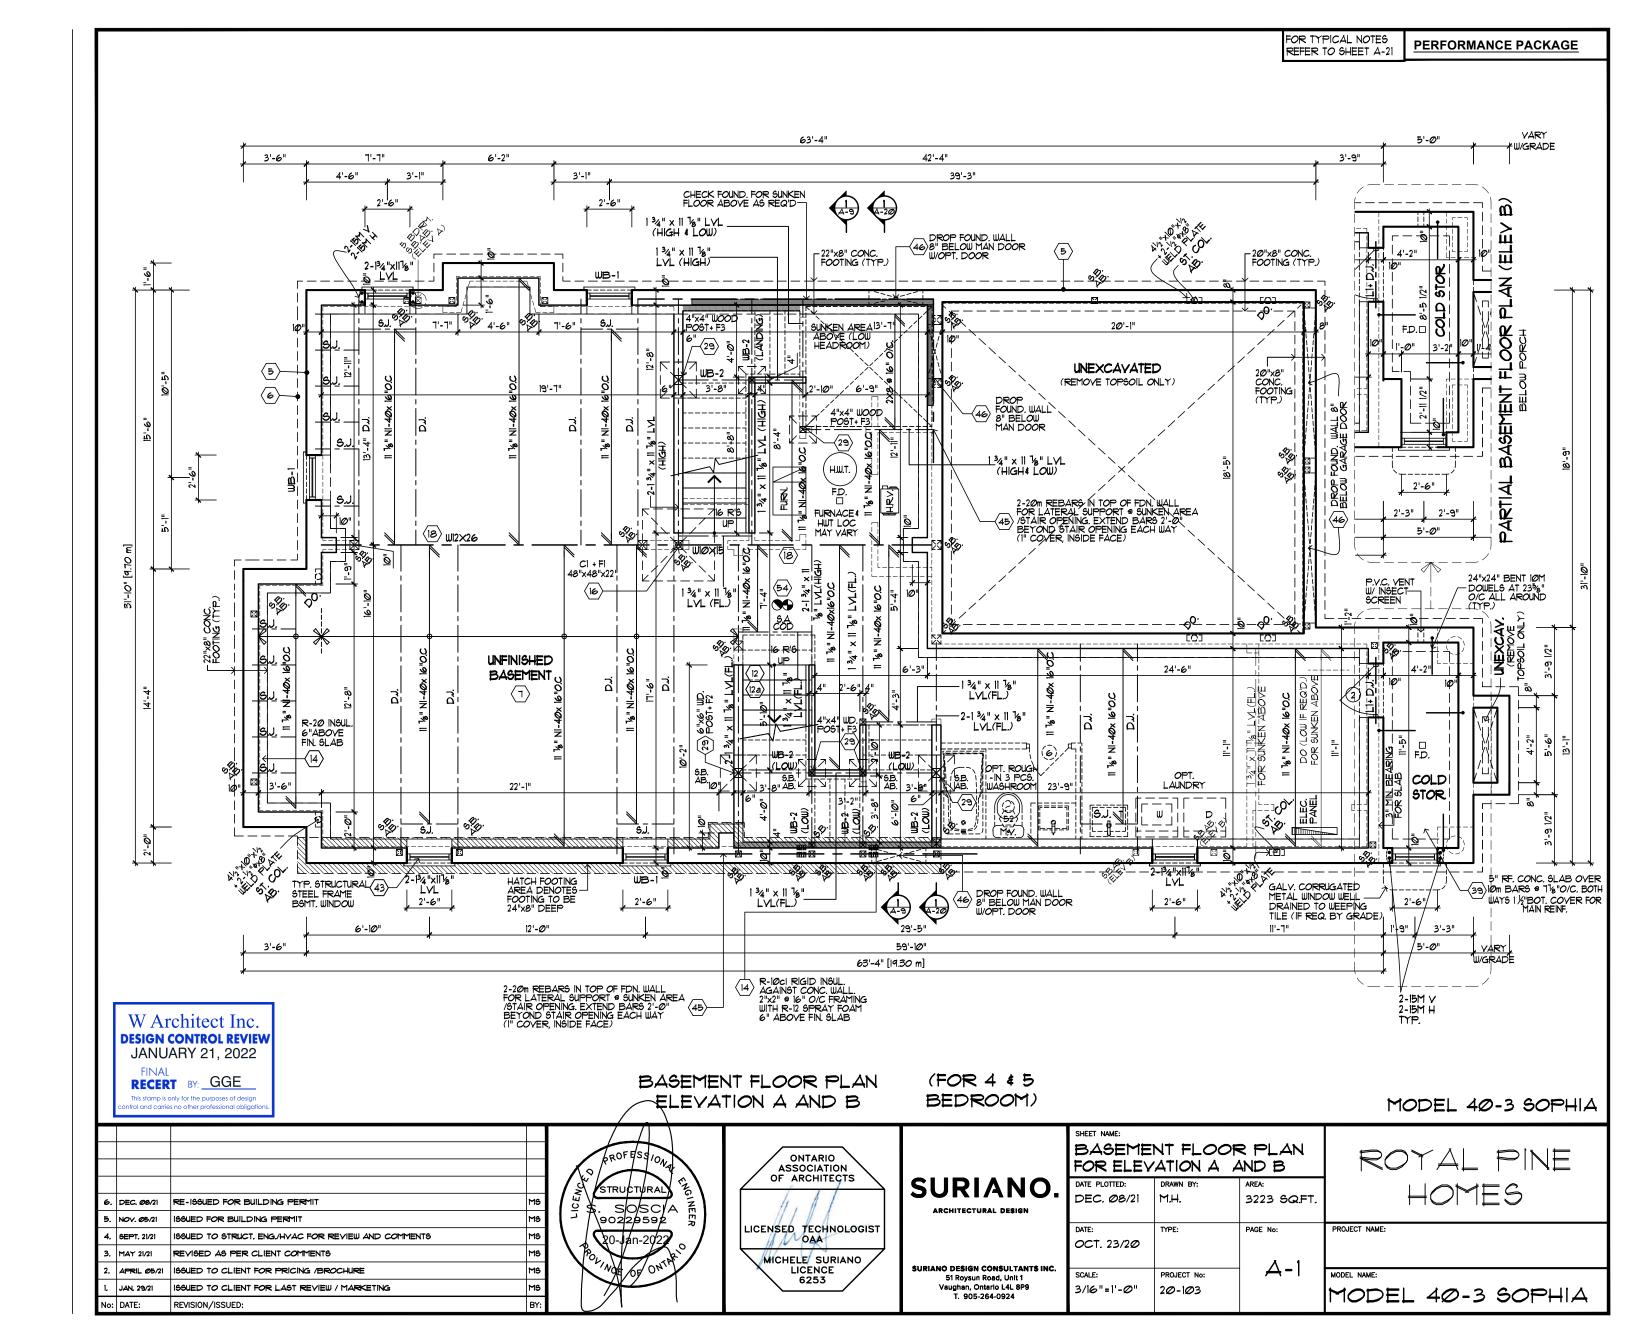


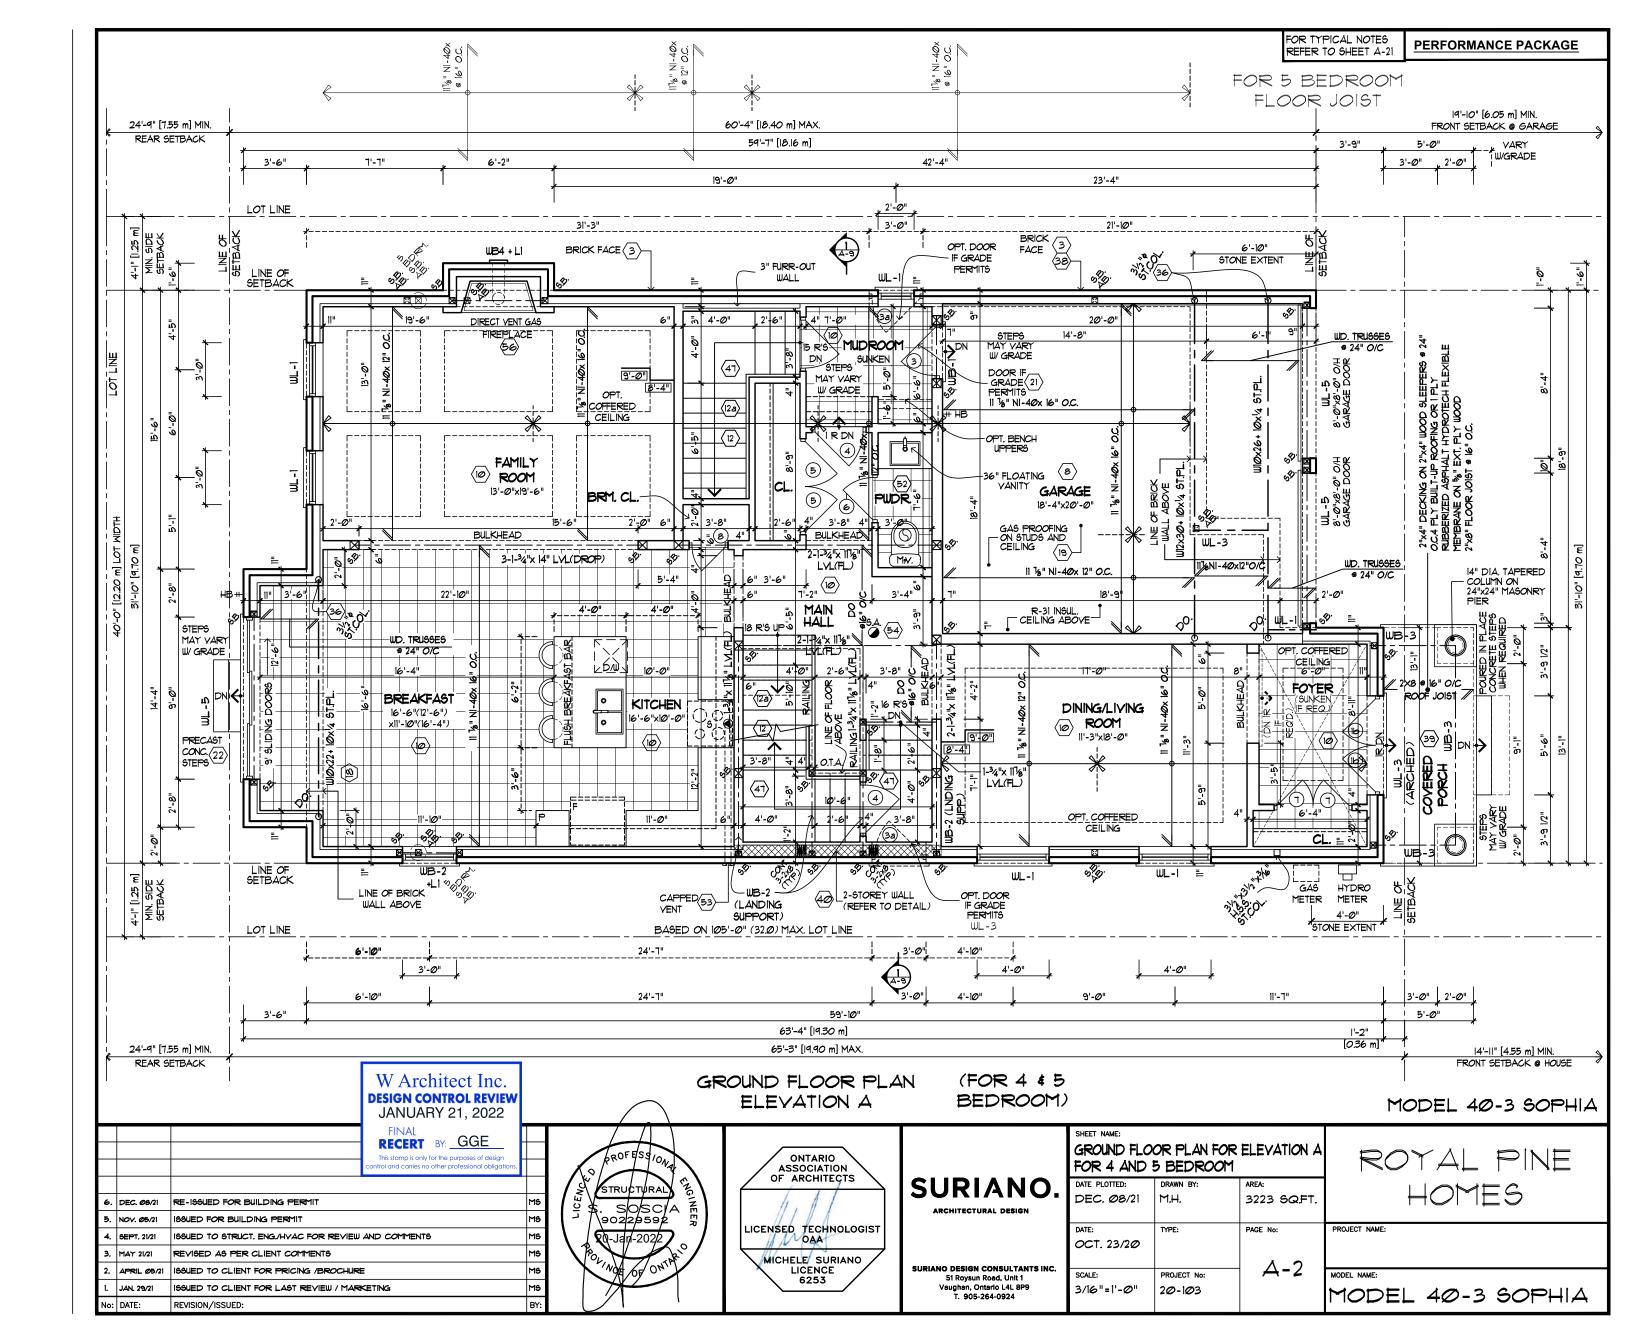


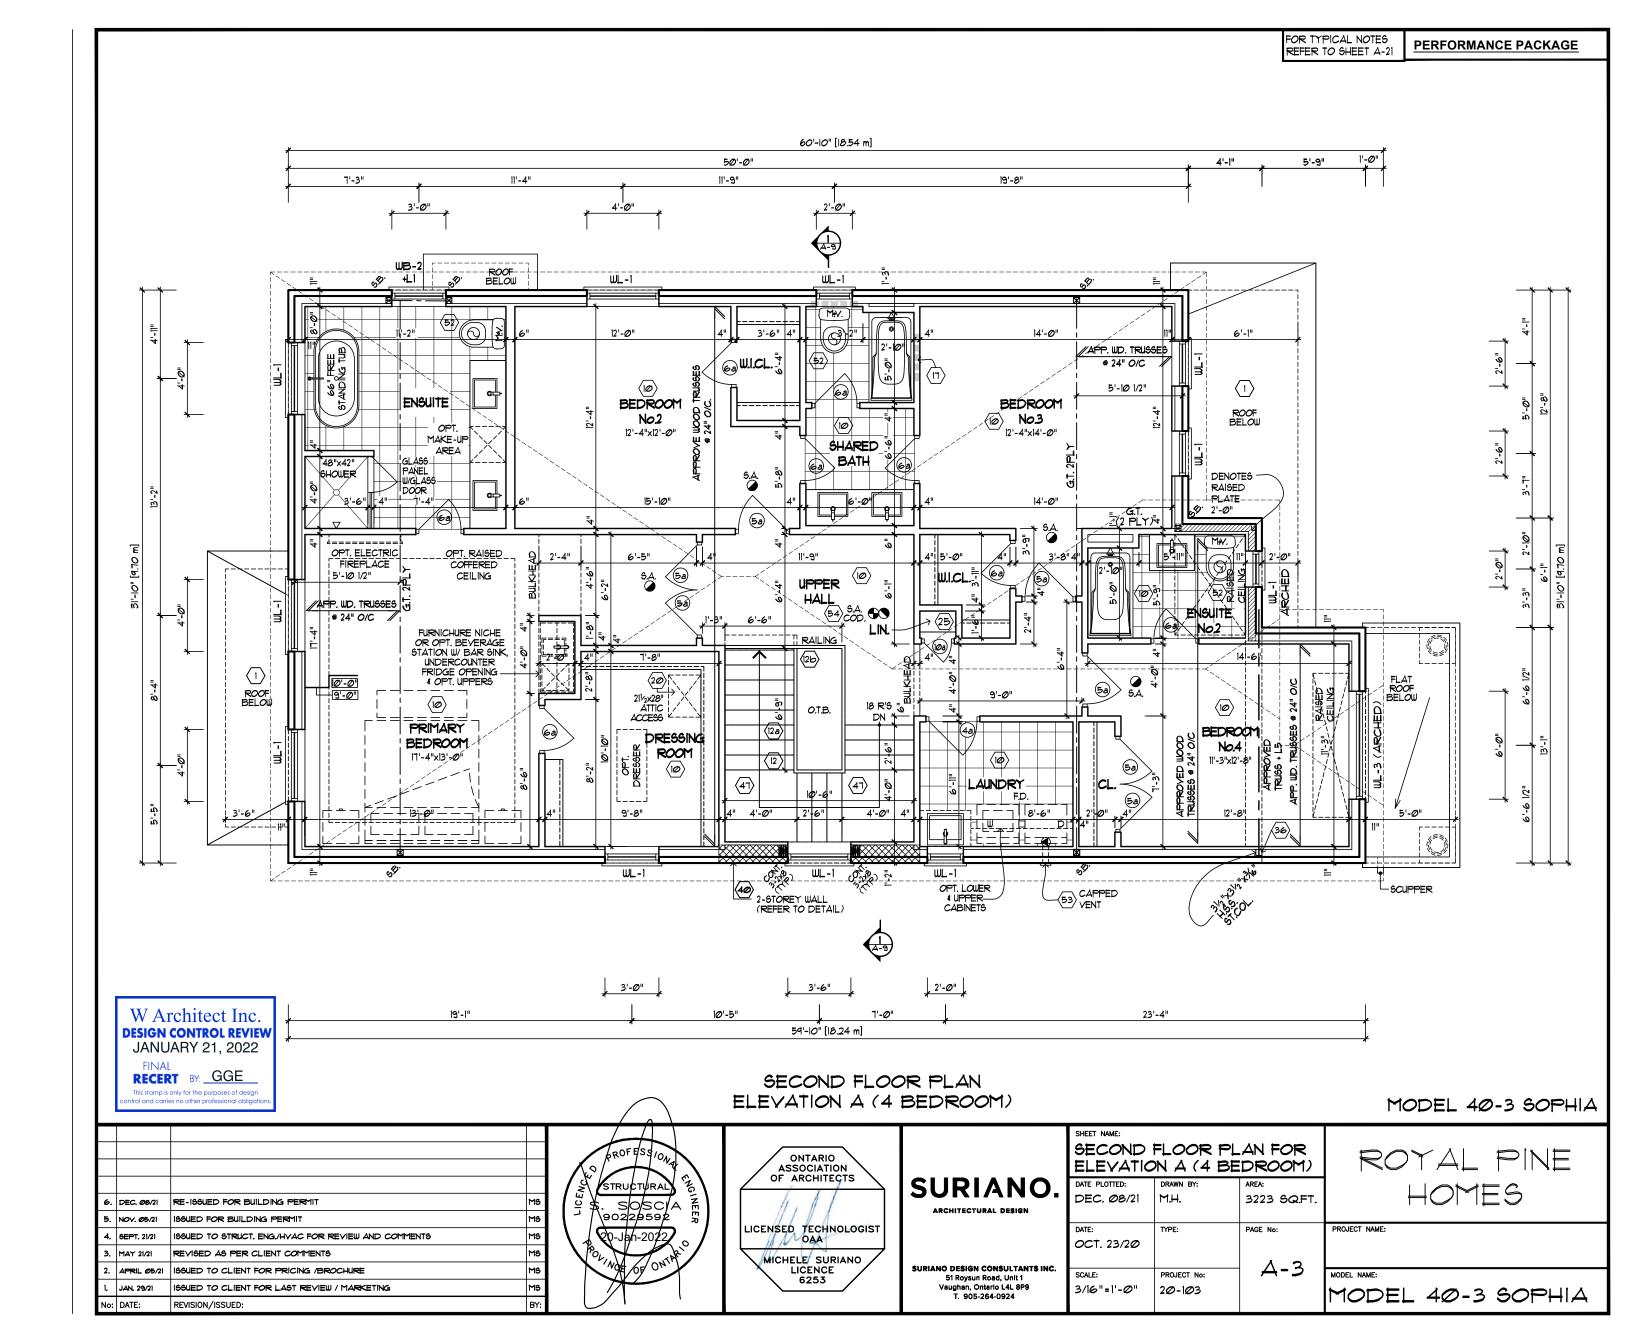


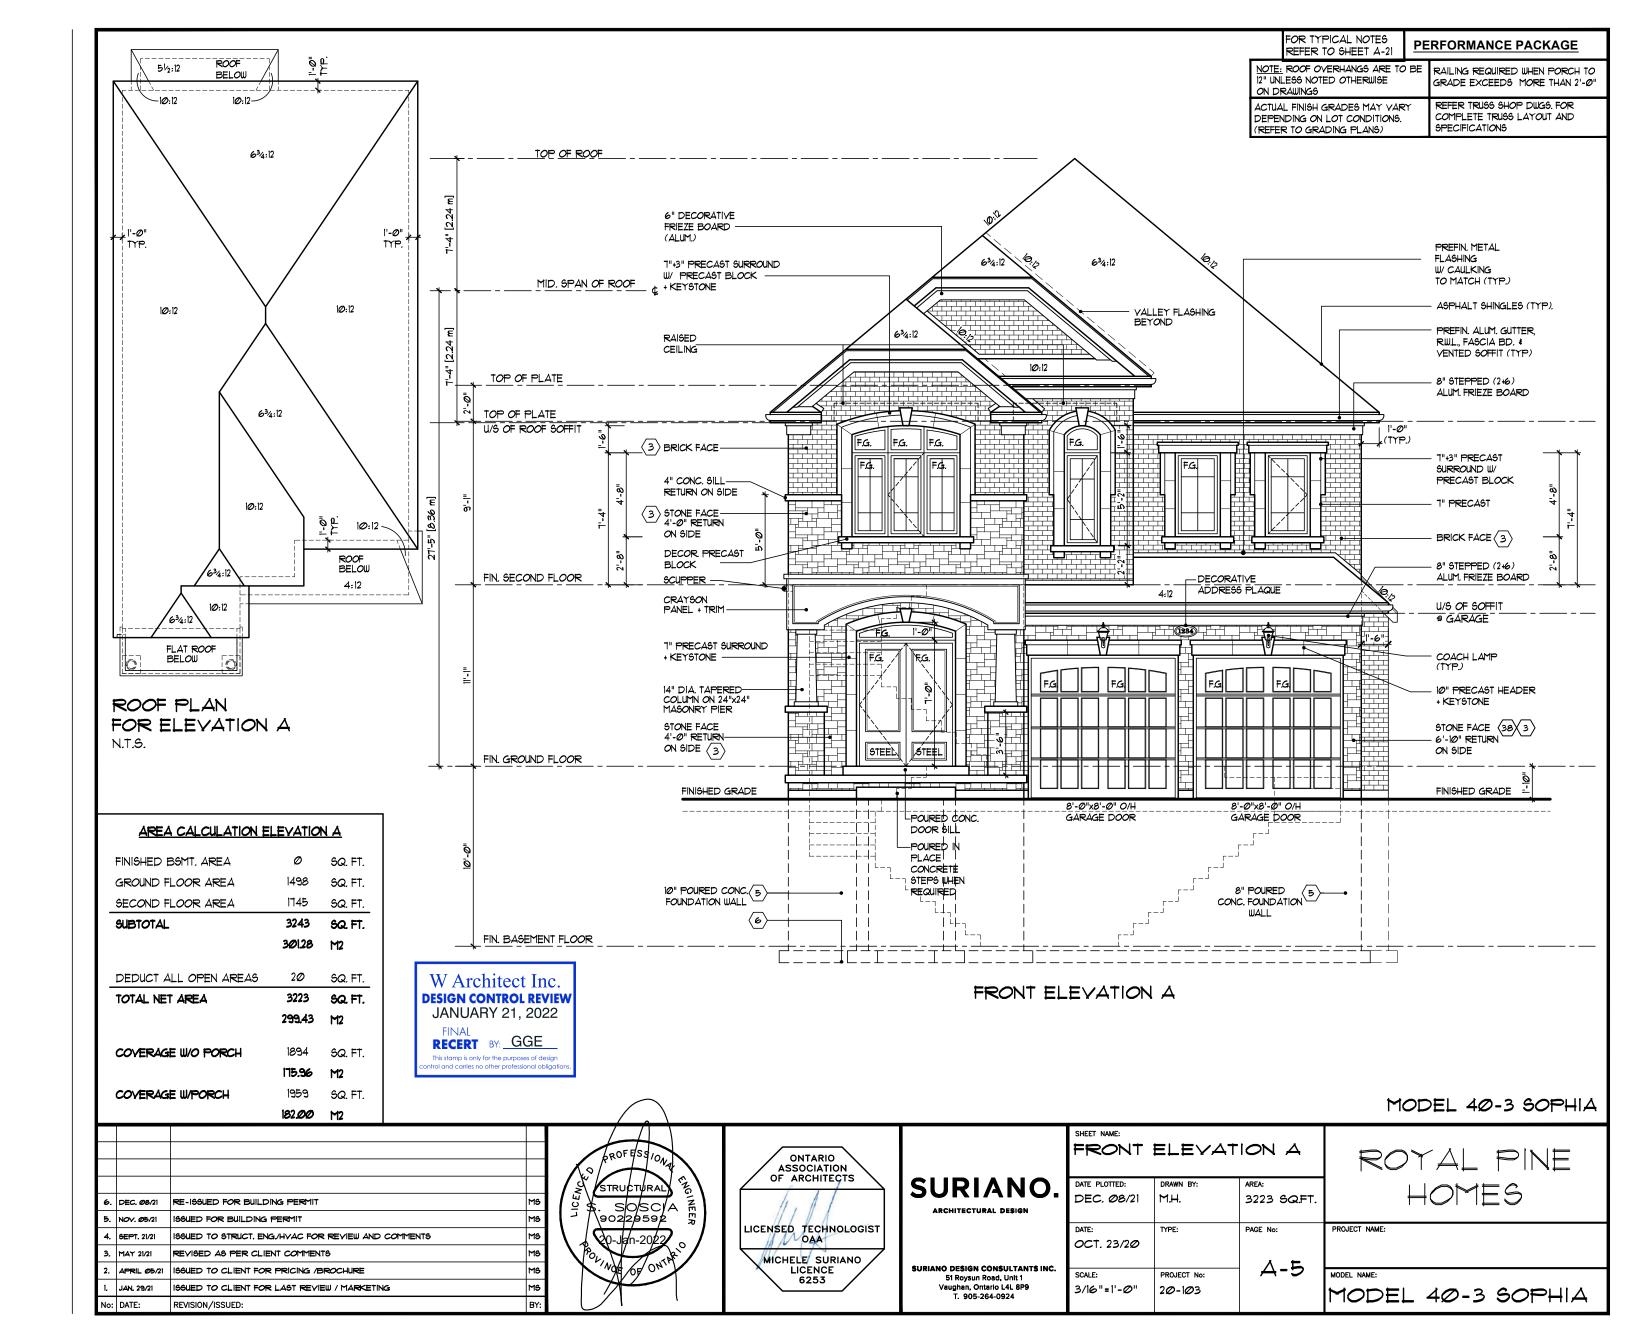


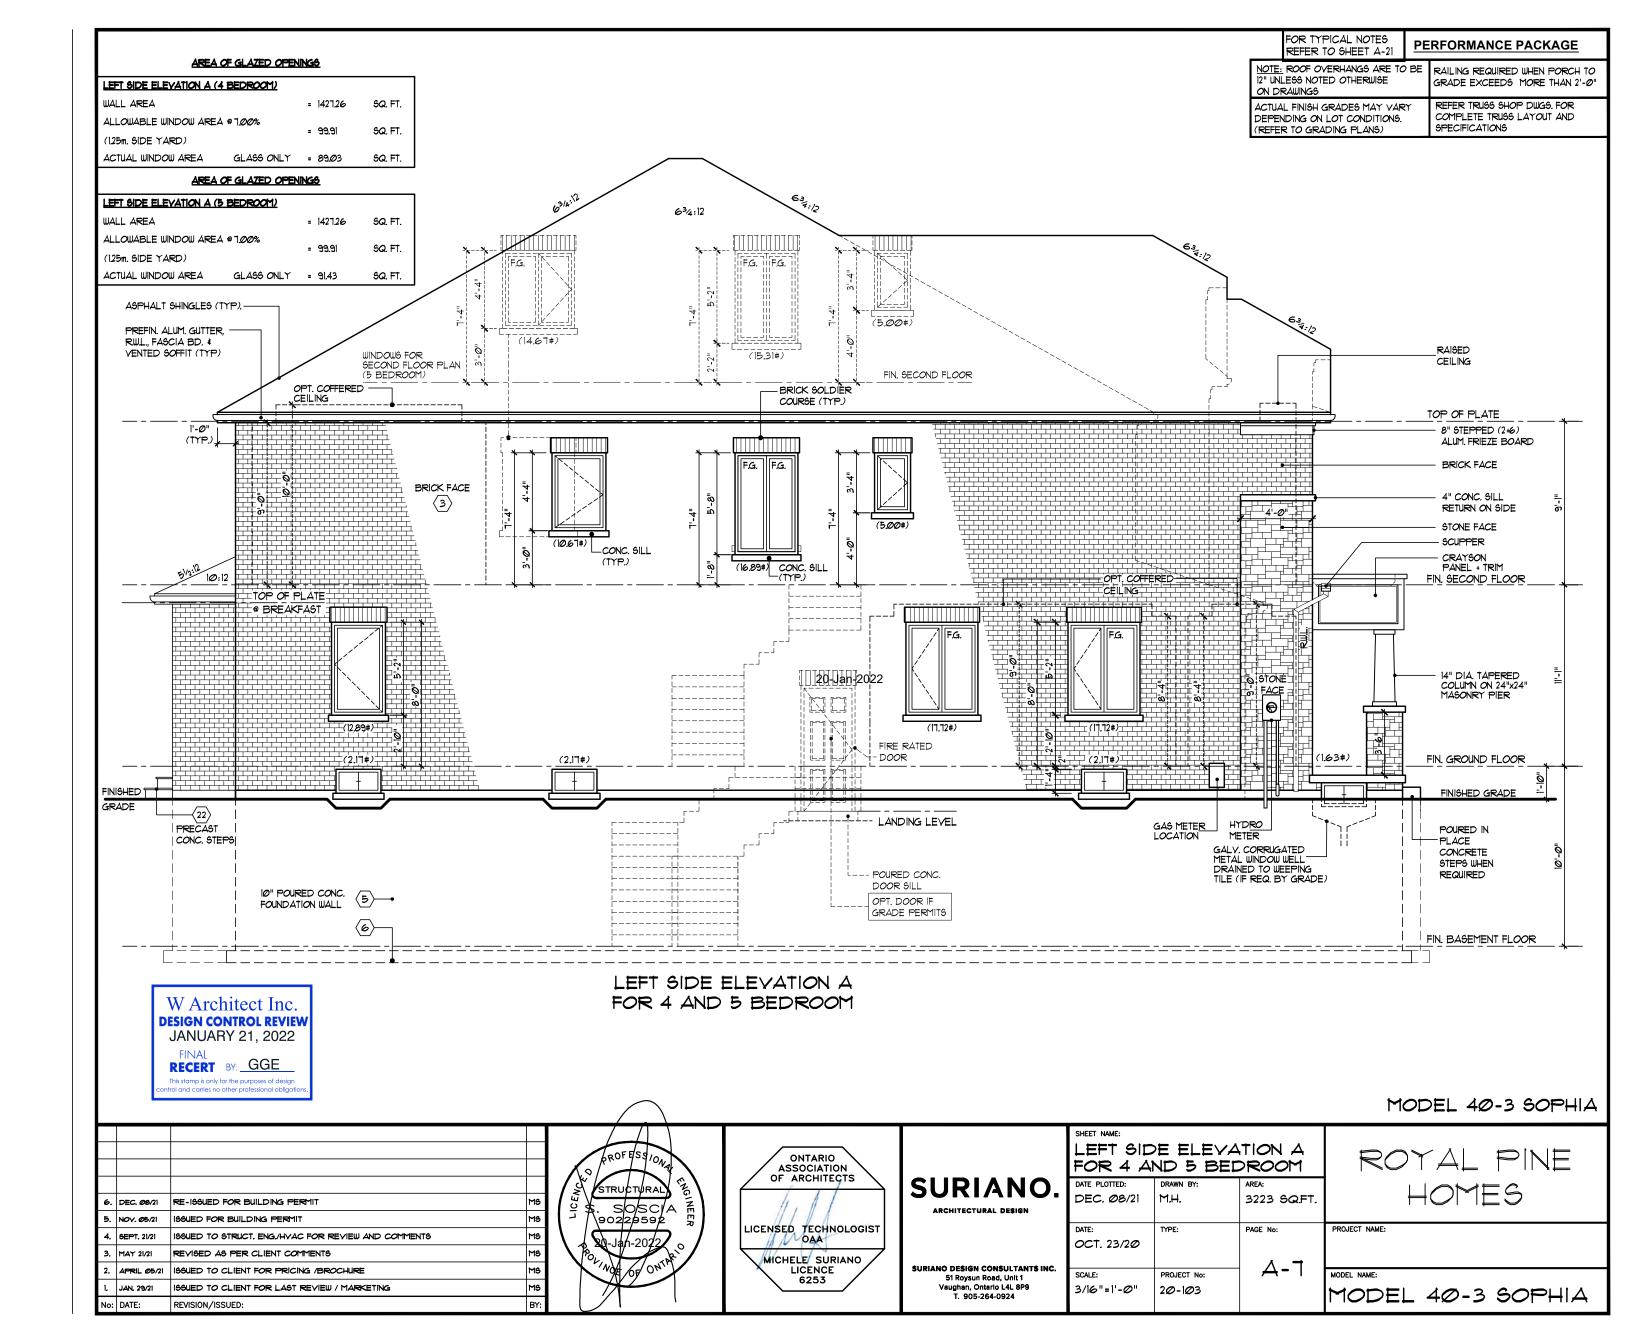


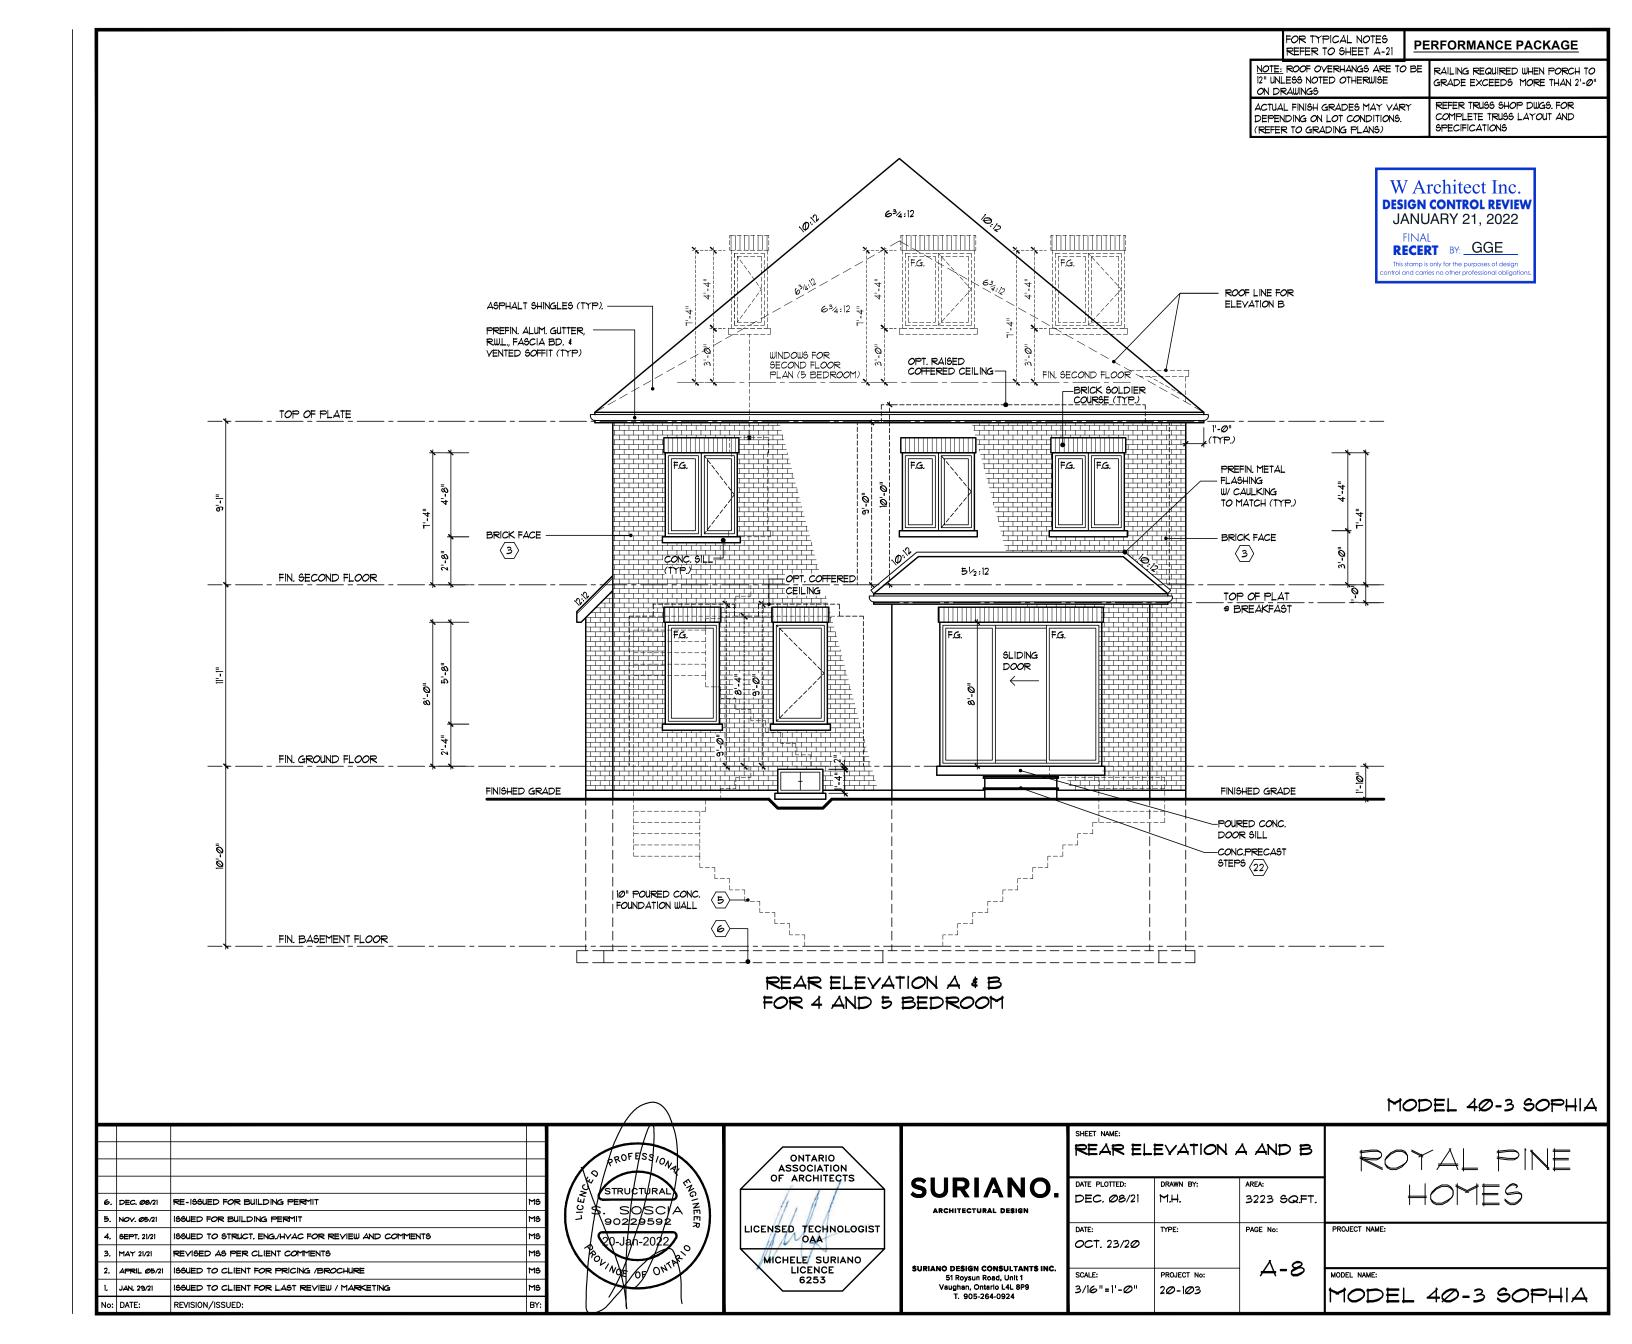


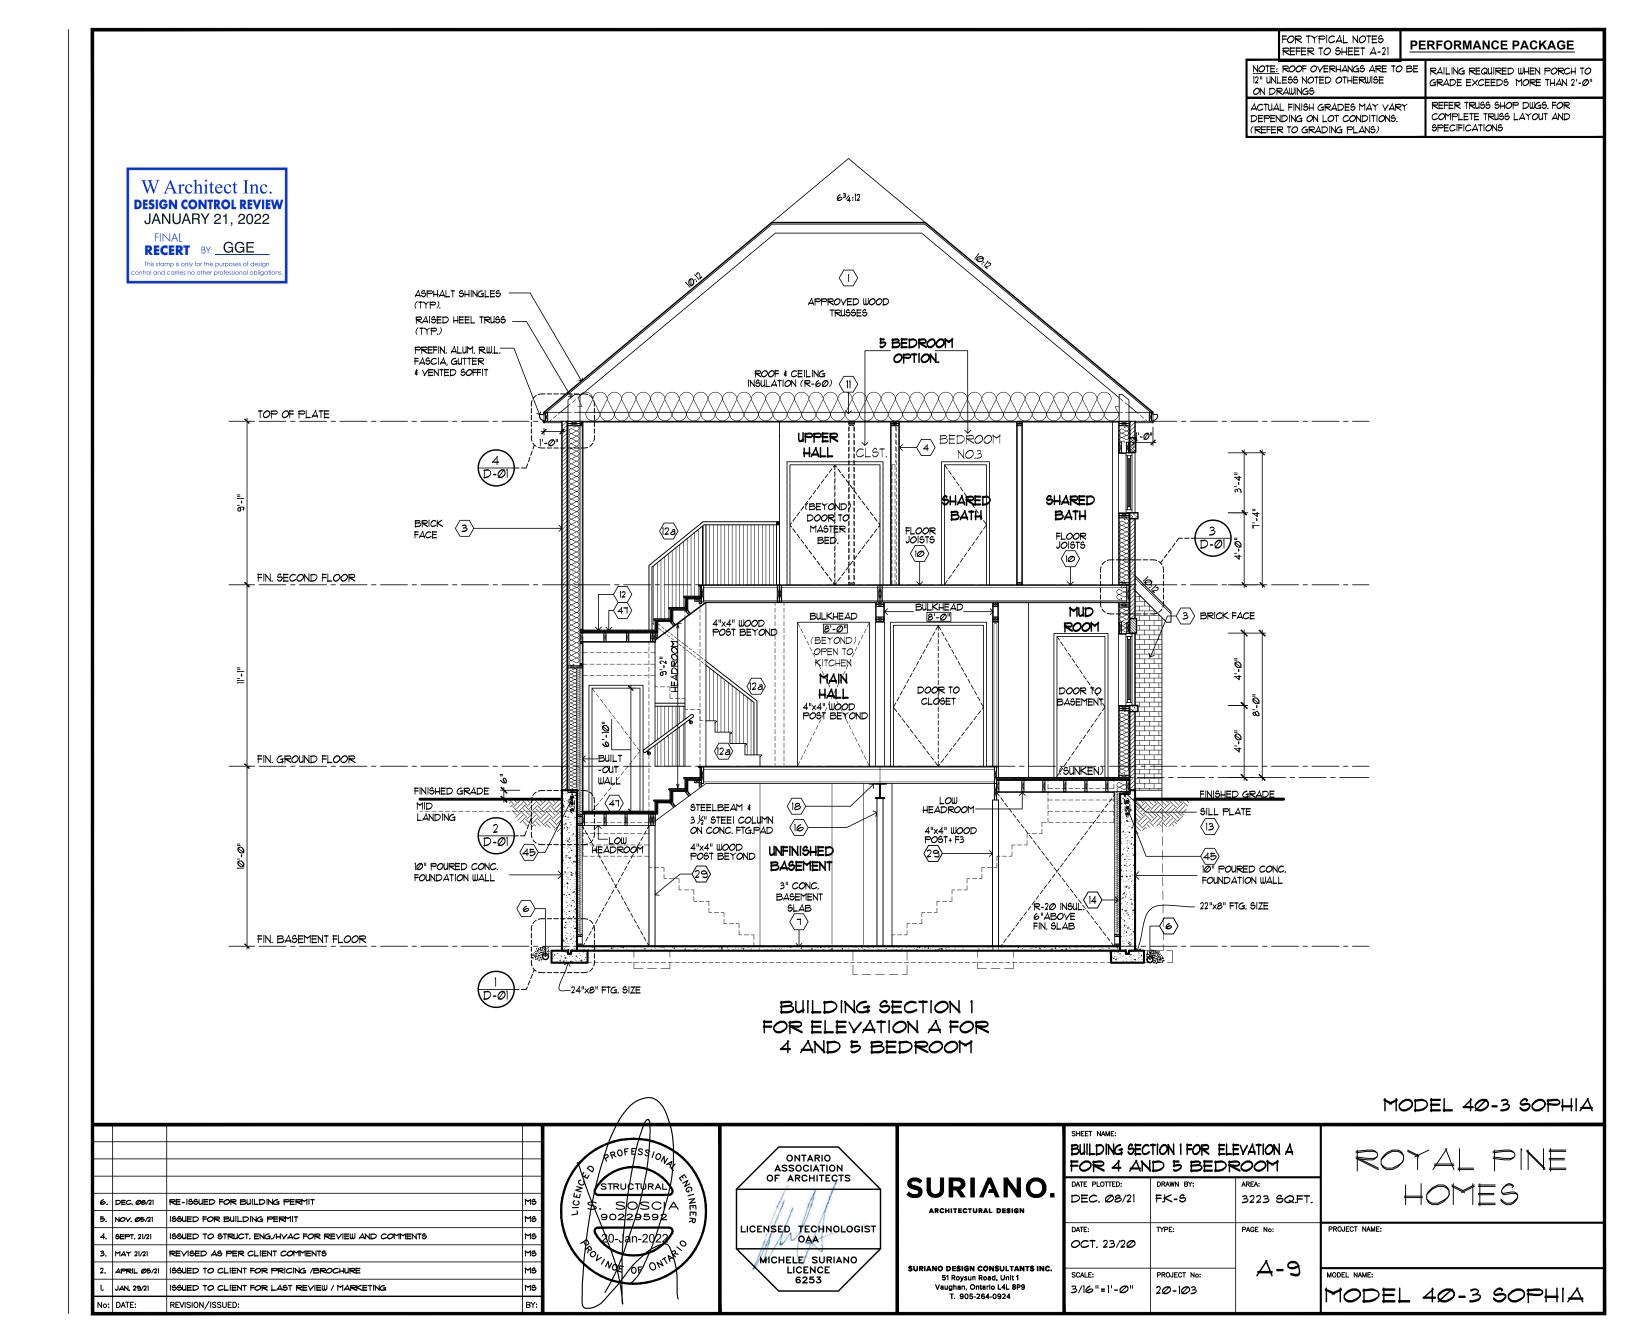

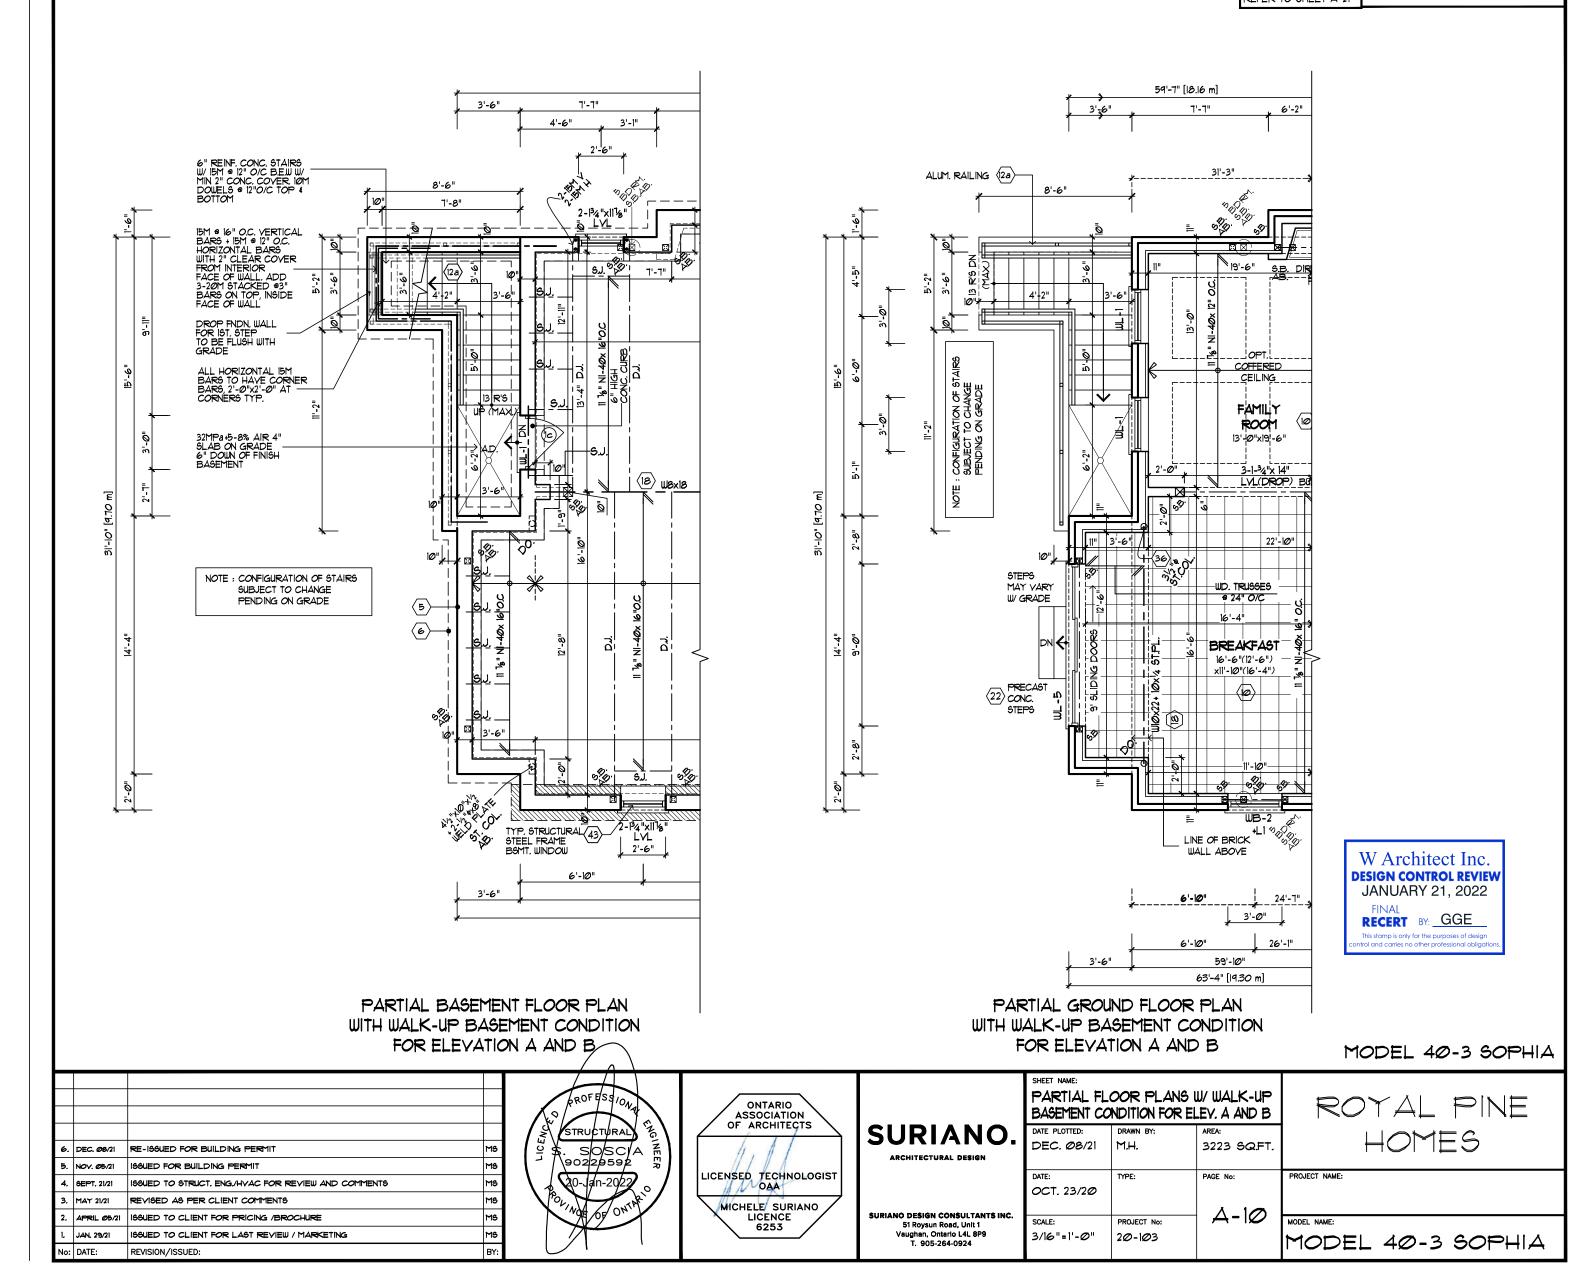

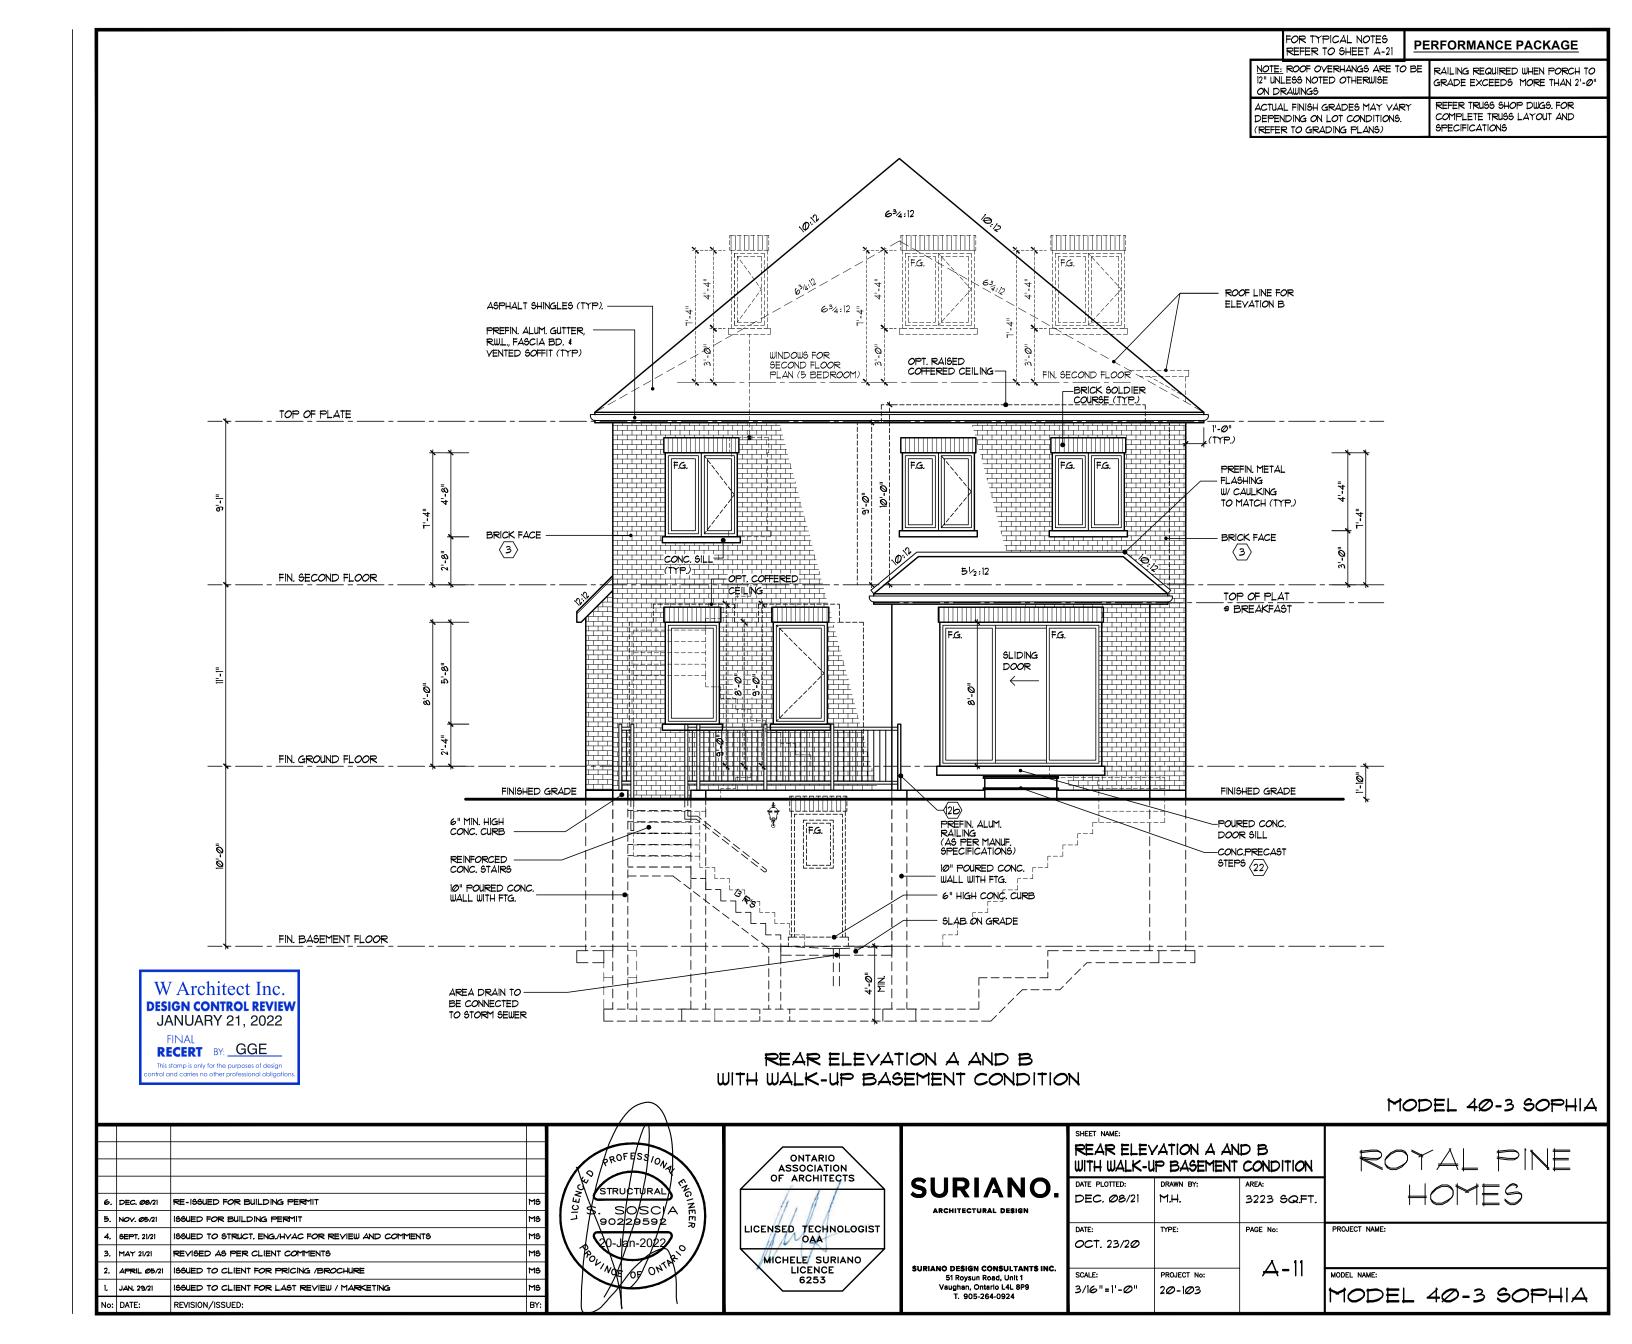


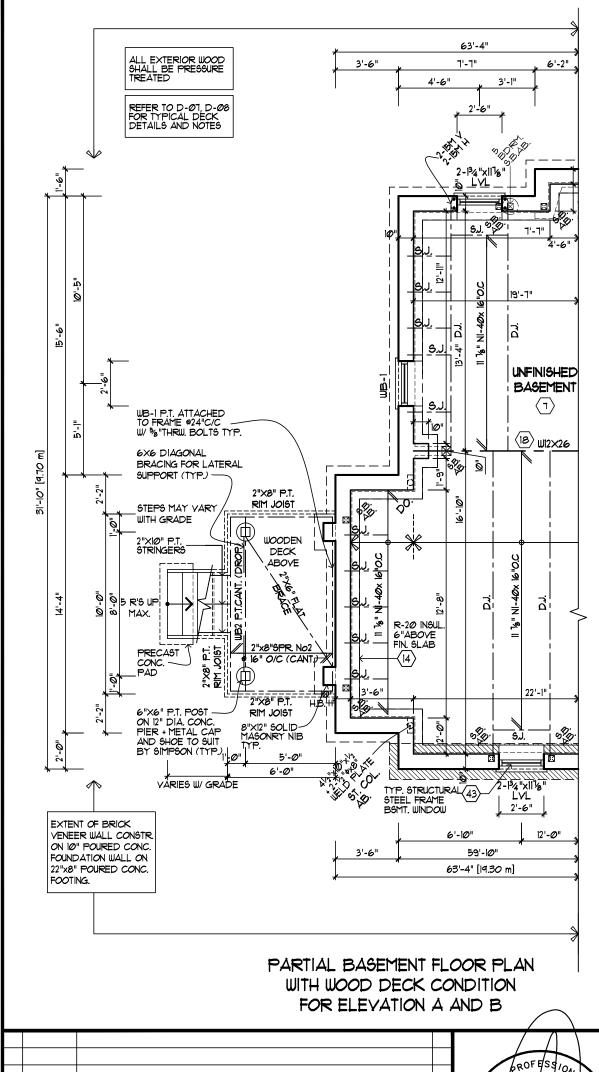


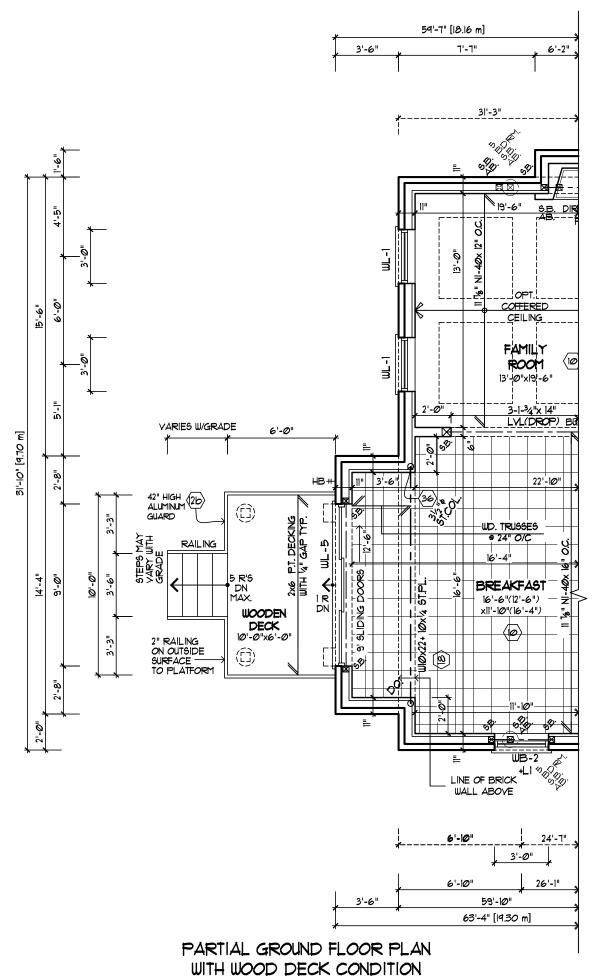

FOR ELEVATION A AND B

MODEL 40-3 SOPHIA

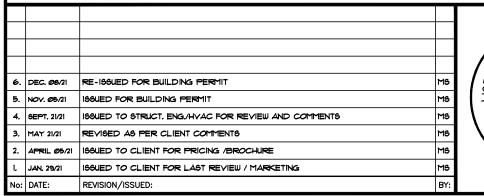

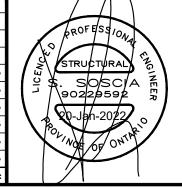



SURIANO

PARTIAL FLOOR PLANS W/ WOOD DECK CONDITION FOR ELEY, A AND B					
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DEC. Ø8/21	M.H.	3223 SQ.FT.			
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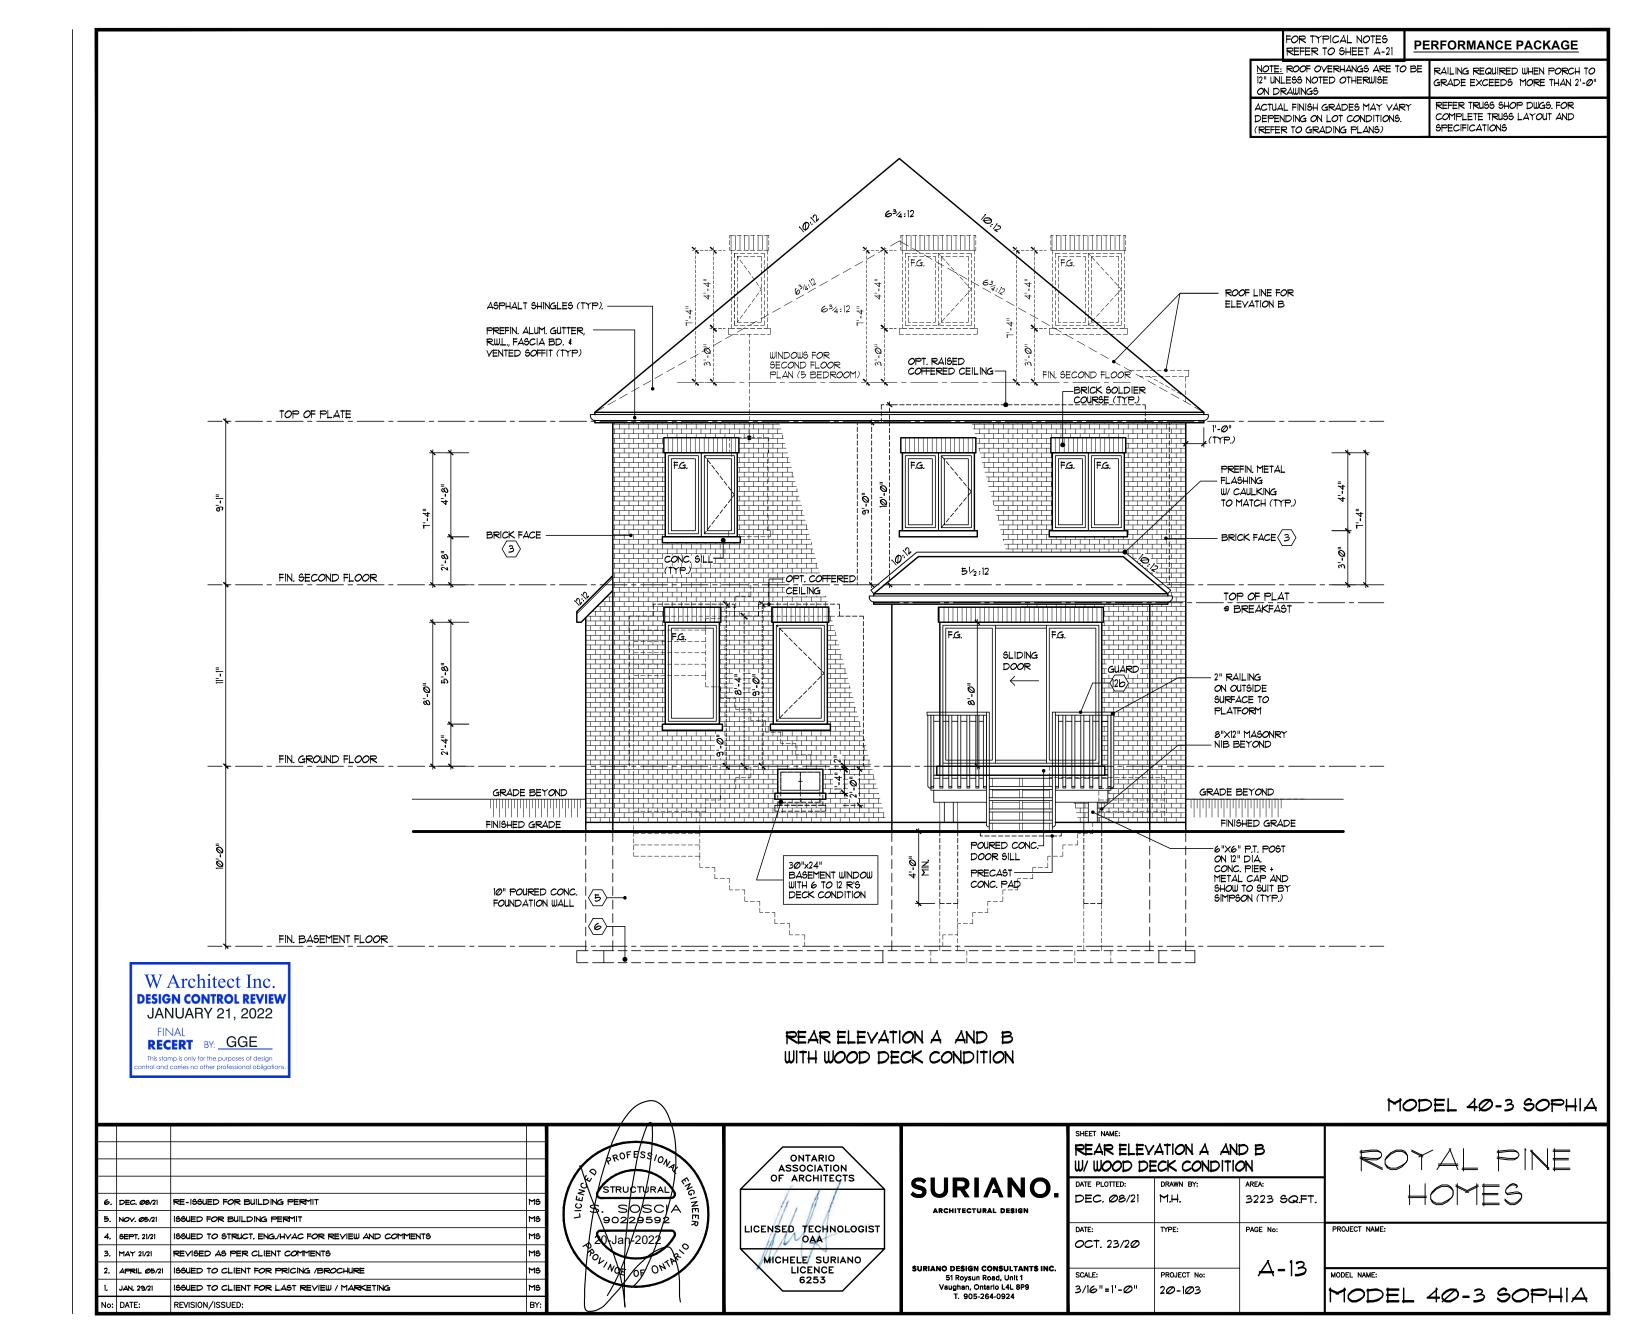
ROYAL PINE HOMES


W Architect Inc.


DESIGN CONTROL REVIEW JANUARY 21, 2022


RECERT BY: GGE


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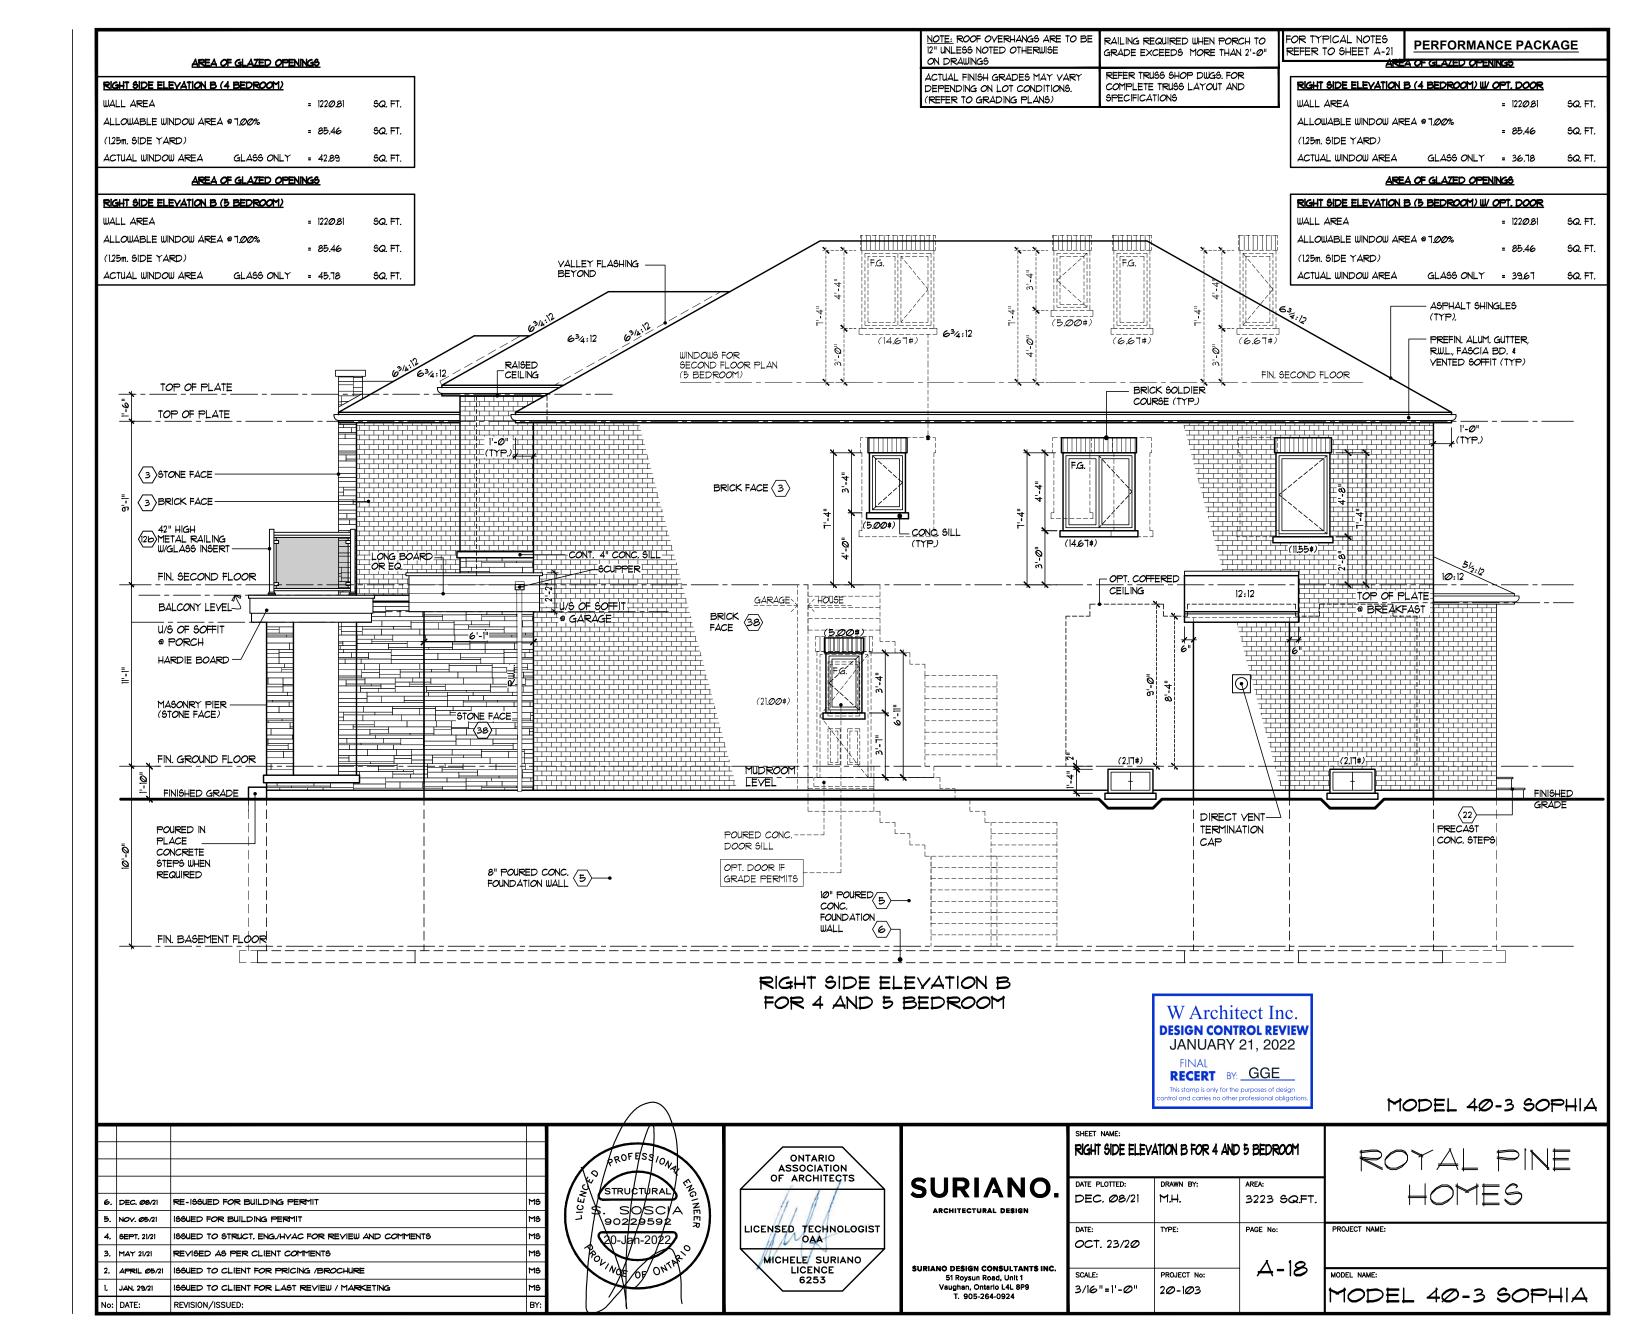





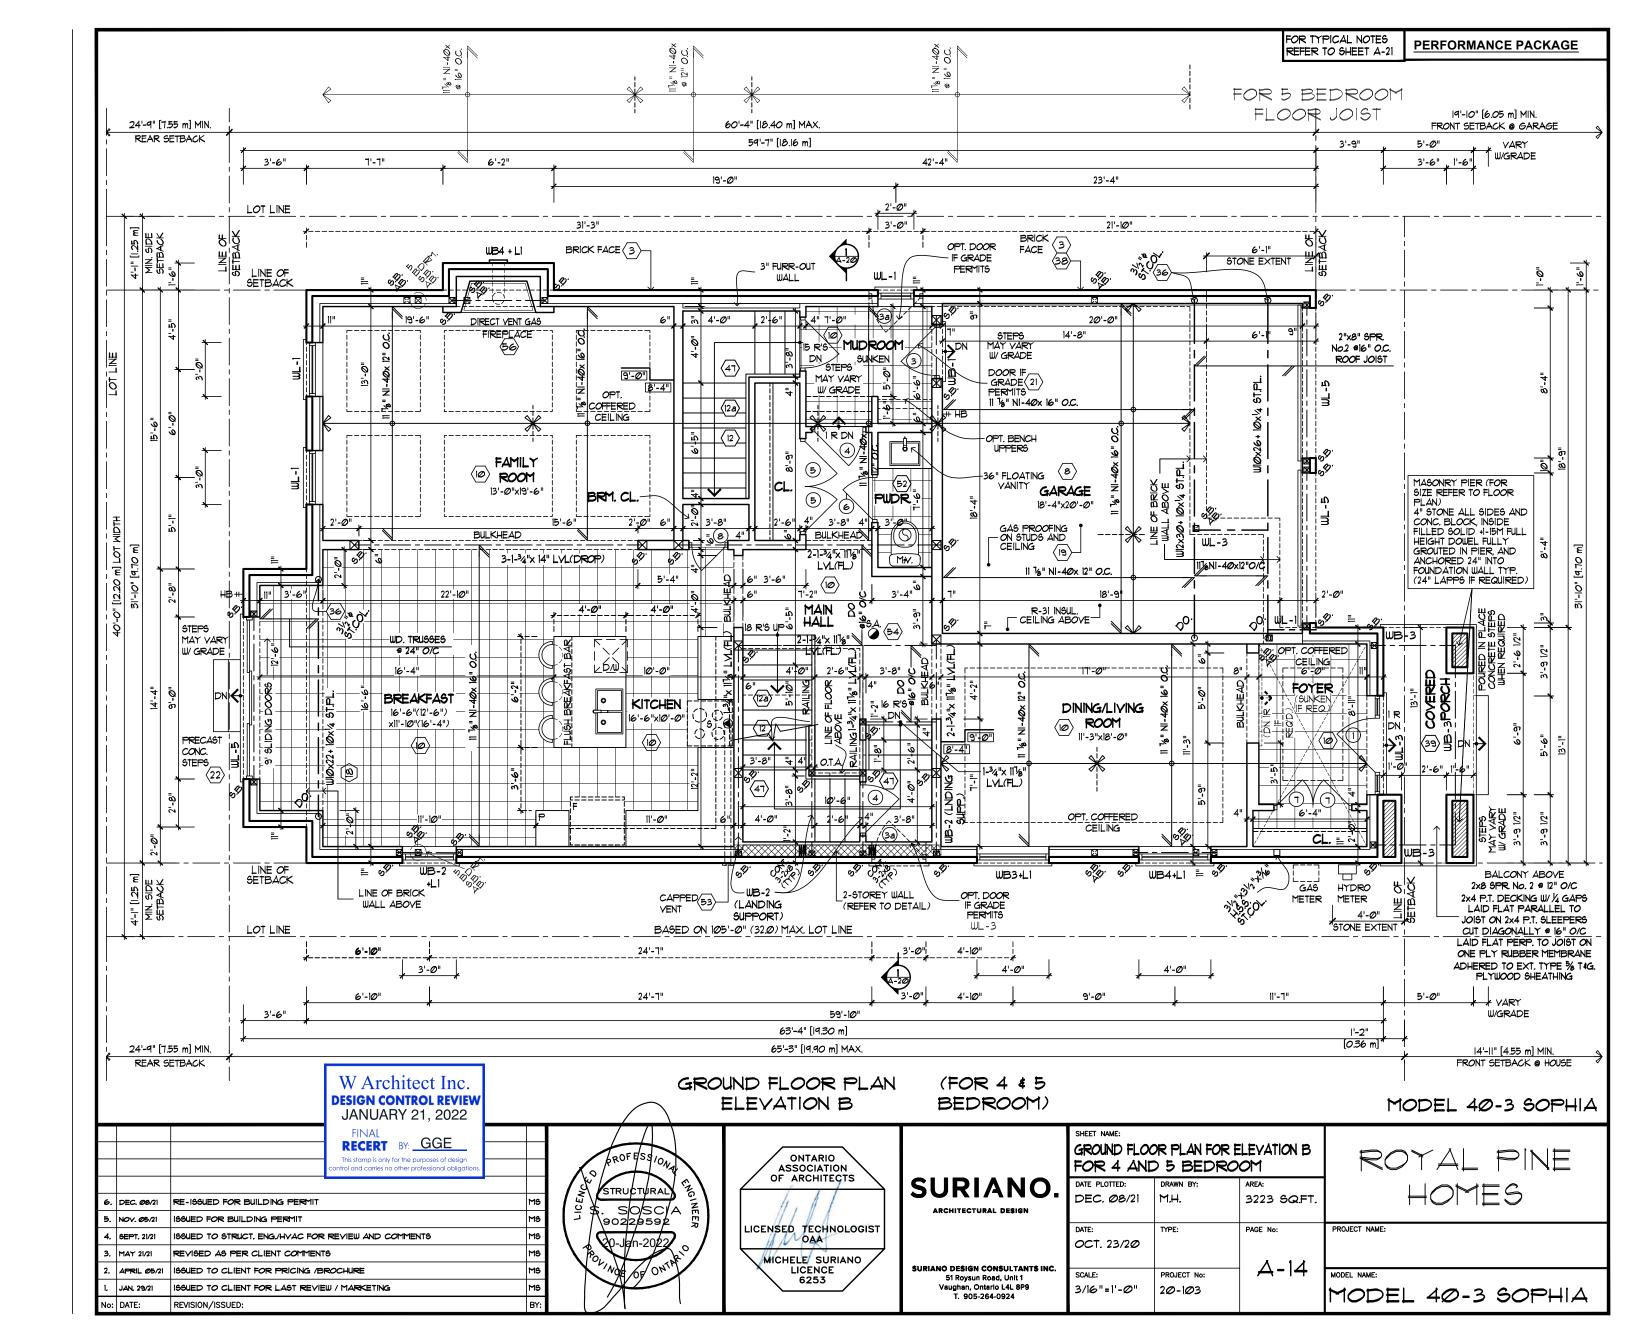


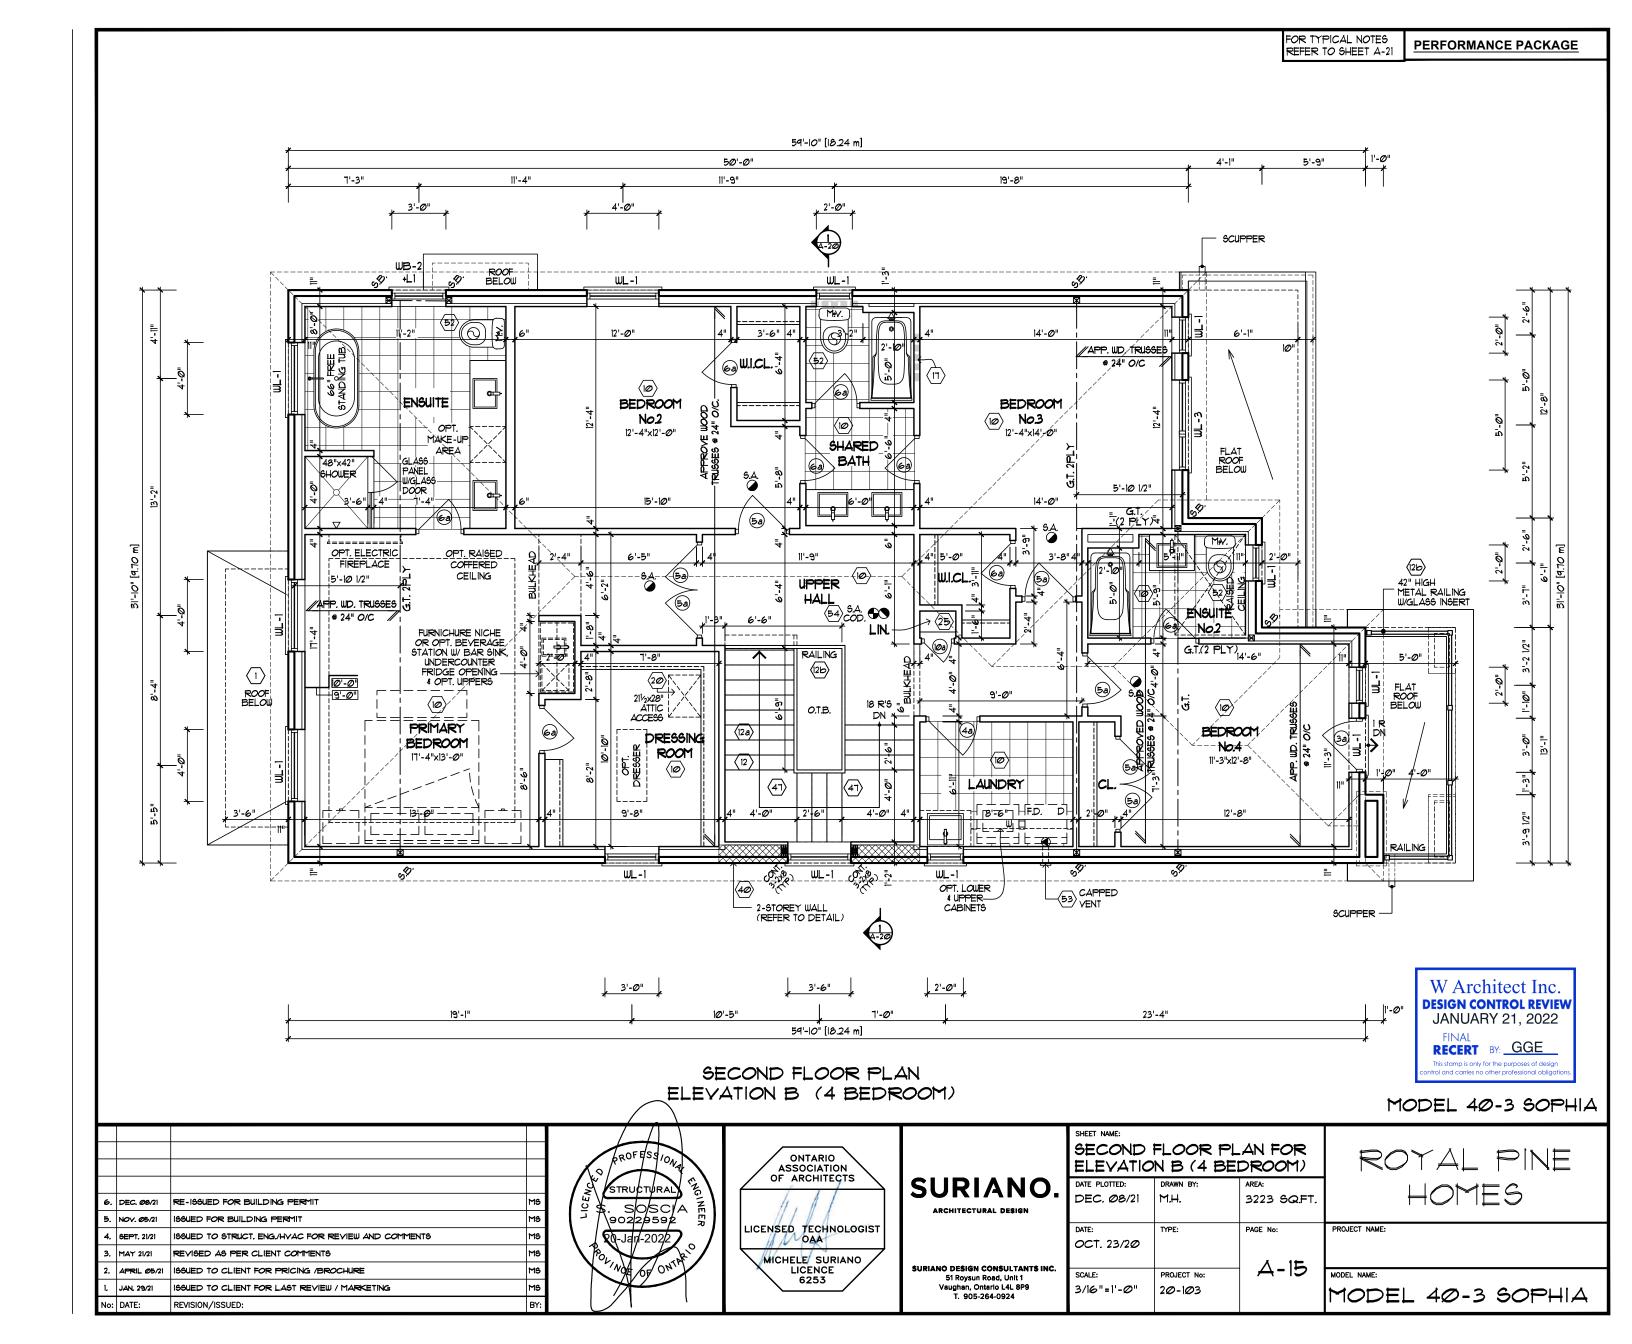

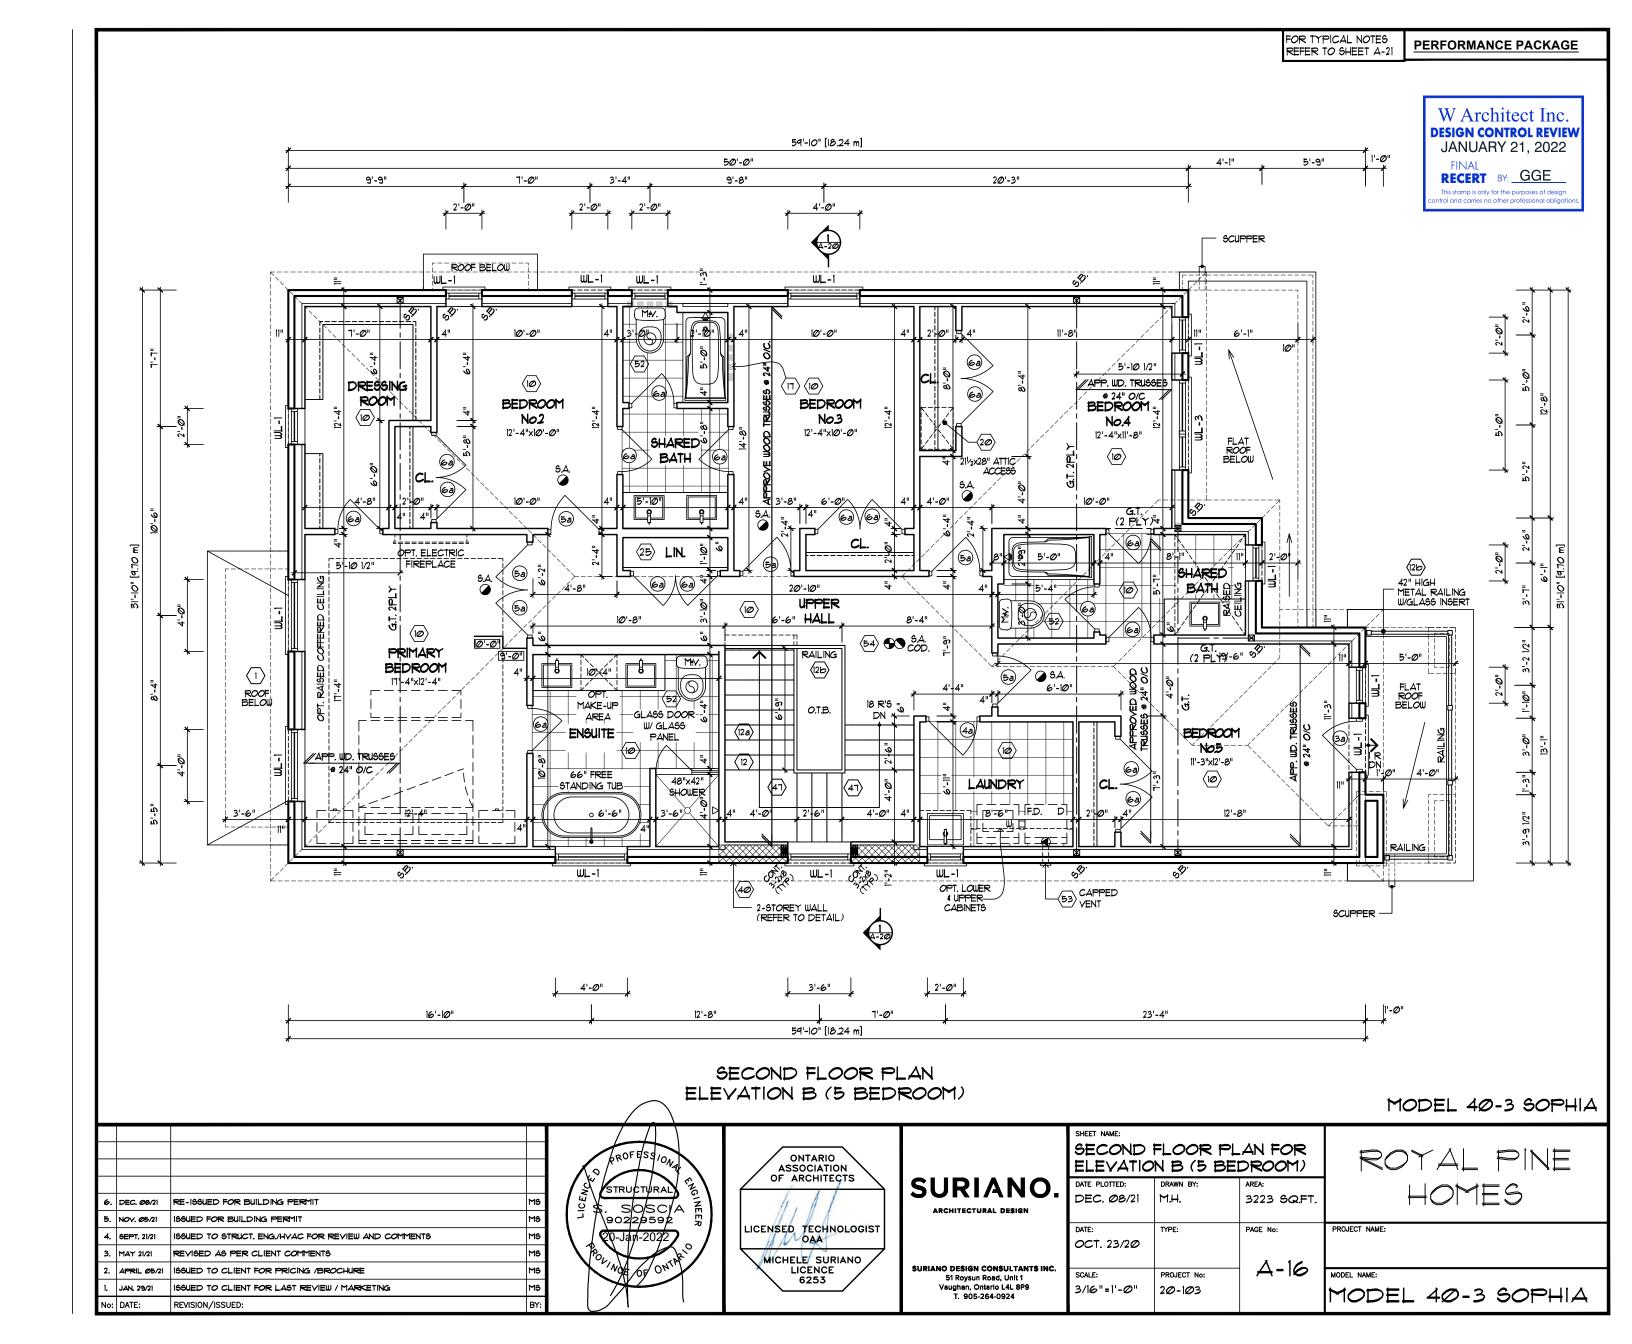

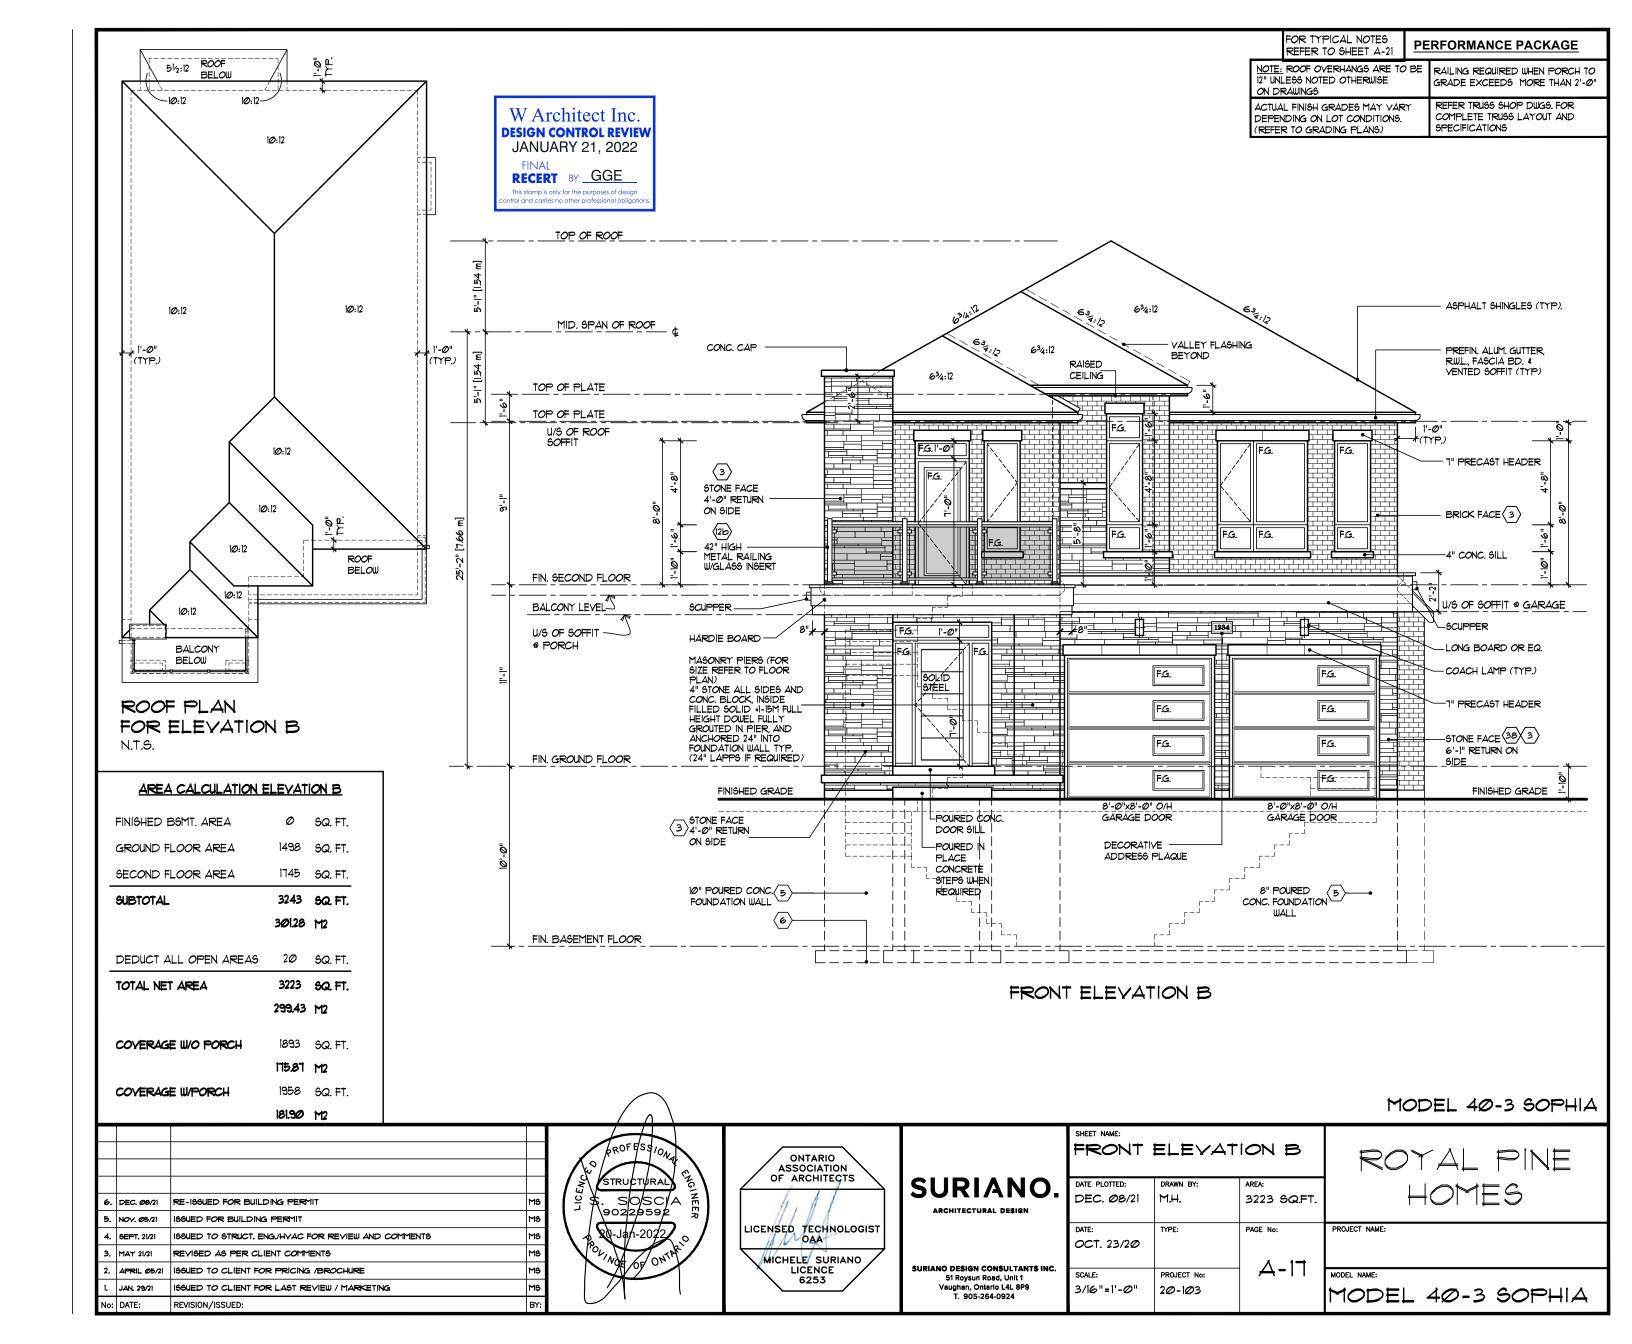

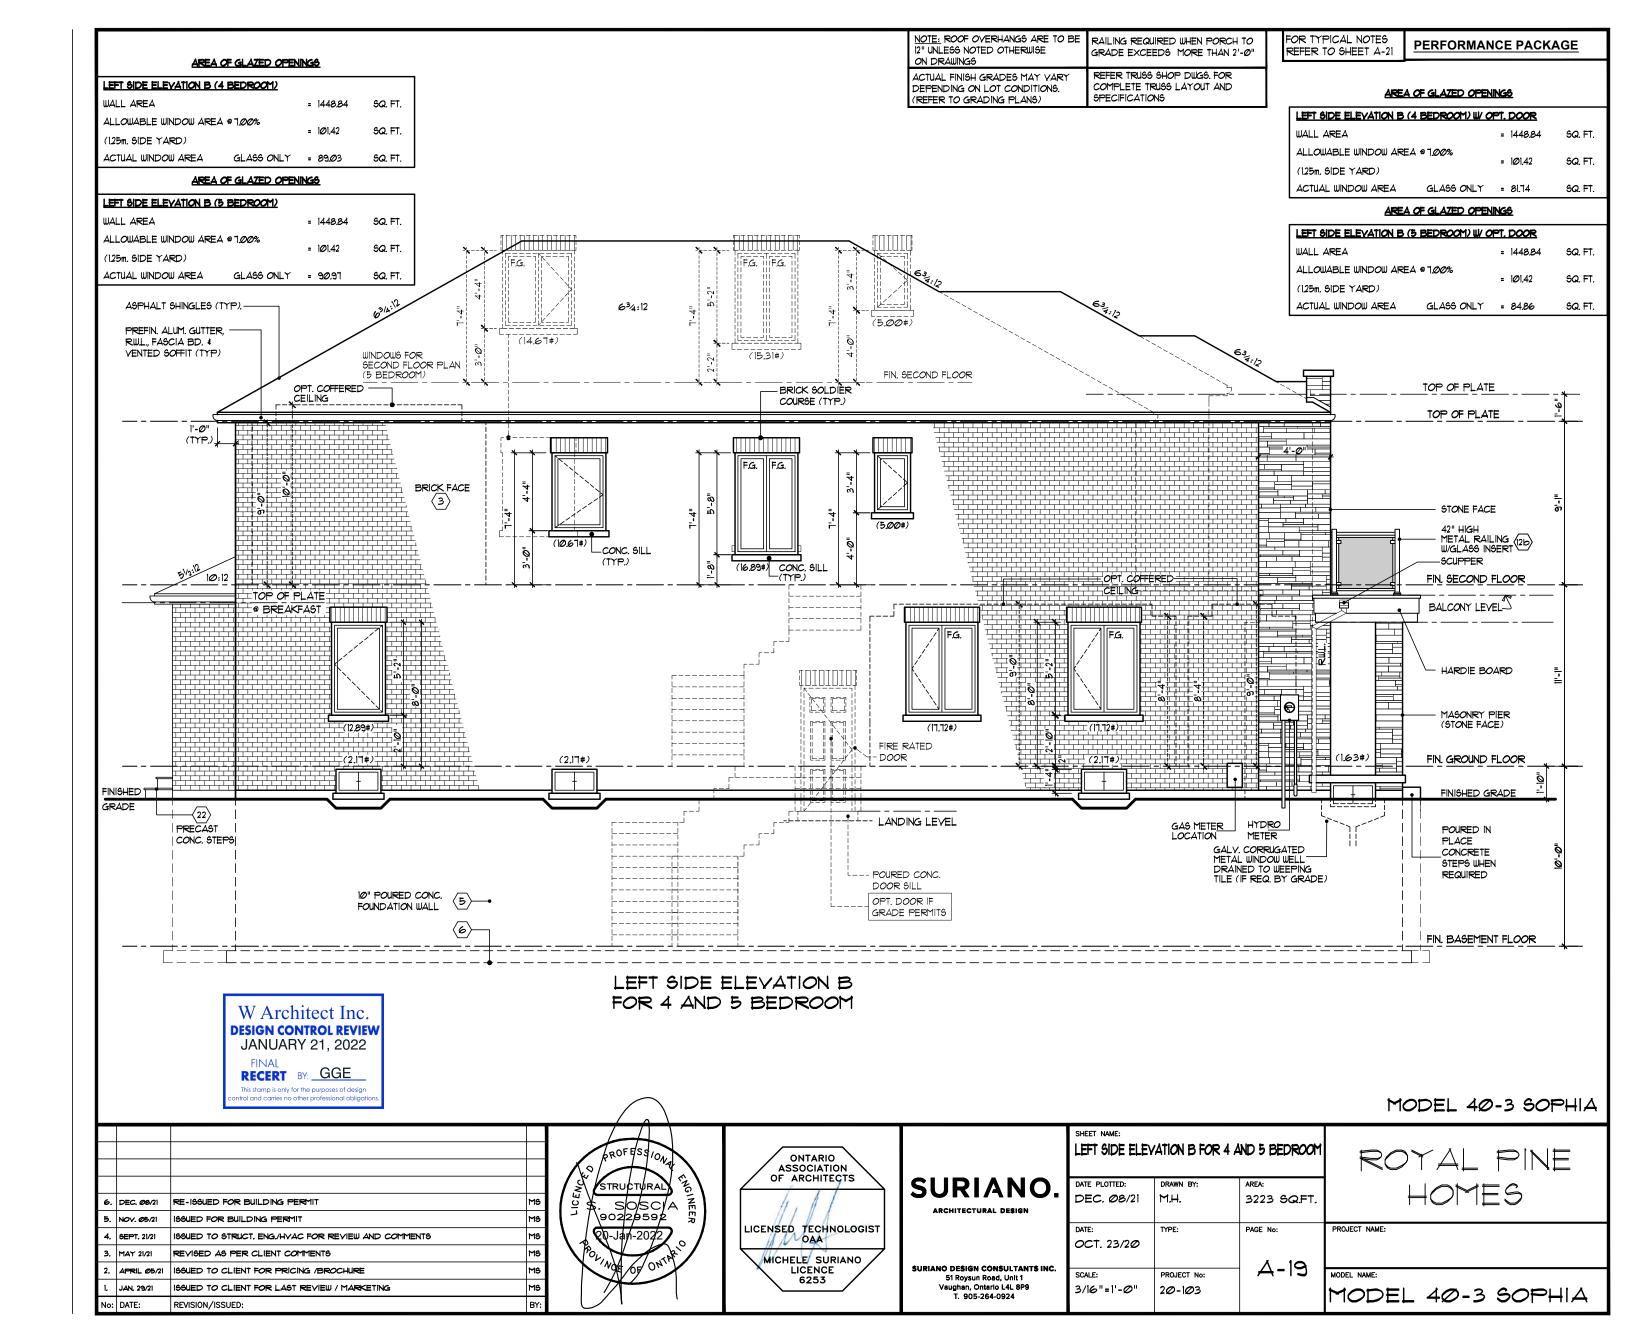

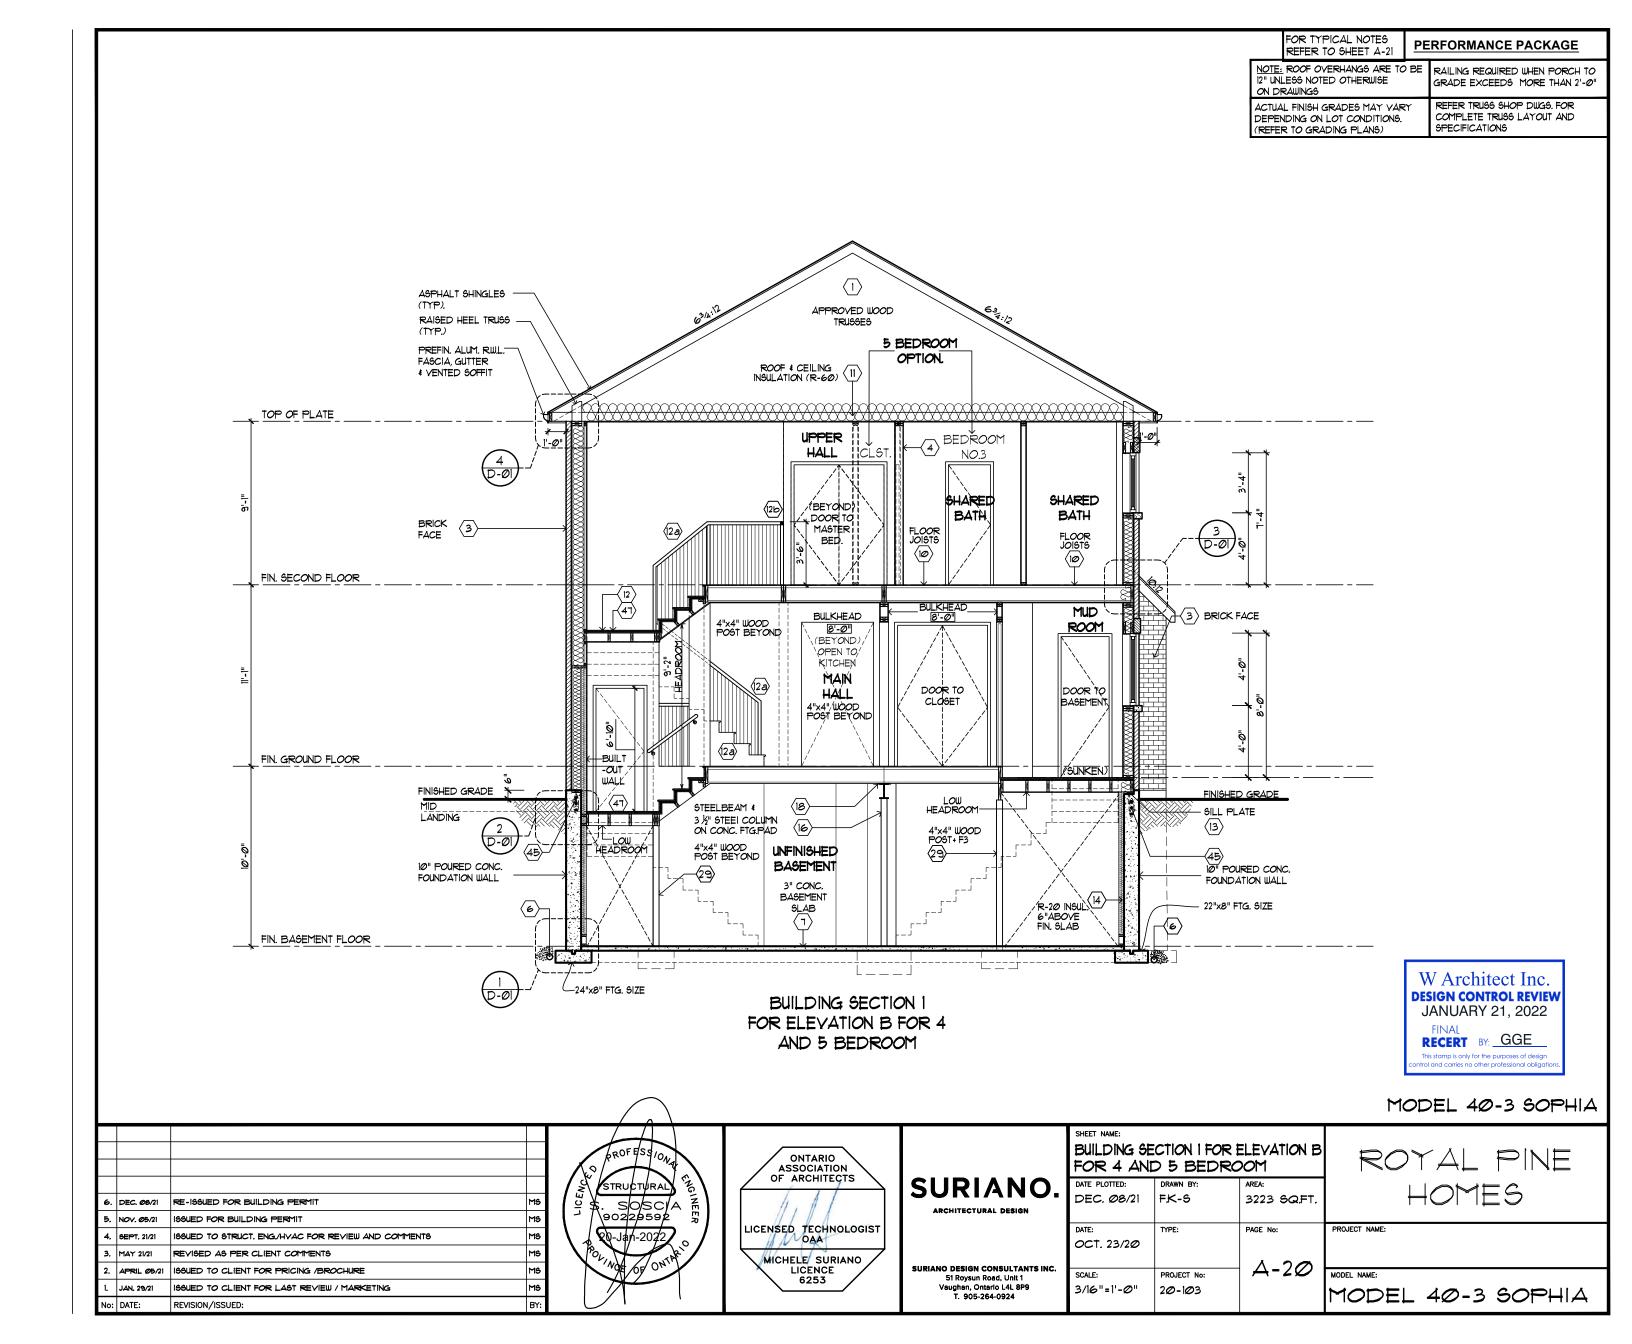

TYPICAL NOTES:

ALL CONCRETE FOOTING SHALL REST ON UNDISTURBED SOIL WITH A MIN. ALLOWABLE BEARING CAPACITY OF 150 Kpa (3000 PSF) AND BE FOUNDED A MIN. OF 4'-0" BELOW FINISHED GRADE.

CONCRETE STRENGTH FOR FOOTINGS SHALL BE A MIN. OF ISMPA, OR 20MPA, AS PER OBC TABLE 9.15.42.A.

CONCRETE STRENGTH FOR GARAGE SLAB, CONCRETE - 8% ENTRAINMENT, UNLESS NOTED OTHERWISE,

CONCRETE STRIP FOOTING SIZE FOR 10" P. CONC. WALLS SHALL BE MIN. OF 8"x22" UNREINFORCED FOR UP TO 16'-0" JOIST SPAN

THE ABOVE FOOTING SIZE WILL BE USED FOR FOUNDATION WALLS WHICH SUPPORT 2 STOREYS OF BRICK VENEER WALL CONSTRUCTION, 2 FLOORS AND ROOF OF LIGHT WOOD FRAME CONSTRUCTION, WITH SPAN OF SUPPORTED JOIST THAT DO NOT EXCEED 4.9m (16'-1") AT A SPECIFIED LIVE LOAD OF NOT GREATER THAN 2.4 Kpa (50 PSF)

REFER TO BASEMENT PLAN FOR FOOTING SIZES IN AREAS EXCEEDING THE ABOVE CONDITIONS.

3/4" SUB FLOOR TO BE GLUED & NAILED (TYP.)

REFER JOIST MANUFACTURER'S SPECIFICATIONS FOR ALL TECHNICAL DETAILS & LAYOUT.

ALL JOISTS UNDER CERAMIC TILES TO BE INSTALLED AS PER JOIST MANUF. SHOP DRAWINGS.

ALL LYLS SHALL BE 1.8E/2.0E GRADE MICROLLAM LVL OR BETTER U. S. O.

BRICK VENEER LINTELS

WLI	= 3 1/2" x 3 1/2" x 1/4"	(90x90x6)	+	2- 2" x 8"	SPF
WL2	= 4" × 3 1/2" × 5/16"	(100x90x8)	+	2- 2" x 8"	SPF
WL3	= 5" × 3 1/2" × 5/16"	(125×9Øx8)	+	2- 2" × 1Ø"	SPF
WL4	= 6" × 3 1/2" × 3/8"	(150x90x10)	+	2- 2" x 12"	SPF
WL5	= 6" × 4" × 3/8"	(150x100x10)	+	2- 2" x 12"	SPF
WL6	= 5" x 3 1/2" x 5/16"	(125x9Øx8)	+	2- 2" x 12"	SPF
WL7	= 5" × 3 1/2" × 5/16"	(125x9Øx8)	+	3- 2" x 10"	SPF
WL8	= 5" x 3 1/2" x 5/16"	(125x9Øx8)	+	3- 2" x 12"	SPF
WL9	= 6" × 4" × 5/16"	(150x100x10)	+	3- 2" x 12"	SPF

CI= 31/2" \$x1/4" STEEL COL. ON CONC.. FTG. + 6"x6"x 1 2" BASE & CAP PLATE. WELD TO BM. ANCHOR TO FTG. W/ 2- \$1/5"x6" AB

FI= 36"x36"x16"	F2= 24"x24"x12"	
F3= 8"x 8"x8"		

ALL RETURN AIR PARTITIONS TO BE 6" - REFER TO

SOLID BEARING:

SB MINIMUM 3-2"x4" OR 3-2"x6" BUILT UP COLUMNS

BUILT UP COLUMNS:

- NAILED W/ 1 ROW FOR 2"x4" COLUMN
- NAILED W/ 2 ROW FOR 2"x6" COLUMN
- NAIL LENGTH TO MATCH TOTAL BUILT UP WIDTH
- NAILS SPACED @ 8" O/C
- PROVIDE SQUASH BLOCKS TO TRANSFER POINT LOADS BETWEEN FLOORS

STEEL LINTELS

L1	=	3 1/2" x 3 1/2" x 1/4"	(89x89x6.4)
L2	=	4" x 3 1/2" x 5/16"	(1Ø2x89xT.9)
L3	=	5" x 3 1/2" x 5/16"	(P.Tx88xT21)
L4	=	6" x 3 1/2" x 3/8"	(152x89x9.5)
L5	=	6" x 4" x 3/8"	(152x1Ø2x9.5)
L6	=	7" x 4" x 3/8"	(178xlØ2x9.5)
L٦	=	7" ×4" × 1/2"	(178xlØ2xl3)

WOOD LINTELS AND BEAMS

FOR APPROVED ENGINEERED FLOOR JOIST SYSTEM.

INCLUDING BEAMS AND SUPPORT, REFER TO THE APPROVED ENGINEERED FLOOR LAY OUT ENCLOSED

LAMINATED VENEER LUMBER

LYLIA	= 1-1 3/4" x 7 1/4"	(1-45xl84)
LVLI	= 2-1 3/4" x 7 1/4"	(2-45x184)
LVL2	= 3-1 3/4" x 7 1/4"	(3-45xl84)
LVL3	= 4-1 3/4" x 7 1/4"	(4-45x184)
LVL4A	= 1-1 3/4" x 9 1/2"	(1-45×235)
LVL4	= 2-1 3/4" x 9 1/2"	(2-45x235)
LVL5	= 3-1 3/4" x 9 1/2"	(3-45x235)
LVL5A	= 4-1 3/4" x 9 1/2"	(4-45x235)
LVL6A	= 1-1 3/4" x 11 7/8"	(1-45x3ØØ)
LVL6	= 2-1 3/4" x 11 7/8"	(2-45x3@@)
LVLT	= 3-1 3/4" x 11 7/8"	(3-45x3@@)
LVLTA	= 4-1 3/4" x 11 7/8"	(4-45x3@@)

TYPICAL ELEVATION NOTES:

REFER TO TRUSS SHOP DWGS. FOR COMPLETE TRUSS LAYOUT AND SPECIFICATIONS

NOTE: ELEVATIONS DO NOT REPRESENT ACTUAL FINISHED GRADES (REFER TO GRADING PLANS)

RAILING REQUIRED WHEN PORCH TO GRADE EXCEEDS MORE THAN 2'-0"

REFER JOIST MANUFACTURER'S SPECIFICATIONS FOR ALL TECHNICAL DETAILS & INFO.

TYPICAL GROUND FLOOR PLAN NOTES:

ALL RETURN AIR PARTITIONS TO BE 6" - REFER TO HYAC DRAWINGS

DENOTES CEILING HEIGHT


TYPICAL GROUND FLOOR NOTES


- REFER JOIST MANUFACTURER'S SPECIFICATIONS FOR ALL TECHNICAL DETAILS & LAYOUT
- 5/8" SUB-FLOOR TO BE GLUED & NAILED (TYP.)
- ALL JOISTS UNDER CERAMIC TILES TO BE INSTALLED AS PER JOIST MANUF. SHOP DUG'S.
- ALL LYLS SHALL BE 1.9E GRADE MICROLLAM LYL OR BETTER U. S. O.

FOR APPROVED ENGINEERED FLOOR JOIST SYSTEM, INCLUDING BEAMS AND SUPPORT REFER TO THE APPROVED ENGINEERED FLOOR LAY OUT ENCLOSED

ALL GARAGE DOORS INTO THE HOUSE SHALL BE GAS PROOFED AND HAVE SELF-CLOSING DEVICES. EACH DOOR SHALL HAVE STAIRS CONFORMING TO O.B.C.

W Architect Inc. **DESIGN CONTROL REVIEW** JANUARY 21, 2022 RECERT BY: GGE

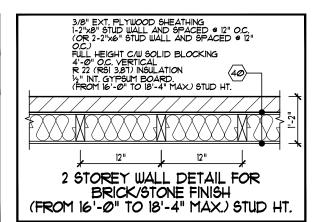

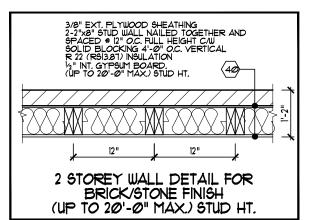

TYPICAL SECOND FLOOR PLAN NOTES:

REFER TRUSS SHOP DWGS. FOR COMPLETE TRUSS LAYOUT AND SPECIFICATIONS

ALL RETURN AIR PARTITIONS TO BE 6". REFER TO HVAC DRAWINGS

10'-0" 9'-0"

DENOTES CEILING HEIGHT

DENOTES STUD WALL REINFORCED FOR FUTURE GRAB BARS. REFER TO DETAIL 3/D-10

MODEL 40-3 SOPHIA

RE-ISSUED FOR BUILDING PERMIT DEC. Ø8/21 166UED FOR BUILDING PERMIT NOV. Ø5/21 ISSUED TO STRUCT, ENG./HYAC FOR REVIEW AND COMMENTS REVISED AS PER CLIENT COMMENTS APRIL Ø5/21 ISSUED TO CLIENT FOR PRICING /BROCHURE MS ISSUED TO CLIENT FOR LAST REVIEW / MARKETING JAN, 29/21 No: DATE: REVISION/ISSUED:





SURIANO.

SURIANO DESIGN CONSULTANTS INC. 51 Roysun Road, Unit 1 Vaughan, Ontario L4L 8P9 T. 905-264-0924

SHEET NAME: TYPICAL	NOTES		ROYAL PINE
DATE PLOTTED:	DRAWN BY:	AREA:	
DEC. Ø8/21	M.H.	3223 SQ.FT.	
DATE:	TYPE:	PAGE No:	PROJECT NAME:
OCT. 23/2Ø			
SCALE:	PROJECT No:	H A-21	MODEL NAME:
3/16"=1'-0"	20-103		MODEL 40-3 SOPHIA

